


KEY PLAN

Sheet No.


D1.11

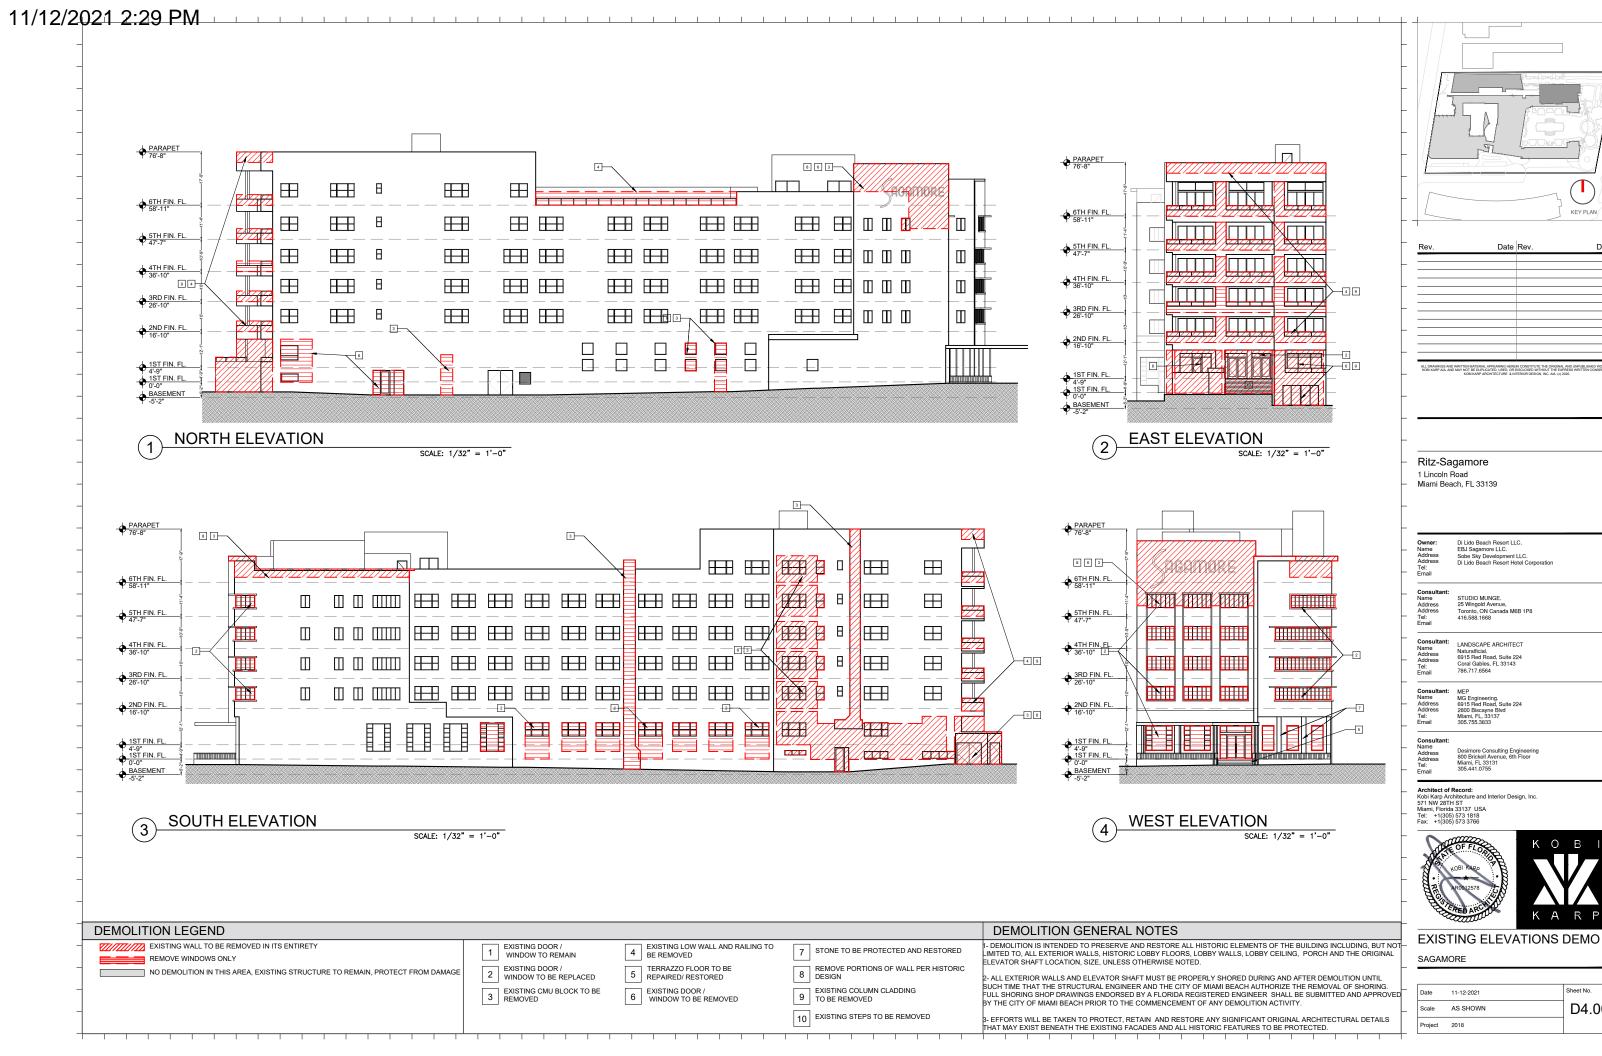

KEY PLAN

Sheet No.

D4.00

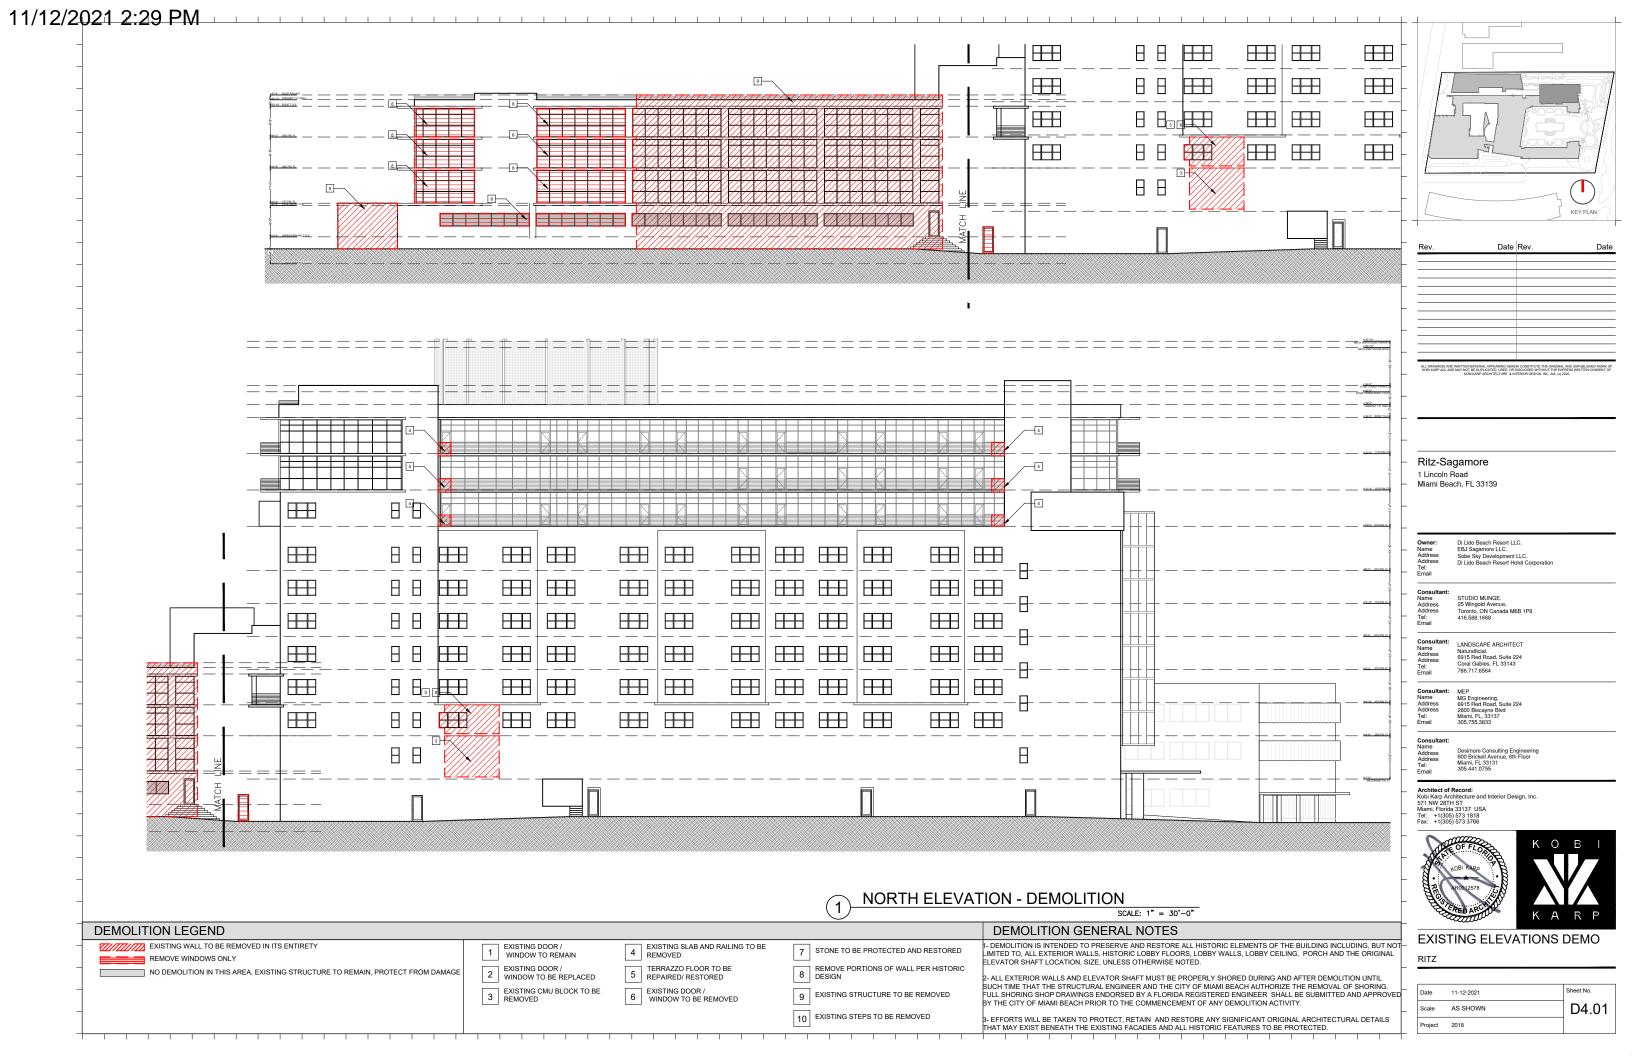


SHEET INDEX

	HDLA							
SHEET#	SHEET TITLE							
L-0.00	COVER SHEET	F	•	¥	•	A	•	
L-0.00A	SITE TABULATIONS		•	ΙĖ	•	E	•	
L-0.00B	ILLUSTRATIVE SITE PLAN	≅		M	•	M	•	
L-0.01	SITE SURVEY	SUBMITTAL	•	SUBMITTAL	•	SUBMITTAL	•	
L-0.02	SITE SURVEY TREE LIST		•		•	HPB (•	
L-1.10	OVERALL HARDSCAPE PLAN	 	•	뮨	•	生	•	
L-1.11	REAR YARD HARDSCAPE AREA DIAGRAM	98	•	09.07	•	11.12	•	
L-3.00	OVERALL TREE DISPOSITION PLAN		•	8	•	Ξ.	•	
L-3.00A	EXISTING PLANTING AREAS DIAGRAM		•	2021	•	2021	•	
L-3.01	TREE DISPOSITION LIST	2	•	×	•	×	•	
L-3.02	TREE DISPOSITION LIST		•		•		•	
L-3.03	TREE DISPOSITION LIST		•		•		•	
L-3.04	TREE DISPOSITION LIST		•		•		•	
L-3.10	OVERALL LANDSCAPE PLAN		•		•		•	
L-3.11	ENLARGED LANDSCAPE PLAN 'A'		•		•		•	
L-3.12	ENLARGED LANDSCAPE PLAN 'B'		•		•		•	
L-3.13	ENLARGED LANDSCAPE PLAN 'C'		•		•		•	
L-3.14	ENLARGED LANDSCAPE PLAN 'D'		•	1	•		•	
L-3.15	LANDSCAPE PLANT LIST		•		•		•	
L-3.16	PLANTING REFERENCE IMAGES		•		•		•	_
L-3.17	PLANTING REFERENCE IMAGES		•					
L-3.30	GENERAL PLANTING DETAILS		•		•		•	
L-4.10	OVERALL LIGHTING PLAN		•	1	•	1	•	_
L-5.10	OVERALL IRRIGATION PLAN		•		•	1	•	_

SCOPE OF WORK


HARDSCAPE, LANDSCAPE, LANDSCAPE LIGHTING, AND IRRIGATION WITHIN THE LIMITS DEFINED BY THE LIMITS OF SCOPE OF WORK.

GRAPHIC LEGEND

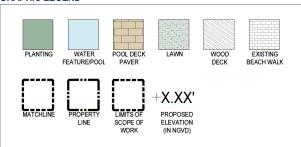

GENERAL ABBREVIATIONS

TW	TOP OF WALL	OA	OVERALL PLAN
TPW	TOP OF PLANTER WALL	CONC	CONCRETE
TB	TOP OF BENCH	LA	LANDSCAPE ARCHITECT
TC	TOP OF CURB	ARCH	ARCHITECT
FFE	FINISH FLOOR ELEVATION	STRUCT	STRUCTURE / STRUCTURAL
AFF	ABOVE FINISH FLOOR	ENG	ENGINEER
P.L.	PROPERTY LINE	DWGS	DRAWINGS
TG	TOP OF GRADE	TYP	TYPICAL
μ	MONUMENT LINE	EXST	EXISTING
ą.	CENTER LINE	HSCP	HARDSCAPE
ML	MATCH LINE	LSCP	LANDSCAPE
EL	ENLARGED PLAN	PLNT	PLANTING

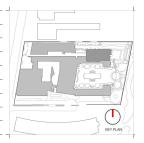

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Ritz-Sagamore 1 Lincoln Road Miami Beach, FL 33139

Owner:
Name
Address
Address
Tel:
Sobe Sky Development

lame STUDIO MUNGE.
Address 25 Wingold Avenue,
Address Toronto, ON Canada M68 (el: 416.588.1668

Consultant:
Name
Address
Address
Address
Address
Coral Gables, FL 33143
788 712 5844

Consultant: MEP
Name MG Engineering.
Address 6915 Red Road, Suite 2
Address 2800 Biscayne Bird
Tel: Miam; FL 33137

onsultant: ame ddress Desimore Consulting Engine ddress 800 Brickell Avenue, 6th Fi

Architect of Record: Kobi Karp Architecture and Interior Design, Ir 571 NW 28TH ST Miami, Florida 33137 USA Tel: +1(305) 573 1818



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R.L.A. FL #6667221

COVER SHEET

Date	11-12-2021	Sheet No.
Scale	NTS	L-0.00
Project	Ritz Sagamore	

Sagamore Ritz

1 Lincoln Road Miami Beach, FL 33139

REQUIRED/

CITY OF MIAMI BEACH

LANDSCAPE LEGEND

INFORMATION REQUIRED TO BE PERMANENTLY AFFIXED TO PLANS
Zoning District <u>RM-3</u> Lot Area <u>207,612 SF</u> Acres <u>4.76</u>

OPEN SPACE	ALLOWED	PROVIDED
A. Square feet of required Open Space as indicated on site plan:		
207,612 sq. ft. x 30%	62,284 SF Required	44,124 SF
B. Square feet of parking lot open space required as indicated on site plan:		
Number of parking spaces $n/a \times 10$ s.f. parking space =	n/a	n/a
C. Total square feet of landscaped open space required: A+B=	62,284 SF Required	44,124 SF
LAWN AREA CALCULATION		
A. Square feet of landscaped open space required	62,284 SF Required	20,217 SF
B. Maximum lawn area (sod) permitted= 30% x 62,284 SF	18,685 SF Allowed	10,624 SF
A. Number of trees required per lot or net lot acre, less existing number of		131 Trees /
trees meeting minimum requirements:		21 Palms (
(28) trees required per acre - (0) existing trees =		69 Ex.
		Palms and
	134	3 Ex. Trees)
B. % Natives required:		
(134) Number of trees provided x 30% =		
		444
	41	108
C. % Low maintenance / drought and salt tolerant required:	67	122
(134) Number of trees provided x 50%=		
D. Street Trees (maximum average spacing of 20' o.c.) 658'_ linear feet along street divided by 20'=	22	25*
	33	*All Ex. Street
E. Street tree species allowed directly beneath power lines: (maximum average spacing of 20' o.c.):		Trees/Palms to
		Remain
<u>n/a</u> linear feet along street divided by 20'=	n/a	n/a
<u>SHRUBS</u>		
A. Number of shrubs required:		
(134) Sum of lot trees required x 12=	1,608	1,616
B. % Native shrubs required:		
(1,608) Number of shrubs provided x 50%=	804	804
LARGE SHRUBS OR SMALL TREES		
A. Number of large shrubs or small trees required:		
(1,608) Number of required shrubs x 10%=	161	201
B. % Native large shrubs or small trees required:		
(161) Number of large shrubs or small trees provided x 50%=	81	201
* Note: See Open Space Diagrams on sheet L-1.11.		



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	gamore Road		
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1 Lincoln F Miami Bea	Road		
1 Lincoln F Miami Bea	Road Ich, FL 33139	c.	
1 Lincoln F Miami Bea Miame R Name Address Address Tel:	Road		
Owner: Name Address Fel: Email Consultant: Name	Pi Lido Beach Resort LI EBJ Sagamore LLC. Sobe Sky Development		
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Owner: Name Address Address Fel: Same Consultant: Name Address Address Address Fel: First	Pi Lido Beach Resort LI EBJ Sagamore LLC. Sobe Sky Development	LLC.	
Owner: Name Address Address Fel: Email Consultant: Name Address Address Tel: Email Consultant:	Oad ch, FL 33139 Di Lido Beach Resort II. E3J Sagamore I.C. Sobe Sky Development STUDIO MUNGE: 25 Wingolf Aversus, Tocesto, ON Canada M 416.589.1688	LLC. 56 1P8	
Owner: Name Address Address Address Address Tel: Email Consultant: Name Address Address Address Address Address Address Address Address	Oad Ch, FL 33139 DI Lido Beach Resort LI EBJ Sagamore LLC. Stoke Sky Developed Avenue, Torotto, CN Canada M 416-550-1656 LANDSCAPE ARCHITE Materials LI	LLC. 98 1P8 CT 24	
Owner: Name Beal Owner: Name Address Address Fel: Email Consultant: Name Address Fel: Email Consultant: Neme Address Address Address Address Address Address Address Address Address	Oad Ch, FL 33139 DILMO Basch Resort LL ESJ Sagamore LLC. Sobe Sky Development STUDIO MUNGE. 25 Wingold Averse, Tonesto, CH Canada M 416.0561.056 LANGSCAPE, ARCHITE Natural STUDIO MUNGE. ACHITE Natural STUDIO MUNGE. 25 Wingold Averse, Marcanto Municard Studio Municard	LLC. 98 1P8 CT 24	
Owner: Name Address Address Address Address Tel: Email Consultant: Name Address Address Tel: Address Tel: Address Tel: Address Tel: Address Tel: Consultant:	Oad ch, FL 33139 DI Lido Basch Resort LC. Sobe Sky Development LC. Sobe Sky Development Co. Sob Sky Development	LLC. 98 1P8 CT 24	
Owner: Name Address Finall	DI Lido Basch Resert I EBJ Sagemon LC. Sobe Sky Development STILDIO MUNGE: ST WINDOWN Across. Toconto, ON Canada M 416.589.1689 LANDSCAPE ARCHITE CORI GABLE ACROSS CORE CORE CONTROL SUB- 6015 Red Road, Sub-6 CORI Gables, FL, 33142 766.717.6064	LLC. 98 1P8 CT 24	





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SITE TABULATIONS

-	Date	11-12-2021	Sheet No.
Ļ	Scale	NTS	L-0.00A
	Project	Ritz Sagamore	





Rev.	Date	Rev.	Date

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Ritz-Sagamore 1 Lincoln Road Miami Beach, FL 33139

Consultants:
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Desires Consulting Engineering
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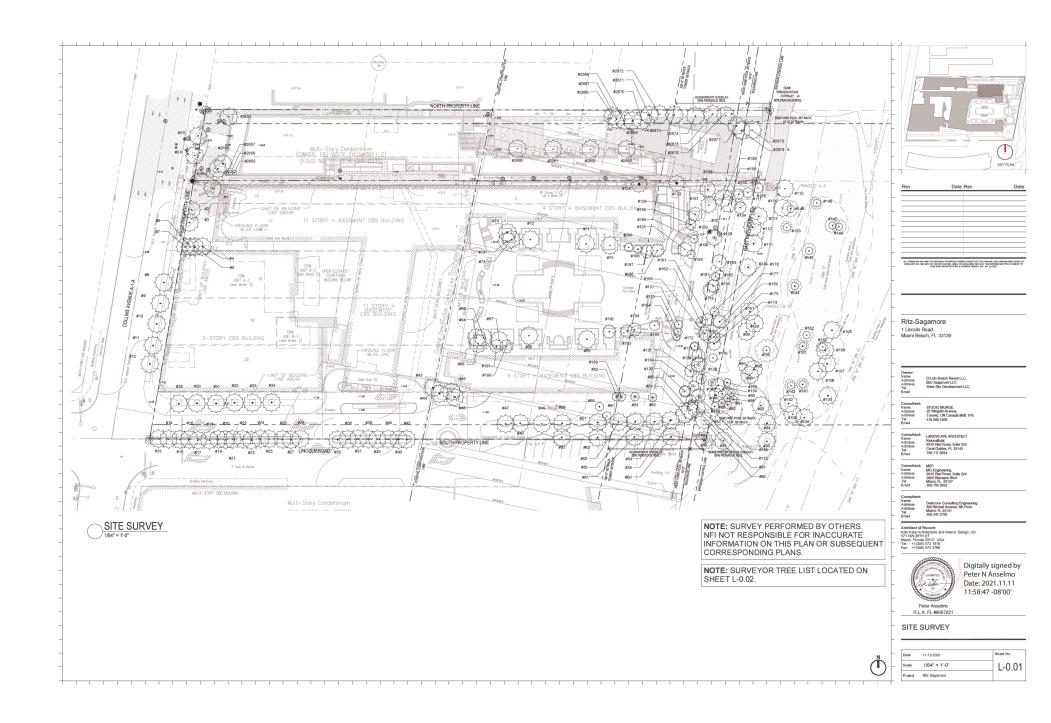


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Peter Anselmo R.L.A. FL #6667221

ILLUSTRATIVE SITE PLAN

-	Date	11-12-2021	Sheet No.
-	Scale	NTS	L-0.00B
	Project	Ritz Sagamore	



Tree	Detected New	Common No.	Diameter	Height	Canopy
No.	Botanical Name	Common Name	(Inches)	(Feet)	(Feet)
1	Cocos nucifera	Coconut Palm	0.6	15	20
2	Phoenix Canariensis	Canary Island Palm	1.2	20	22
3	Phoenix Canariensis	Canary Island Palm	1.3	22	22
4 - 7	Cocos nucifera	Coconut Palm	0.5	12	20
8 - 11	Cocos nucifera	Coconut Palm	0.7	30	20
12	Cocos nucifera	Coconut Palm	0.7	25	20
13	Cocos nucifera	Coconut Palm	0.7	20	20
14 - 16	Cocos nucifera	Coconut Palm	0.7	22	20
17	Cocos nucifera	Coconut Palm	0.6	18	20
18 - 20	Cocos nucifera	Coconut Palm	0.6	20	20
21	Cocos nucifera	Coconut Palm	0.6	18	20
22	Cocos nucifera	Coconut Palm	0.6	20	20
23	Cocos nucifera	Coconut Palm	0.7	22	20
24 - 28	Cocos nucifera	Coconut Palm	0.7	22	20
29 - 34	Phoenix Canariensis	Canary Island Palm	1.3	22	20
35	Cocos nucifera	Coconut Palm	0.6	30	20
36 - 37	Cocos nucifera	Coconut Palm	0.6	25	20
38 - 39	Cocos nucifera	Coconut Palm	0.6	20	20
40	Cocos nucifera	Coconut Palm	0.6	22	20
41	Cocos nucifera	Coconut Palm	0.6	18	20
42	Cocos nucifera	Coconut Palm	0.7	20	20
13. 44. 46	Cocos nucifera	Coconut Palm	0.6	25	20
45	Cocos nucifera	Coconut Palm	0.6	18	20
47 - 49	Phoenix Canariensis	Canary Island Palm	23	22	20
50 - 63	Phoenix Canariensis	Canary Island Palm	14	25	20
64, 65	Cocos nucifera	Coconut Palm	0.7	25	20
66	Cocos nucifera	Coconut Palm	0.7	20	20
67	Cocos nucifera	Coconut Palm	0.7	20	20
68.69	Phoenix Canariensis	Canary Island Palm	1.3	25	20
70	Cocos nucifera	Coconut Palm	0.7	22	20
71. 72	Phoenix Canariensis	Canary Island Palm	1.3	25	20
73. 75	Cocos nucifera	Coconut Palm	0.7	30	20
74	Cocos nucifera	Coconut Palm	0.7	22	20
79 - 82	Cocos nucifera	Coconut Palm	0.7	20	20
83 - 87	Unknown to Surveyor	Unknown to Surveyor	0.5	15	15
145	Cocos nucifera	Coconut Palm	0.8	25	25
139	Cocos nucifera	Coconut Palm	0.7	38	30
140	Cocos nucifera	Coconut Palm	0.7	42	30
141	Cocos nucifera	Coconut Palm	0.6	45	30
142	Cocos nucifera	Coconut Paim	0.7	50	30
143	Cocos nucifera	Coconut Palm	0.7	48	25
144	Cocos nucifera	Coconut Palm	0.6	20	25
146	Cocos nucifera	Coconut Palm	0.0	35	30
147	Cocos nucifera	Coconut Palm	0.8	45	30
148	Cocos nucifera	Coconut Palm	0.8	25	25
149	Cocos nucifera	Coconut Palm	0.8	30	30

Tree	Botanical Name	Common Name	Diameter	Height	Canopy
No.			(Inches)	(Feet)	(Feet)
52	Roystonea regia	Royal Palm	16	25	14
53	Roystonea regia	Royal Palm	16	20	14
54	Roystonea regia	Royal Palm	16	22	14
55	Roystonea regia	Royal Palm	16	22	14
79	Thrinax radiata	Florida Thatch Palm	4	12	5
80	Thrinax radiata	Florida Thatch Palm	4	12	5
81	Thrinax radiata	Florida Thatch Palm	4	12	5
82	Washingtonia robusta	Washington Palm	10	35	10
83	Washingtonia robusta	Washington Palm	10	35	10
85	Washingtonia robusta	Washington Palm	10	35	10
88	Cabbage	Cabbage	10	12	14
89	Cabbage	Cabbage	12	12	10
90	Cabbage	Cabbage	12	14	12
91	Cabbage	Cabbage	12	14	12
92	Cabbage	Cabbage	12	14	12
116	Cocos nucifera	Coconut Palm	10	25	12
117	Cocos nucifera	Coconut Palm	8	25	12
118	Cocos nucifera	Coconut Palm	8	25	12
125	Cocos nucifera	Coconut Palm	10	25	16
126	Cocos nucifera	Coconut Palm	10	22	16
127	Cabbage	Cabbage	4	15	6
128	Cabbage	Cabbage	4	12	5
129	Cabbage	Cabbage	4	15	6
130	Cabbage	Cabbage	10	25	18
131	Cocos nucifera	Coconut Palm	10	25	10
132	Cocos nucifera	Coconut Palm	8	25	12
133	Cocos nucifera	Coconut Palm	8	25	12
134	Cocos nucifera	Coconut Palm	8	25	12
135	Cocos nucifera	Coconut Palm	10	30	16
136	Cocos nucifera	Coconut Palm	8	25	12
137	Cocos nucifera	Coconut Palm	10	25	14
138	Cabbage	Cabbage	10	30	16
154	Cocos nucifera	Coconut Palm	7	15	14
155	Cocos nucifera	Coconut Palm	10	20	18
156	Cocos nucifera	Coconut Palm	10	40	20
157	Cocos nucifera	Coconut Palm	9	20	18
158	Cocos nucifera Cocos nucifera	Coconut Palm Coconut Palm	8	30	18
159	Cocos nucifera	Coconut Palm	10	25	16
160	Cocos nucifera	Coconut Palm Coconut Palm	10	30	16
161	Cocos nucifera	Coconut Palm Coconut Palm	10	30	16
162	Cocos nucifera	Coconut Palm	10	35	12
163	Cocos nucifera Cocos nucifera	Coconut Palm Coconut Palm	10	30	12
			10		
164	Cocos nucifera	Coconut Palm		20	8
165	Conocarpus erectus	Silver Button	8	14	
166	Cabbage	Cabbage	4	16	8
167	Conocarpus erectus	Silver Button	8	14	4
168	Conocarpus erectus	Silver Button	8	14	4
169	Washingtonia robusta	Washington Palm	10	35	10

RITZ PROPERTY (cont'd)

Tree	Botanical Name	Common Name	Diameter	Height	Canopy
No.	Botanicai Name	Common Name	(Inches)	(Feet)	(Feet)
171	Cocos nucifera	Coconut Palm	12	15	15
172	Cocos nucifera	Coconut Palm	8	15	10
173	Cocos nucifera	Coconut Palm	8	15	10
174	Cocos nucifera	Coconut Palm	12	15	15
175	Cocos nucifera	Coconut Palm	12	15	15
176	Cocos nucifera	Coconut Palm	8	15	10
177	Cocos nucifera	Coconut Palm	10	15	15
178	Cocos nucifera	Coconut Palm	7	15	10
179	Cocos nucifera	Coconut Palm	8	20	15
180	Cocos nucifera	Coconut Palm	12	15	15
181	Cocos nucifera	Coconut Palm	7	10	10
182	Cocos nucifera	Coconut Palm	7	10	10
183	Cocos nucifera	Coconut Palm	7	10	10
184	Cocos nucifera	Coconut Palm	7	10	10
185	Cocos nucifera	Coconut Palm	8	8	12
186	Cocos nucifera	Coconut Palm	7	20	15
187	Cocos nucifera	Coconut Palm	12	20	15
188	Cocos nucifera	Coconut Palm	12	25	10
189	Cocos nucifera	Coconut Palm	8	20	10
190	Cocos nucifera	Coconut Palm	8	30	15
191	Cocos nucifera	Coconut Palm	8	30	15
192	Cocos nucifera	Coconut Palm	8	15	15
193	Cocos nucifera	Coconut Palm	8	20	15
194	Cocos nucifera	Coconut Palm	12	15	15
195	Cocos nucifera	Coconut Palm	8	15	12



Rev.	Date	Rev.	Date

Ritz-Sagamore 1 Lincoln Road Miami Beach, FL 33139




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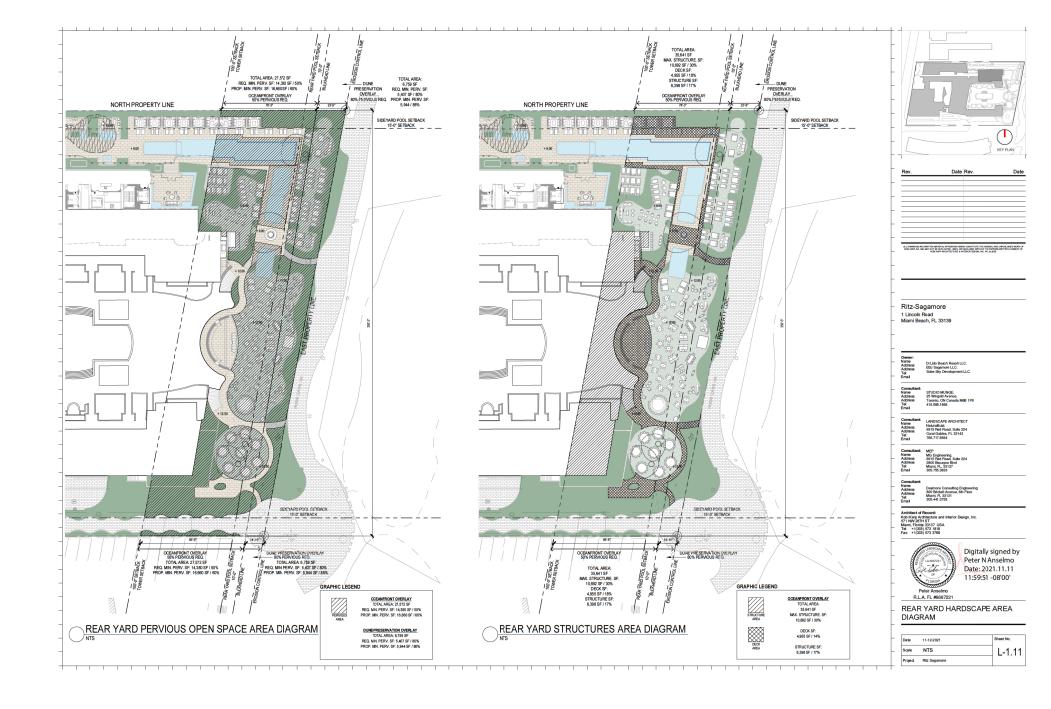
Peter Anselmo R.L.A. FL #6667221


-	SITE	SURVEY	TREE	LIST
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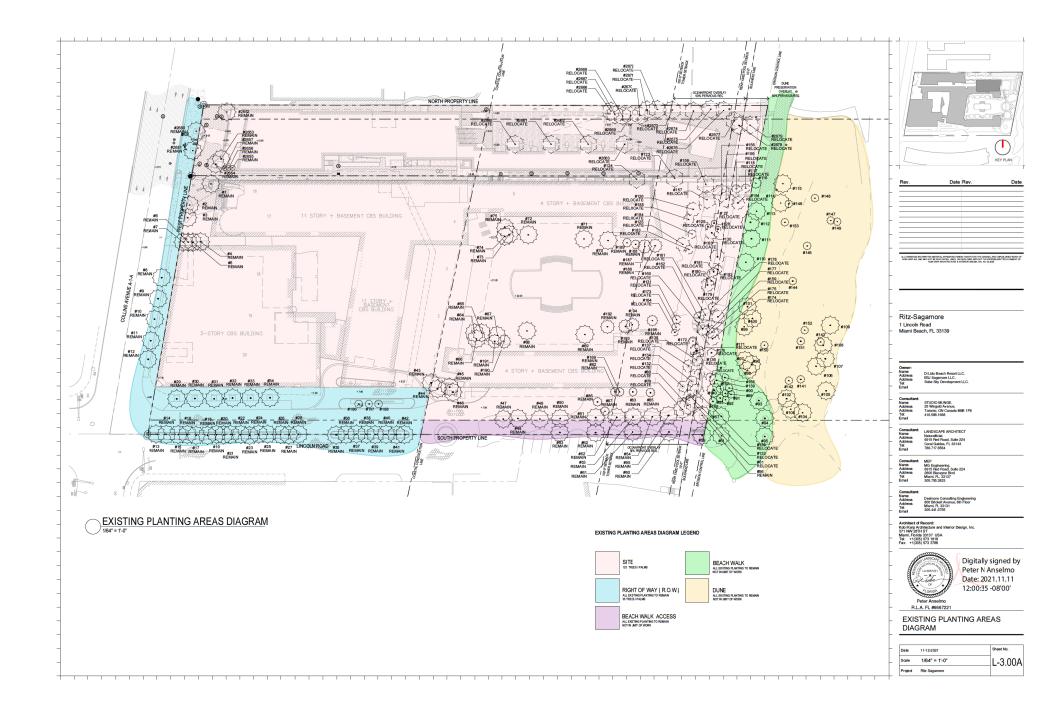
Date	11-12-2021	Sheet No.
Scale	NTS	L-0.02
Project	Ritz Sagamore	

2652	Coconut Palm	12	25	20
2653	Coconut Palm	12	35	20
2654	Coconut Palm	12	25	20
2655	Fan Palm	12	4	6
2656	Fan Palm	12	10	6
2657	Fan Palm	12	4	10
2660	Coconut Palm	12	30	20
2661	Coconut Palm	12	35	20
2662	Coconut Palm	12	32	22
2663	Coconut Palm	12	35	20
2666	Coconut Palm	9	38	24
2667	Coconut Palm	10	35	24
2668	Coconut Palm	9	35	24
2669	Coconut Palm	8	28	24
2670	Coconut Palm	8	30	24
2671	Coconut Palm	9	30	20
2672	Coconut Palm	11	25	24
2673	Coconut Palm	12	30	18
2674	Coconut Palm	10	28	20
2675	Coconut Palm	7	25	16
2676	Coconut Palm	8	24	14
2677	Coconut Palm	7	20	18
2678	Coconut Palm	7	20	16
2679	Coconut Palm	8	18	16





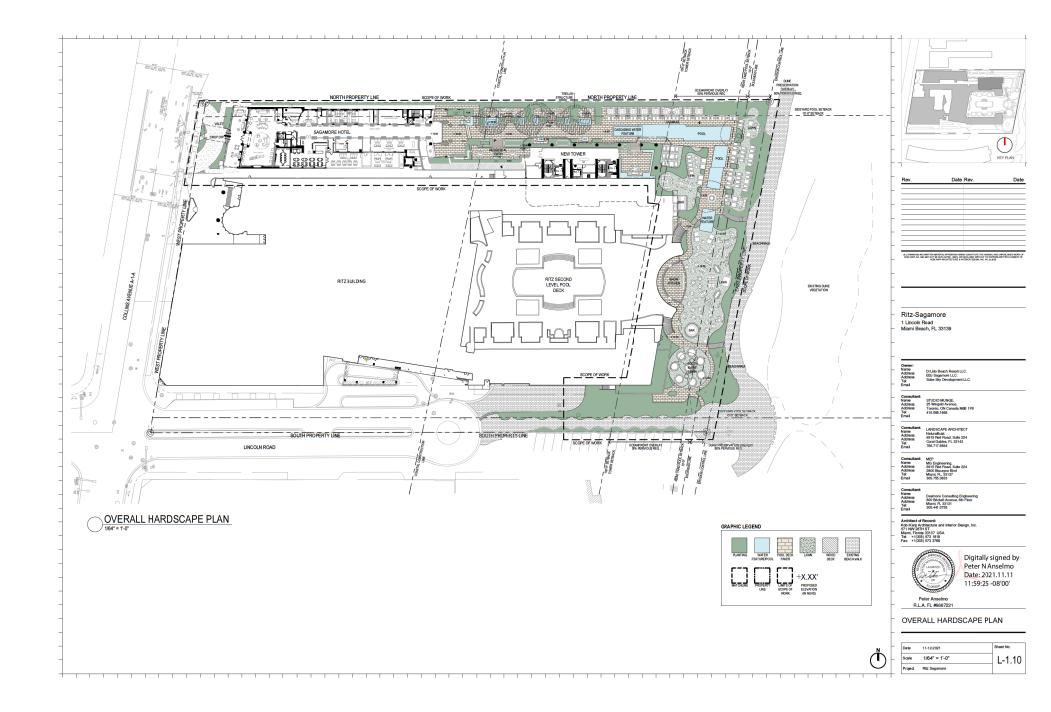

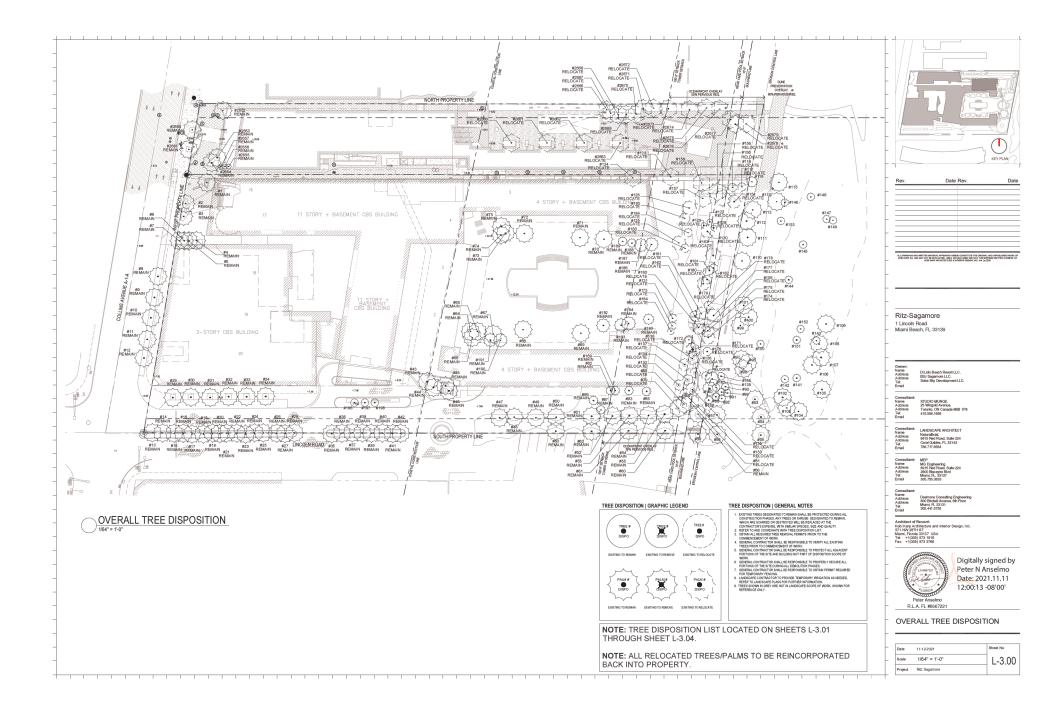

EY#	ABRV.	BOTANICAL NAME	BOTANICAL NAME COMMON NAME		SIZE		LOCATION	DISPOSITION		MITIGATIO REQ'D	
				DBH. (IN.)	HT. (FT.)	SPD. (FT.)		REMAIN		ELOCATE ON SITE	
1	CNU	Cocos nucifera	Coconut Palm	0.6	15	20	Site	X	REMOVE	ONTOTIL	No
2	PCA	Phoenix canariensis	Canary Island Date Palm	1.2	20	22	Site	x			No
3	PCA	Phoerix canariensis	Canary Island Date Palm	1.3	22	22	Site	x			No
4	CNU	Cocos nucifera	Coconut Palm	0.5	12	22	Site	x			No
5	CNU	Cocos nucifera	Coconut Palm	0.5	12	22	Site	x			No
6	CNU	Cocos nucifera	Coconut Palm	0.5	12	22	Site	X			No
7	CNU	Cocos nucifera	Coconut Palm	0.5	12	22	Site	x			No
8	CNU	Cocos nucifera	Coconut Palm	0.7	30	20	ROW	x			No
9	CNU	Cocos nucifera	Coconut Palm	0.7	30	20	ROW	x			No
10	CNU	Cocos nucifera	Coconut Palm	0.7	30	20	ROW	x	 		
							ROW		_		No
11	CNU	Cocos nucifera	Coconut Palm	0.7	30	20	ROW	X			No
12	CNU	Cocos nucifera	Coconut Palm	0.7	25	20	ROW	X			No
13	CNU	Cocos nucifera	Coconut Palm	0.7	20	20		X			No
14	CNU	Cocos nucifera	Coconut Palm	0.7	22	20	ROW	X			No
15	CNU	Cocos nucifera	Coconut Palm	0.7	22	20	ROW	X	+		No
16	CNU	Cocos nucifera	Coconut Palm	0.7	22	20	ROW	Х	-		No
17	CNU	Cocos nucifera	Coconut Palm	0.6	18	20	ROW	Х			No
18	CNU	Cocos nucifera	Coconut Palm	0.6	20	20	ROW	х			No
19	CNU	Cocos nucifera	Coconut Palm	0.6	20	20	ROW	Х			No
20	CNU	Cocos nucifera	Coconut Palm	0.6	20	20	ROW	Х			No
21	CNU	Cocos nucifera	Coconut Palm	0.6	18	20	ROW	Х			No
22	CNU	Cocos nucifera	Coconut Palm	0.6	20	20	ROW	Х			No
23	CNU	Cocos nucifera	Coconut Palm	0.7	22	20	ROW	Х			No
24	CNU	Cocos nucifera	Coconut Palm	0.7	22	20	ROW	Х			No
25	CNU	Cocos nucifera	Coconut Palm	0.7	22	20	ROW	Х			No
26	CNU	Cocos nucifera	Coconut Palm	0.7	22	20	ROW	х			No
27	CNU	Cocos nucifera	Coconut Palm	0.7	22	20	ROW	х			No
28	CNU	Cocos nucifera	Coconut Palm	0.7	22	20	ROW	х			No
29	PCA	Phoenix canariensis	Canary Island Date Palm	1.3	22	20	ROW	х			No
30	PCA	Phoerix canariensis	Canary Island Date Palm	1.3	22	20	ROW	х			No
31	PCA	Phoerix canariensis	Canary Island Date Palm	1.3	22	20	ROW	х			No
32	PCA	Phoerix canariensis	Canary Island Date Palm	1.3	22	20	ROW	х			No
33	PCA	Phoerix canariensis	Canary Island Date Palm	1.3	22	20	ROW	х			No
34	PCA	Phoerix canariensis	Canary Island Date Palm	1.3	22	20	ROW	х			No
35	CNU	Cocos nucifera	Coconut Palm	0.6	30	20	ROW	х			No
36	CNU	Cocos nucifera	Coconut Palm	0.6	25	20	ROW	X			No
37	CNU	Cocos nucifera	Coconut Palm	0.6	25	20	ROW	X			No
38	CNU	Cocos nucifera	Coconut Palm	0.6	20	20	ROW	X			No
39	CNU	Cocos nucifera	Coconut Palm	0.6	20	20	ROW	x			No
40	CNU	Cocos nucifera	Coconut Palm	0.6	22	20	ROW	x			No
41	CNU	Cocos nucifera	Coconut Palm	0.6	18	20	ROW	x			No
42	CNU	Cocos nucifera	Coconut Palm	0.7	20	20	ROW	x			No
43	CNU	Cocos nucifera	Coconut Palm	0.6	25	20	Site	x			No
44	CNU	Cocos nucifera	Coconut Palm	0.6	25	20	Site	x			No
45	CNU	Cocos nucifera	Coconut Palm	0.6	18	20	Site	x			No
46	CNU	Cocos nucifera	Coconut Palm	0.6	25	20	Site	x			No
	PCA	Phoenix canariensis						X			
47		Phoenix canariensis Phoenix canariensis	Canary Island Date Palm	23	22	20	Site		+		No No
48	PCA		Canary Island Date Palm	23	22	20	Site	X	+		No
	PCA	Phoenix canariensis	Canary Island Date Palm	23	22	20	Site	X	-		No
50	PCA	Phoenix canariensis	Canary Island Date Palm	14	25	20	Site	X	-		No
51	PCA	Phoerix canariensis	Canary Island Date Palm	14	25	20	Site	X	-		No
52	PCA	Phoenix canariensis	Canary Island Date Palm	14	25	20	Site	Х	-		No
53	PCA	Phoerix canariensis	Canary Island Date Palm	14	25	20	Site	Х			No
		Phoenix canariensis	Canary Island Date Palm	14	25	20	Site	X	1		No
54 55	PCA PCA	Phoerix canariensis	Canary Island Date Palm	14	25	20	Site	х			No



Rev.	Date	Rev.	Date
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Ritz-Sagamore 1 Lincoln Road Miami Beach, FL 33139



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Peter Anselmo R.L.A. FL #6667221

-	Date	11-12-2021	Sheet No.
-	Scale	NTS	L-3.01
	Project	Ritz Sagamore	

EY#	ABRV.	BOTANICAL NAME	COMMON NAME		SIZE		LOCATION		DISPOSITION	MITIGATIO REQ'D
56	PCA	Phoenix canariensis	Canary Island Date Palm	14	25	20	Site	х		No
57	PCA	Phoenix canariensis	Canary Island Date Palm	14	25	20	Beach Walk	х		No
58	PCA	Phoenix canariensis	Canary Island Date Palm	14	25	20	Beach Walk	х		No
59	PCA	Phoenix canariensis	Canary Island Date Palm	14	25	20	Beach Walk	х		No
60	PCA	Phoenix canariensis	Canary Island Date Palm	14	25	20	Beach Walk Access	X		No
61	PCA	Phoenix canariensis	Canary Island Date Palm	14	25	20	Beach Walk Access	х		No
62	PCA	Phoenix canariensis	Canary Island Date Palm	14	25	20	Beach Walk Access	х		No
63	PCA	Phoenix canariensis	Canary Island Date Palm	14	25	20	Beach Walk Access	X		No
64	CNU	Cocos nucifera	Coconut Palm	0.7	25	20	Site	X		No
65	CNU	Cocos nucifera	Coconut Palm	0.7	25	20	Site	X		No
66	CNU	Cocos nucifera	Coconut Palm	0.7	20	20	Site	X		No
67	CNU	Cocos nucifera	Coconut Palm	0.7	20	20	Site	x		No
68	PCA	Phoenix canariensis	Canary Island Date Palm	1.3	25	20	Site	X		No
69		Phoenix canariensis	Canary Island Date Palm		25	20	Site	x		
70	PCA	Cocos nucifera	Coconut Palm	0.7	22	20	Site	X	 	No No
71	PCA	Phoenix canariensis	Canary Island Date Palm	1.3	25	20	Site	X		No
72	PCA	Phoenix canariensis	Canary Island Date Palm	1.3	25	20	Site	X		No
73	CNU	Cocos nucifera	Coconut Palm	0.7	30	20	Site	X	+	No
74	CNU	Cocos nucifera	Coconut Palm	0.7	22	20	Site	X	+ + -	No
75	CNU	Cocos nucifera	Coconut Palm	0.7	30	20	Site	Х		No
76			Not Located						X	No
77			Not Located						X	No
78			Not Located	on Survey					X	No
79	CNU	Cocos nucifera	Coconut Palm	0.7	20	20	Site		X	No
80	CNU	Cocos nucifera	Coconut Palm	0.7	20	20	Site		X	No
81	CNU	Cocos nucifera	Coconut Palm	0.7	20	20	Site		X	No
82	CNU	Cocos nucifera	Coconut Palm	0.7	20	20	Site	х		No
83	CNU	Cocos nucifera	Coconut Palm				Site	х		No
84			Not Located	on Survey					X	No
85	CNU	Cocos nucifera	Coconut Palm				Site	х		No
86	CNU	Cocos nucifera	Coconut Palm				Site	х		No
87	CNU	Cocos nucifera	Coconut Palm				Site	х		No
88	SPA	Sabal palmetto	Cabbage Palm	10	12	14	Beach Walk	х		No
89	SPA	Sabal palmetto	Cabbage Palm	12	12	10	Beach Walk	х		No
90	SPA	Sabal palmetto	Cabbage Palm	12	14	12	Beach Walk	х		No
91	SPA	Sabal palmetto	Cabbage Palm	12	14	12	Beach walk	x		No
92	SPA	Sabal palmetto	Cabbage Palm	12	14	12	Beach Walk	x		No
93	0.71		Unknown to Surveyor				Dune	x		No
94			Unknown to Surveyor				Dune	x		No
95	1		Unknown to Surveyor				Dune	X		No
	1		· · · · · · · · · · · · · · · · · · ·						+ + -	
96 97	+		Unknown to Surveyor Unknown to Surveyor				Dune Dune	X X	 	No No
	+								 	
98	+		Unknown to Surveyor				Dune	X	+ + -	No
99	-		Unknown to Surveyor				Dune	X		No
100	-		Unknown to Surveyor				Dune	X	 	No
101	1		Unknown to Surveyor				Dune	Х		No
102	1		Unknown to Surveyor				Dune	Х		No
103			Unknown to Surveyor				Dune	Х		No
104			Unknown to Surveyor				Dune	х		No
105	1		Unknown to Surveyor				Dune	х		No
106			Unknown to Surveyor				Dune	х		No
107			Unknown to Surveyor				Dune	х		No
108			Unknown to Surveyor				Dune	х		No
109			Unknown to Surveyor				Dune	х		No
110			Unknown to Surveyor				Beach Walk	х		No
111			Unknown to Surveyor				Beach Walk	X		No
112			Unknown to Surveyor				Beach Walk	x		No
113			Unknown to Surveyor				Beach Walk	x		No
114	1		Unknown to Surveyor				Dune	x		No
7.179	_		Unknown to Surveyor				Dune	X		No
115										



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Ritz-Sagamore 1 Lincoln Road Miami Beach, FL 33139



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ļ.	Scale	NTS	L-3.02	
	Project	Ritz Sagamore		

RITZ CAR			<u> </u>							MITIGATIO
EY#	ABRV.	BOTANICAL NAME	COMMON NAME		SIZE		LOCATION		DISPOSITION	REQ'D
116	CNU	Cocos nucifera	Coconut Palm	10	25	12	Beach Walk	Х	<u> </u>	No
117	CNU	Cocos nucifera	Coconut Palm	8	25	12	Site		X	No
118	CNU	Cocos nucifera	Coconut Palm	8	25	12	Site		X	No
119	-		Not Located on Survey						X	No
120	-		Not Located on Survey						X	No
121			Not Located on Survey						X	No
122		1	Not Located on Survey						X	No
123	CNU	Cocos nucifera	Coconut Palm				Site		X	No
124	CNU	Cocos nucifera	Coconut Palm				Site		X	No
125	CNU	Cocos nucifera	Coconut Palm	10	25	16	Site		X	No
126	CNU	Cocos nucifera	Coconut Palm	10	22	16	Site		X	No
127	SPA	Sabal palmetto	Cabbage Palm	4	15	6	Site		X	No
128	SPA	Sabal palmetto	Cabbage Palm	4	12	5	Site		x	No
129	SPA	Sabal palmetto	Cabbage Palm	4	15	6	Site		x	No
130	SPA	Sabal palmetto	Cabbage Palm	10	25	18	Site		х	No
131	CNU	Cocos nucifera	Coconut Palm	10	25	10	Site		х	No
132	CNU	Cocos nucifera	Coconut Palm	8	25	12	Site		x	No
133	CNU	Cocos nucifera	Coconut Palm	8	25	12	Site		x	No
134	CNU	Cocos nucifera	Coconut Palm	8	25	12	Site		X	No
135	CNU	Cocos nucifera	Coconut Palm	10	30	16	Site		x	No
136	CNU	Cocos nucifera	Coconut Palm	8	25	12	Site		x	No
137	CNU	Cocos nucifera	Coconut Palm	10	25	14	Site		T x	No
138	SPA	Sabal palmetto	Cabbage Palm	10		16			x	No
	SPA	Sabarbannetto	_	10	30	16	Site		 	
139			Unknown to Surveyor				Beach Walk	X		No
140			Unknown to Surveyor				Beach Walk	X		No
141	-		Unknown to Surveyor				DUNE	Х		No
142			Unknown to Surveyor				DUNE	Х		No
143			Unknown to Surveyor				DUNE	X		No
144			Unknown to Surveyor				DUNE	Х		No
145			Unknown to Surveyor				DUNE	Х		No
146			Unknown to Surveyor				DUNE	X		No
147			Unknown to Surveyor				DUNE	х		No
148			Unknown to Surveyor				DUNE	х		No
149			Unknown to Surveyor				DUNE	х		No
150			Unknown to Surveyor				DUNE	х		No
151			Unknown to Surveyor				DUNE	х		No
152			Unknown to Surveyor				DUNE	х		No
153			Unknown to Surveyor				DUNE	х		No
154	CNU	Cocos nucifera	Coconut Palm	7	15	14	Site	_ ··-	x	No
155	CNU	Cocos nucifera	Coconut Palm	10	20	18	Site		x	No
156	CNU	Cocos nucifera	Coconut Palm	10	40	20	Site		x	No
		Cocos nucifera	Coconut Palm	9					x	
157 158	CNU	Cocos nucifera Cocos nucifera	Coconut Palm	8	20 30	18 18	Site Site	-		No No
	_							_	X	
159	CNU	Cocos nucifera	Coconut Palm	10	25	16	Site	-	X	No
160	CNU	Cocos nucifera	Coconut Palm	10	30	16	Site	-	X	No
161	CNU	Cocos nucifera	Coconut Palm	10	30	16	Site	-	X	No
162	CNU	Cocos nucifera	Coconut Palm	10	35	12	Site		X	No
163	CNU	Cocos nucifera	Coconut Palm	10	30	16	Site		X	No
164	CNU	Cocos nucifera	Coconut Palm	10	20	8	Site		X	No
165	CER	Conocarpus erectus	Silver Buttonwood	8	14	4	Beach Walk	х		No
166	SPA	Sabal palmetto	Cabbage Palm	4	16	8	Site		x	No
167	CER	Conocarpus erectus	Silver Buttonwood	8	14	4	Beach Walk	х		No
168	CER	Conocarpus erectus	Silver Buttonwood	8	14	4	Beach Walk	х		No
169	WRO	Washingtonia robusta	Washingtonia Palm	10	35	10	Site	х		No
170	1		Not Located on Survey						x	No
171	CNU	Cocos nucifera	Coconut Palm	12	15	15	Site		x	No
172	CNU	Cocos nucifera	Coconut Palm	8	15	10	Site		x	No
173	CNU	Cocos nucifera	Coconut Palm	8	15	10	Site	_	X	No
474		Cocos nucifera	Coconut Palm	12	15	15	Site	1	X	No
174 175	CNU	Cocos nucifera	Coconut Palm	12	15	15	Site		X	No



Date	Rev.	Date
		Date Nev.

Ritz-Sagamore 1 Lincoln Road Miami Beach, FL 33139

Owner: Name Address Address Tel: Email

Consultant

Consultant

Desirone Consulting Engineering
Address
Addres



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	. [Project	Ritz Sagamore	

EY#	ABRV.	BOTANICAL NAME	COMMON NAME		SIZE		LOCATION		DIEDORITIO	u	MITIGATION REQ'D
177	CNU	Cocos nucifera	Coconut Palm	10	15	15	Site		DISPOSITION	x x	No No
178	CNU	Cocos nucifera	Coconut Palm	7	15	10	Site			X	No
179	CNU	Cocos nucifera	Coconut Palm	8	20	15	Site			×	No
180	CNU	Cocos nucifera	Coconut Palm	12	15	15	Site			x	No
181	CNU	Cocos nucifera	Coconut Palm	7	10	10	Site			x	No
182	CNU	Cocos nucifera	Coconut Palm	7	10	10	Site			x	No
183	CNU	Cocos nucifera	Coconut Palm	7	10	10	Site			x	No
184	CNU	Cocos nucifera	Coconut Palm	7	10	10	Site			x	No
185	CNU	Cocos nucifera	Coconut Palm	8	8	12	Site			×	No
186	CNU	Cocos nucifera	Coconut Palm	7	20	15	Site	х			No
187	CNU	Cocos nucifera	Coconut Palm	12	20	15	Site	X			No
188	CNU	Cocos nucifera	Coconut Palm	12	25	10	Site	x			No
189	CNU	Cocos nucifera	Coconut Palm	8	20	10	Site	x			No
190	CNU	Cocos nucifera	Coconut Palm	8	30	15	Site	X			No
											
191	CNU	Cocos nucifera Cocos nucifera	Coconut Palm Coconut Palm	8	30	15	Site	X			No
192		Cocos nucifera	Coconut Palm	_	15	15	Site	X			No No
193	CNU			8	20	15	Site				No
194	CNU	Cocos nucifera	Coconut Palm	12	15	15	Site	X			No
195	CNU	Cocos nucifera	Coconut Palm	8	15	12	Site	X			No
196	CER	Conocarpus erectus	Green Buttonwood	4	12	6	Site	X			No
197	CER	Conocarpus erectus Conocarpus erectus	Green Buttonwood Green Buttonwood	4	12	6	Site	X			No
198	CER	Conocarpus erectus	Green Buttonwood	4	12	6	Site	^			No
AGAMO	$\overline{}$		1	_	_	_					
2652	CNU	Cocos nucifera	Coconut Palm	12	25	20	Site	Х			No
2653	CNU	Cocos nucifera	Coconut Palm	12	35	20	Site	Х			No
2654	CNU	Cocos nucifera	Coconut Palm	12	25	20	Site	Х			No
2655	RMA	Ravenala madagascariensis	Travellers Palm	12	4	6	Site	Х			No
2656	RMA	Ravenala madagascariensis	Travellers Palm	12	10	6	Site	Х			No
2657	RMA	Ravenala madagascariensis	Travellers Palm	12	4	10	Site	Х			No
2660	CNU	Cocos nucifera	Coconut Palm	12	30	20	Site			X	No
2661	CNU	Cocos nucifera	Coconut Palm	12	35	20	Site			Х	No
2662	CNU	Cocos nucifera	Coconut Palm	12	32	22	Site			Х	No
2663	CNU	Cocos nucifera	Coconut Palm	12	35	20	Site			Х	No
2666	CNU	Cocos nucifera	Coconut Palm	9	38	24	Site			х	No
2667	CNU	Cocos nucifera	Coconut Palm	10	35	24	Site			х	No
2668	CNU	Cocos nucifera	Coconut Palm	9	35	24	Site			Х	No
2669	CNU	Cocos nucifera	Coconut Palm	8	28	24	Site			х	No
2670	CNU	Cocos nucifera	Coconut Palm	8	30	24	Site			х	No
2671	CNU	Cocos nucifera	Coconut Palm	9	30	20	Site			Х	No
2672	CNU	Cocos nucifera	Coconut Palm	11	25	24	Site			Х	No
2673	CNU	Cocos nucifera	Coconut Palm	12	30	18	Site			Х	No
2674	CNU	Cocos nucifera	Coconut Palm	10	28	20	Site			х	No
2675	CNU	Cocos nucifera	Coconut Palm	7	25	16	Site			х	No
2676	CNU	Cocos nucifera	Coconut Palm	8	24	14	Site			х	No
2677	CNU	Cocos nucifera	Coconut Palm	7	20	18	Site			х	No
2678	CNU	Cocos nucifera	Coconut Palm	7	20	16	Site			х	No
2679	CNU	Cocos nucifera	Coconut Palm	8	18	16	Site			х	No
2680	CNU	Cocos nucifera	Coconut Palm	8	18	16	RIGHT OF WAY	х			No
2681	CNU	Cocos nucifera	Coconut Palm	8	18	16	RIGHT OF WAY	Х			No
JMMAR											
		ng On-Site Trees / Palms:			120	(NOT INC	LUDING OFF-SITE TR	EES ON E	BEACH WALL	(ACCES	S, BEACH WAL
		ite Trees / Palms to Remain: ite Trees / Palms to be Relocat	ed:		55 65	-					
		ng R.O.W Trees / Palms:	оч.		35						
		ng R.O.W Trees / Palms to Rei	main:		35						
		ng R.O.W Trees / Palms to be			0						



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Ritz-Sagamore 1 Lincoln Road Miami Beach, FL 33139

Owner:
Name Di Lido Beach Resort L
Address EBJ Sagamore LLC.
Sobe Sky Developmer

onsultant: ame STUDIO MUNGE. ddress 25 Wingold Avenue, ddress Toronto, ON Canada M68

isultant: MEP

10 M3 Engineering.
10ss 6915 Red Road, Suite 2
12808 Research Blad

ress 2800 Biscayne Bhd Miami, FL, 33137 305,755,3833

me dress Desimore Consulting Engineer 800 Brickell Avenue, 6th Floor 800 Brickell Avenue, 6th Floor 81 Mamil, FL 33131 905.441.0755


Architect or Record:
Kobi Karp Architecture and Interior Design, In
571 NW 28TH ST
Miami, Florida 33137 USA
Tel: +1(305) 573 1818
Fax: +1(305) 573 3796




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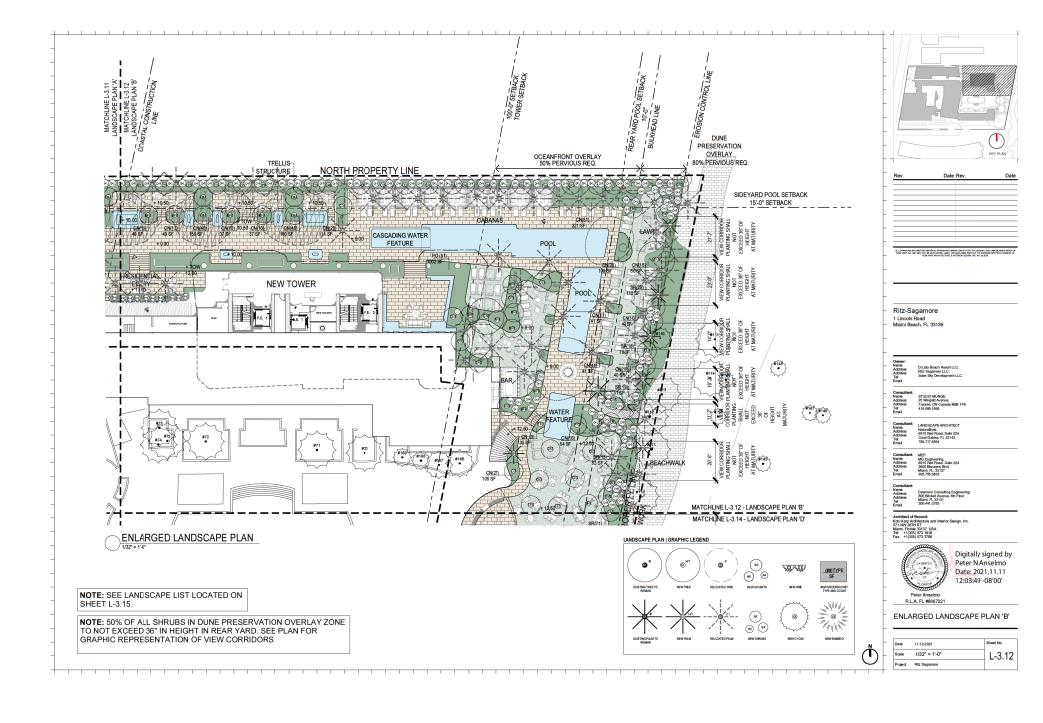
Peter Anselmo R.L.A. FL #6667221


-	Date	11-12-2021	Sheet No.	
-	Scale	NTS	L-3.04	
	Project	Ritz Sagamore		




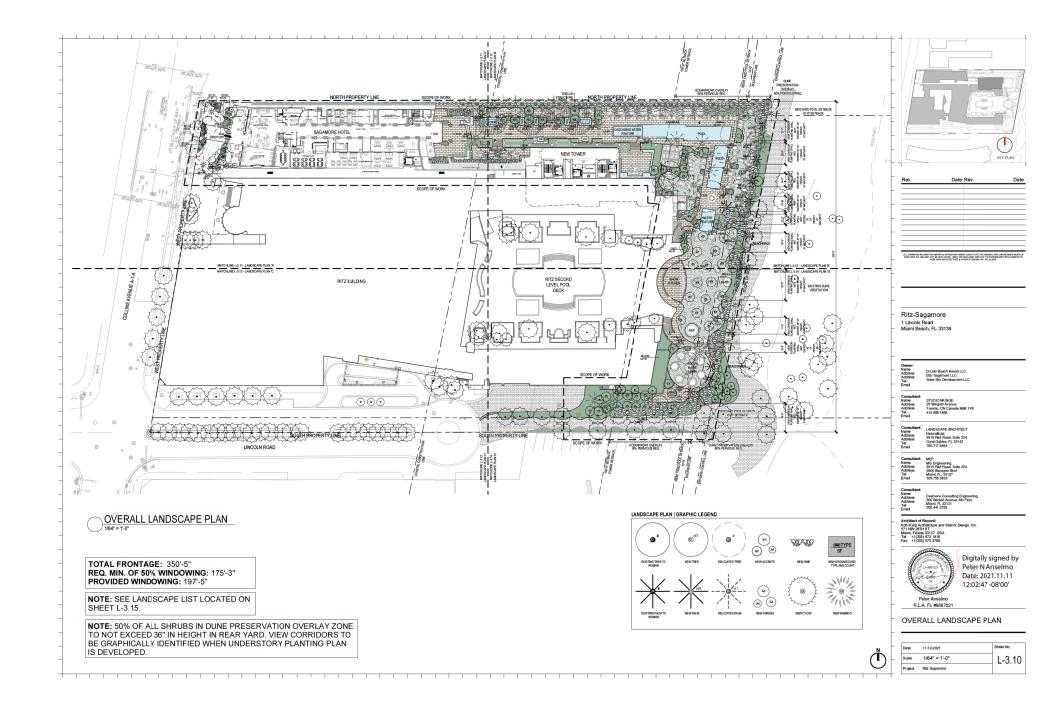

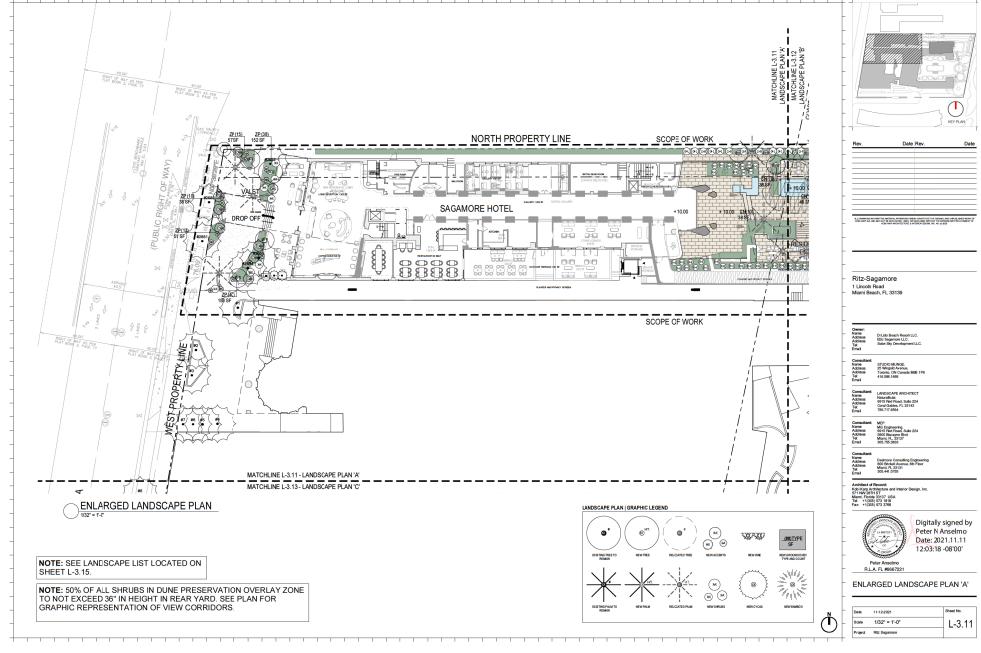



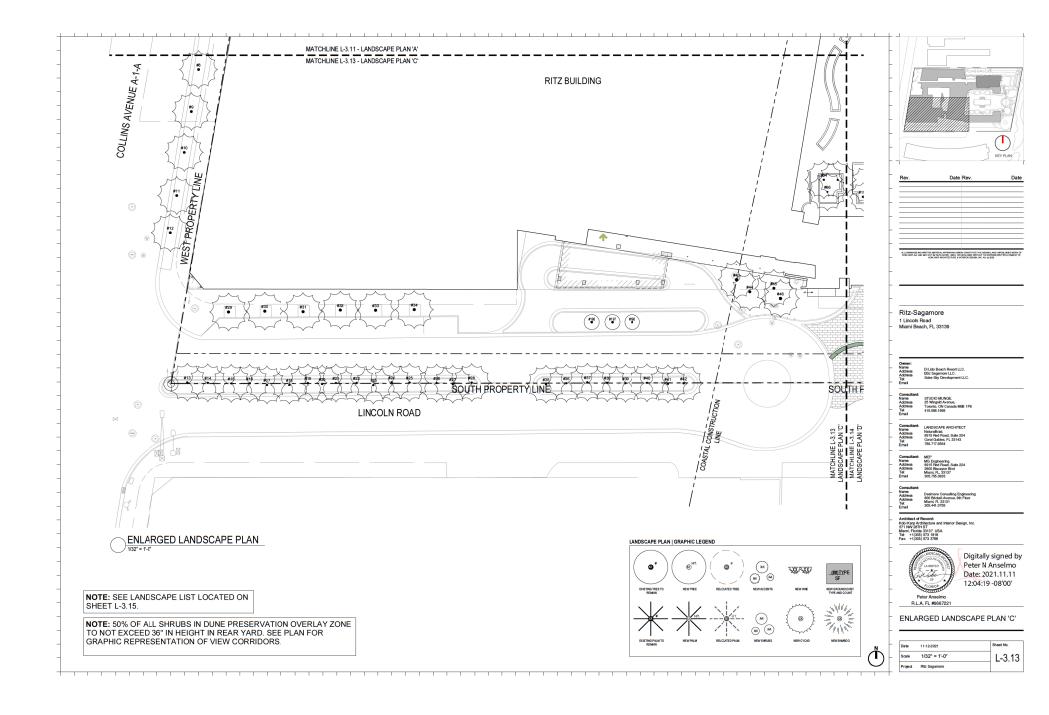

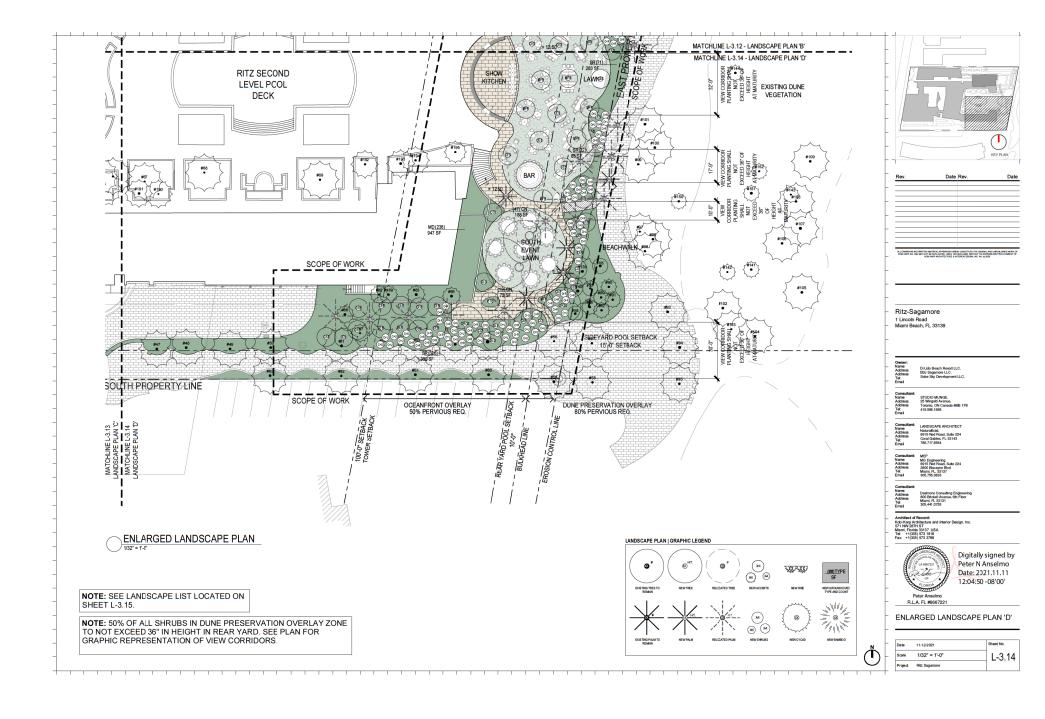

المحمد	SAGAMORE + RITZ PLANT LIST 2021.09.07						DPO	IGHT
QTY	TY ABRV. BOTANICAL NAME		A BOTANICAL NAME COMMON NAME SPECIFICATIONS		FL. NATIVE		DROUGHT TOLERANT	
TREES (C	OVER STOR	RY PLANTING)			YES	NO	YES	NC
2	BSI	Bursera simaruba	Gumbo Limbo	25' Ht. x 15' Spr.	X		х	
1	COD	Cananga odorata	Ylang Ylang	25' Ht.		х	x	
1	CSP	Ceiba speciosa	Silk Floss Tree (Fink)	30' Ht., Specimen		х	х	
18	CDI	Coccoloba diversifolia	Pigeon Plum	12'-14' Ht. x 6' Spr. Min. 6' CT.	х		х	
25	CER	Conocarpus erectus	Green Buttonwood	12'-14' Ht x 10' Spr. Mltl-trk, 2"-8" Cal. Min.,6' CT.	х		х	
21	CES	Conocarpus erectus var. sericeus	Silver Buttonwood (mlt. trk.)	16'-18 Ht., Mitt-trk, Field Grown, Specimen	х		х	
17	CRO	Clusia rosea	Autograph Tree	12'-14' Ht. x 10' Spr, Nltl-trk, Field Grown, Specimen	х		х	
4	CRO2	Clusia rosea	Autograph Tree	25' Ht. x 15' Spr.	х		х	
5	FMA	Ficus maclellandii	Ficus Alii	200 Gal.		х		х
3	GLU	Gymnanthes lucida	Crabwood	12'-14' Ht. x 6' Spr. Min. 6' CT.	х		х	
24	MFR	Myrcianthes fragrans	Simpson Stopper	16'-18 Ht., Mitt-trk, Field Grown, Specimen	х		х	
3	PTO	Pithecellobium tortum	Brazilian Rain Tree	8'-10' Ht x 8' Spr. Min.		х	х	
3	TBA	Tabebula bahamensis	Bahama Tabebula (white flower)	200 Gal.	х		х	
4	TIM2	Tabebuia impetiginosa	Pink Trumpet Tree	25' Ht., 200 Gal.	х		х	
ALMS (OVER STOR	RY PLANTING)						
1	CBA	Copernicia baileyana	Bailey Palm	16' Ht.		х	х	
8	CMA	Coccothrinax mariguama	Miraguama Palm	10' Ht.		х	×	
69	CNU	Cocos nucifera	Relocated Coconut Palm	Relocated from On Site		х	х	
6	SPA	Sabal palmetto	Sabal Palm (booted trunk)	14' Ht., 18" DBH	х		х	
6	SPA2	Sabal palmetto	Sabal Palm (character trunk)	18'-25' Staggered Ht., _eaning Trunk	х		х	
SHRUBS	(UNDER ST	ORY PLANTING)						
488	CN	Clusia guttifera 'Nana'	Small Leaf Clusia	7 Gal.		х	х	
107	CR	Clusia rosea	Autograph Tree	8' Ht.	х		х	
66	CU	Coccoloba uvifera	Sea Grape	8' Ht.	х		х	
28	GL	Gymnanthes lucida	Crabwood	8' Ht.	х		х	
236	MD	Monstera deliciosa	Mexican Breadfrut	7 Gal.		х	х	
51	PO	Plumeria obtusa	Evergreen Plumeria	15 Gal.		х	х	
37	RE	Rhapis excelsa	Lady Palm	15 Gal.		х	х	
487	SR	Serenoa repens 'Silver Form'	Silver Saw Palmetto	15 Gal.	х		х	
116	ZP	Zamia pumila	Coontie	7 Gal.	×		×	

LANDSCAPE SUMMARY:

EXISTING TREES TO REMAIN: (3) CREDITS (TREES # 196, #197, #198) EXISTING PALMS TO REMAIN: (69) NOT CREDITED (COCONUT PALMS) PROPOSED TREES: (131) TREES TO BE CREDITED PROPOSED PALMS: (21) PALMS NOT CREDITED

NOTE: 50% OF ALL SHRUBS IN DUNE PRESERVATION OVERLAY ZONE TO NOT EXCEED 36" IN HEIGHT IN REAR YARD. SEE PLAN FOR GRAPHIC REPRESENTATION OF VIEW CORRIDORS.



Rev.	Date	Rev.	Date

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LANDSCAPE PLANT LIST

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Bursera simaruba Gumbo Limbo



Cananga odorata Ylang Ylang



Ceiba speciosa Silk Floss Tree



Coccoloba diversifolia Pigeon Plum



Coccoloba uvifera Seagrape



Crabwood



Clusia rosea Autograph Tree



Green Buttonwood



Silver Buttonwood



Tabebuia bahamensis Bahama Tabebuia







Ficus maclellandii

Tabebuia impetiginosa Pink Trumpet Tree






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PLANTING.	REFERENCE	IMAGES

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roject	Ritz Sagamore	



Myrcianthes fragrans

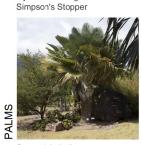Copernicia baileyana Bailey Palm



Pithecellobium tortum

Brazilian Rain Tree

Coccothrinax mariguama Mariguama Palm



Sabal palmetto Sabal Palm

GENERAL PLANTING NOTES AND SPECIFICATIONS:

CONTRACTOR SHALL BECOME FAMILIAR WITH ALL NO UNILITIES OR STRUCTURES PROG TO DISGRING, LANDSCAPE IS SHALL REPAR ALL DAMAGE TO UNDERSHOUND UTILITIES, STRUCTION CAUSED BY UTILITY DAMAGE, AT NO COST TO THE

ASSISTANTIAN BY THE LANGUAGE ARCHITECT.

ALL BULDING CONSTRUCTION MATERIAL AND FOREIGN MATERIAL SHALL BE EMOVED FROM PAINTING AREA AND REPLACED WITH 80,00 MM FILL SOL, OR OF PRESPORÇATIONS. ALL SLANGS IN PARRING LOTS AND AROUND ULDINGS, SHALL BECKNATEET TO A DEPTH OF 9 MM. AND REPLACED WITH 92D PLANT MIX OR AS PER SPECIFICATIONS.

SITE PREPARATION SHALL INCLUDE THE ERADICATION AND REMOVAL OF IT WEEDS, GRASS, AS WELLAS JLEAN-UP OF ANY DEAD MATERIAL AND FINISH ADING AS PER THE SPECS.

CONTRICTION TO DISCUSSION COST TO THE UNINEX.

3.4. IL PLANT MARRIEST TO BE LOTION A 10 PETER AS CERNED BY THE
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MATERIAL REPORT OF PLANTAGE IT FOR CONTROLL.

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TREE PROTECTION MATERIALS

TREE / PALM RELOCATION NOTES

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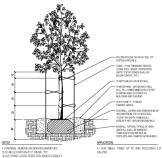
12. CORRECT ALL PROBLEMS RELATED TO SETTLEMENT, EROSION, OR

INSTALLATION


3. PLANTING PTS SHALL BE A MINIMUM OF TWO 27 TIMES LARGER IN DIAMETE AND ONE AND A HALF (1-12) TIMES LARGER IN DEPTH THAN THE ROOT BALL ROUGHEN SIDES AND BOTTOM OF PIT.

8' WAX SETWEINFOST


TREE PROTECTION DETAIL SCALE: N.T.S




(4) SMALL TREE PLANTING AND STAKING DETAIL (5) LARGE TREE PLANTING AND STAKING DETAIL (5) SQUENTS

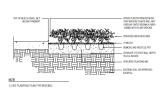



7 GROUNDCOVER PLANTING DETAIL SCALE: N.T.S

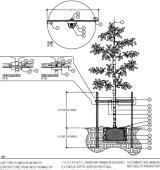


7.) 27. K. P. KEP T. LANDLONE TAMBER AS SPICISED.
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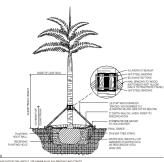


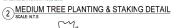

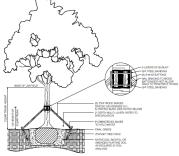
B VINE PLANTING DETAIL SCALE: N.T.S

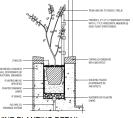

9 PLANT SPACING DETAIL
SCALE N.T.S

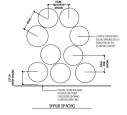

3 PALM PLANTING AND STAKING DETAIL SCAE'NTS

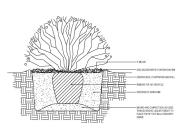

6 SHRUB PLANTING DETAIL



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GENERAL PLANTING DETAILS

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