PRIVATE RESIDENCE 11 EAST RIVO ALTO DRIVE



MIAMI BEACH, FL 33139

DRB FINAL SUBMITTAL PACKAGE 12-06-2021

ARCHITECT KOBI KARP ARCHITECTURE AND INTERIOR DESIGN, INC. 571 NW 28 th St. Miami , Florida 33127 Tel: (305) 573-1818 Fax: (305) 573-3766

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PRIVATE RESIDENCE

11 EAST RIVO ALTO DRIVE MIAMI BEACH, FL 33139

Owner: Name Address Address Tel:

Email

OWNER OWNER_ADDRESS1 OWNER_ADDRESS2 OWNER_PHONE OWNER_EMAIL


Consultant: Name Address Address Tel:

Email Consultant: Name Address

Address Tel: Email Consultant

Name Address Address Tel: Email

Architect: Kobi Karp Architecture and Interior Design, Inc. 571 NW 28th Street, Miami, Florida 33127 USA Tel: +1(305) 573 1818 Fax: +1(305) 573 3766

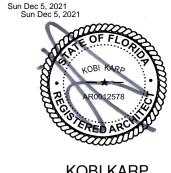




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COVER SHEET

Date 11-15-2021 Scale --Project 2191

Sheet No. A0.00



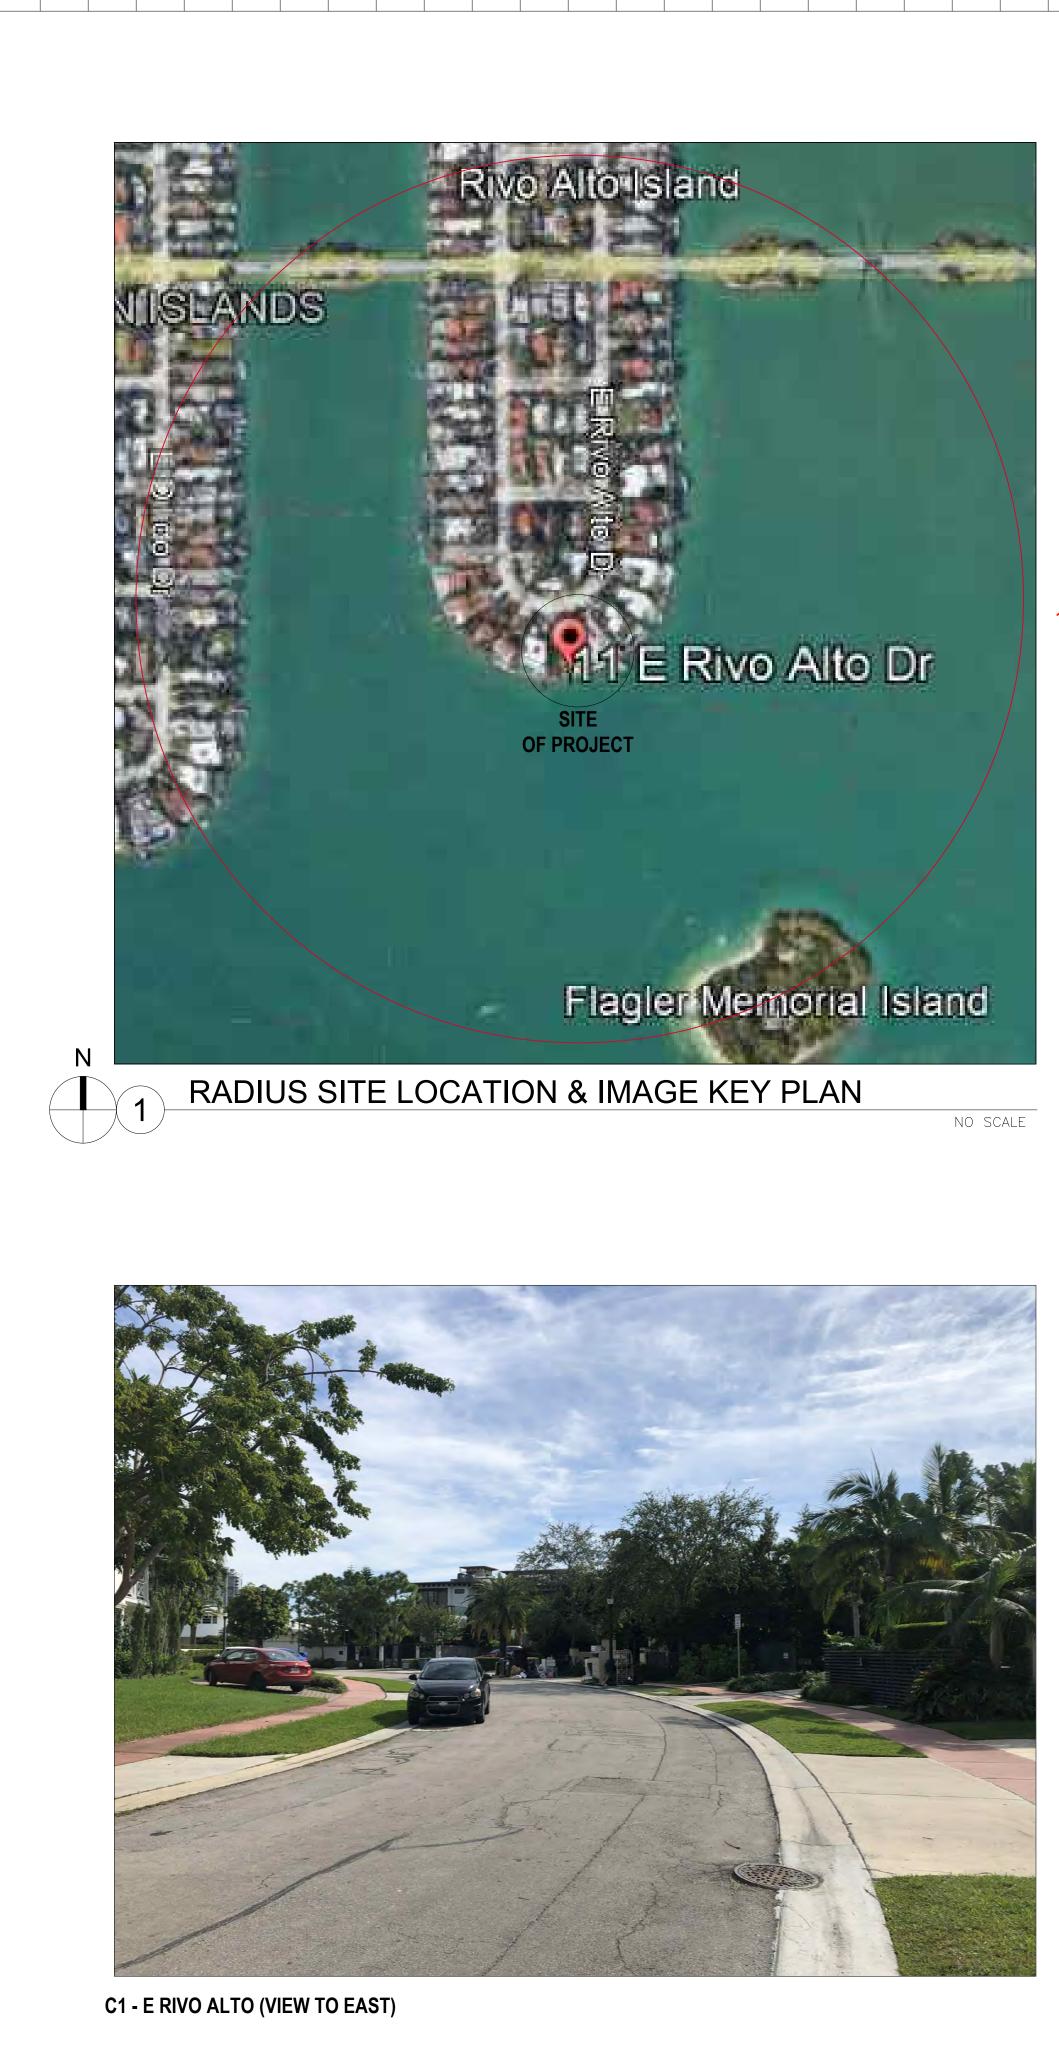

11 E.RIVO ALTO -



C2 - E RIVO ALTO (VIEW TO WEST)

IMAGES ON SHEET A0.04-CONTEXT

C1 - E. RIVO ALTO - LOOKING EAST C2 - E. RIVO ALTO - LOOKING WEST

IMAGES ON SHEET A0.05-EXISTING PROPERTY

E1 - FRONT YARD

- E2 SIDE YARD EAST
- E3 SIDE YARD WEST

E4 - REAR YARD

IMAGES ON SHEET A0.06-NEIGHBOR PROPERTY

- N1 8 E. RIVO ALTO
- N2 15 E. RIVO ALTO
- N3 10 E. RIVO ALTO

PRIVATE RESIDENCE

11 EAST RIVO ALTO DRIVE MIAMI BEACH, FL 33139

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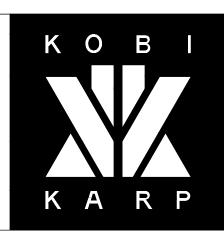
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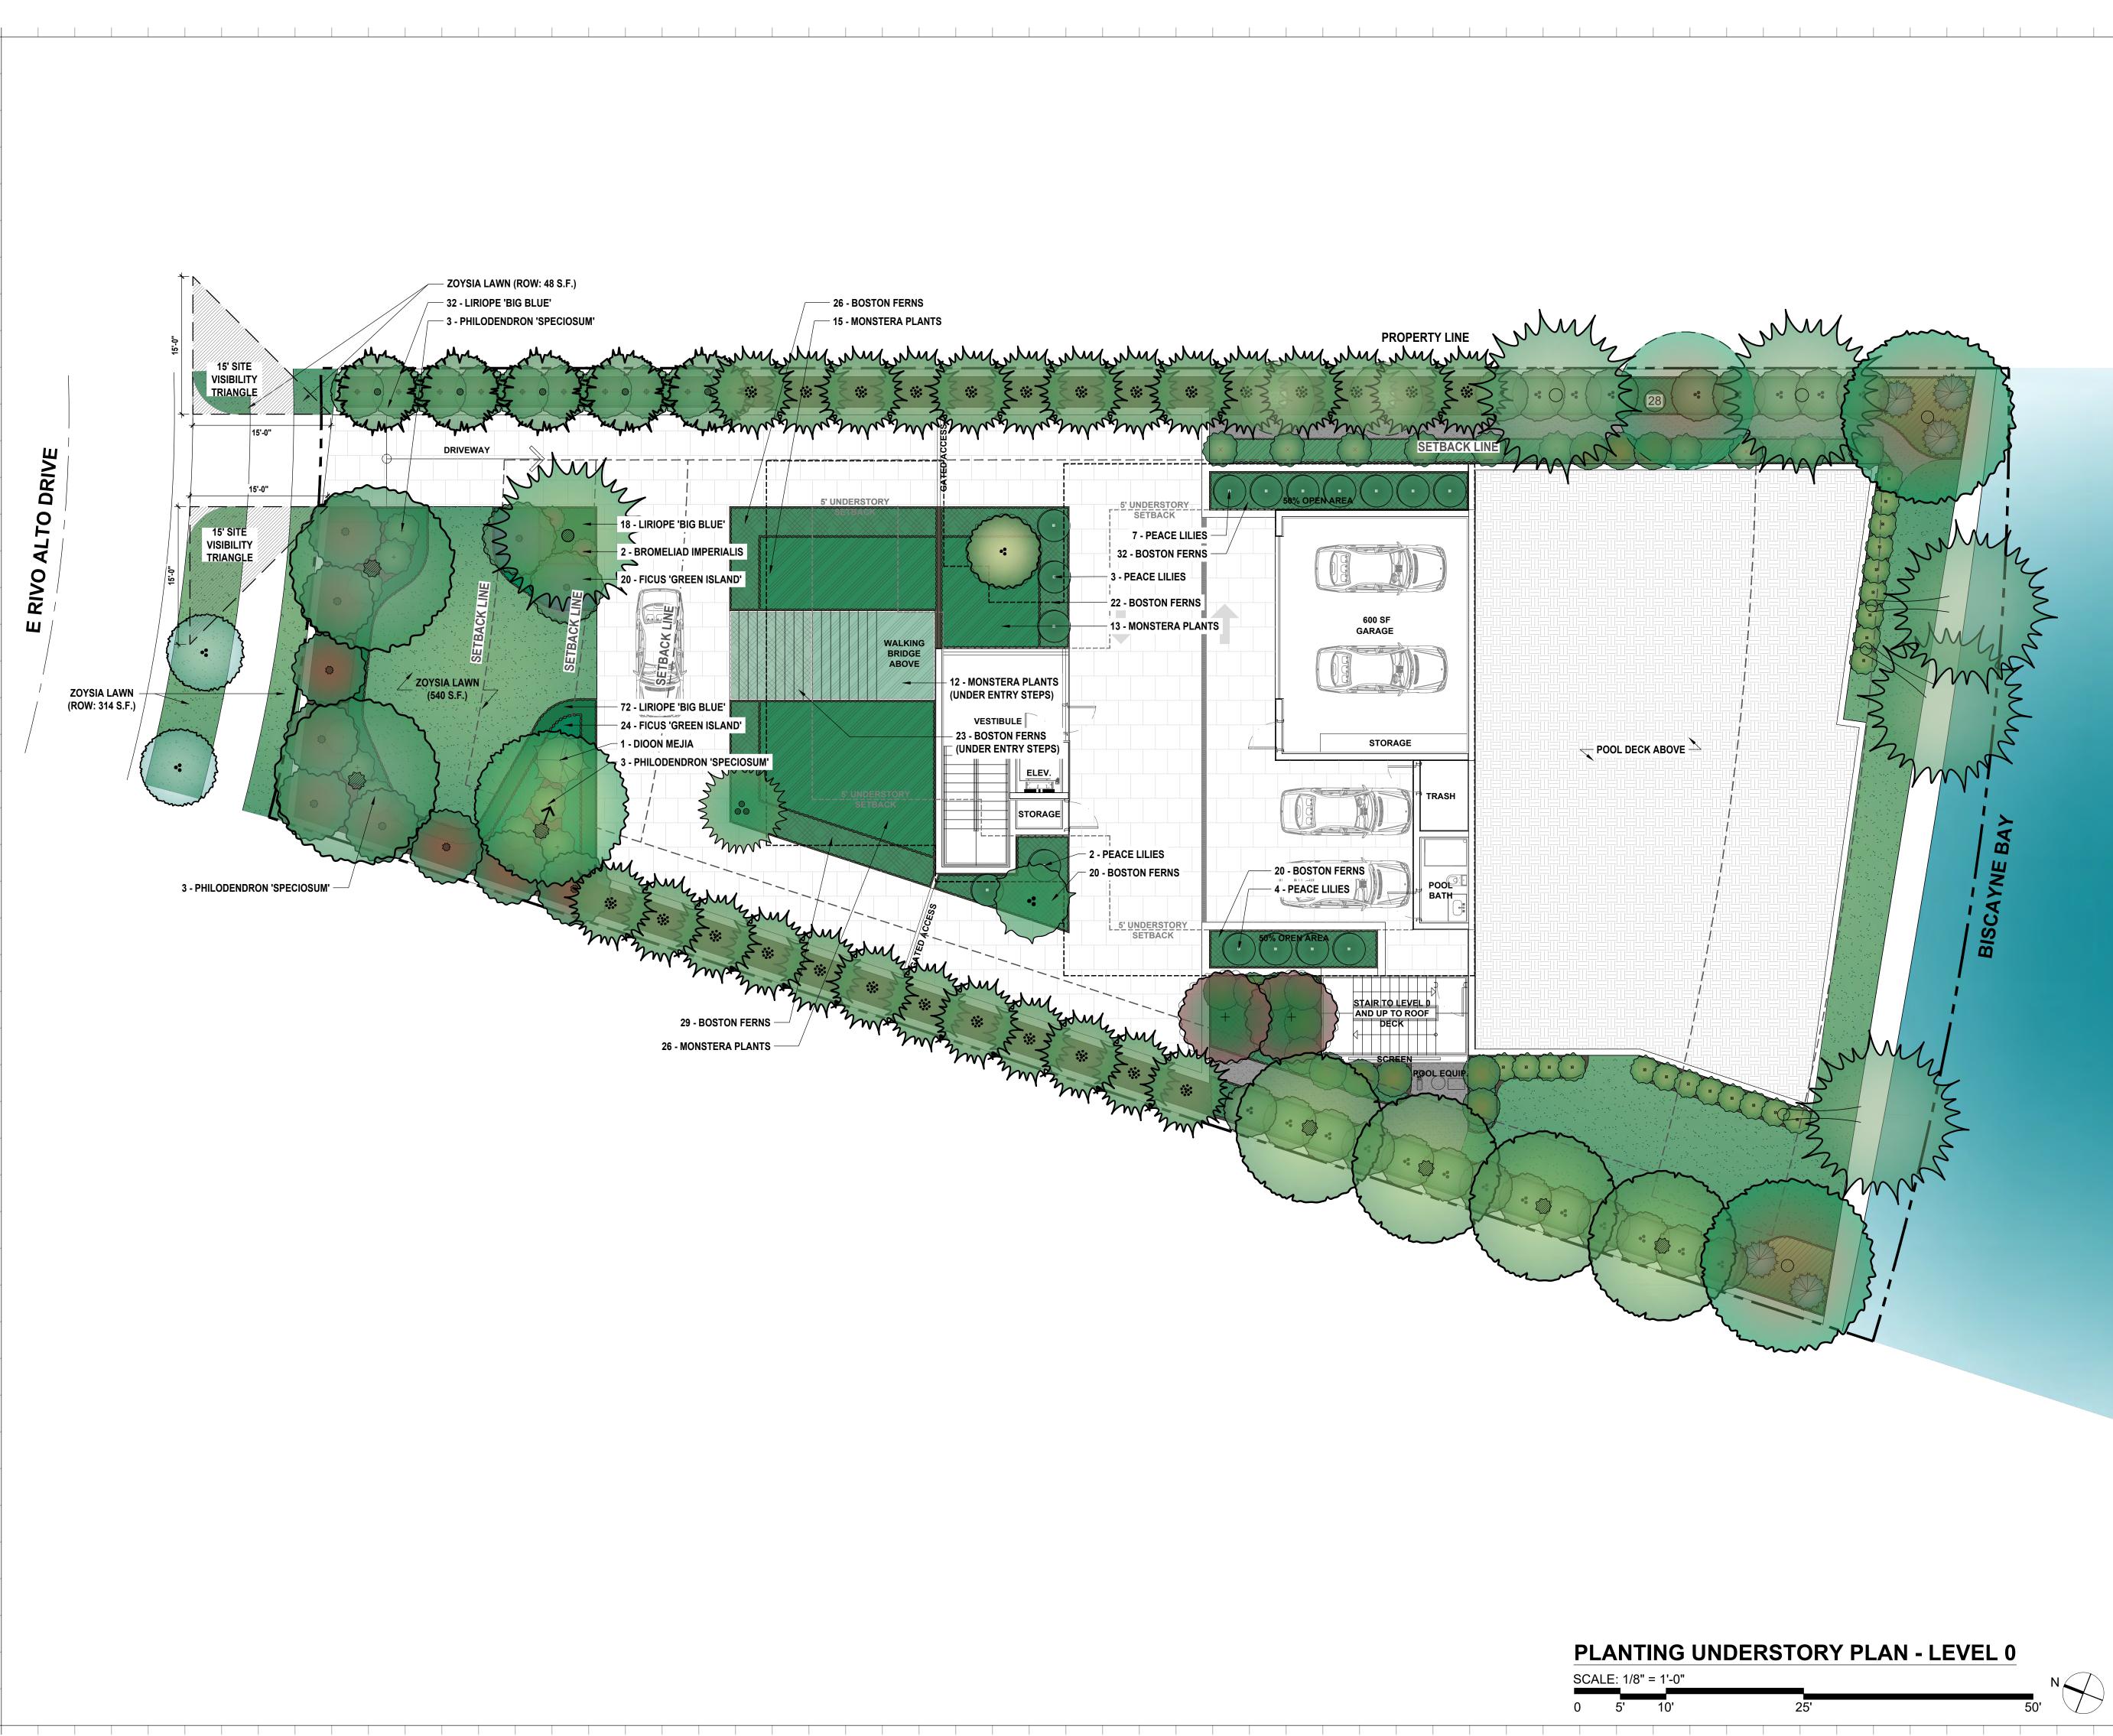


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IMAGE KEY

Date	11-15-2021
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11 EAST RIVO ALTO DRIVE MIAMI BEACH, FL 33139

Owner:


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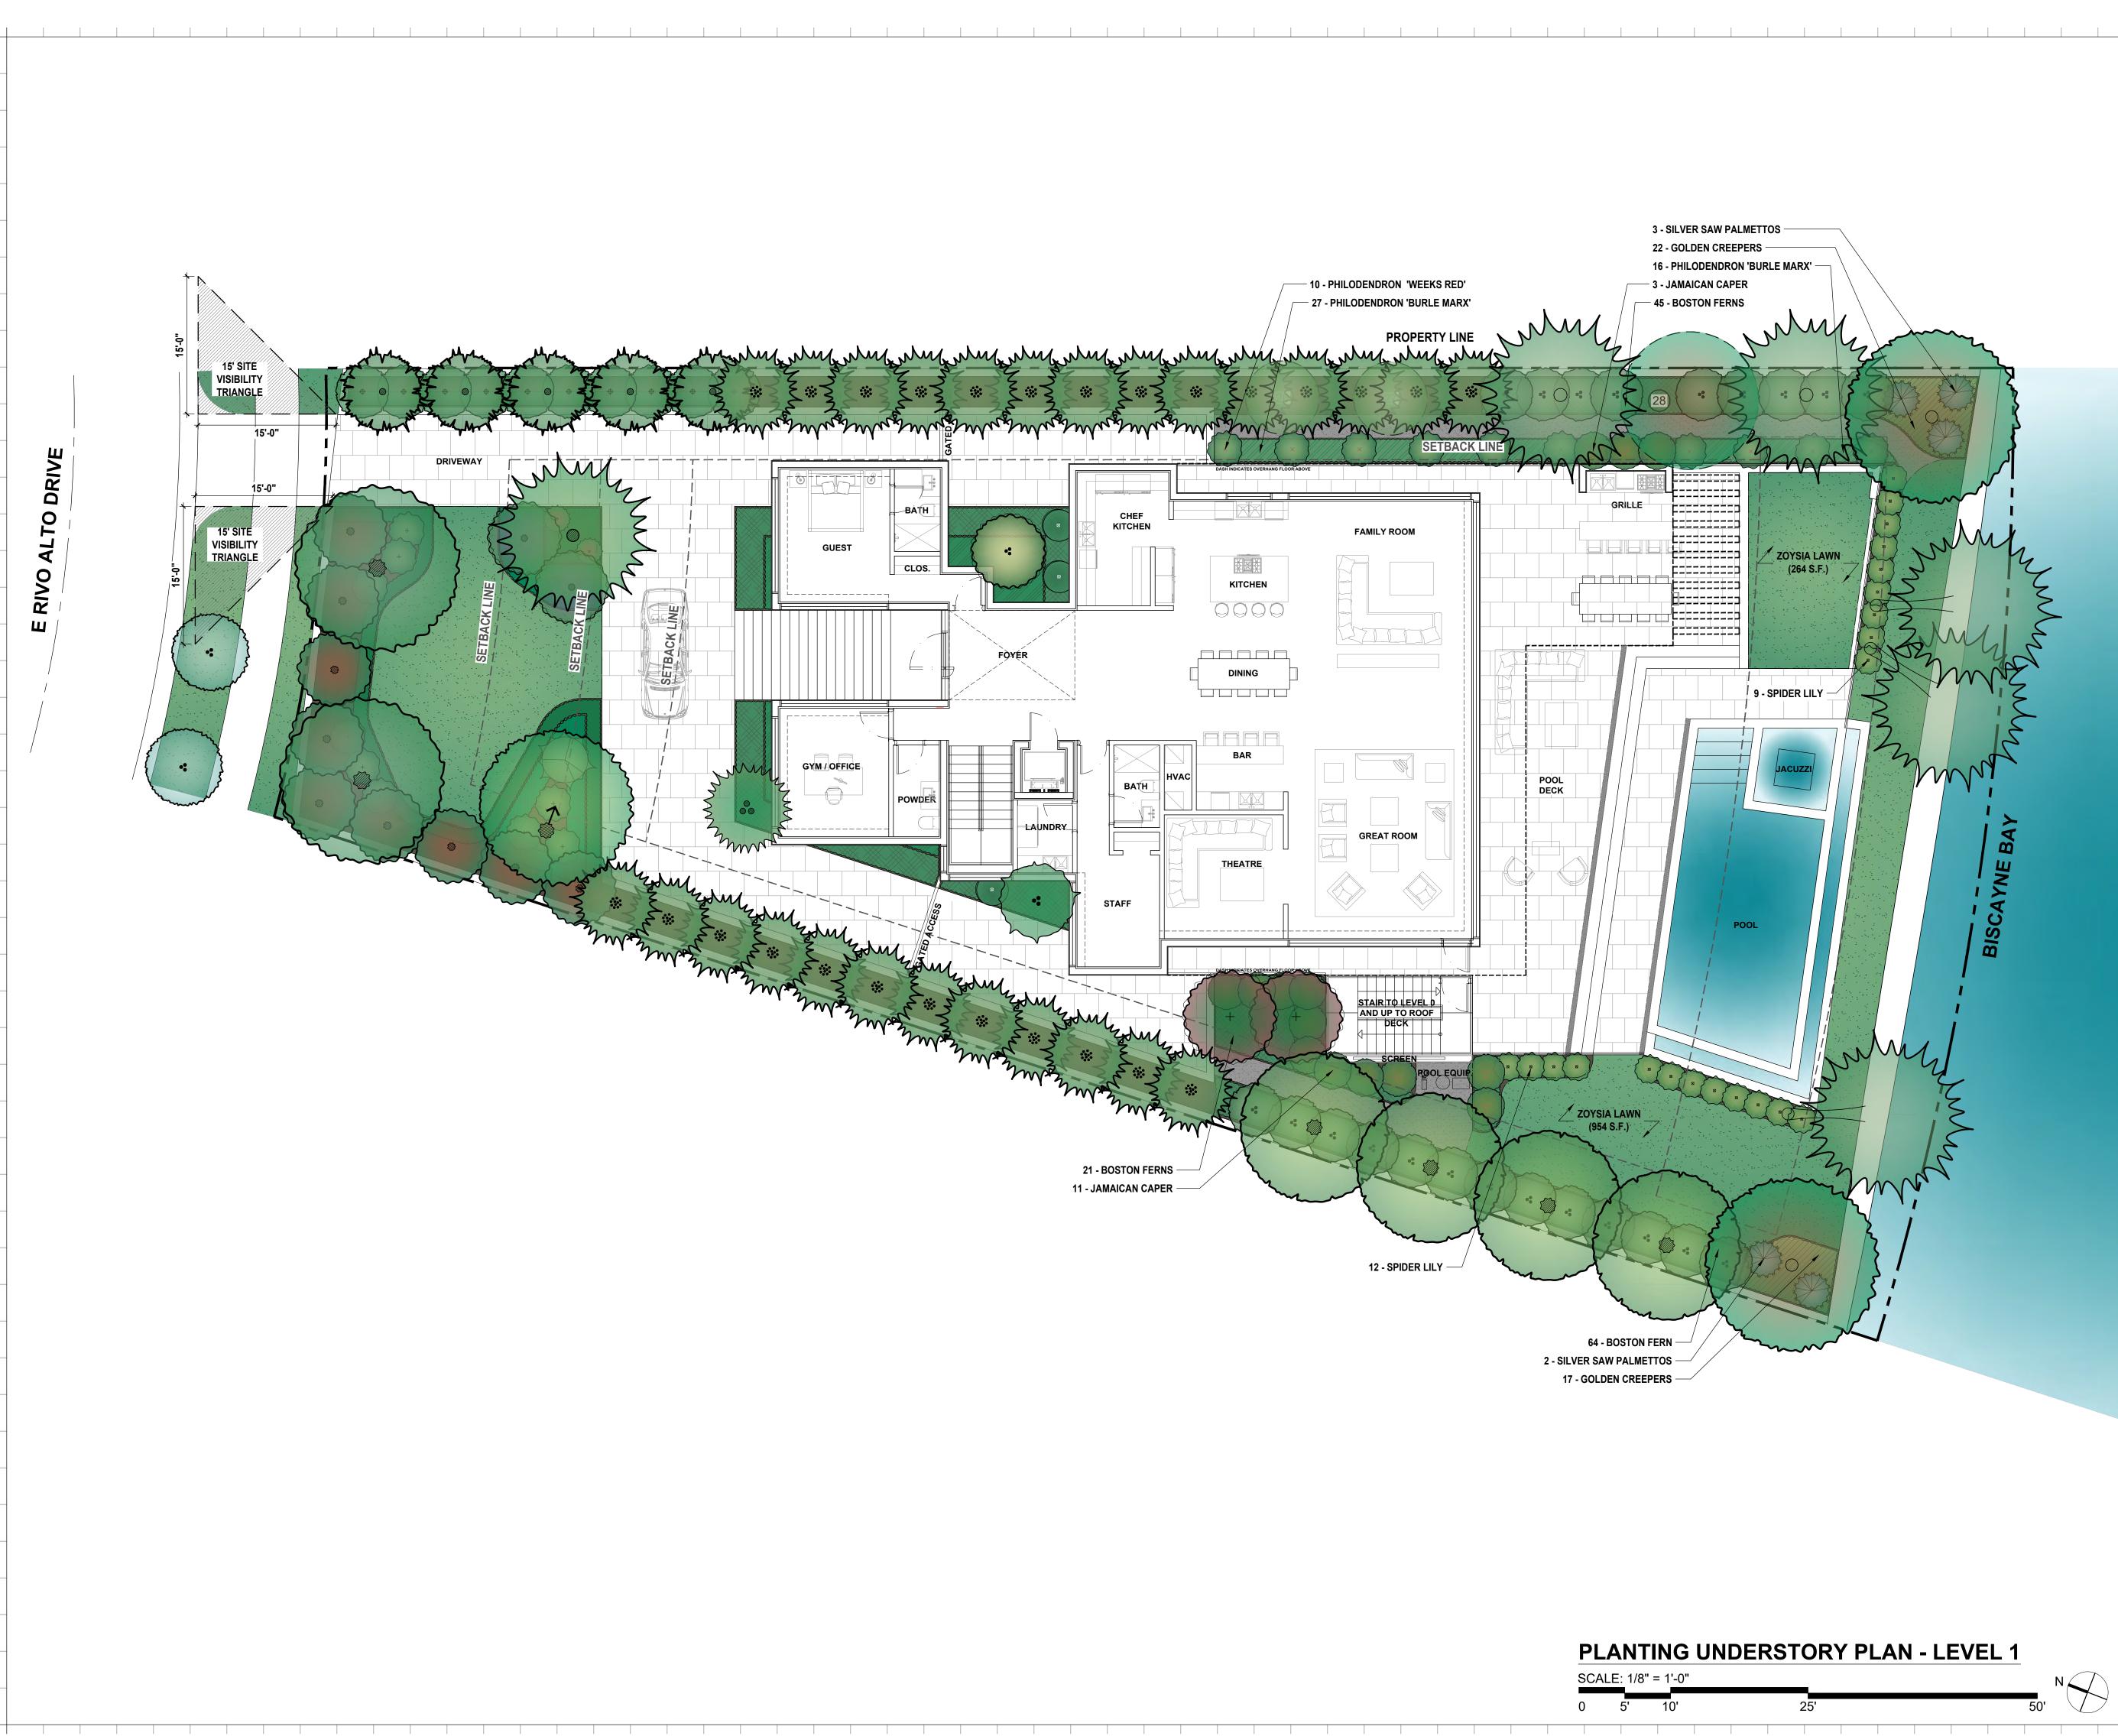
Architect of Record: Kobi Karp Architecture and Interior Design, Inc. 2915 Biscayne Boulevard, Suite #200 Miami, Florida 33137 USA Tel: +1(305) 573 1818 Fax: +1(305) 573 3766

Landscape Architect of Record: David O. Design p.o. box 331615 Coconut Grove, FL. 33233-1615, USA Tel: +1(305) 854.9299 - Fax: +1(305) 854.9882 Email: davidodesign@hotmail.com www.davidodishoo.com



PLANTING UNDERSTORY PLAN LEVEL 0

Date:	12-03-2021
Scale :	1/8"=1'-0"
Project # :	21024

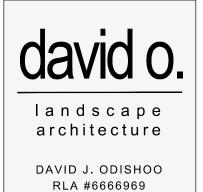

Date Rev. Date /11 12 14

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PRIVATE RESIDENCE

Consultant: Name Address Address Tel: Email

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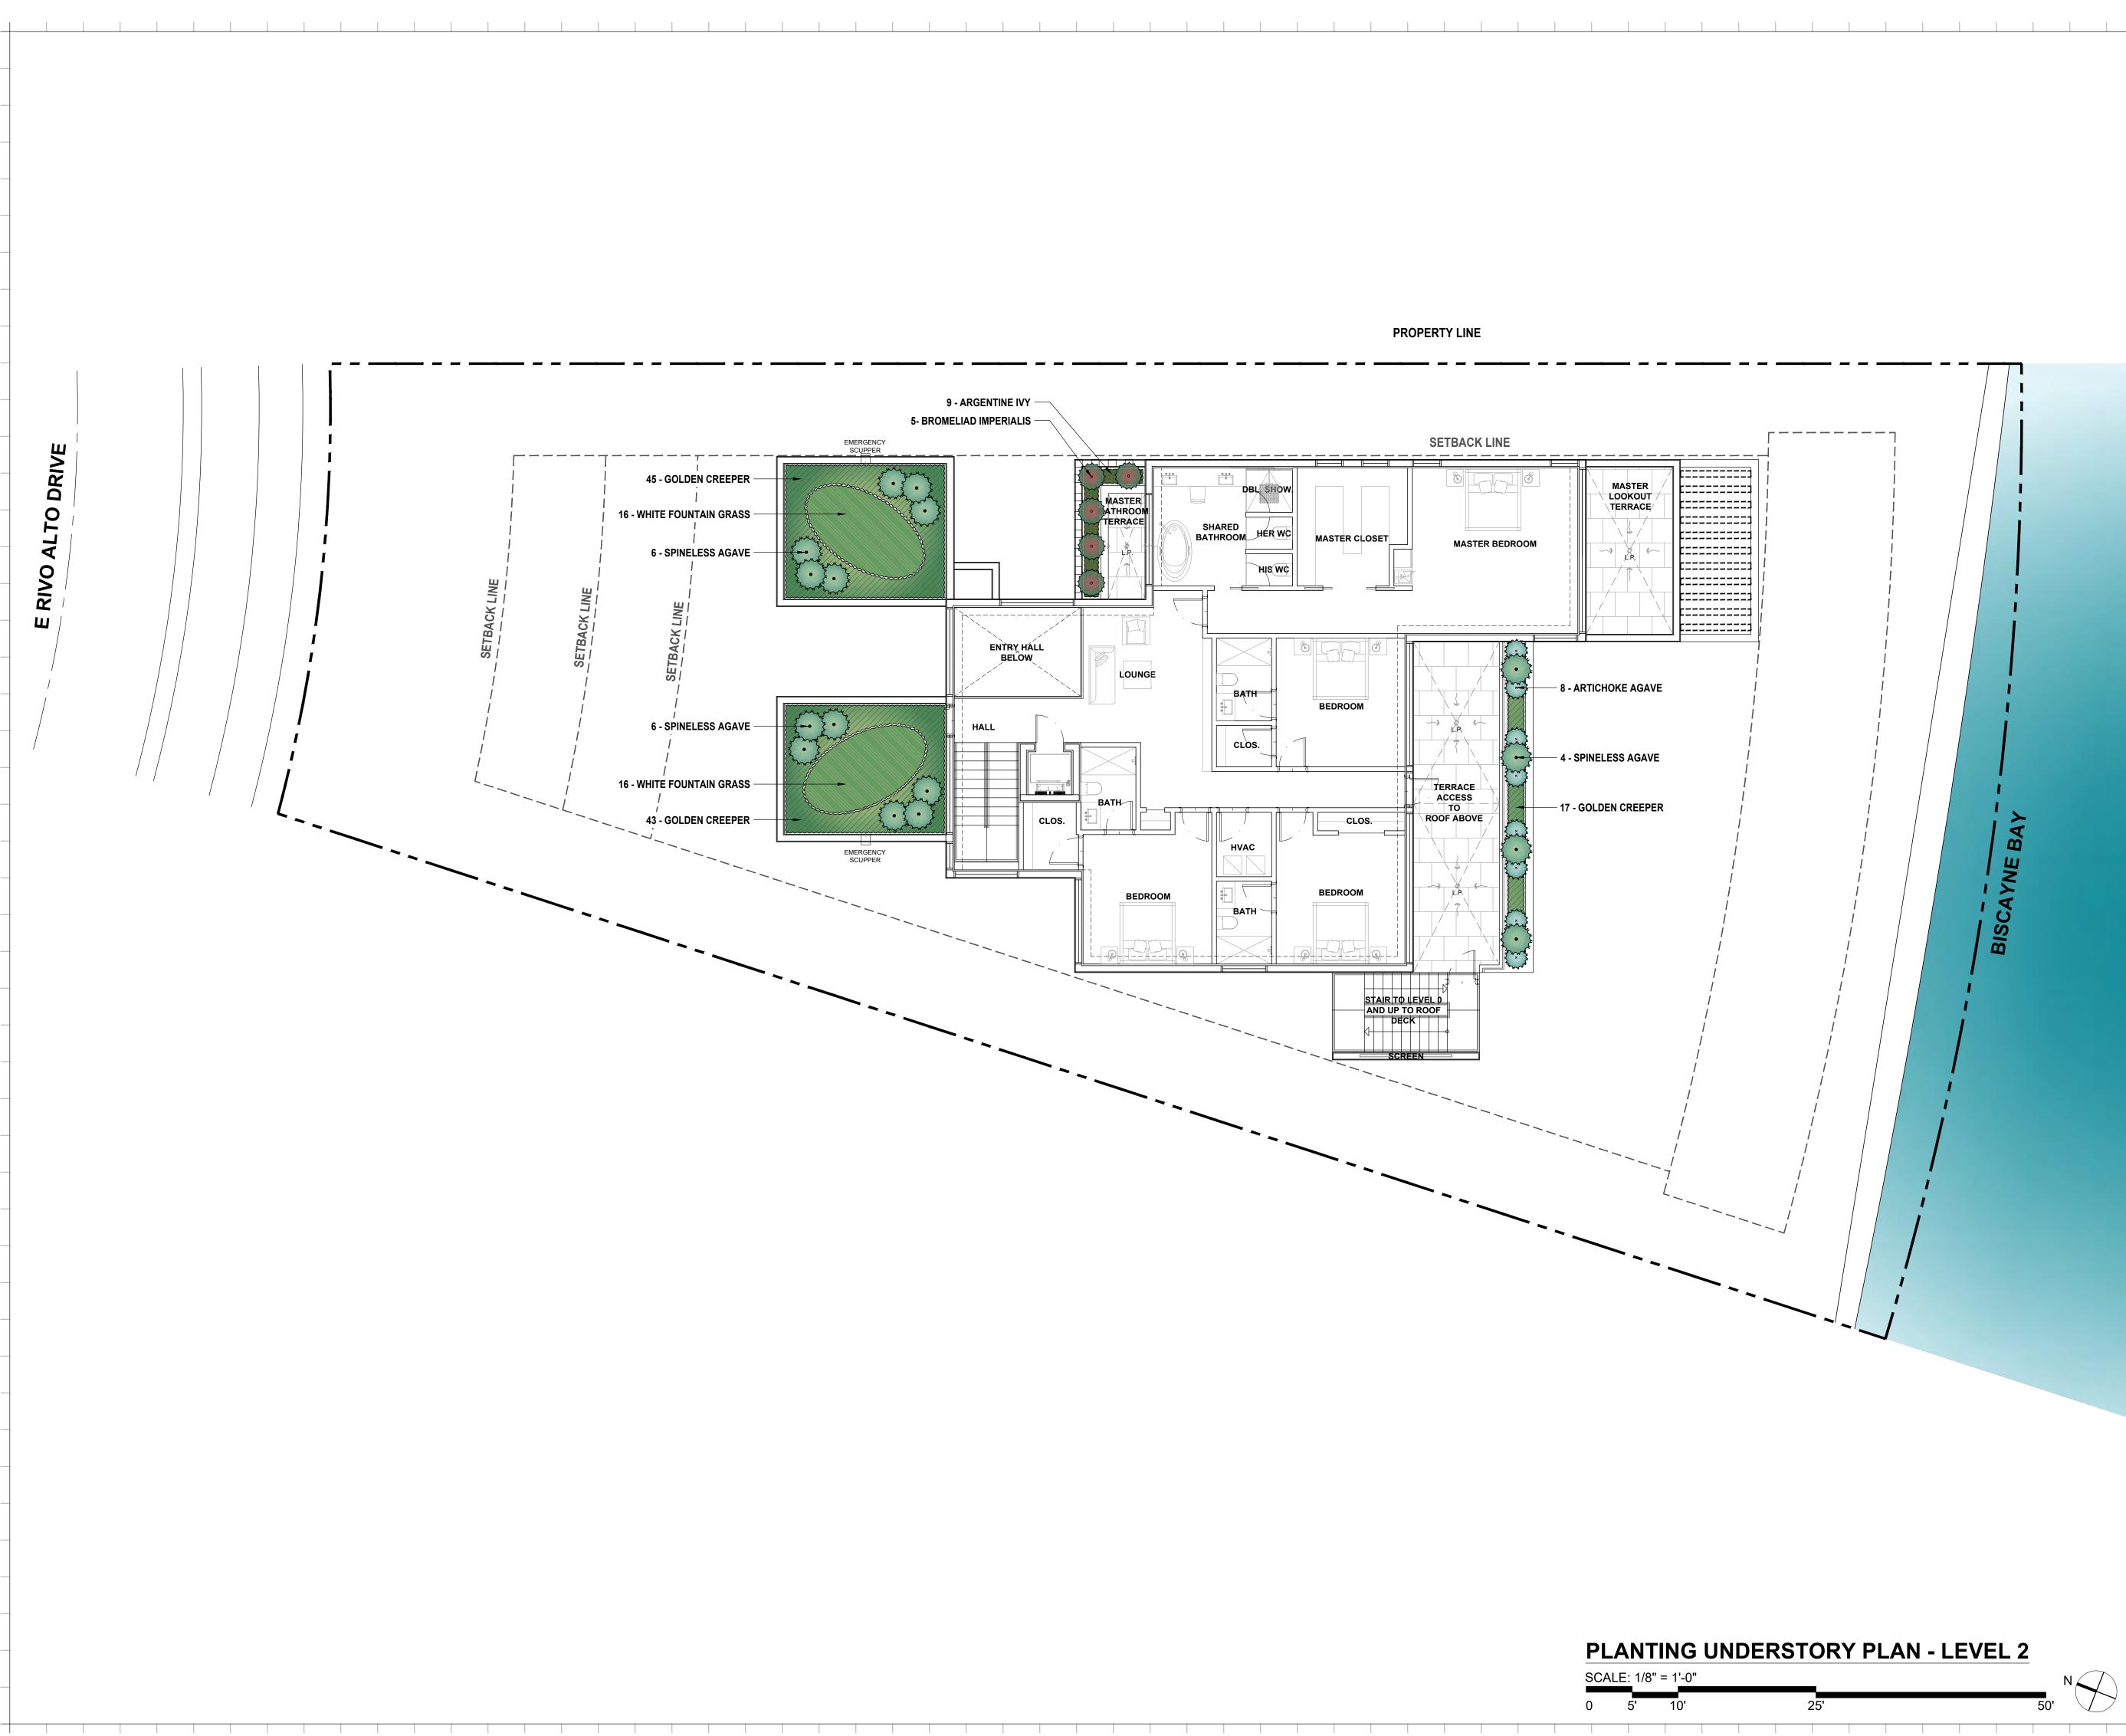
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PLANTING UNDERSTORY PLAN LEVEL 1

Date:	12-03-202
Scale :	1/8"=1'-0"
Project # :	21024



Date Rev. Date Rev. /10 /11 /12 /15 /16 ALL DRAWINGS AND WRITTEN MATERIAL APPEARING HEREIN CONSTITUTE THE ORIGINAL AND UNPUBLISHED WORK OF KOBI KARP AIA, AND MAY NOT BE DUPLICATED, USED, OR DISCLOSED WITHOUT THE EXPRESS WRITTEN CONSENT OF KOBI KARP ARCHITECTURE & INTERIOR DESIGN, INC. AIA. (c) 2020

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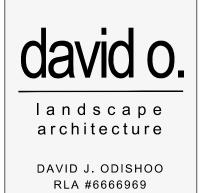
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Consultant: Name Address Address Tel: Email

Consultant: Name Address Address Tel: Email


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PLANTING UNDERSTORY PLAN LEVEL 2

Date:	12-03-2021
Scale :	1/8"=1'-0"
Project # :	21024



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Owner:

PRIVATE RESIDENCE

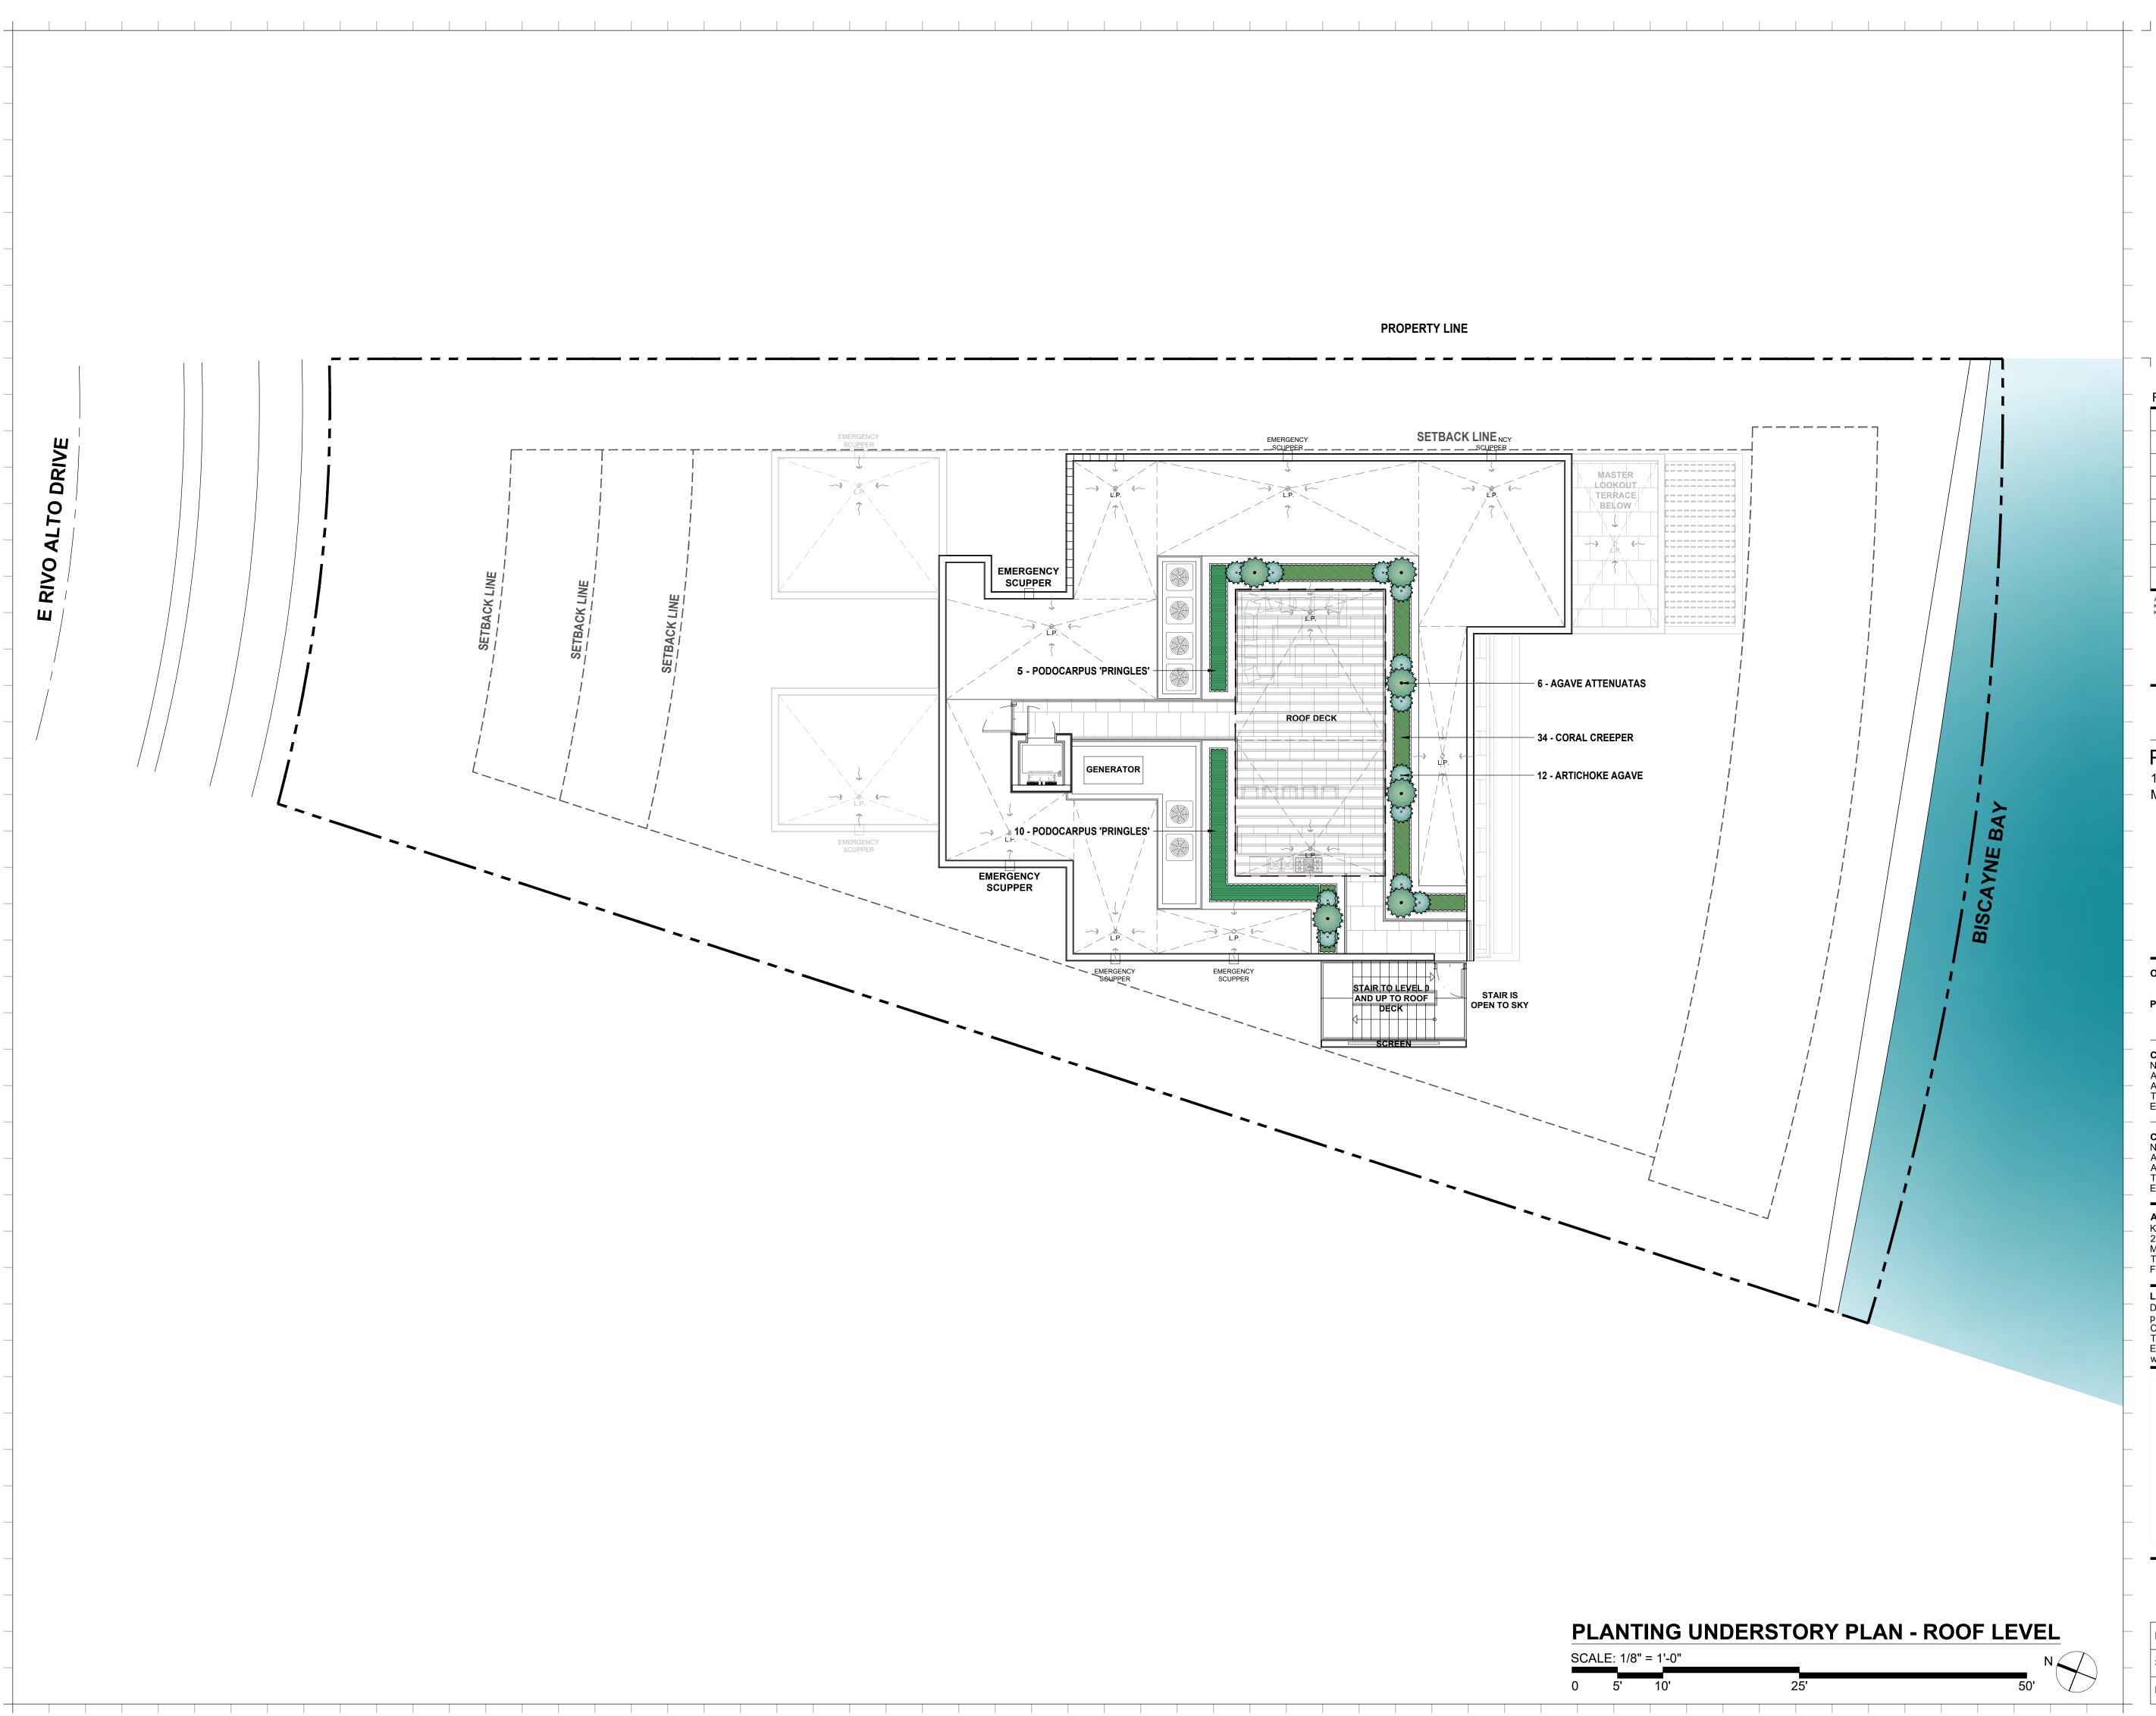Consultant: Name Address Address Tel: Email

Consultant: Name Address Address Tel: Email

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PLANTING UNDERSTORY PLAN ROOF LEVEL

Date:	12-03-2021
Scale :	1/8"=1'-0"
Project # :	21024



RENDERING FRONT VIEW 1 N.T.S.



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Date Rev.

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Date

PRIVATE RESIDENCE 11 EAST RIVO ALTO DRIVE

MIAMI BEACH, FL 33139

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OWNER OWNER_ADDRESS1 OWNER_ADDRESS2 OWNER_PHONE OWNER_EMAIL

Consultant: Name Address Address Tel: Email

Consultant: Name Address Address Tel: Email

Architect: Kobi Karp Architecture and Interior Design, Inc. 571 NW 28th Street, Miami, Florida 33127 USA Tel: +1(305) 573 1818 Fax: +1(305) 573 3766





KOBI KARP Lic. # AR0012578

RENDERINGS

Date	11-15-2021
Scale	
Project	2191

Sheet No. A1.01

Email Consultant: Name

Address Address Tel: Email



RENDERING REAR VIEW 1 N.T.S.

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Date Rev.

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Date

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MIAMI BEACH, FL 33139

Owner: Name Address Address Tel:

Email


OWNER OWNER_ADDRESS1 OWNER_ADDRESS2 OWNER_PHONE OWNER_EMAIL

Consultant: Name Address Address Tel: Email

Name Address Address Tel:

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KOBI KARP Lic. # AR0012578

RENDERINGS

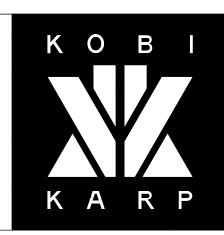Date	11-15-2021
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Project	2191


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Consultant: Name Address Address Tel: Email

Consultant:

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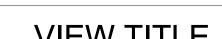
Architect:



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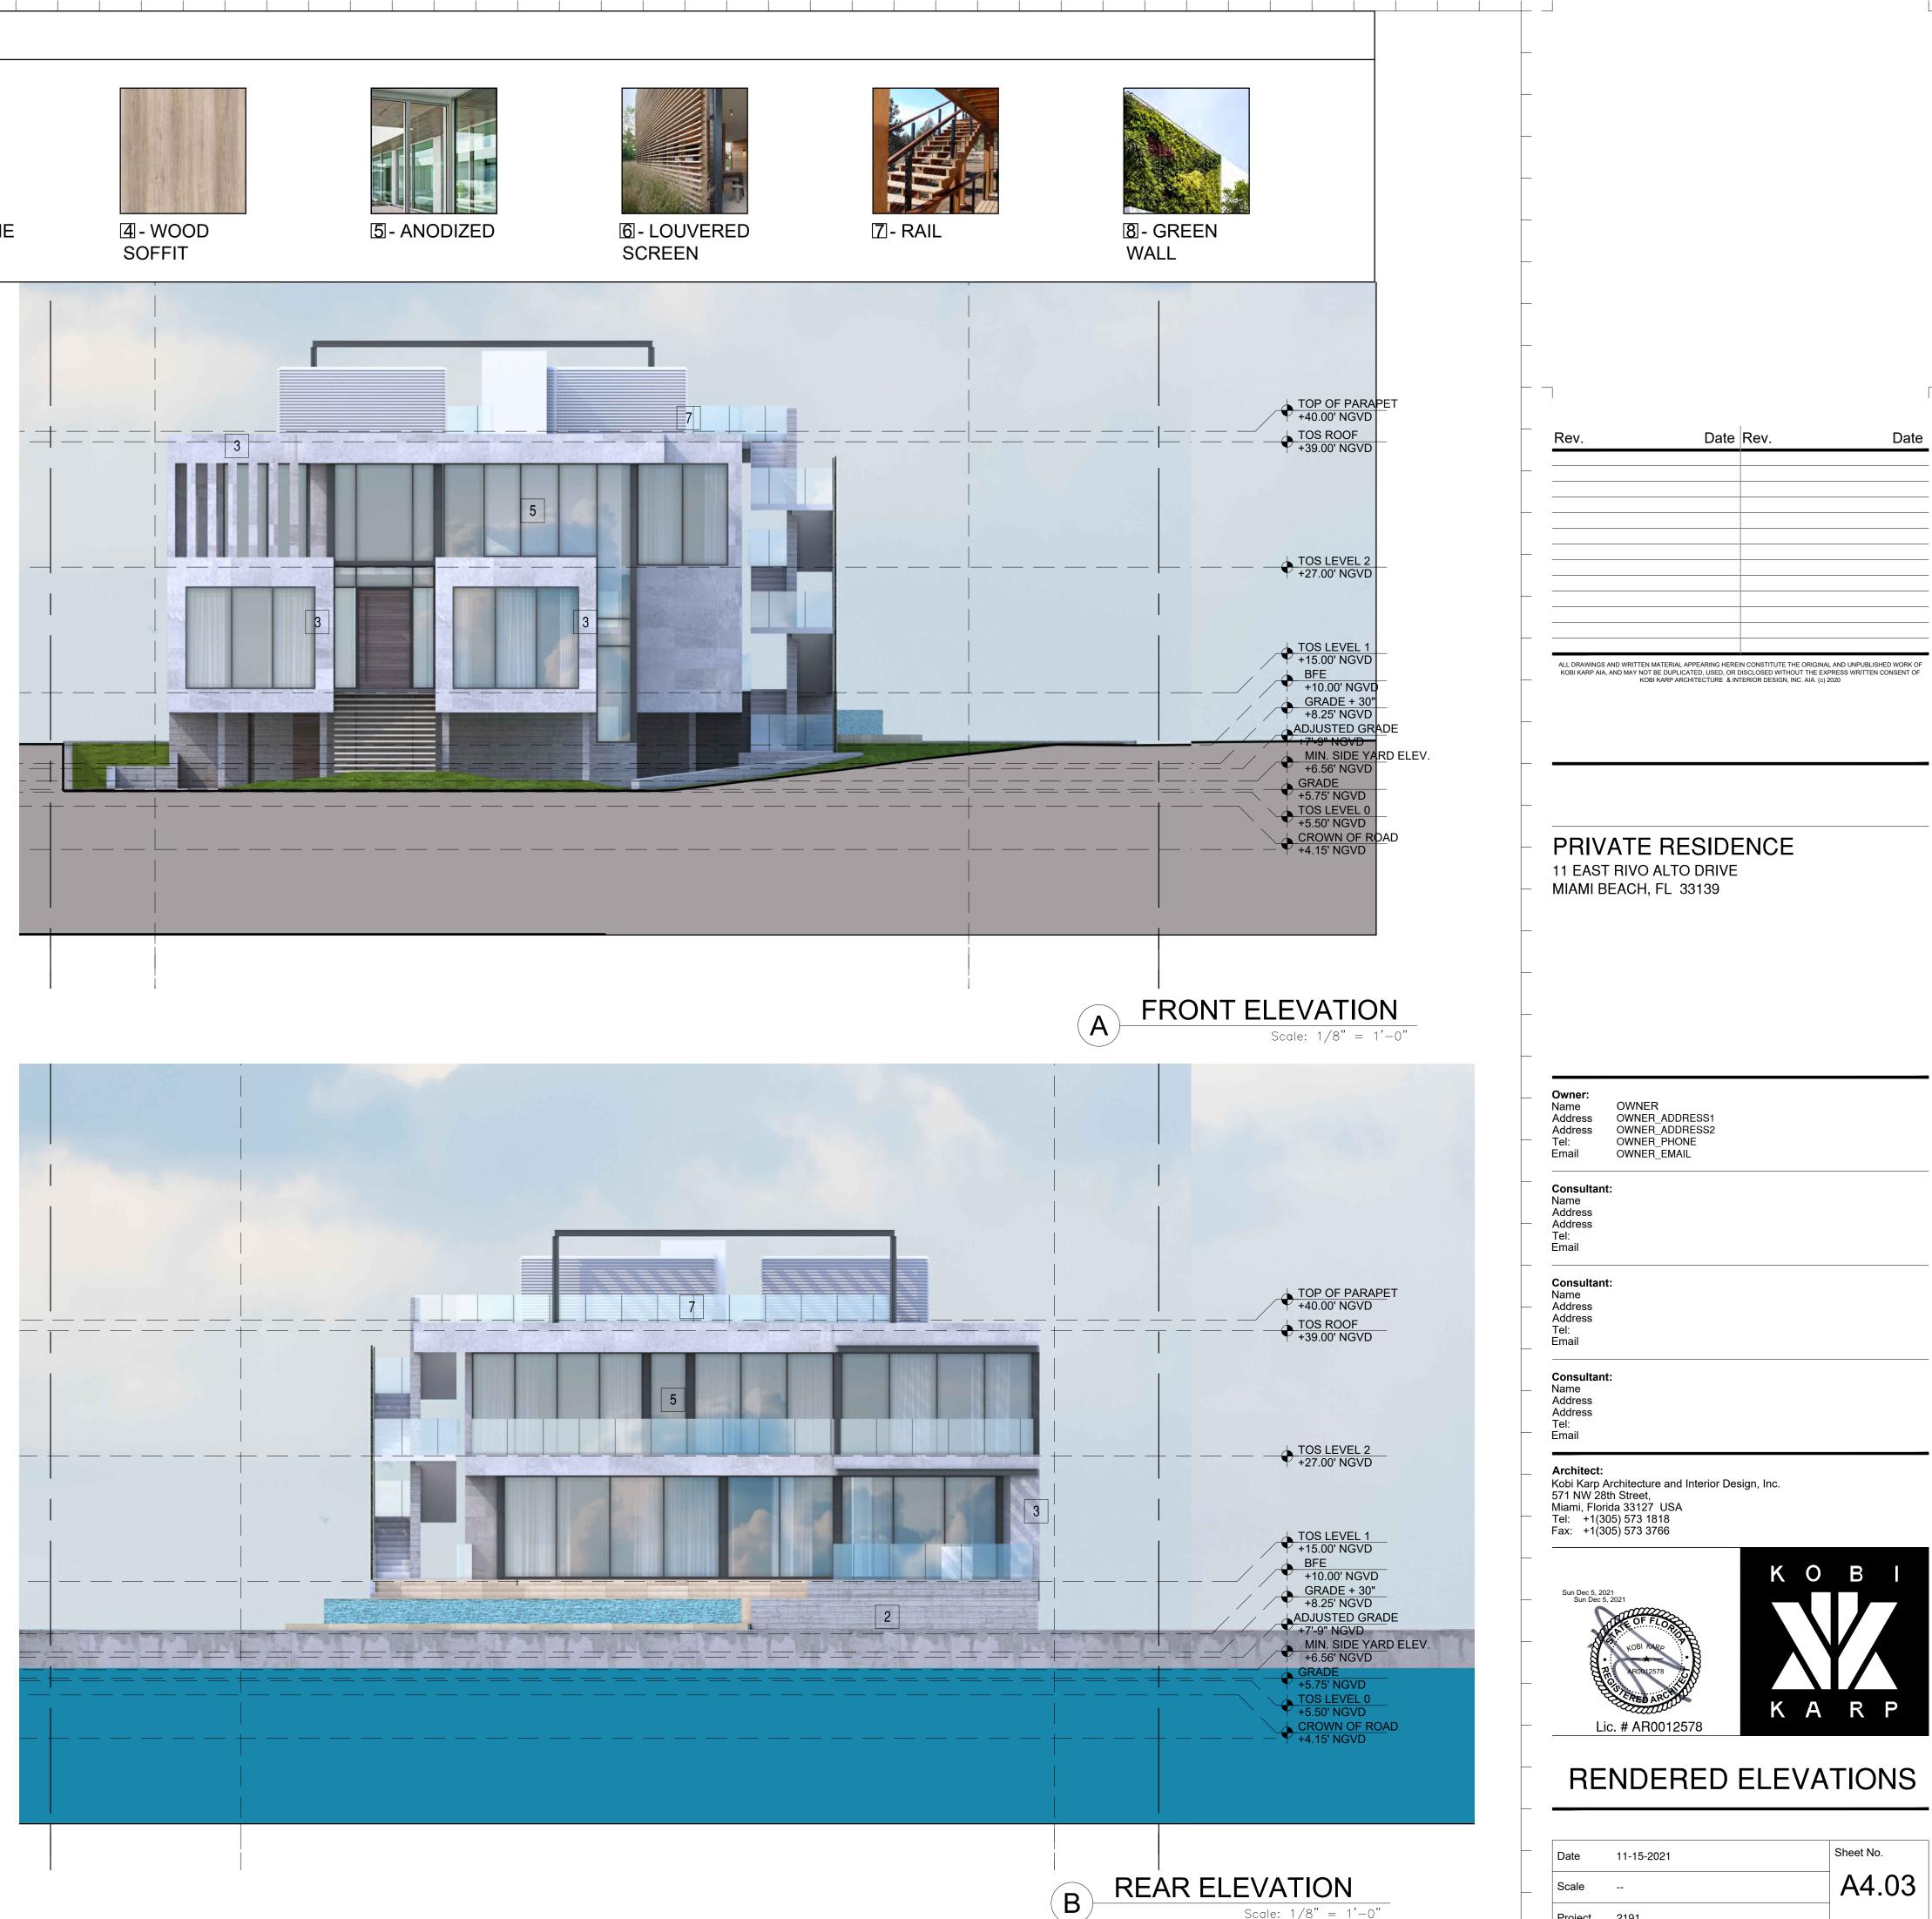

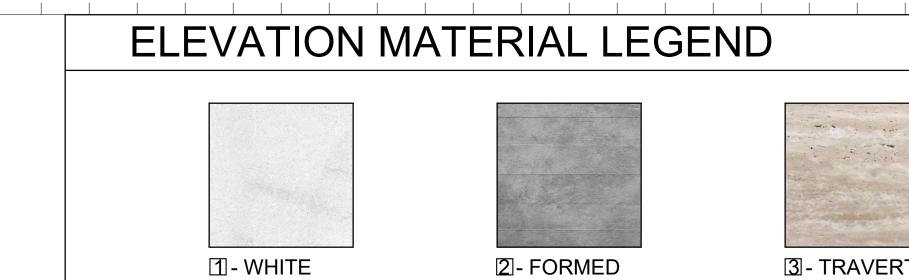
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Scale: 1/8" = 1'-0" Project 2191













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Date	11-15-2021	Sheet No.
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Project	2191	

Rev.	Date Rev.	Date



Planning Department, 1700 Convention Center Drive, 2nd Floor Miami Beach, Florida 33139, www.miamibeachfl.gov 305.673.7550

SINGLE FAMILY RESIDENTIAL - ZONING DATA SHEET

ITEM #	Project Information				
1	Address:	11 EAST RIVO ALTO [DRIVE, MIAMI BEACH, F	L 33139	
2	Folio number(s):	02-3233-001-0540			
3	Board and file numbers :				
4	Year built: (EXISTING TO BE DEMO'D.)	1935	Zoning District:		RS-3
5	Base Flood Elevation:	+10.00' NGVD	Grade value in NGVD: +4.15' NGVD - CROWN OF ROAD		
6	Adjusted grade (Flood+Grade/2):		Free board:		
7	Lot Area:	12,900 SF			
8	Lot width:	55'-8" AT 20' SETBACK	Lot Depth: 183'-0" AVE	RAGE TWO SIDE LENG	GTHS
9	Max Lot Coverage SF and %:	3,870 SF (30.00%)	Proposed Lot Coverage SF	and %:	3,869 SF (29.9
10	Existing Lot Coverage SF and %:		Lot coverage deducted (ga	rage-storage) SF:	
11	Front Yard Open Space SF and %:	790 SF (75.16 %)	Rear Yard Open Space SF a	nd %:	2,060 SF (72.6
12	Max Unit Size SF and %:	6,450 SF (50.00 %)	Proposed Unit Size SF and	%:	6,449 SF (99.9
13	Existing First Floor Unit Size:		Proposed First Floor Unit S	ize:	3,343 SF (51.8
14	Existing Second Floor Unit Size		Proposed Second Floor vol % (Note: to exceed 70% of home requires Board Appr	the first floor of the main	
15			Proposed Second Floor Uni	it Size SF and % :	2,603 SF (40.3
16			Proposed Roof Deck Area S Maximum is 25% of the en immediately below):	•	632 SF (24.3
	Zoning Information / Calculations	Required	Existing	Proposed	Deficiencies
17	Height:	24'-0" FLAT		24'-0" FLAT	
18	Setbacks:				

	Zoning Information / Calculations	Required	Existing	Proposed	Deficiencies
17	Height:	24'-0" FLAT		24'-0" FLAT	
18	Setbacks:				
19	Front First level:	20'-0"		47'-7"	
20	Front Second level:	30'-0"		67'-1"	
21	Side 1: EAST SIDE 1:	10'-0" MIN.		10'-1"	
22	Side 2 or (facing street): WEST SIDE 2:	10'-0" MIN.		10'-1"	
23	Rear:	27'-6"		27'-7"	
1	Accessory Structure Side 1:	N / A		N / A	
24	Accessory Structure Side 2 or (facing street) :	N / A		N / A	
25	Accessory Structure Rear:	N / A		N / A	
26	Sum of side yard :	20'-0" MIN.		20'-2"	
27	Located within a Local Historic District?			Yes or	No
28	Designated as an individual Historic Single Far	nily Residence Site?		Yes or	No
29	Determined to be Architecturally Significant?			Yes or	No
4	Additional data or information must be prese	nted in the format outlined	in this section		

Additional data or information must be presented in the format outlined in this section

Notes:

If not applicable write N/A

App/PlanRev1-16v.1

SHEET NUMBER
A0.00
A0.01
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A0.04
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INDEX

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COVER
PROJECT DATA / DRAWING INDEX & GENERAL NOTES
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LOCATION KEY
CONTEXT IMAGES
CONTEXT IMAGES
CONTEXT IMAGES
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RENDERINGS
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ZONING DIAGRAMS – LOT COVERAGE
ZONING DIAGRAMS – UNIT SIZE LEVEL O
ZONING DIAGRAMS – UNIT SIZE LEVEL 1
ZONING DIAGRAMS – UNIT SIZE LEVEL 2
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RENDERED WEST & EAST ELEVATIONS
AXONOMETRICS
AXONOMETRICS
SECTIONS SITE SECTIONS
SITE SECTIONS
LANDSCAPE DRAWINGS
CIVIL DRAWINGS
MEP DRAWINGS

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PRIVATE RESIDENCE 11 EAST RIVO ALTO DRIVE

MIAMI BEACH, FL 33139

Owner: Name Address Address Tel:

Email


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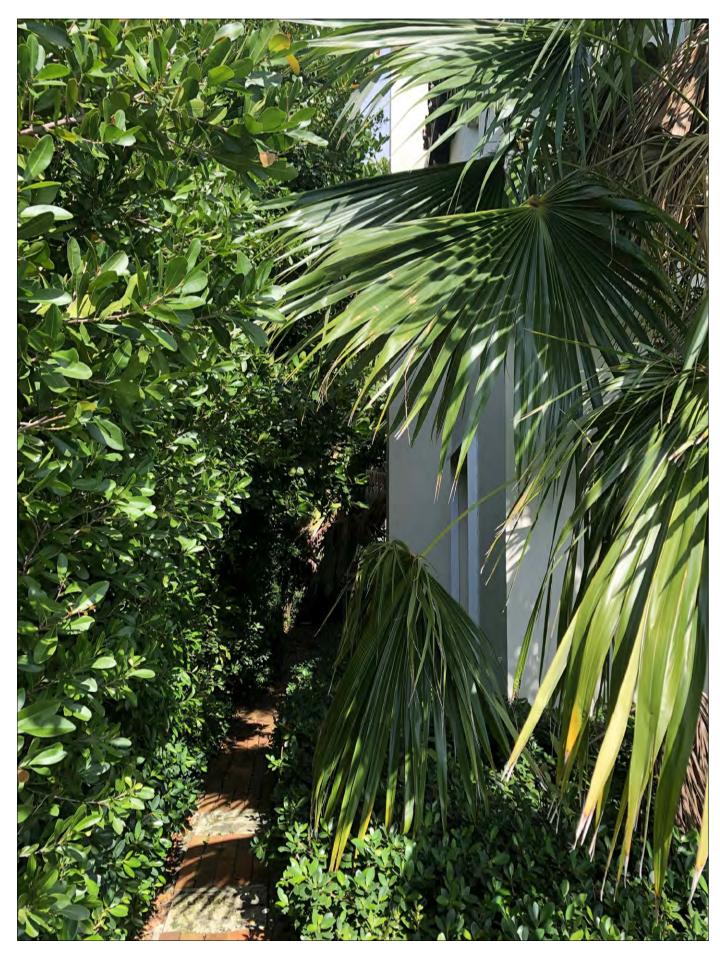
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E1 - 11 E. RIVO ALTO - VIEW TO FRONT (EXISTING STRUCTURE)




E3 - 11. E. RIVO ALTO - VIEW TO WEST SIDE (EXISTING STRUCTURE)



E4 - 11. E. RIVO ALTO - VIEW TO REAR (EXISTING STRUCTURE)

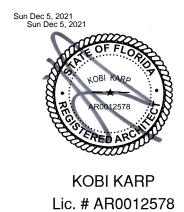

E2 - 11 E. RIVO ALTO - VIEW TO EAST SIDE (EXISTING STRUCTURE)

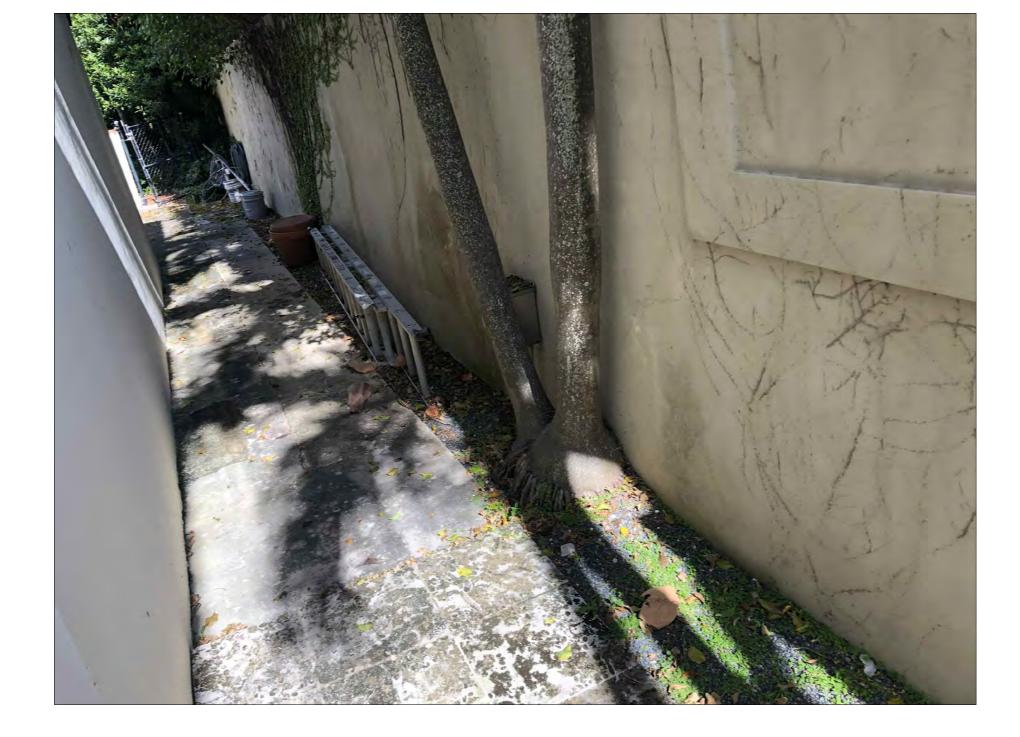

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Name Address Address Tel:

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OWNER OWNER_ADDRESS1 OWNER_ADDRESS2 OWNER_PHONE OWNER_EMAIL


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KOBI KARP Lic. # AR0012578

SITE IMAGES


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Sheet No.

NO SCALE

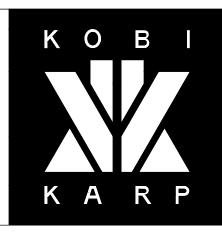

E5 - 11 E. RIVO ALTO - EXISTING FRONT DOOR DETAIL

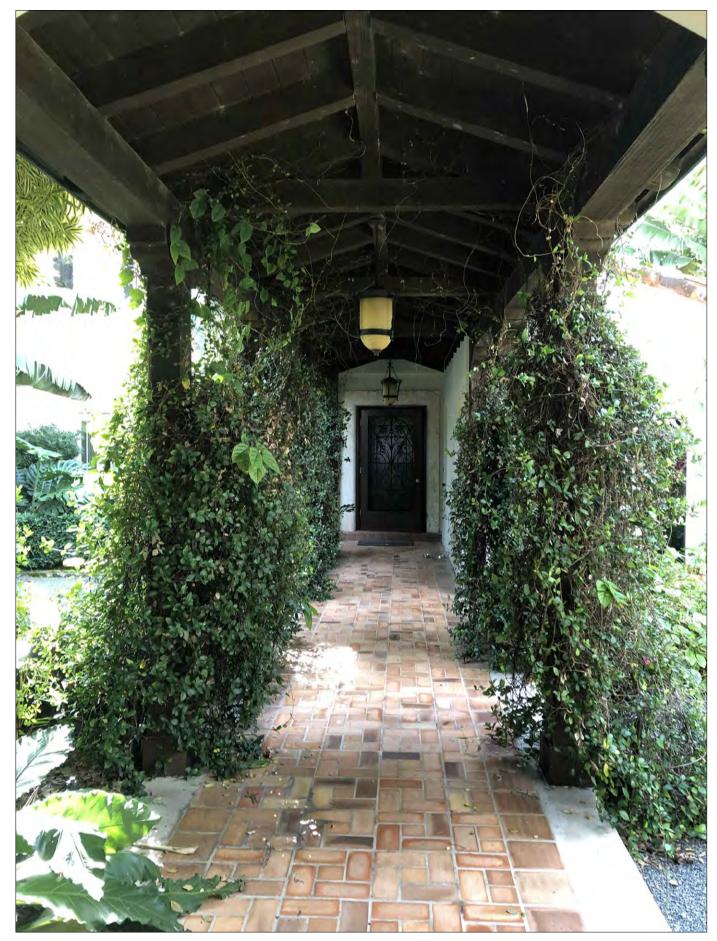

E6 - 11 E. RIVO ALTO - EXISTING ENTRY COURTYARD DETAIL



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Date

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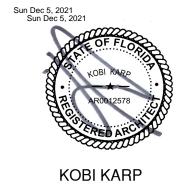
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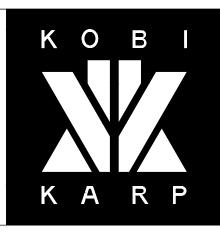
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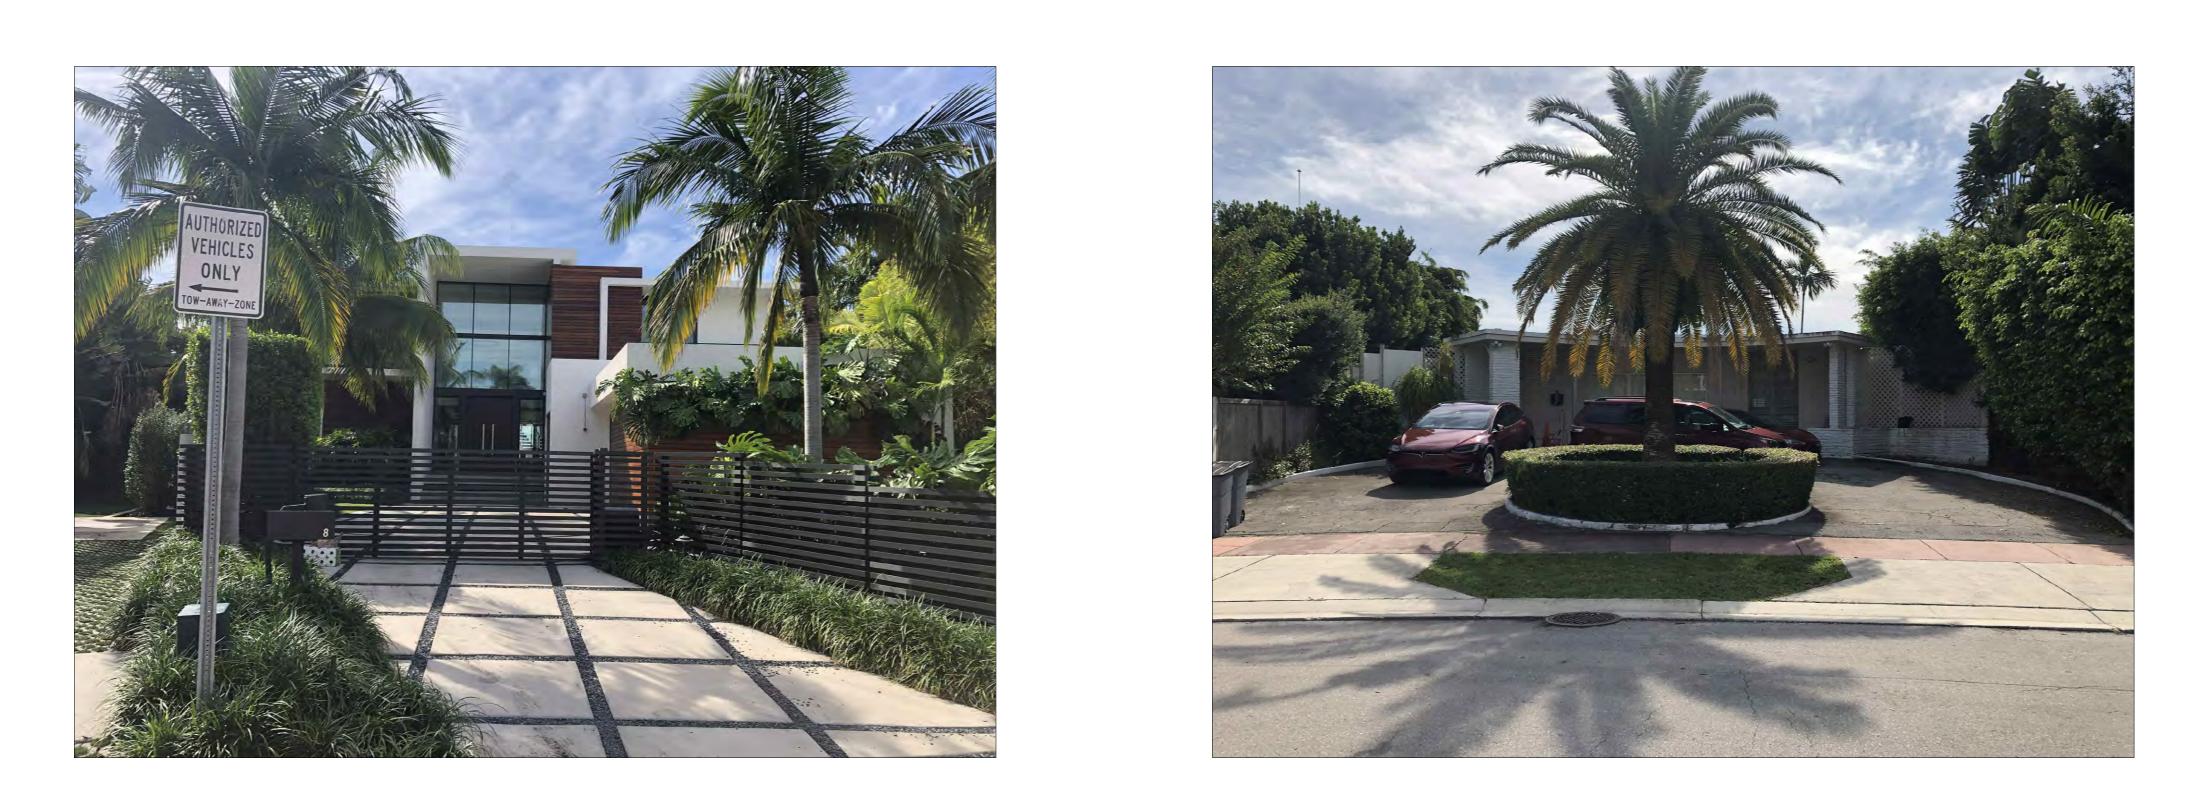
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SITE IMAGES

Date 11-15-2021 Scale --Project 2191

Sheet No. A0.04

NO SCALE



N1 - 8 E. RIVO ALTO (NEIGHBOR)



N3 - 10 E. RIVO ALTO (NEIGHBOR)

N2 - 15 E. RIVO ALTO (NEIGHBOR)

<u>/1</u> ∕2∖ ∕3∖ 4 • ∕5∖ • 6 • • ∕9∖ • /10 11 12 Date Rev. Date Rev

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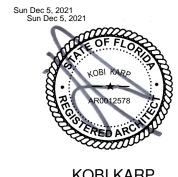
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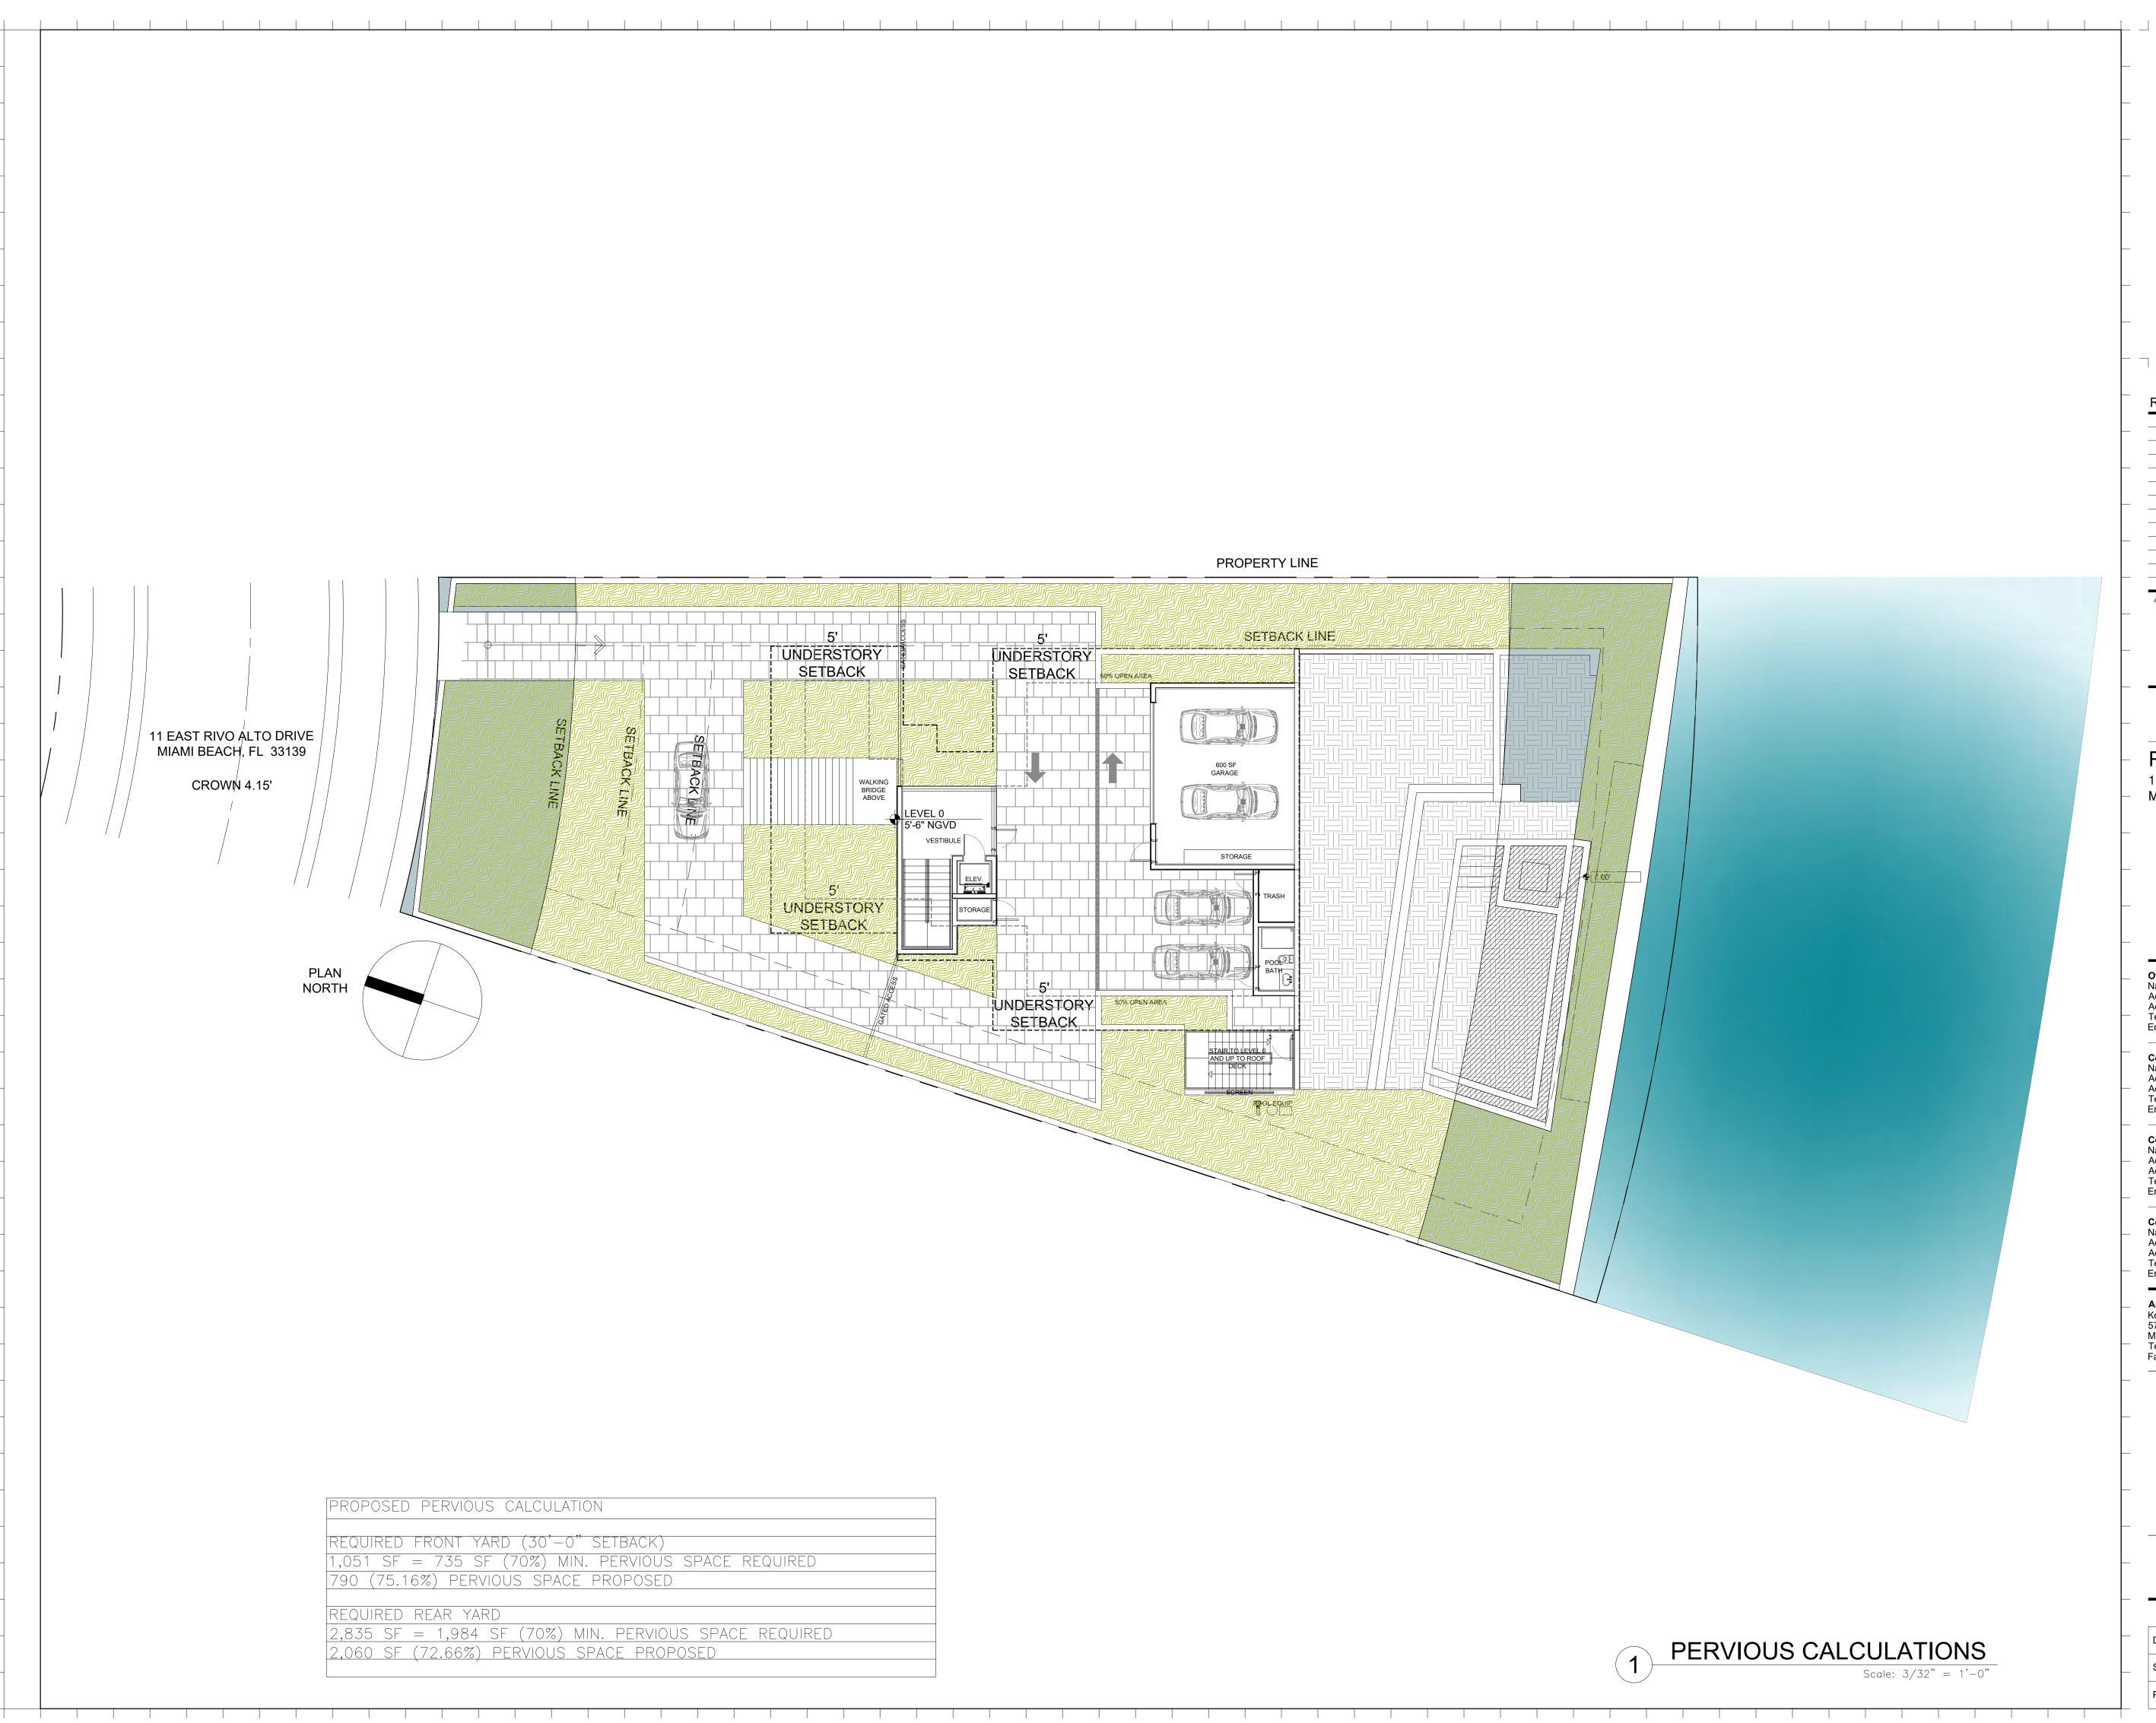


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CONTEXT IMAGES

Date 11-15-2021 Scale --Project 2191

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WALKING BRIDGE ABOVE

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LEVEL 0 5'-6" NGVD

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UNDERSTORY

SETBACK

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UNDERSTORY

SETBACK

50% OPEN AREA


50% OPEN AREA

D	
RED	

600 SF GARAGE STORAGE AND UP TO ROOF ROOLEOUR

PROPERTY LINE

SETBACK LINE

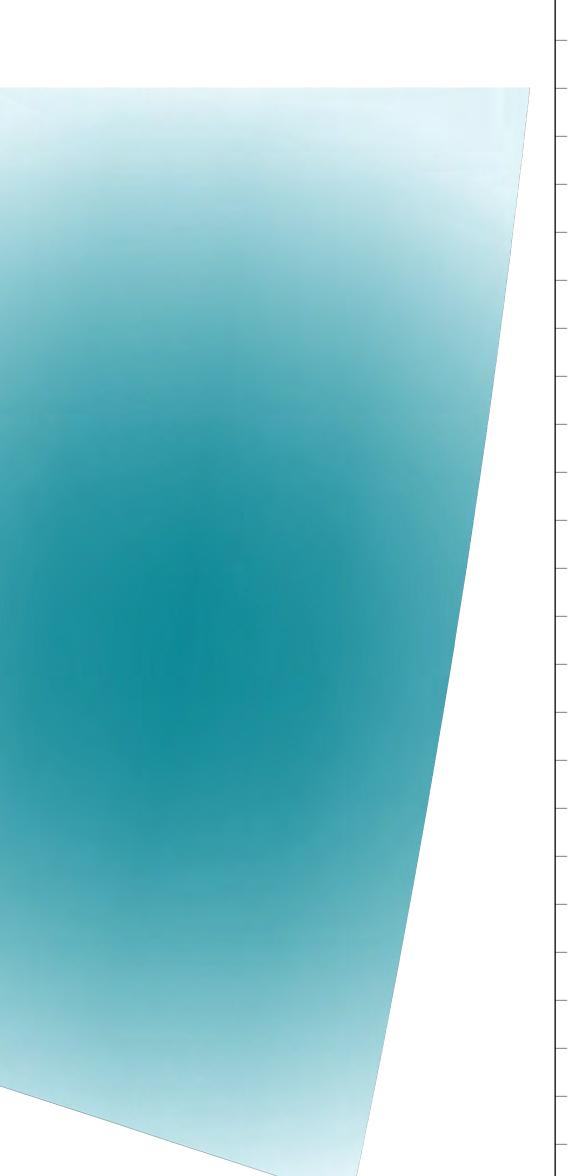

PERVIOUS CALCULATIONS

Scale: 3/32" = 1'-0"

Rev.	Date	Rev.	Da

PRIVATE RESIDENCE 11 EAST RIVO ALTO DRIVE

MIAMI BEACH, FL 33139

Owner: Name Address Address Tel:

Email


OWNER OWNER_ADDRESS1 OWNER_ADDRESS2 OWNER_PHONE OWNER_EMAIL

Consultant: Name Address Address Tel: Email

Consultant: Name Address Address Tel: Email

Consultant: Name Address Address Tel: Email

Architect: Kobi Karp Architecture and Interior Design, Inc. 571 NW 28th Street, Miami, Florida 33127 USA Tel: +1(305) 573 1818 Fax: +1(305) 573 3766

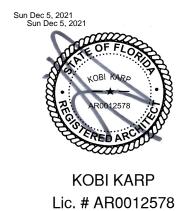




ZONING DIAGRAMS

Date	11-15-2021
Scale	
Project	2191

Sheet No. A1.10

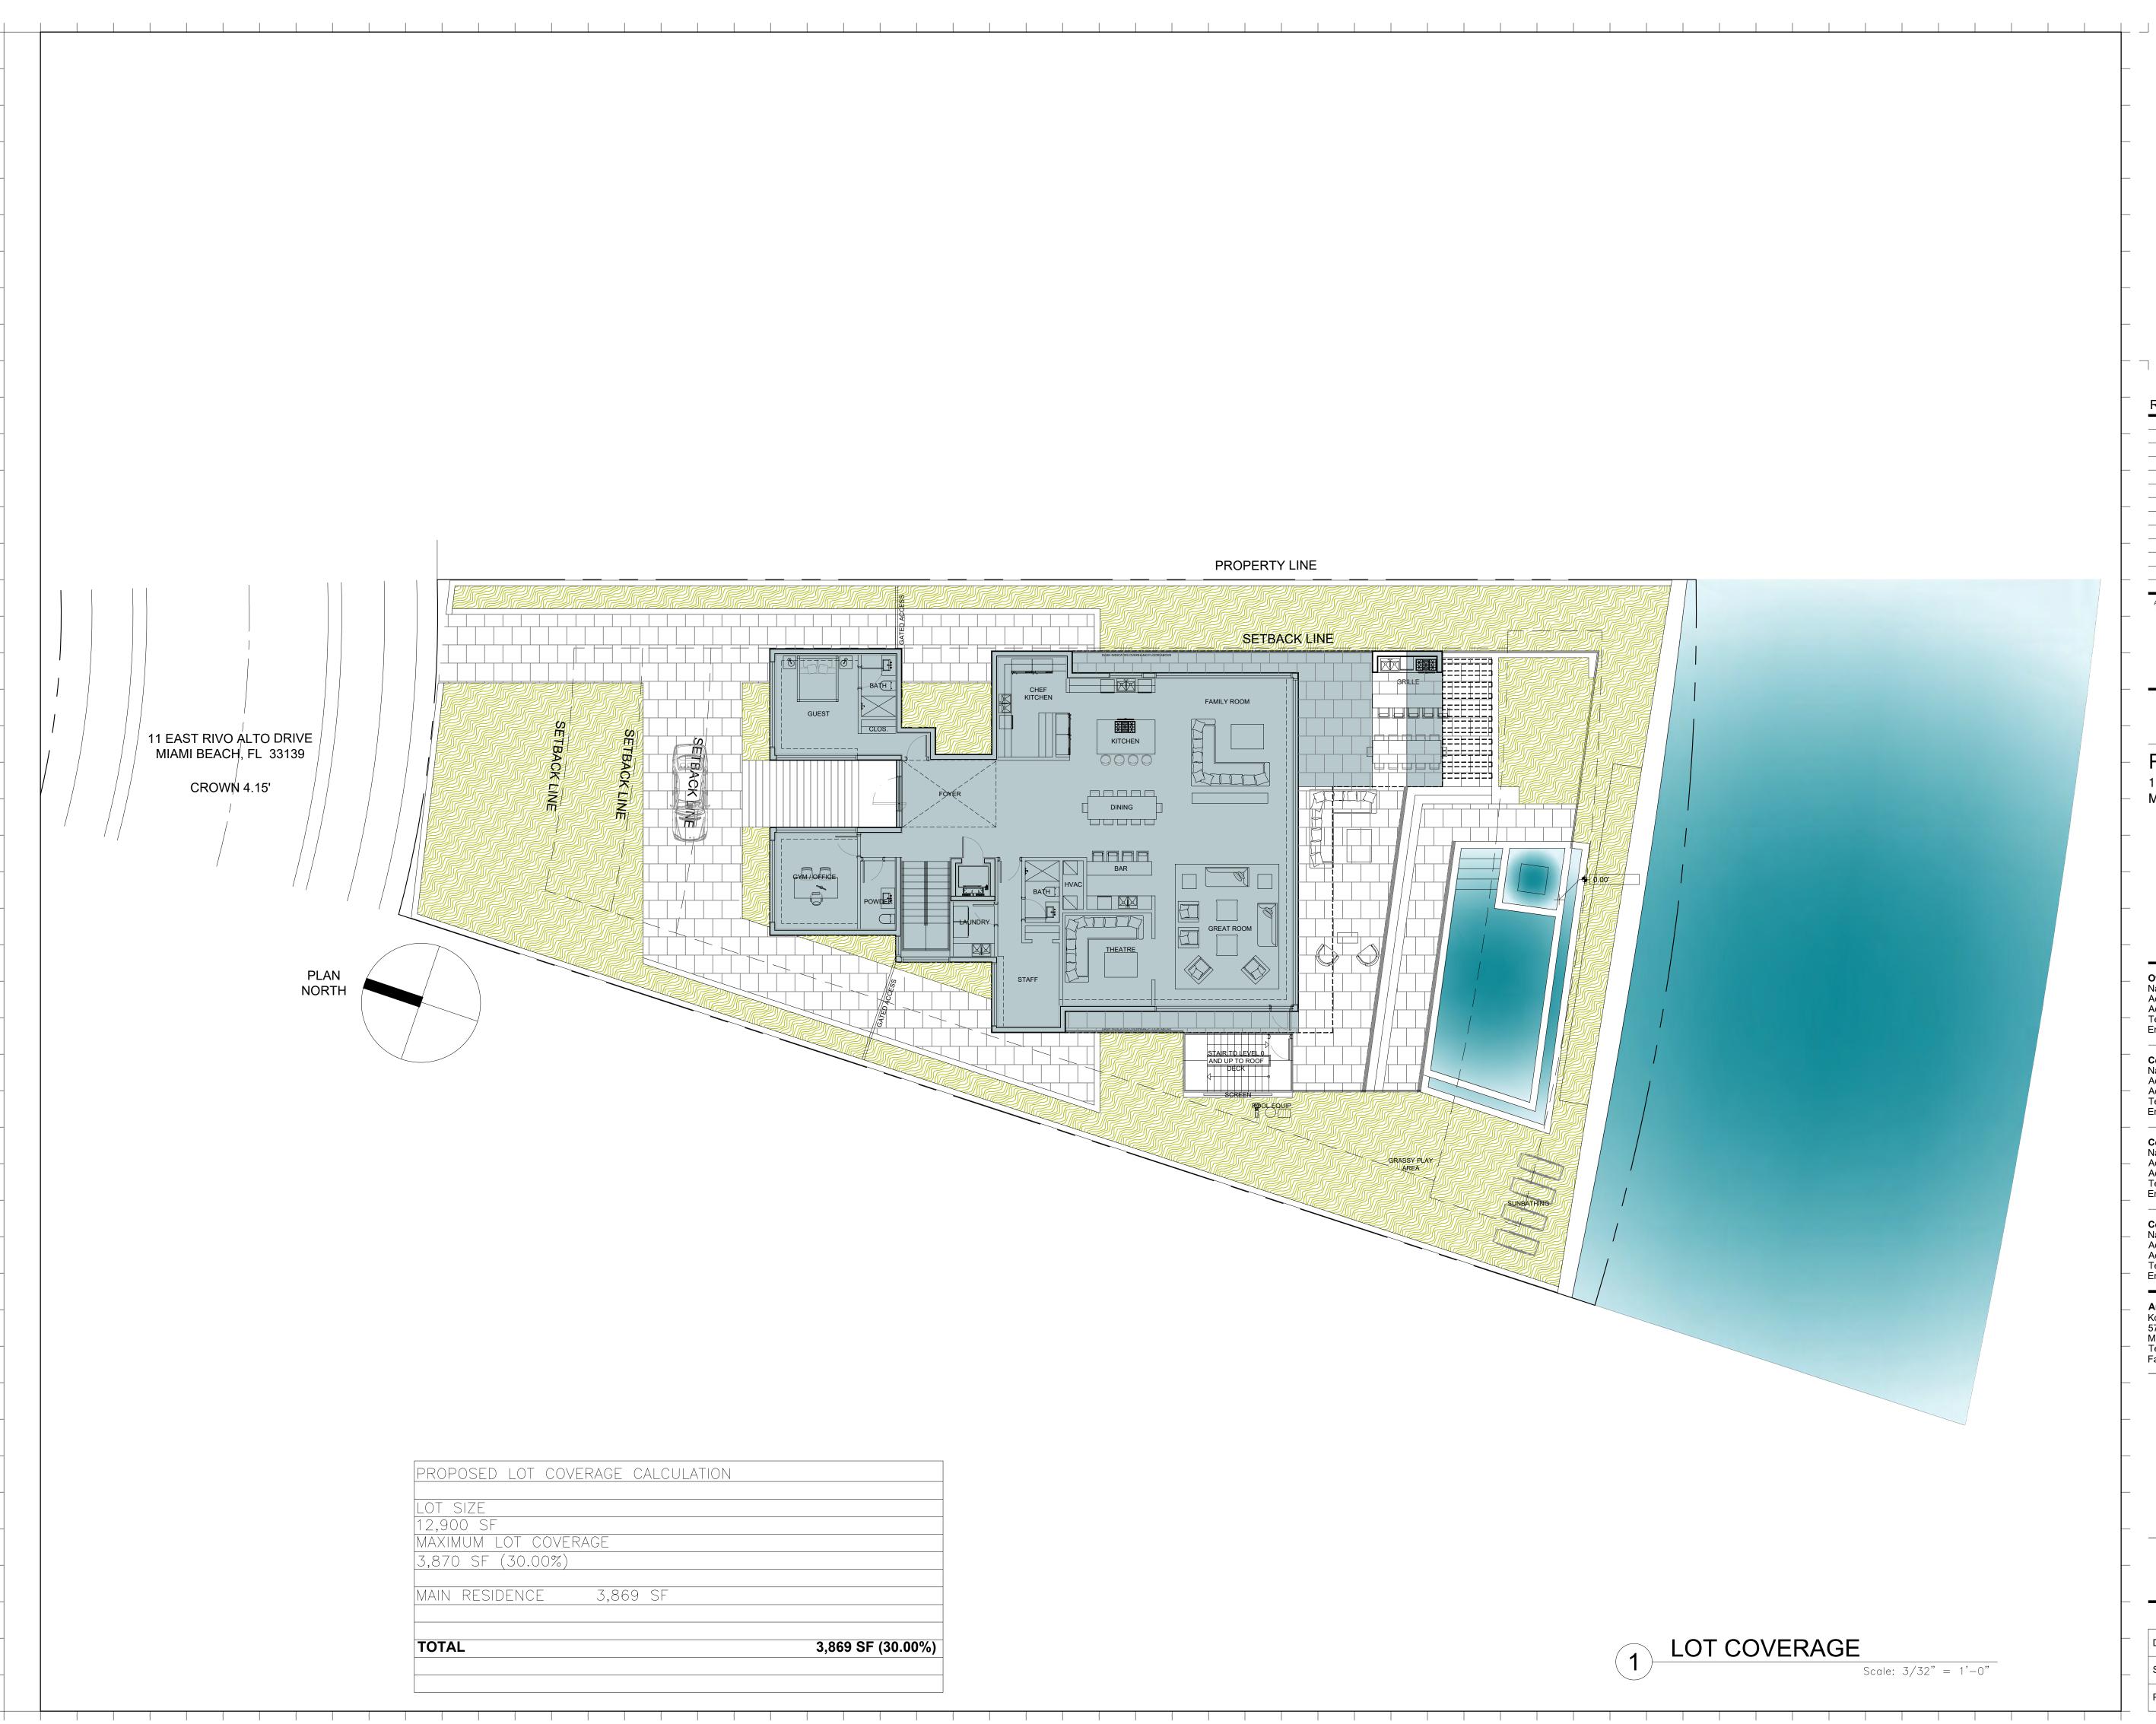

3,869	SF (30.00%)
	·

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Owner: Name Address Address Tel:

Email

Rev

Date Rev.

Date

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Consultant: Name Address Address Tel: Email

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Architect: Kobi Karp Architecture and Interior Design, Inc. 571 NW 28th Street, Miami, Florida 33127 USA Tel: +1(305) 573 1818 Fax: +1(305) 573 3766





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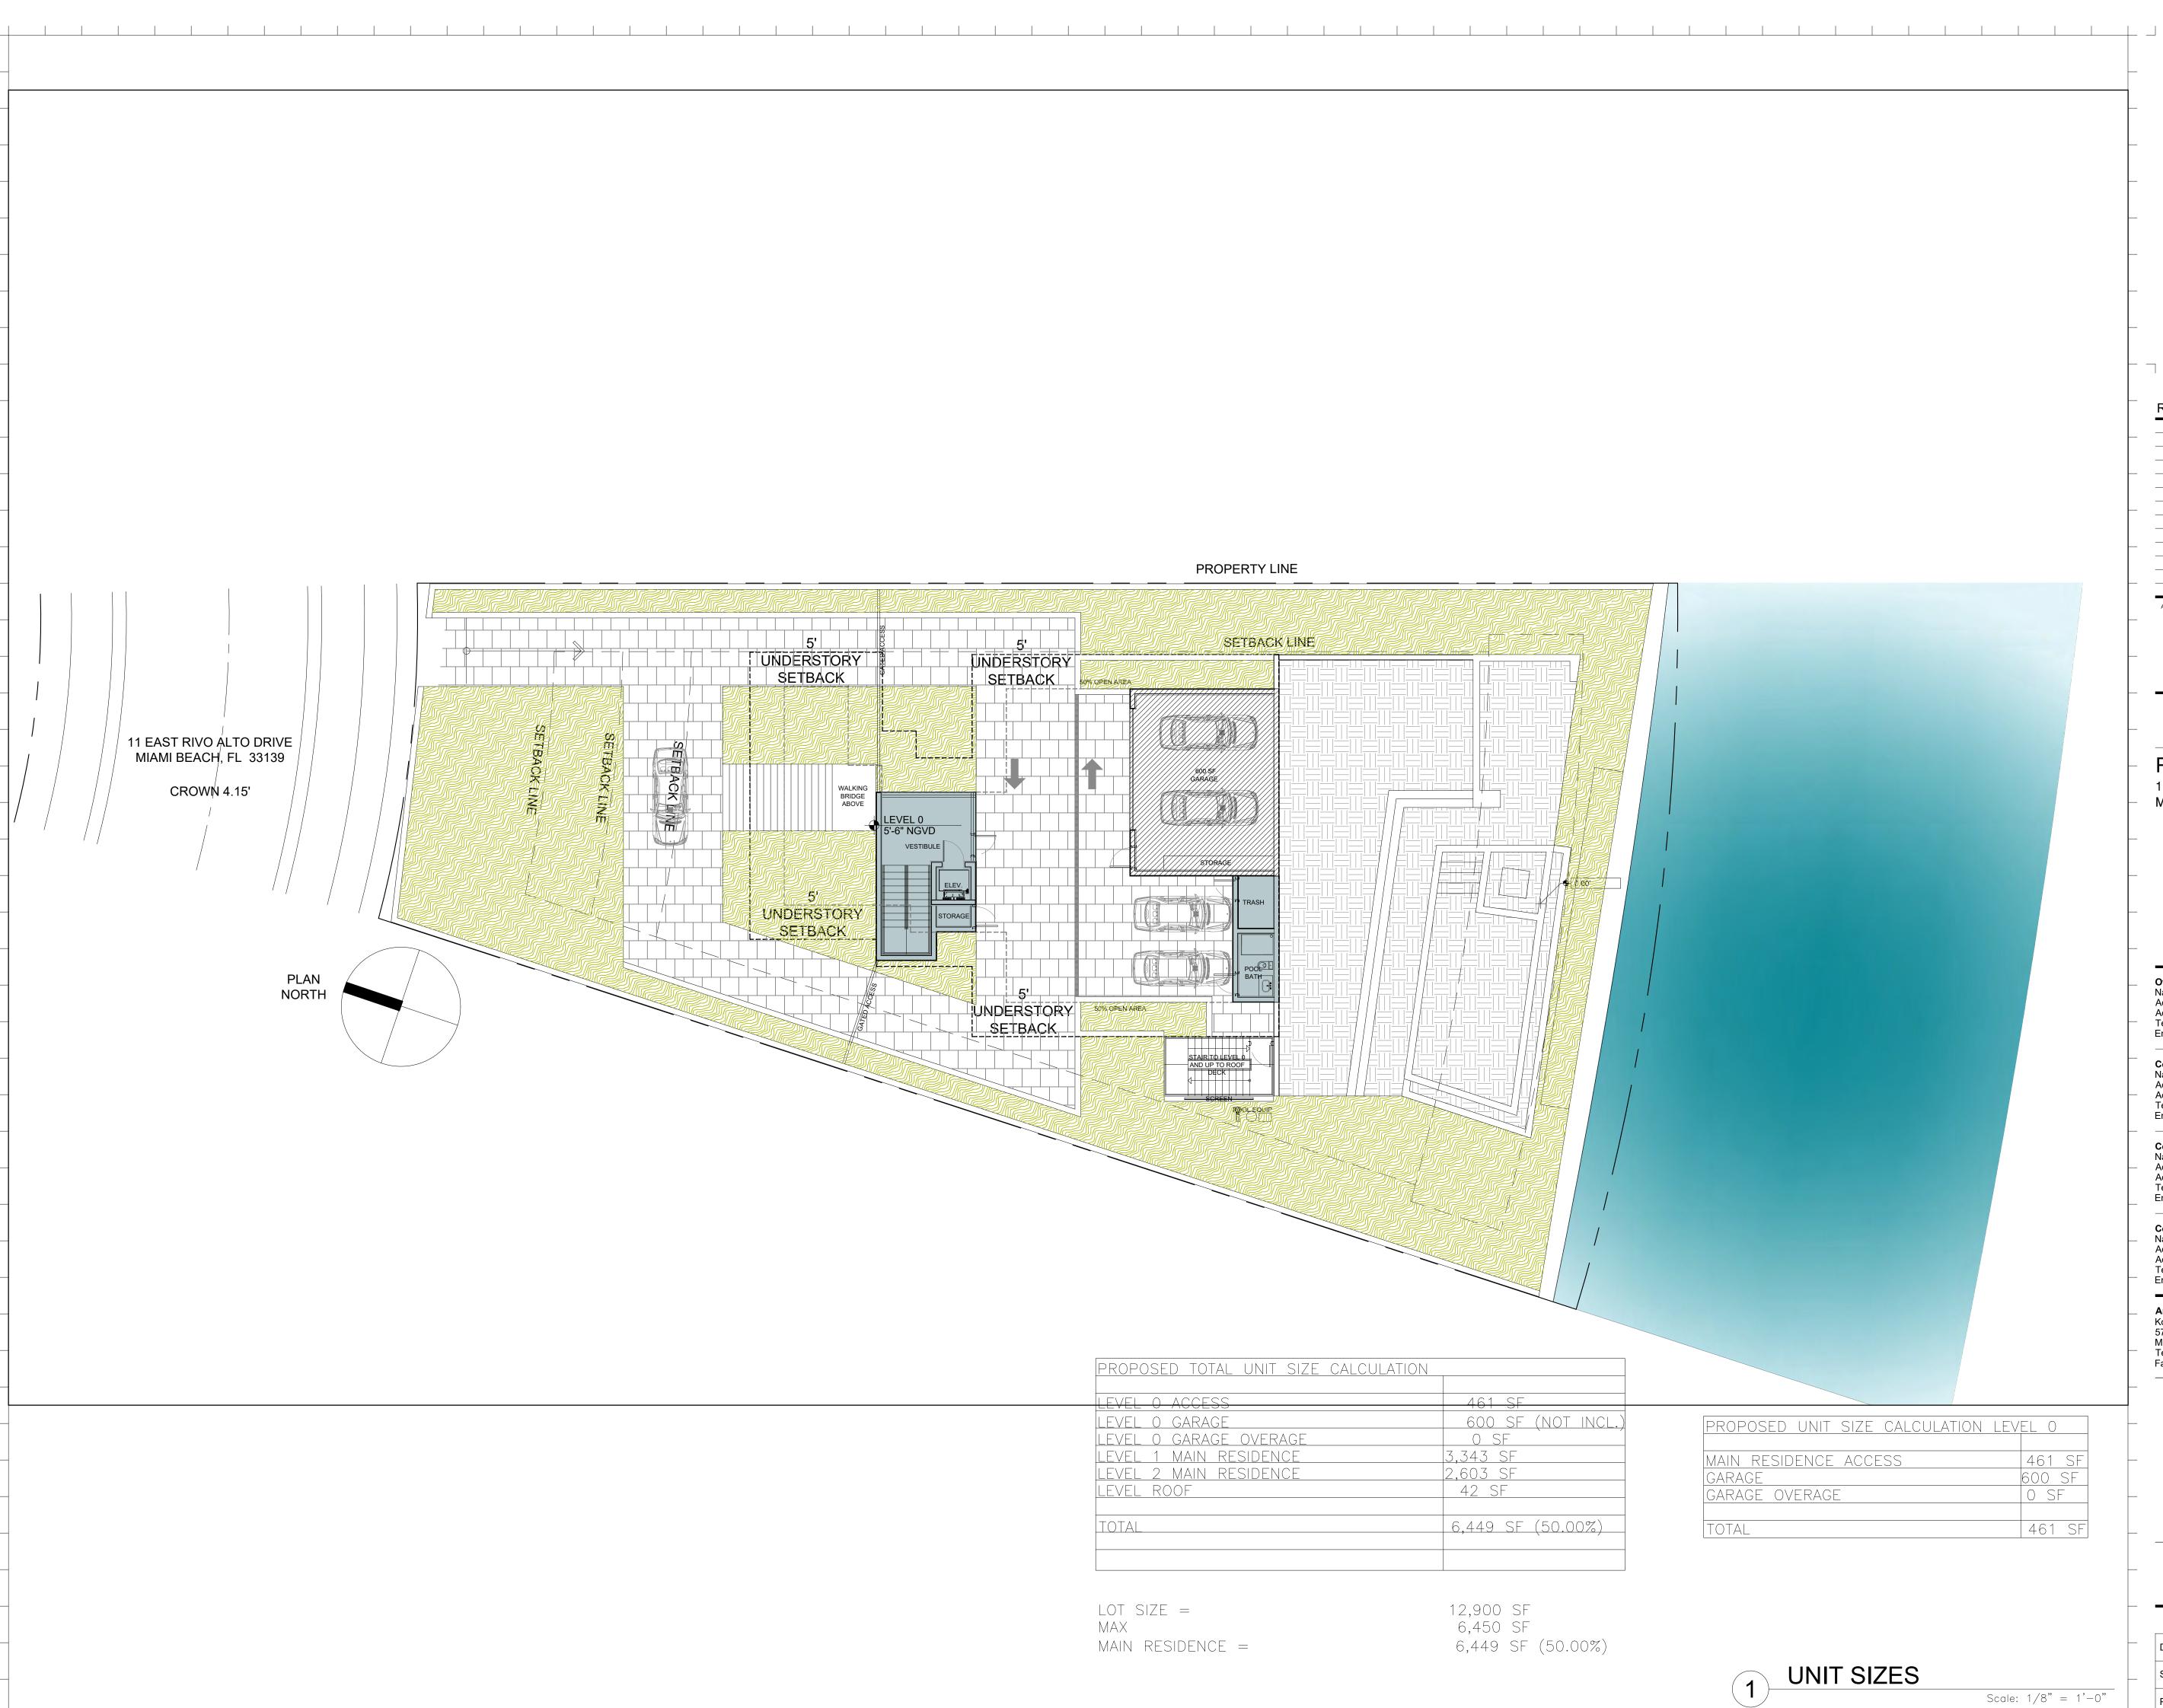
ZONING DIAGRAMS

)ate	11-15-2021
scale	
Project	2191

Sheet No. A1.11

LOT COVERAGE

Scale: 3/32" = 1'-0"



PROPOSED TOTAL UNIT SIZE CALCULATION		
I EVEL O ACCESS	461 SF	
LEVEL O GARAGE		(NOT INCL.)
LEVEL O GARAGE OVERAGE	0 SF	``````````````````````````````````````
LEVEL 1 MAIN RESIDENCE	3,343 SF	
LEVEL 2 MAIN RESIDENCE	2,603 SF	
LEVEL ROOF	42 SF	
ΤΟΤΑΙ	6,449 SF	(50.00%)
		× /



PROPOSED UNIT SIZE CALCULATION LEV	el o
MAIN RESIDENCE ACCESS	461 SF
GARAGE	600 SF
GARAGE OVERAGE	0 SF
TOTAL	461 S

1							_			
						Scale	e: 1/8"	= 1'-	-0"	
										-

Date Rev. Date Rev. ALL DRAWINGS AND WRITTEN MATERIAL APPEARING HEREIN CONSTITUTE THE ORIGINAL AND UNPUBLISHED WORK OF KOBI KARP AIA, AND MAY NOT BE DUPLICATED, USED, OR DISCLOSED WITHOUT THE EXPRESS WRITTEN CONSENT OF KOBI KARP ARCHITECTURE & INTERIOR DESIGN, INC. AIA. (c) 2020

PRIVATE RESIDENCE 11 EAST RIVO ALTO DRIVE

MIAMI BEACH, FL 33139

Owner: Name Address Address Tel:

Email

OWNER OWNER_ADDRESS1 OWNER_ADDRESS2 OWNER_PHONE OWNER_EMAIL

Consultant: Name Address Address Tel: Email

Consultant: Name Address Address Tel: Email


Consultant: Name Address Address Tel: Email

Architect: Kobi Karp Architecture and Interior Design, Inc. 571 NW 28th Street, Miami, Florida 33127 USA Tel: +1(305) 573 1818 Fax: +1(305) 573 3766





Date	11-15-2021	Sheet No.
Scale		A1.12
Project	2191	

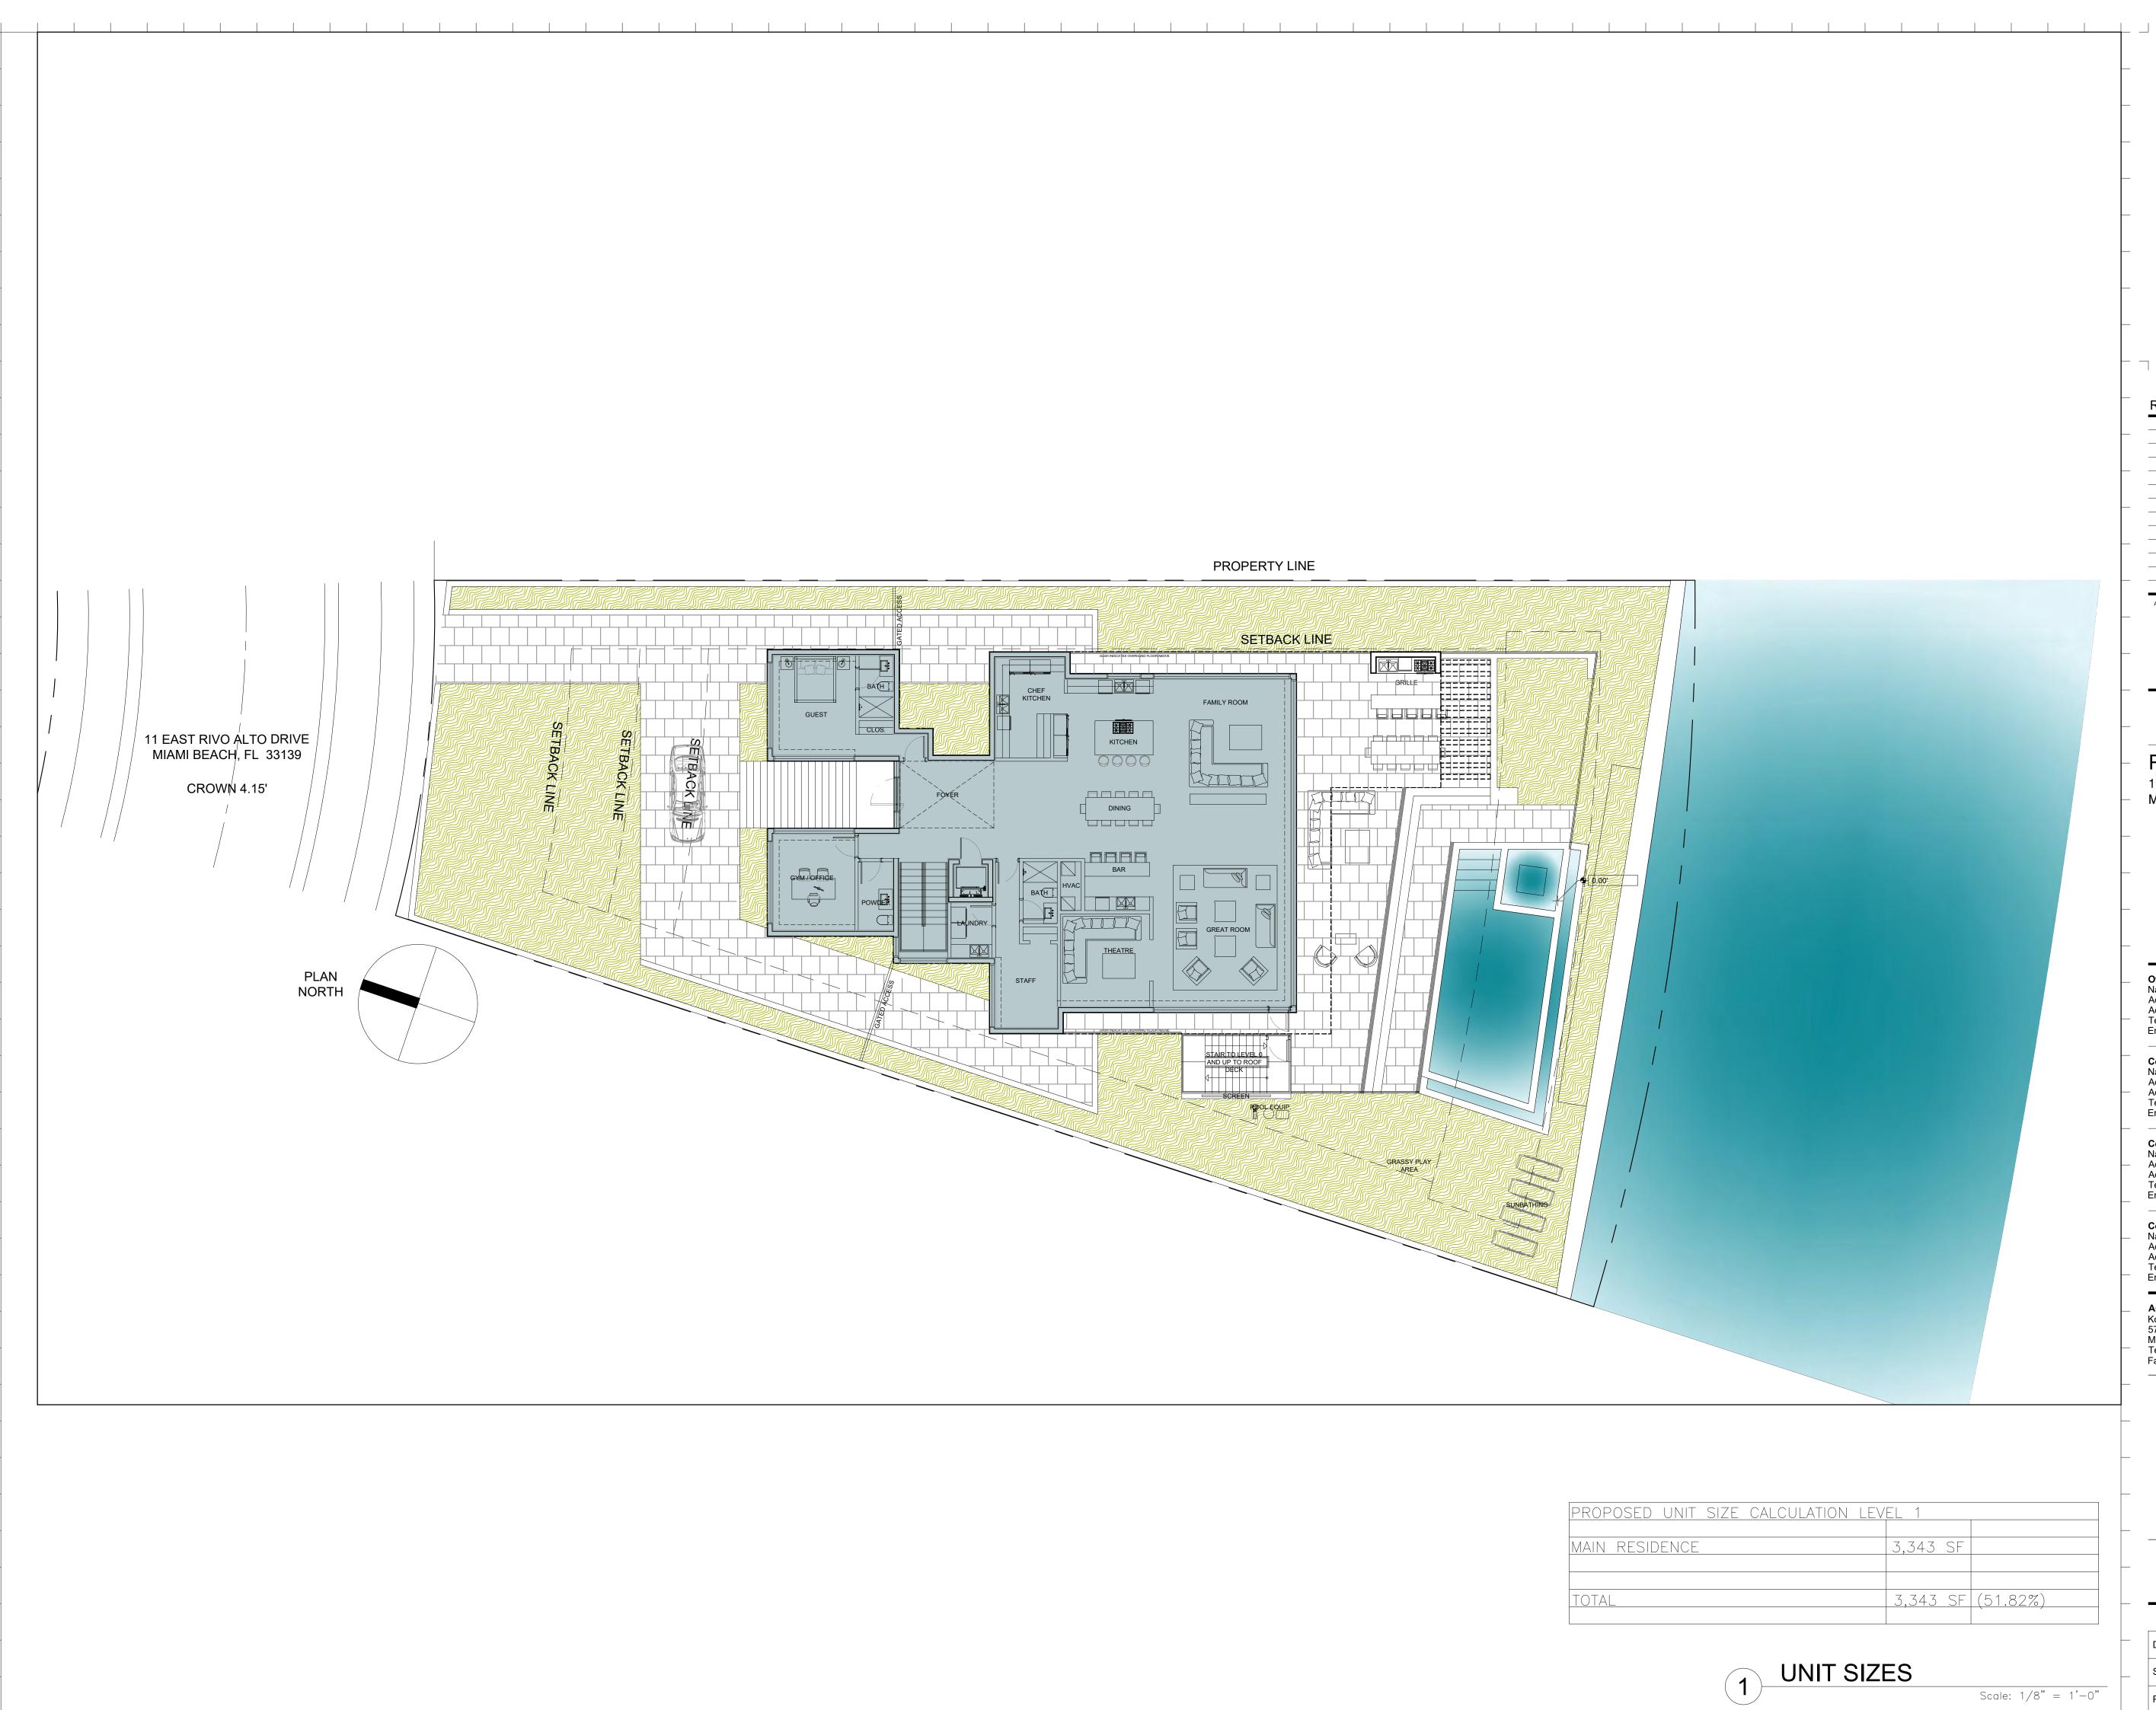

SIZE CALCULATION LEV	/EL 1	
	3,343 SF	
	3,343 SF	(51.82%)

Rev.	Date	Rev.	Da

PRIVATE RESIDENCE 11 EAST RIVO ALTO DRIVE

MIAMI BEACH, FL 33139

Owner: Name Address Address Tel:

Email


OWNER OWNER_ADDRESS1 OWNER_ADDRESS2 OWNER_PHONE OWNER_EMAIL

Consultant: Name Address Address Tel: Email

Consultant: Name Address Address Tel: Email


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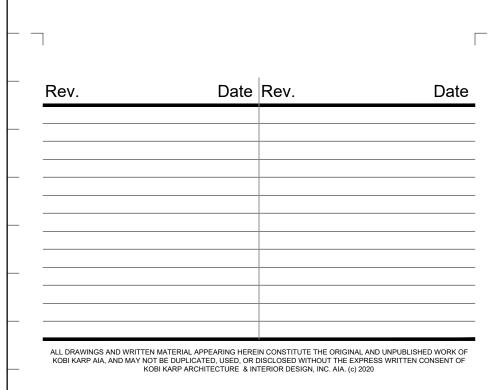


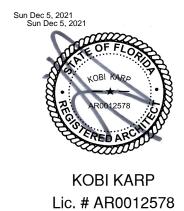

Date	11-15-2021	Sheet No.
Scale		A1.13
Project	2191	



SIZE CALCULATION LEVEL 2					
	2,603 SF				
	2,603 SF	(40.35%)			

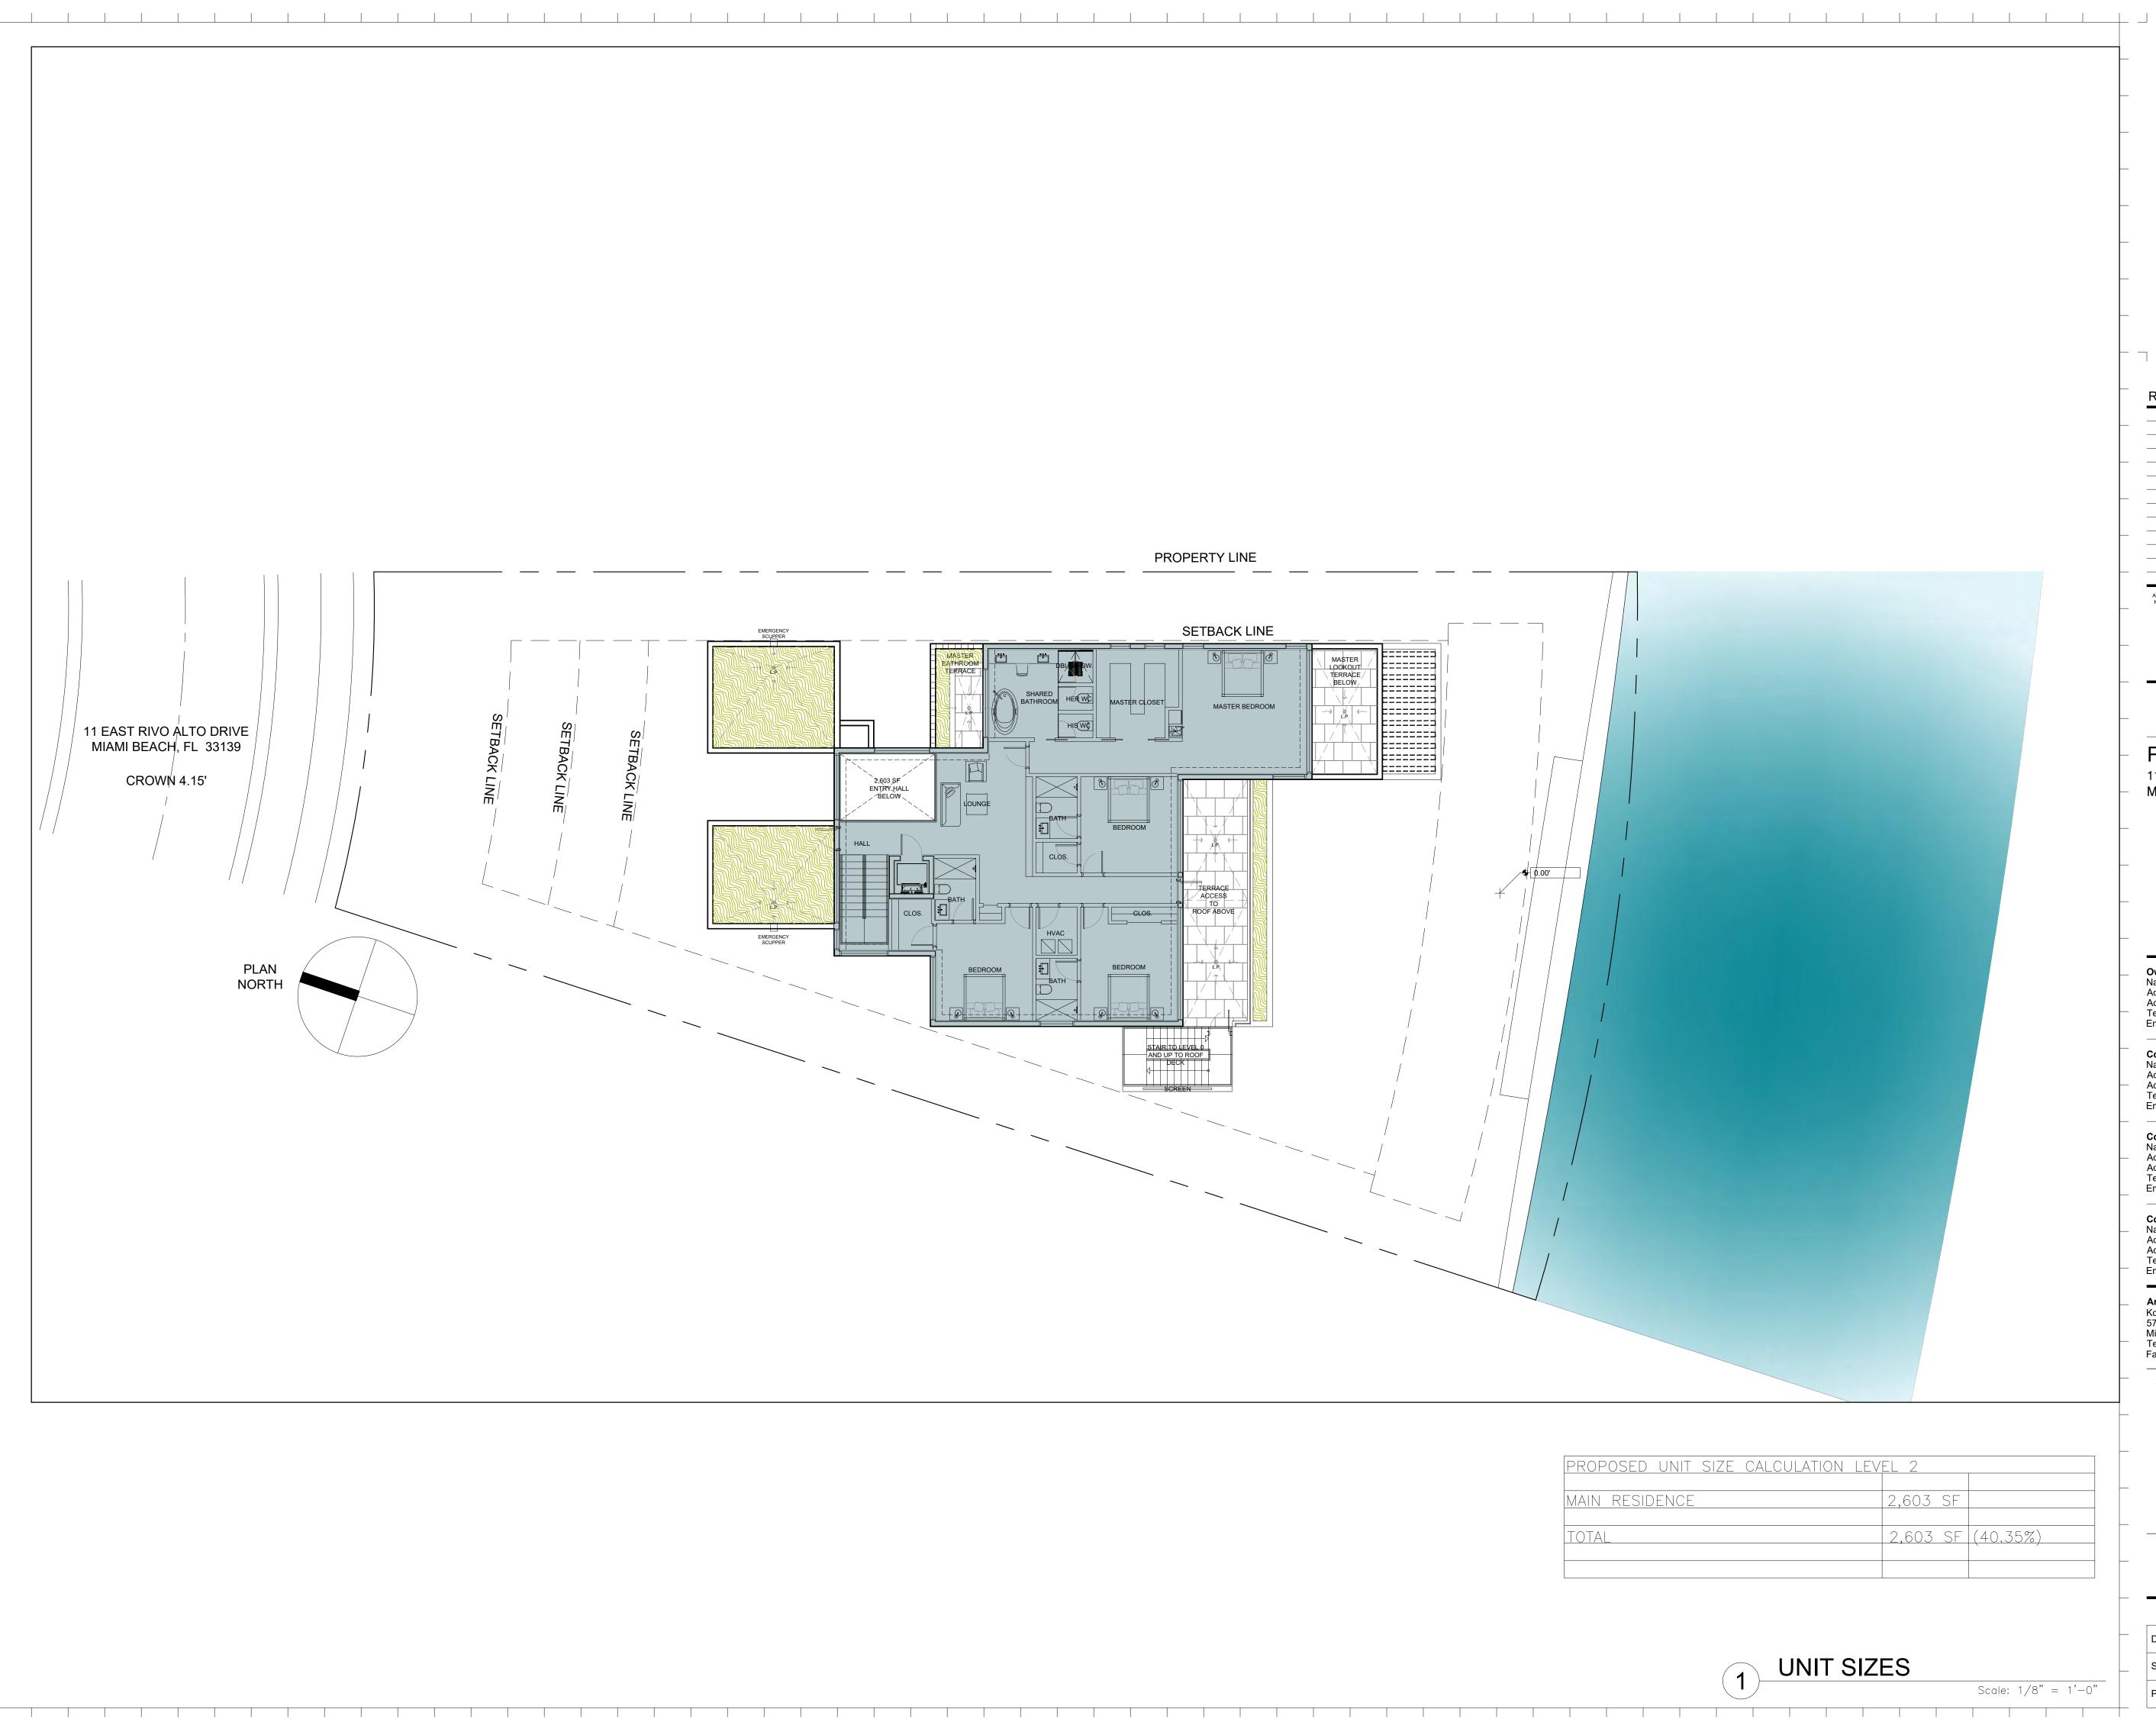

PRIVATE RESIDENCE 11 EAST RIVO ALTO DRIVE

MIAMI BEACH, FL 33139

Owner: Name Address Address Tel:

Email


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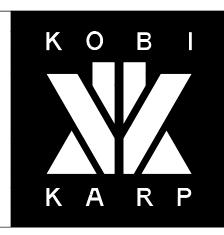
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Consultant: Name Address Address Tel: Email


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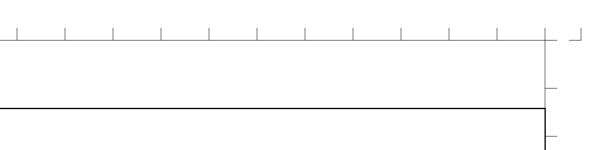





Date	11-15-2021	Sheet No.
Scale		A1.1
Project	2191	

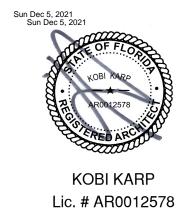

PROPERTY LINE		
EMERGENCY SETBACKyEkoINE		
PROPOSED UNIT SIZE CALCULATION ROOF LEVEL	PROPOSED ROOF DECK CALCULATION	
ELEVATOR BULKHEAD 42 SF	SECOND FLOOR ENCLOSED AREA 2,603 SF	-
ELEVATOR BULKHEAD 42 SF	MAX USEABLE ROOF DECK ALLOWED 650 SF (25.00%)	
TOTAL 42 SF	TOTAL PROPOSED USEABLE ROOF DECK 632 SF (24.30%)	
	MAXIMUM TRELLIS 20% 520 SF (20.00%)	
	PROPOSED TRELLIS 520 SF (20.00%)	
	[1 + (0 + 0) = 0 + (20 + 0) + (I

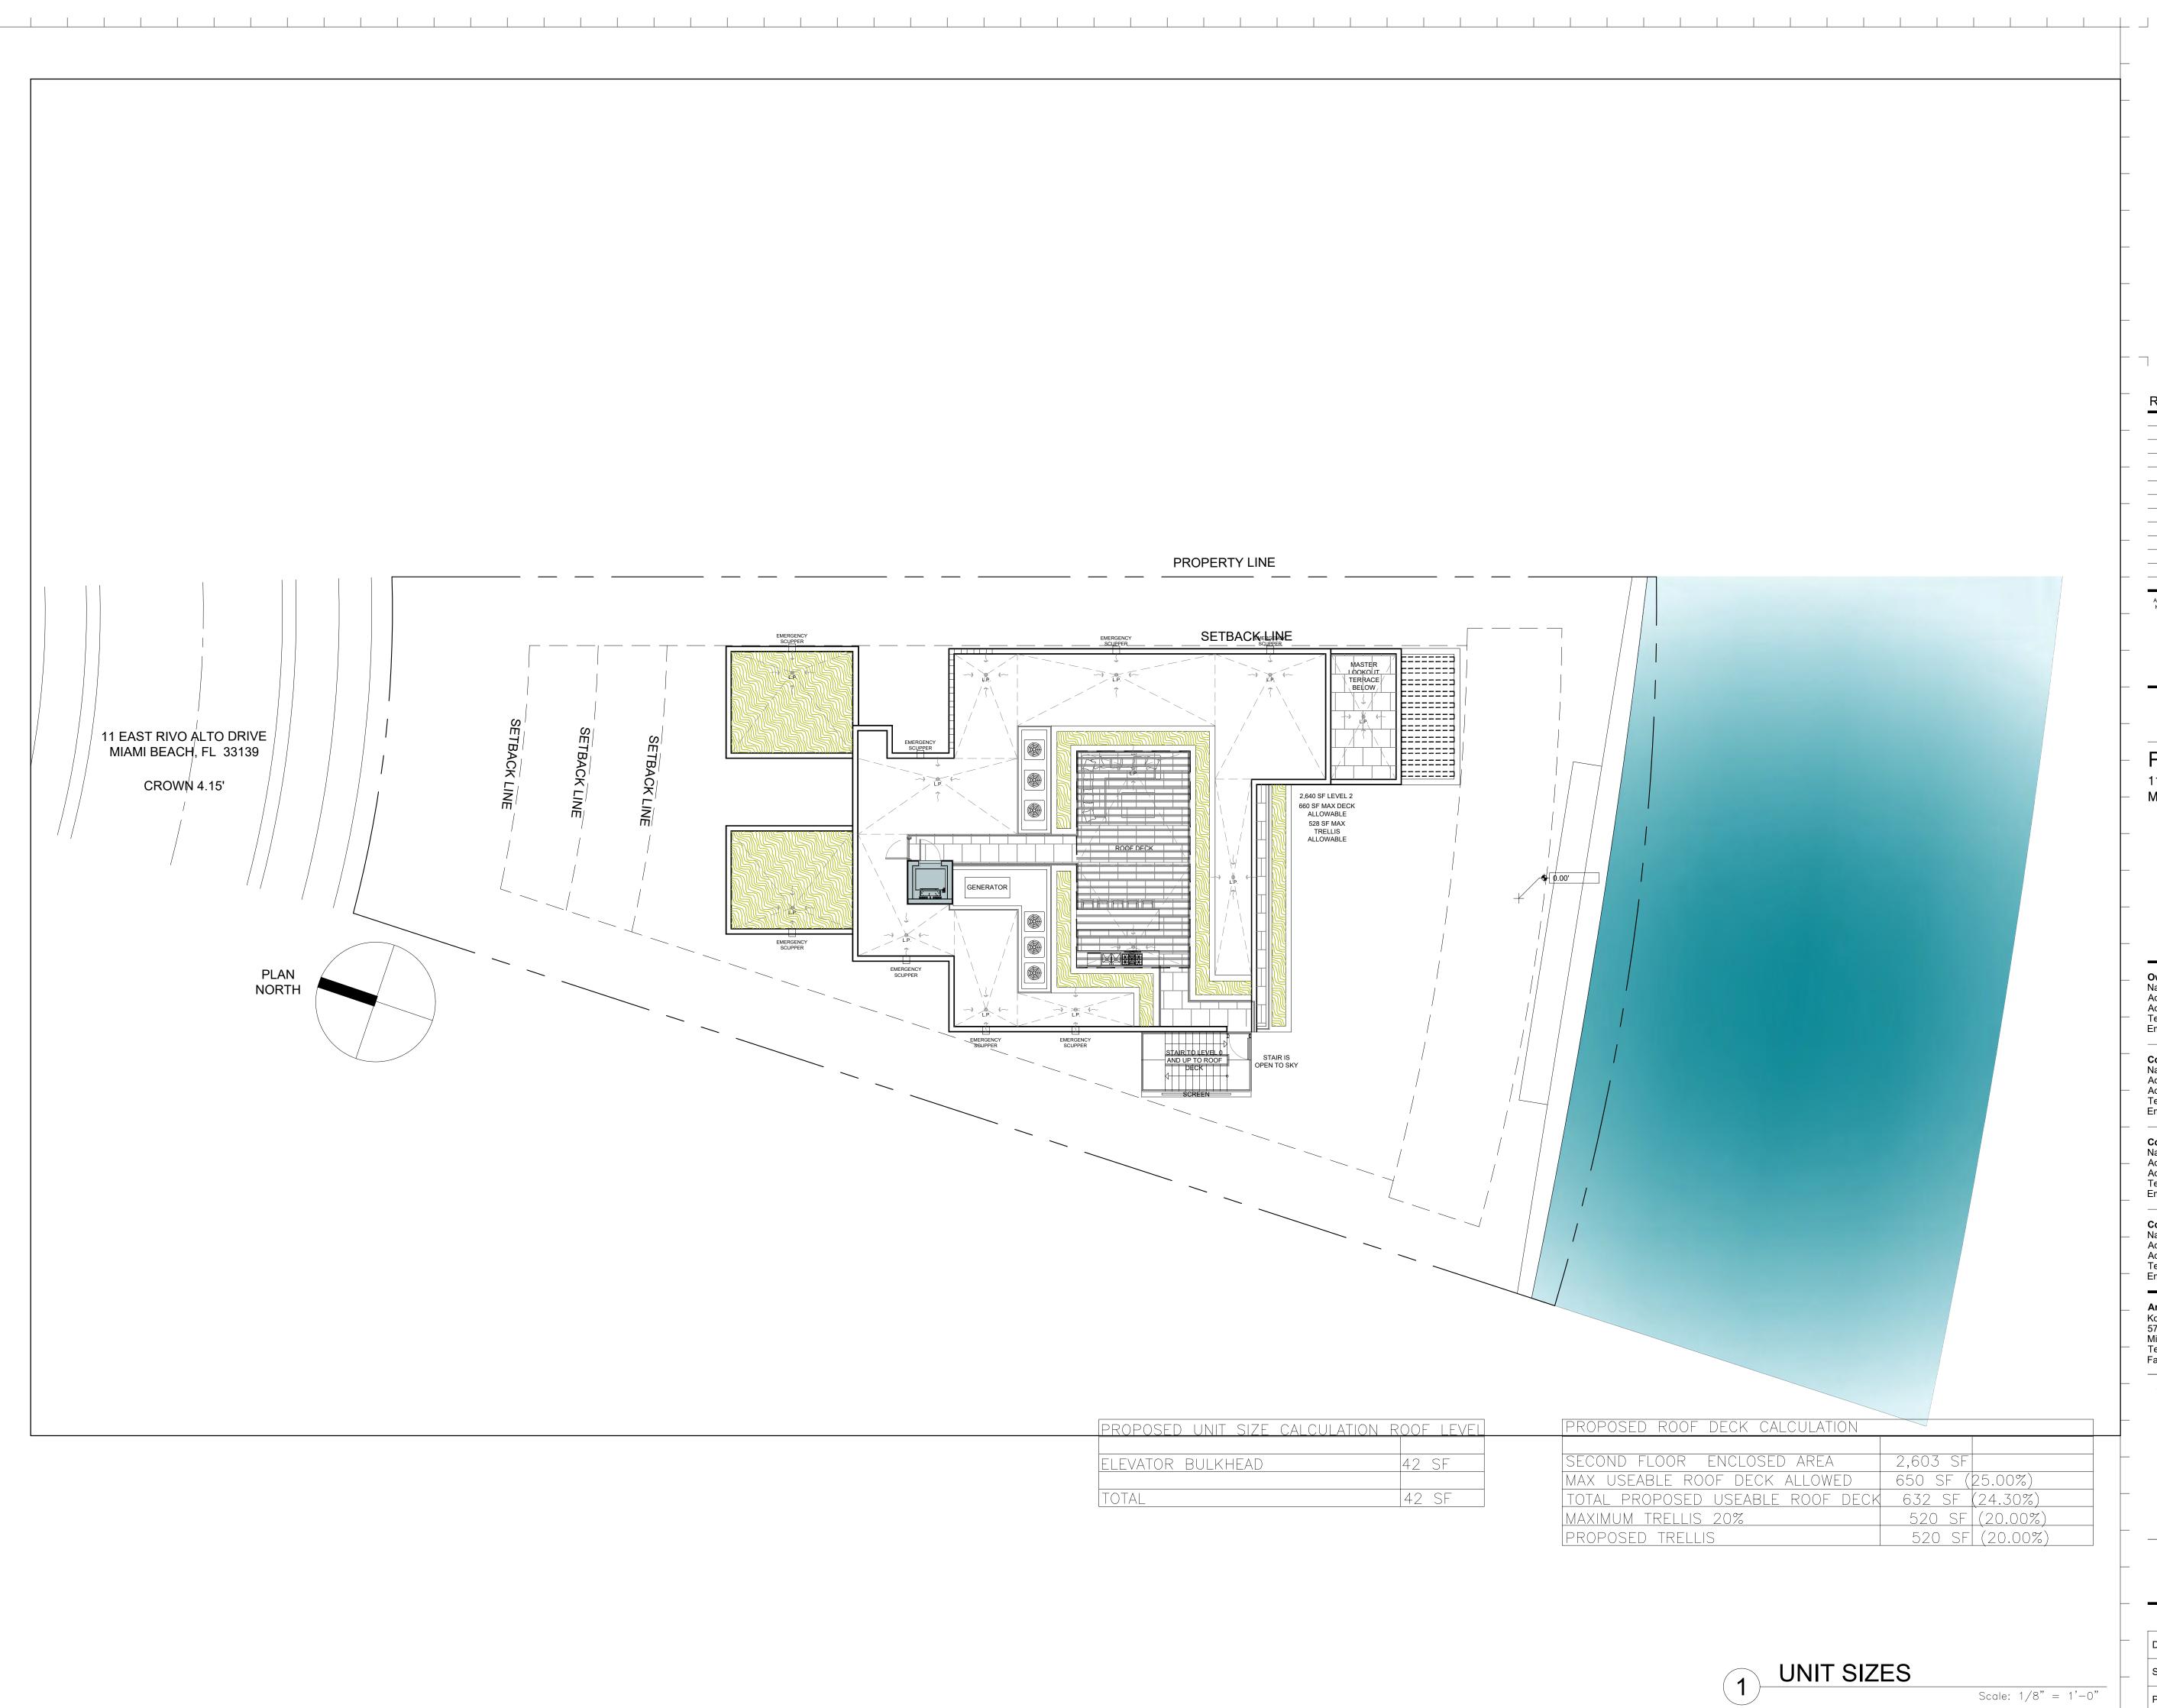

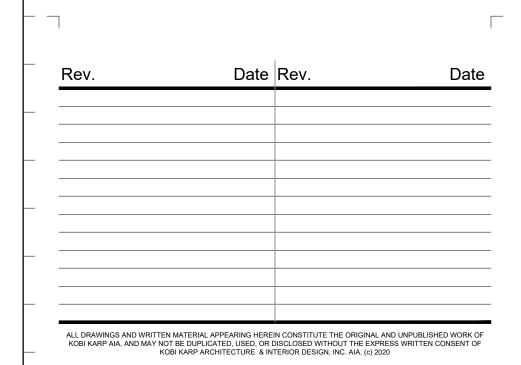

PRIVATE RESIDENCE 11 EAST RIVO ALTO DRIVE

MIAMI BEACH, FL 33139

Owner: Name Address

Name OWNER Address OWNER_ADDRESS1 Address OWNER_ADDRESS2 Tel: OWNER_PHONE Email OWNER_EMAIL


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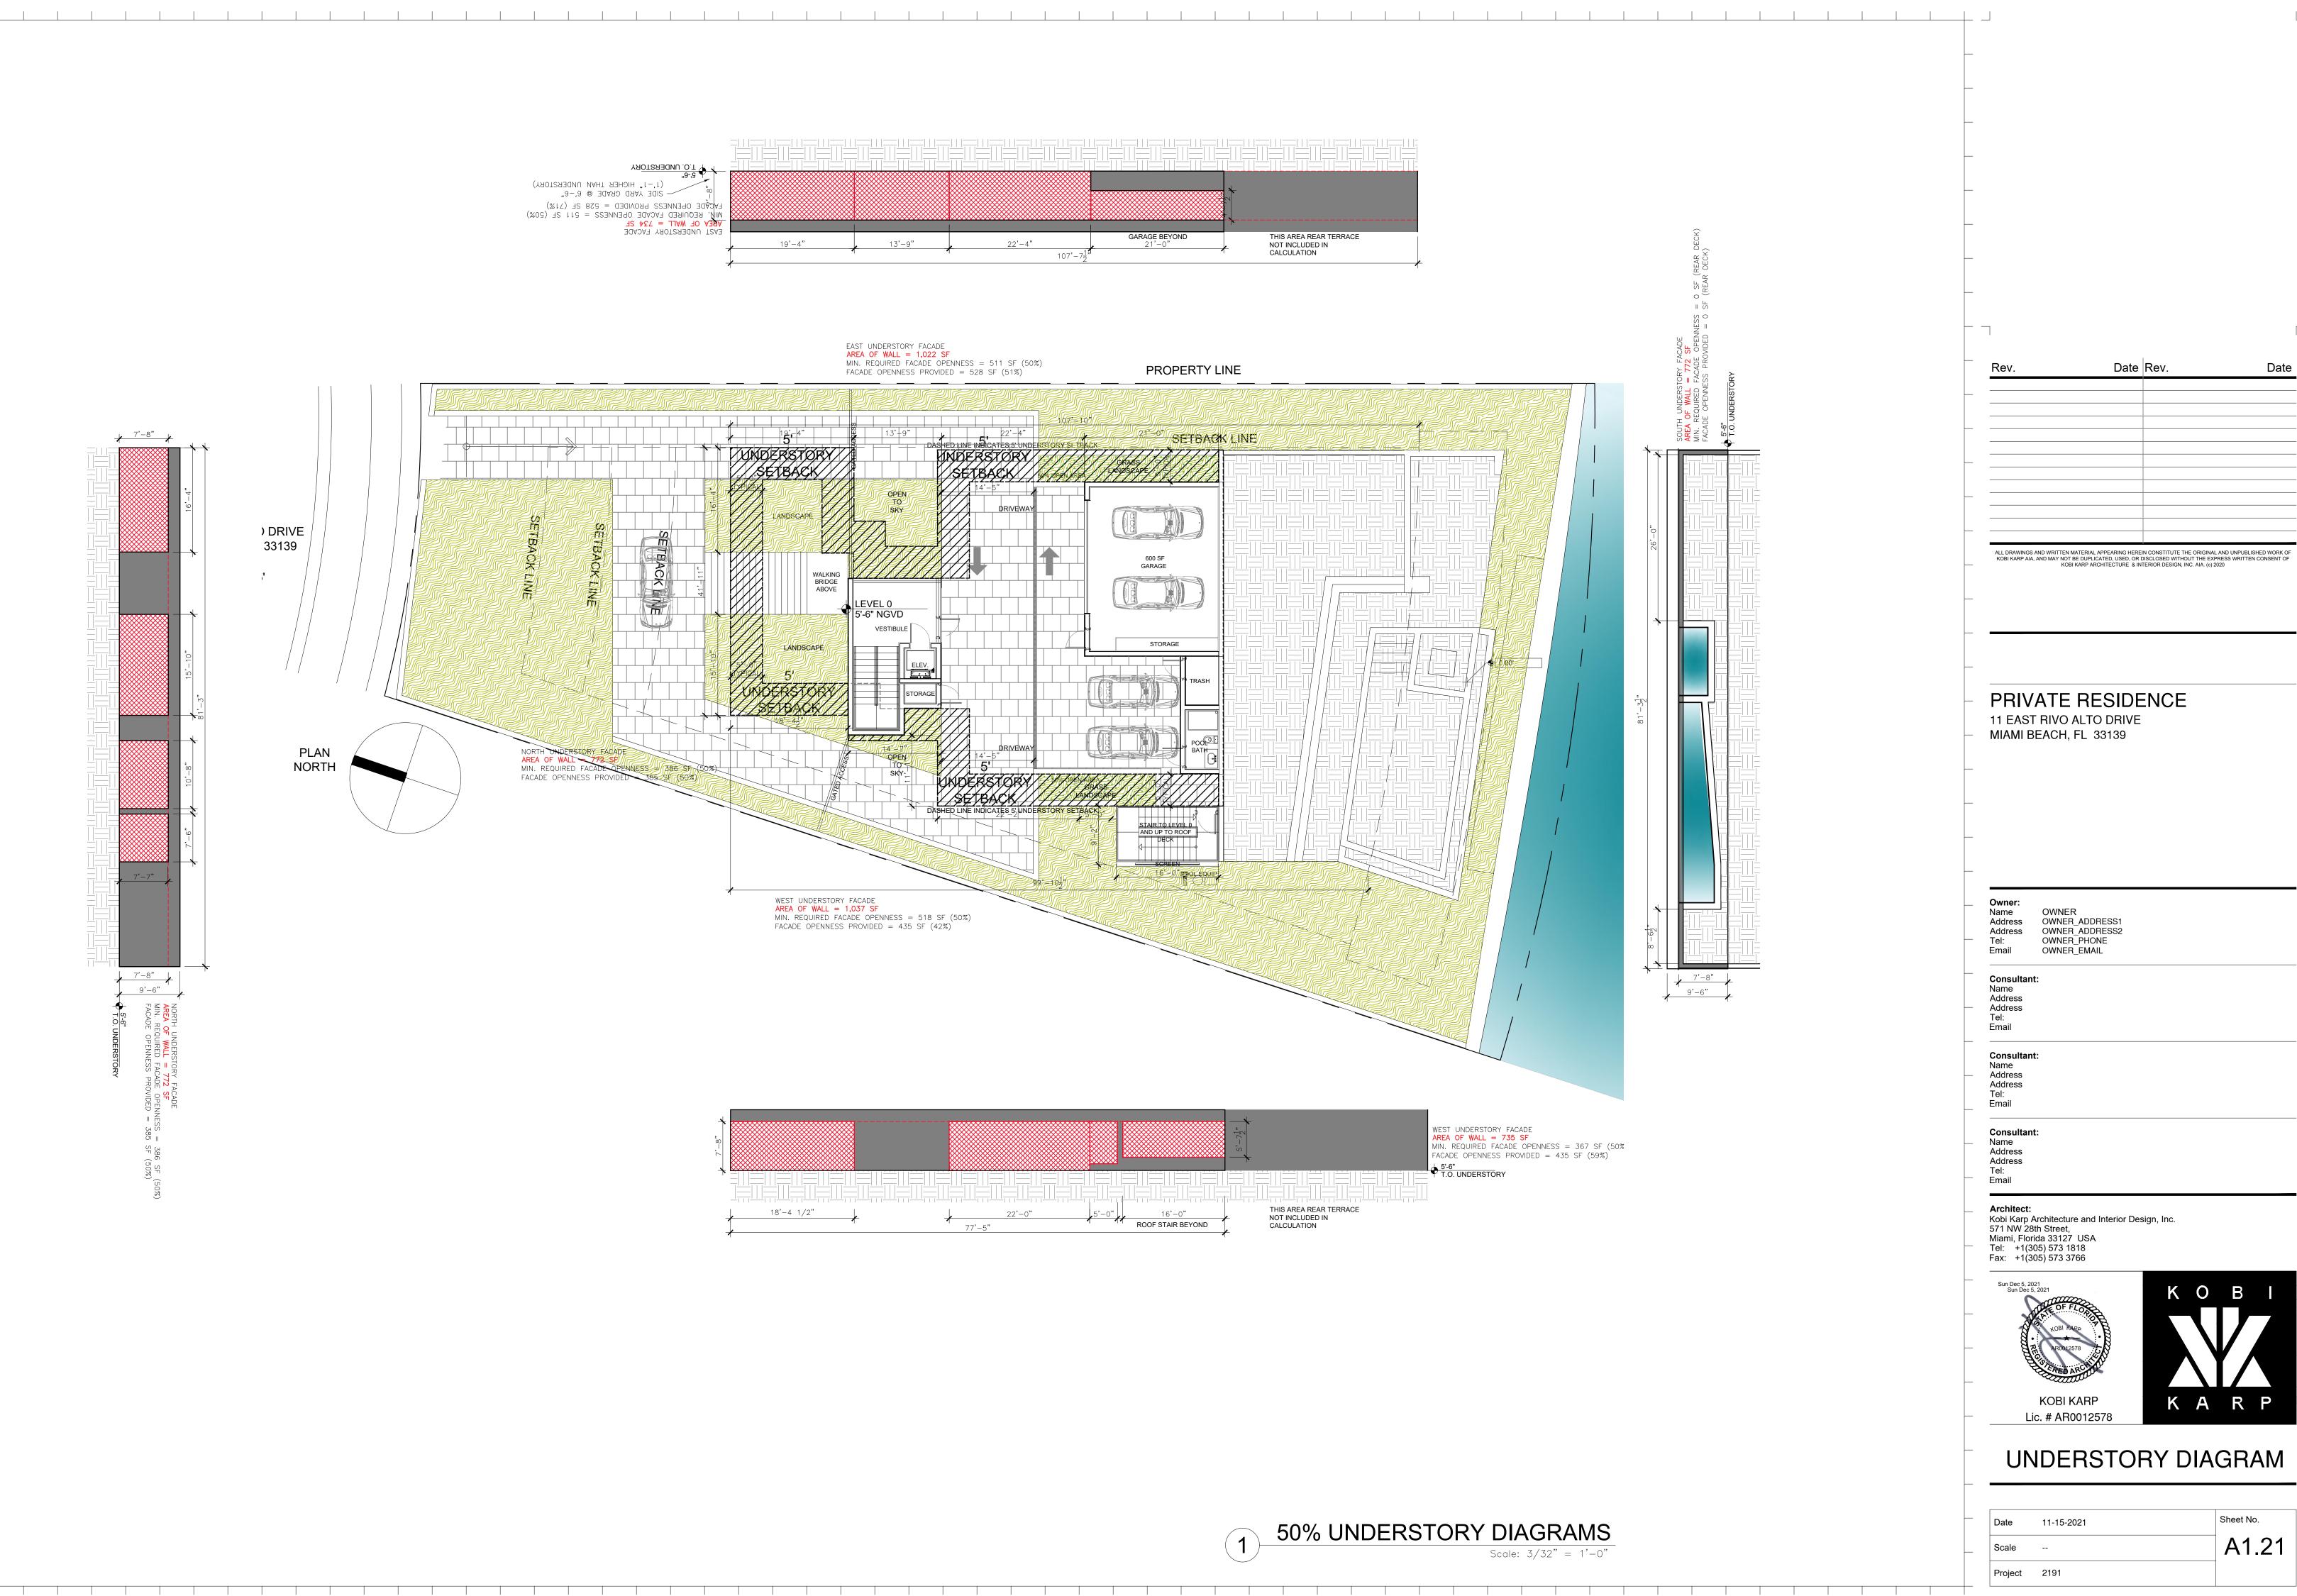
Architect: Kobi Karp Architecture and Interior Design, Inc. 571 NW 28th Street, Miami, Florida 33127 USA Tel: +1(305) 573 1818 Fax: +1(305) 573 3766





Date	11-15-2021	Sheet No.
Scale		A1.15
Project	2191	




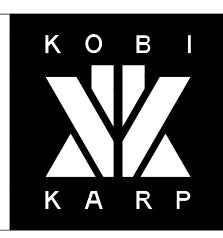

7-1 IW					× + + + + + + + - + + - + + - + + + + + + + + +
ענ ר∕-					·
				GARAGE BEYOND	THIS AREA REAR TERRACE
-	19'-4"	13'-9"	22'-4"	21'-0"	NOT INCLUDED IN
•		1	$107' - 7\frac{1}{2}''$	*	CALCULATION
7	/		ζ		/

Sheet No.

Date

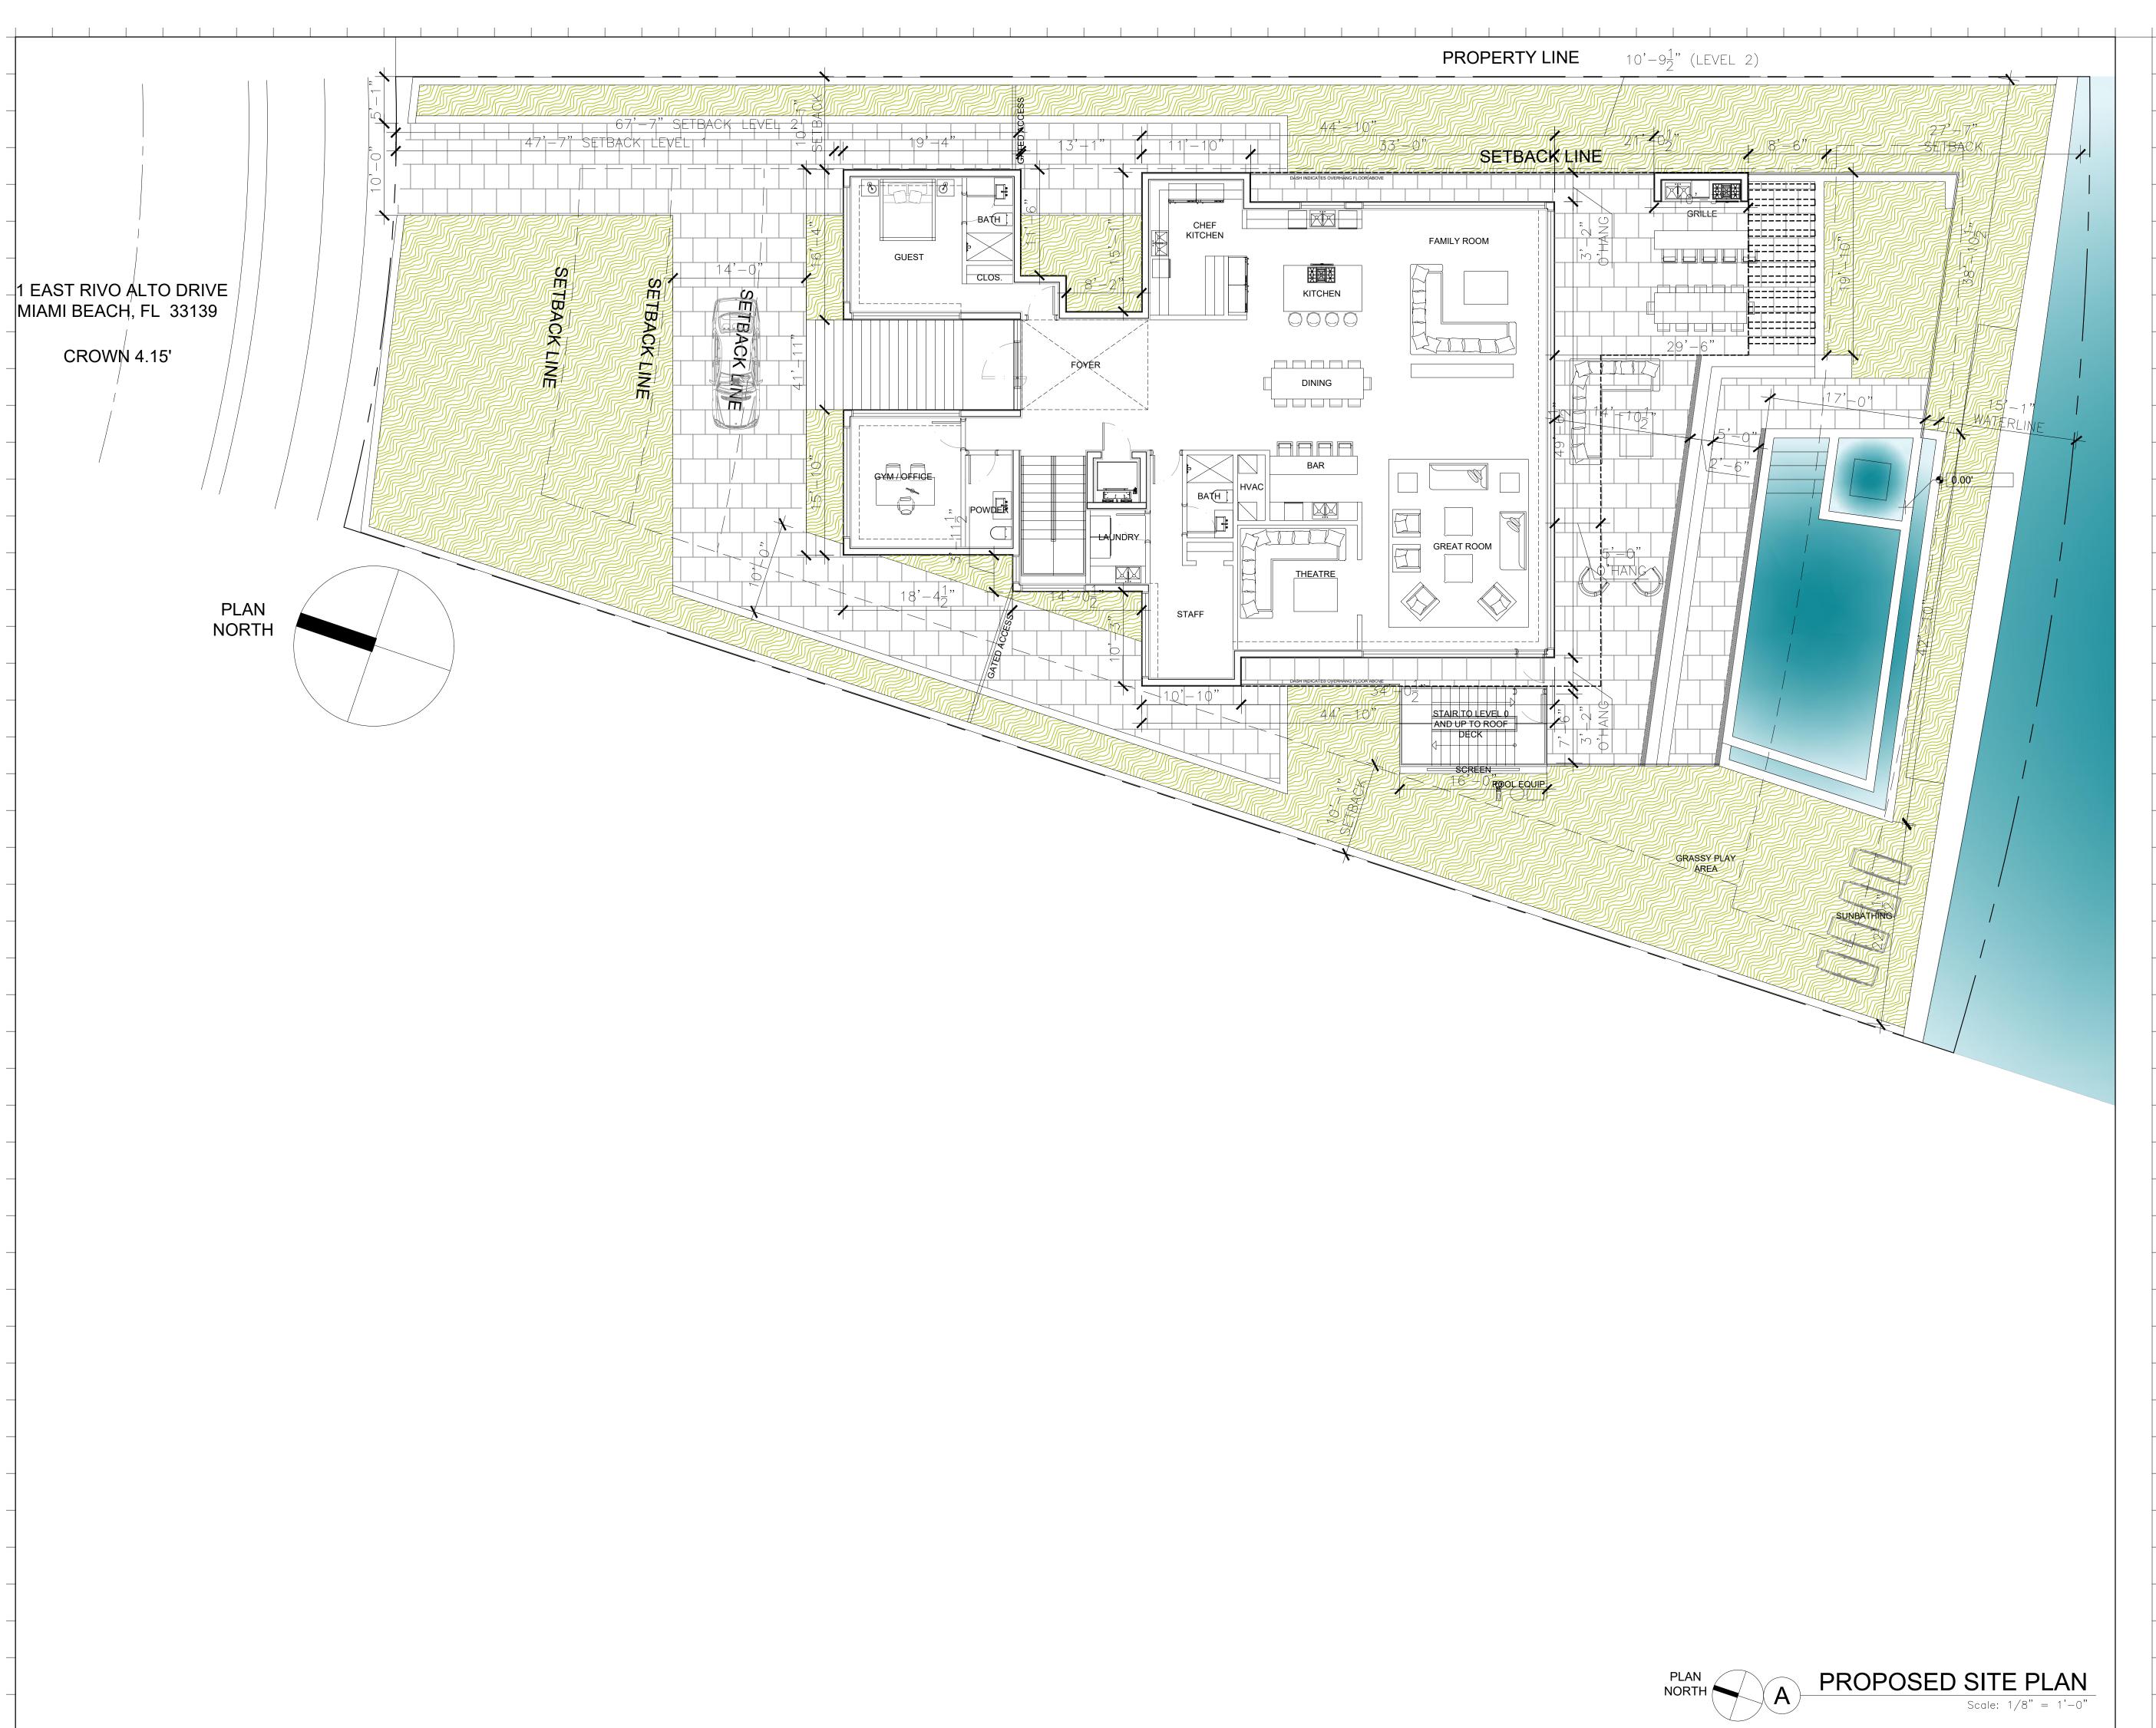

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PRIVATE RESIDENCE 11 EAST RIVO ALTO DRIVE

MIAMI BEACH, FL 33139

Owner: Name Address Address Tel:

Email

OWNER OWNER_ADDRESS1 OWNER_ADDRESS2 OWNER_PHONE OWNER_EMAIL

Consultant: Name Address Address Tel: Email


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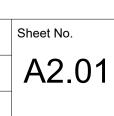


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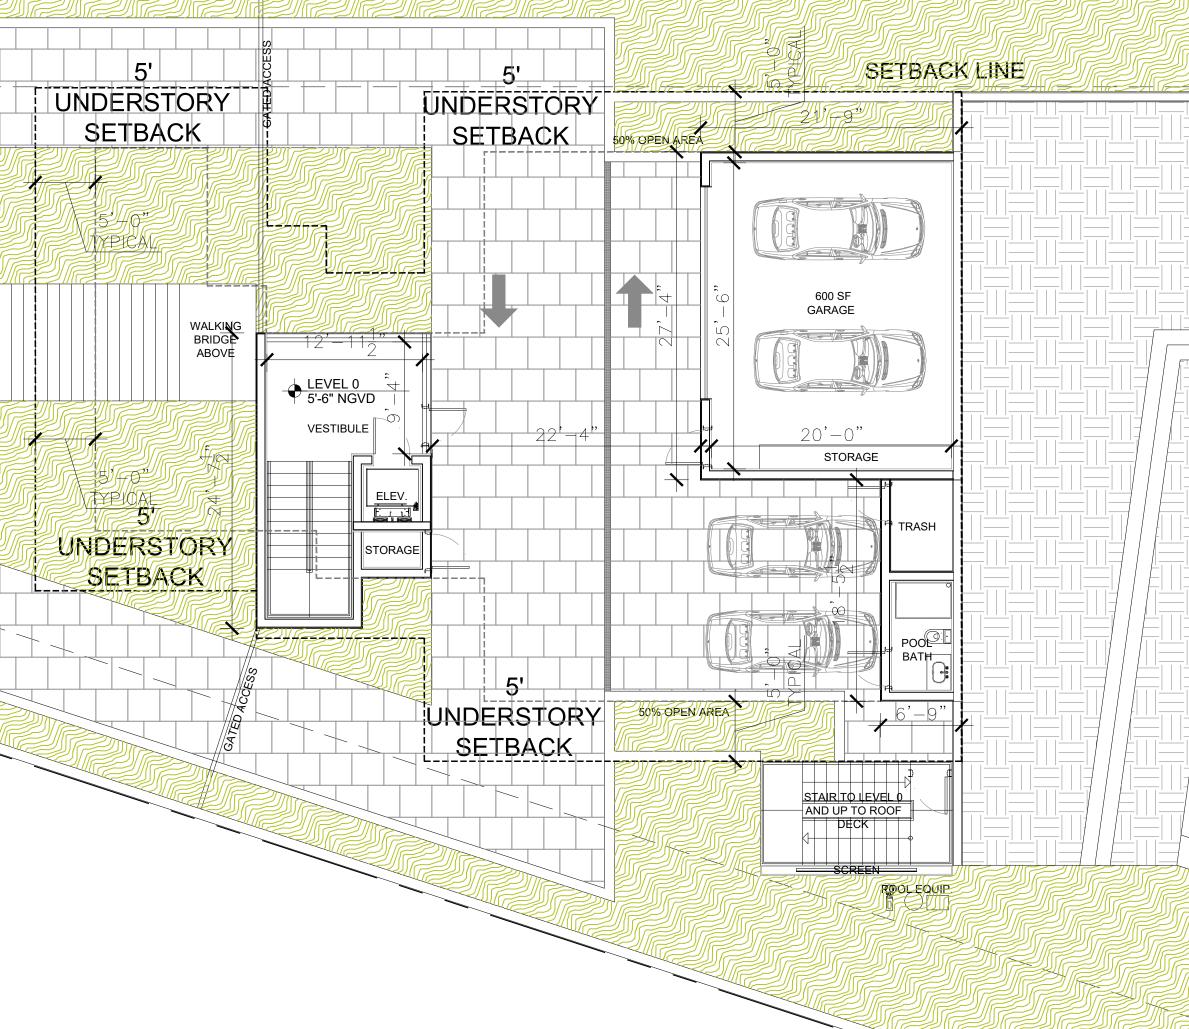
PROPOSED SITE PLAN


Date	11-15-202 ⁻
Scale	
Project	2191



1 1 SETEROR SETENCE ST RIVO ALTO DRIVE SETBACK LINE MI BEACH, FL 33139 CROWN 4.15' PLAN NORTH

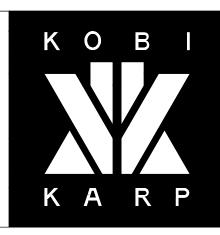PROPERTY LINE



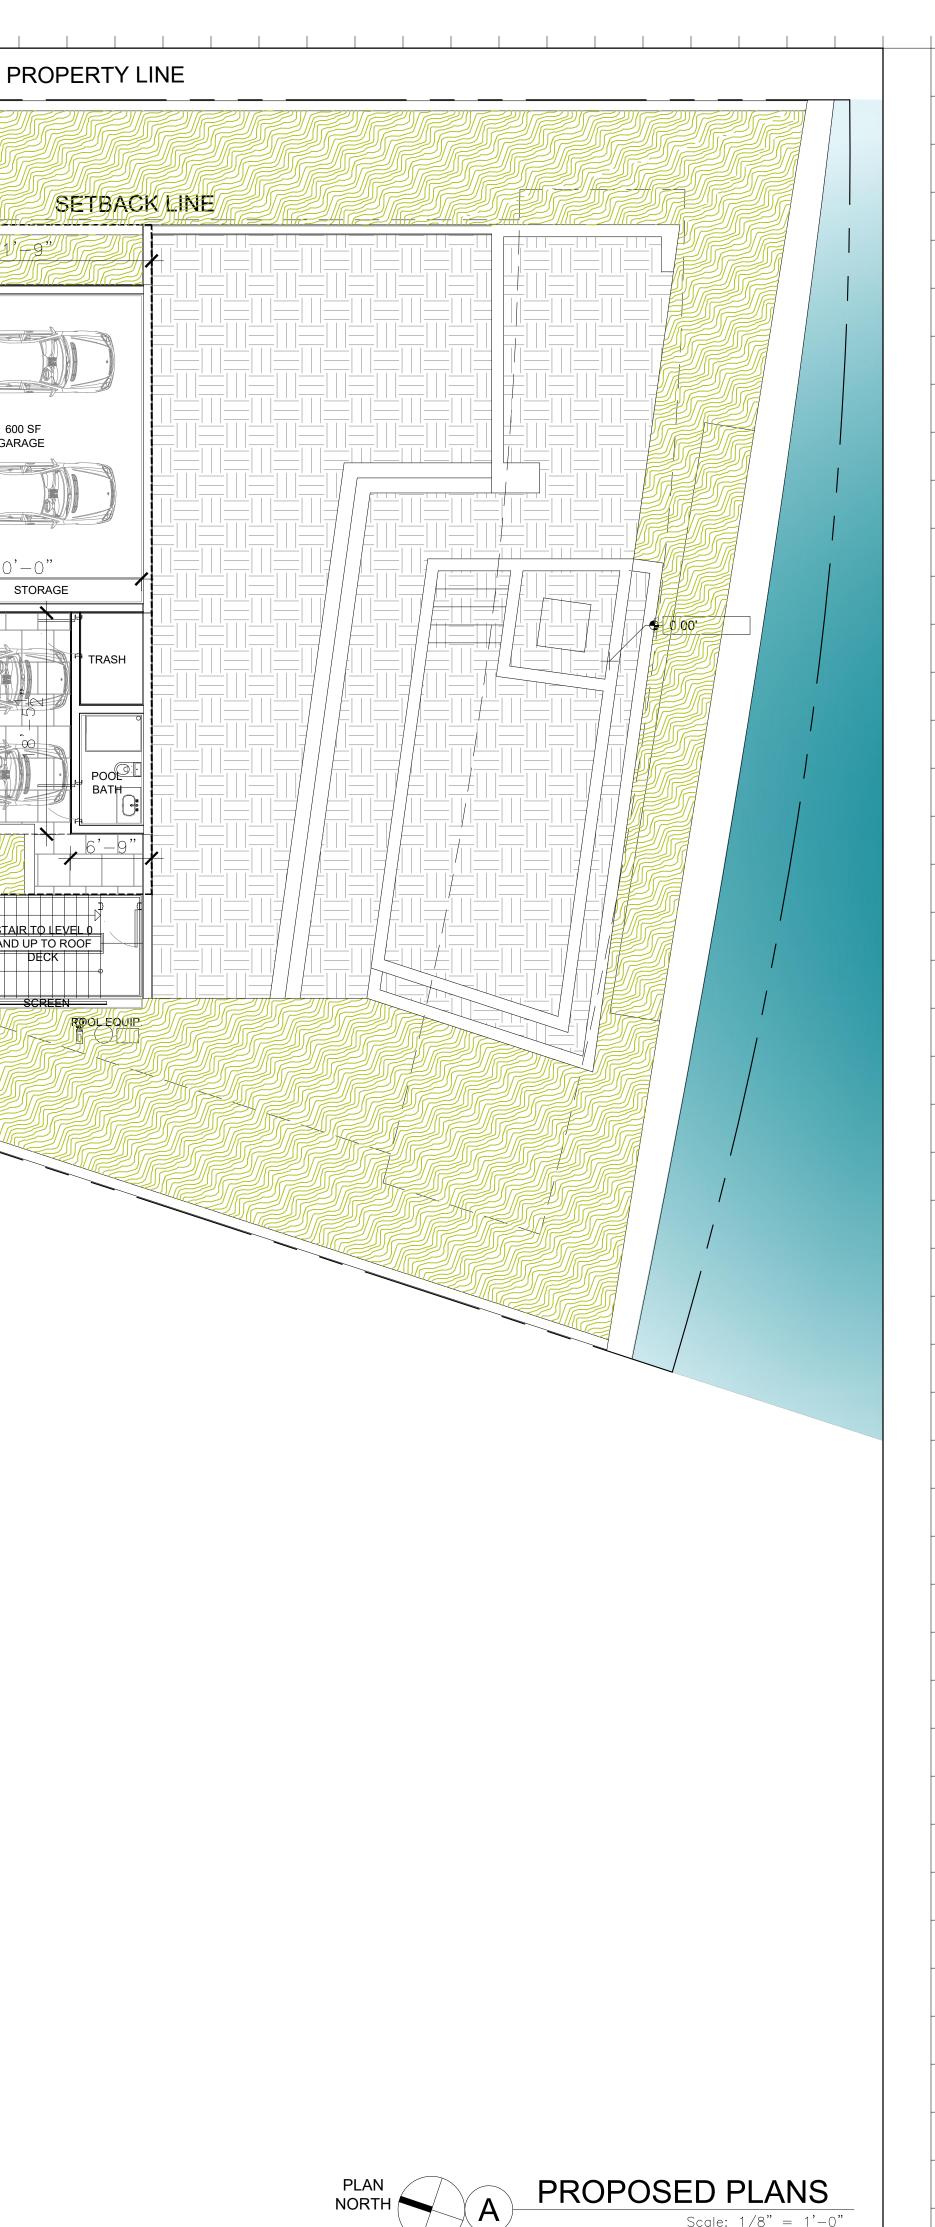

Rev.	Date Rev.	Dat

PRIVATE RESIDENCE 11 EAST RIVO ALTO DRIVE

MIAMI BEACH, FL 33139

Owner: Name Address Address Tel:

Email

OWNER OWNER_ADDRESS1 OWNER_ADDRESS2 OWNER_PHONE OWNER_EMAIL


Consultant: Name Address Address Tel: Email

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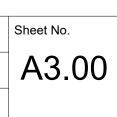


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PROPOSED LEVEL 0


Date	11-15-2021
Scale	
Project	2191


Scale: 1/8" = 1'-0"

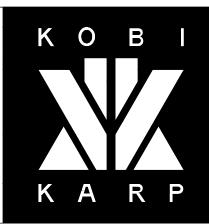

S SETBACK ST RIVO ALTO DRIVE BACKLINE SETBACK LINE MI BEACH, FL 33139 CROWN 4.15' PLAN NORTH



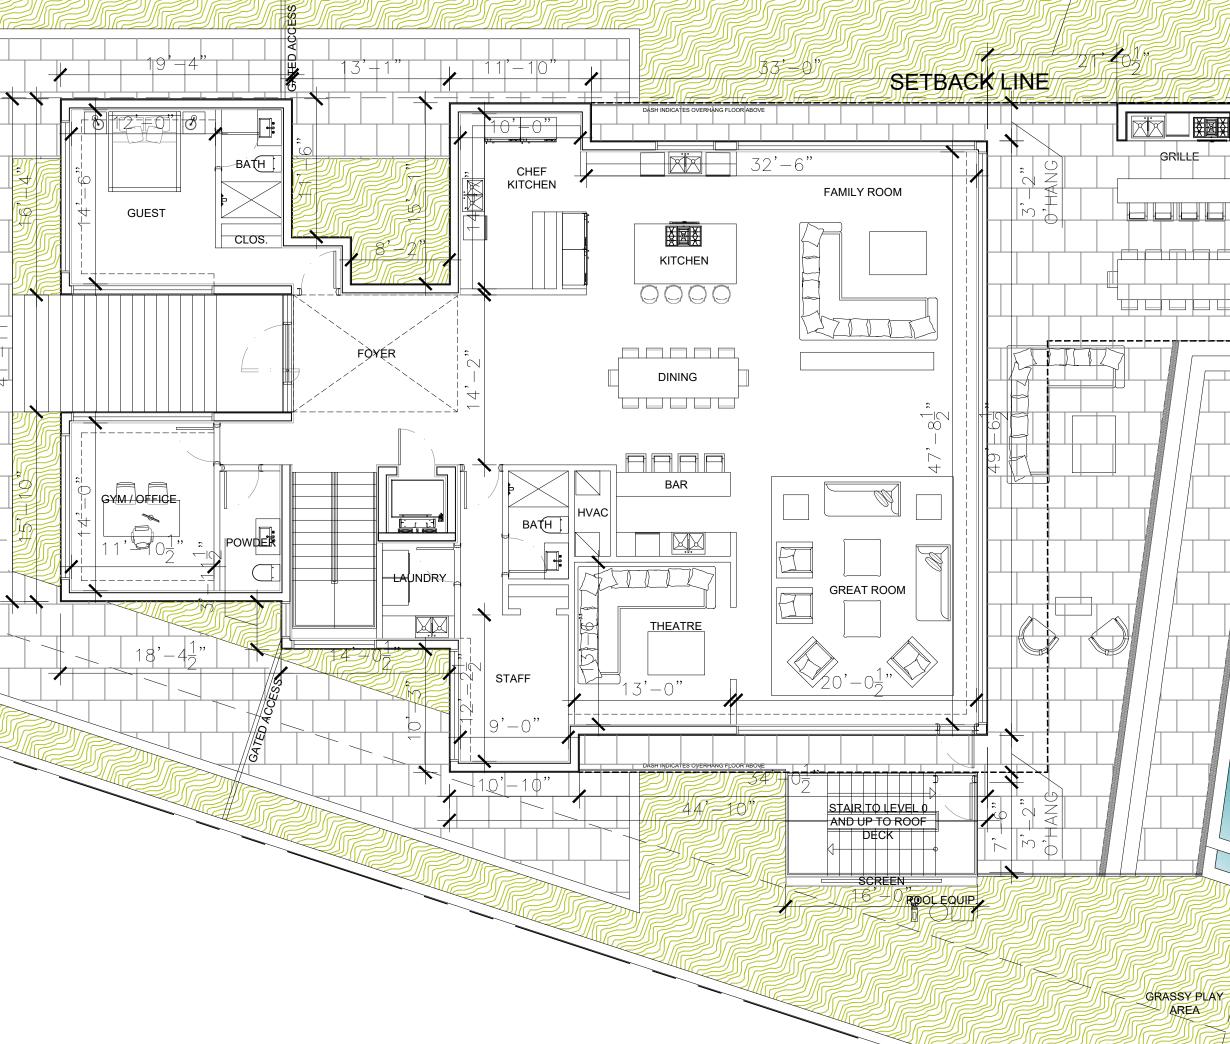

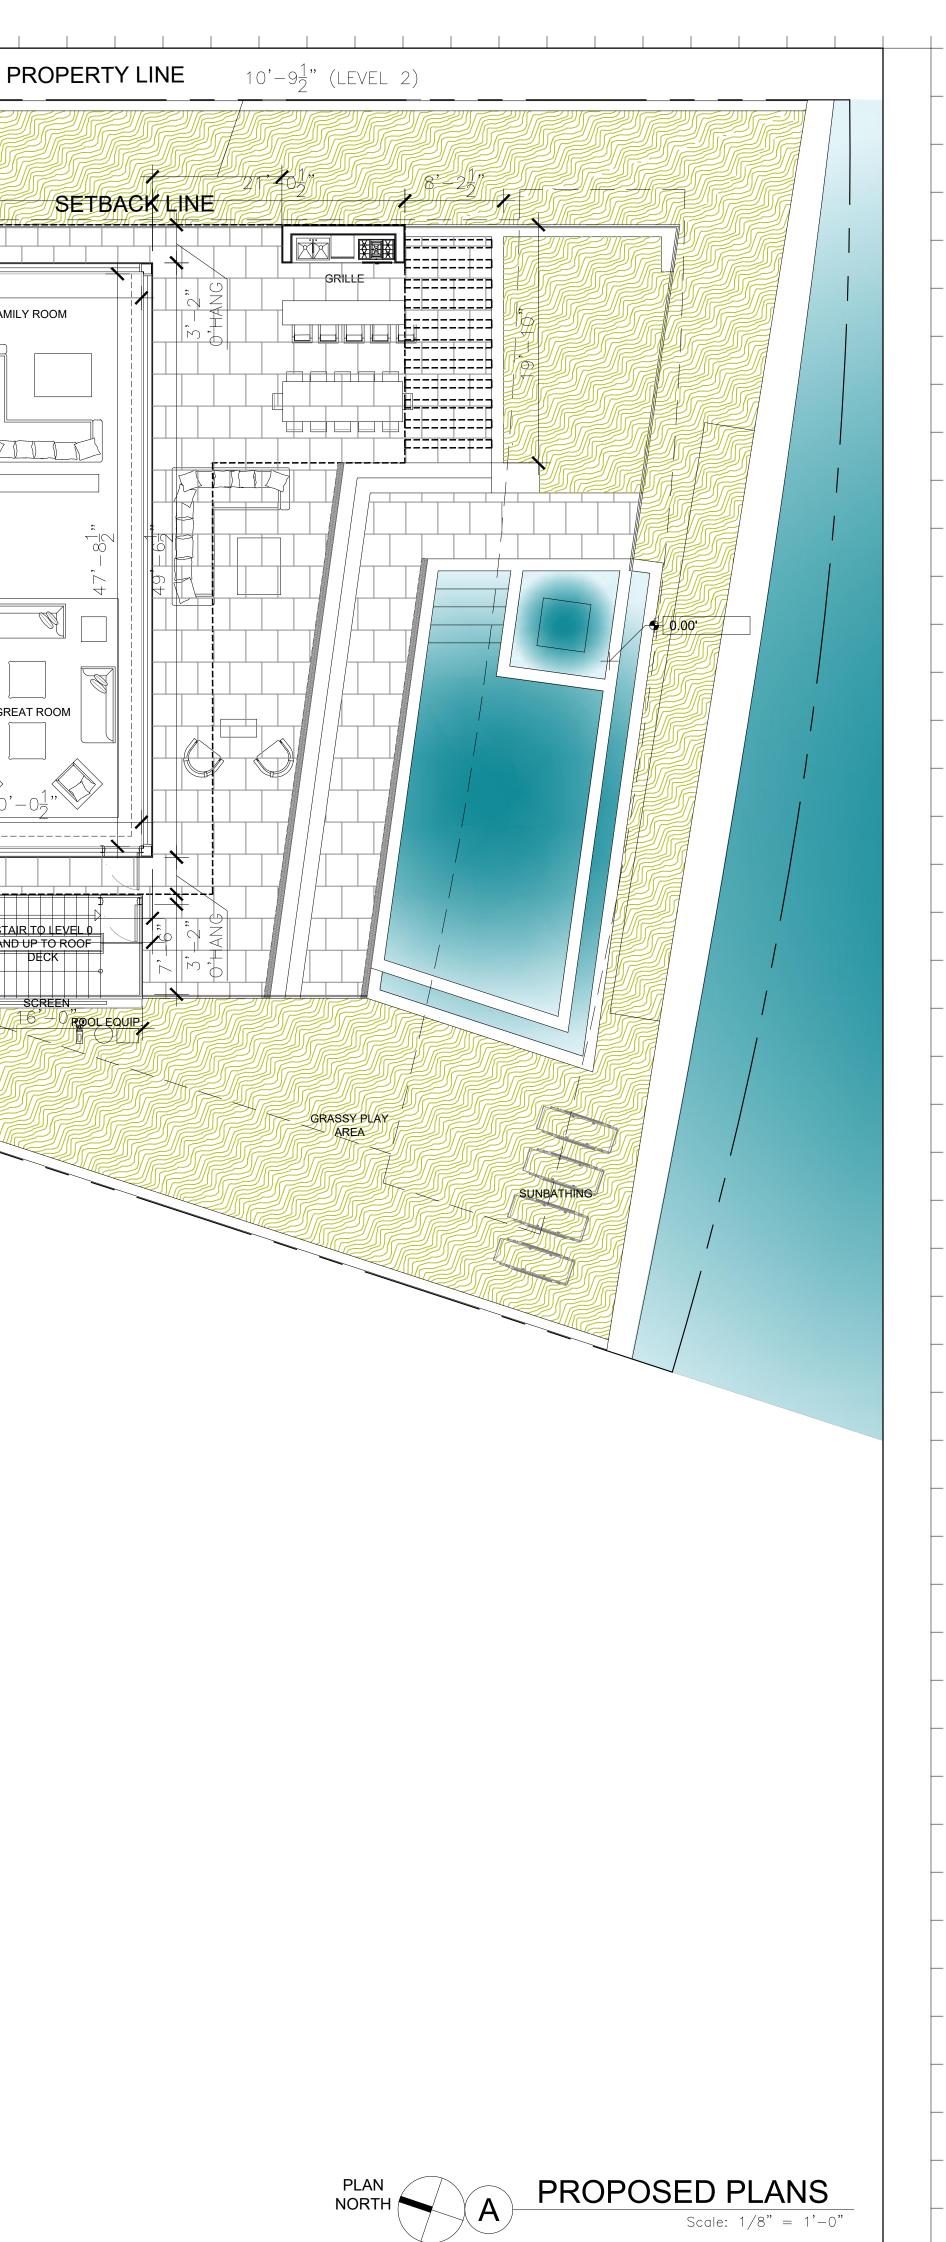

Rev.	Date	Rev.	Date

PRIVATE RESIDENCE

11 EAST RIVO ALTO DRIVE MIAMI BEACH, FL 33139

Owner: Name Address Address Tel:

Email


OWNER OWNER_ADDRESS1 OWNER_ADDRESS2 OWNER_PHONE OWNER_EMAIL

Consultant: Name Address Address Tel: Email

Consultant: Name Address Address Tel: Email

Consultant: Name Address Address Tel: Email


Architect: Kobi Karp Architecture and Interior Design, Inc. 571 NW 28th Street, Miami, Florida 33127 USA Tel: +1(305) 573 1818 Fax: +1(305) 573 3766

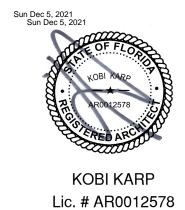



PROPOSED LEVEL 1

Date	11-15-2021
Scale	
Project	2191

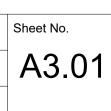


1 1 _____ ____ __ __ ____ ____ ____ _____ ST RIVO ALTO DRIVE NI BEACH, FL 33139 CROWN 4.15' PLAN NORTH

PROPERTY LINE

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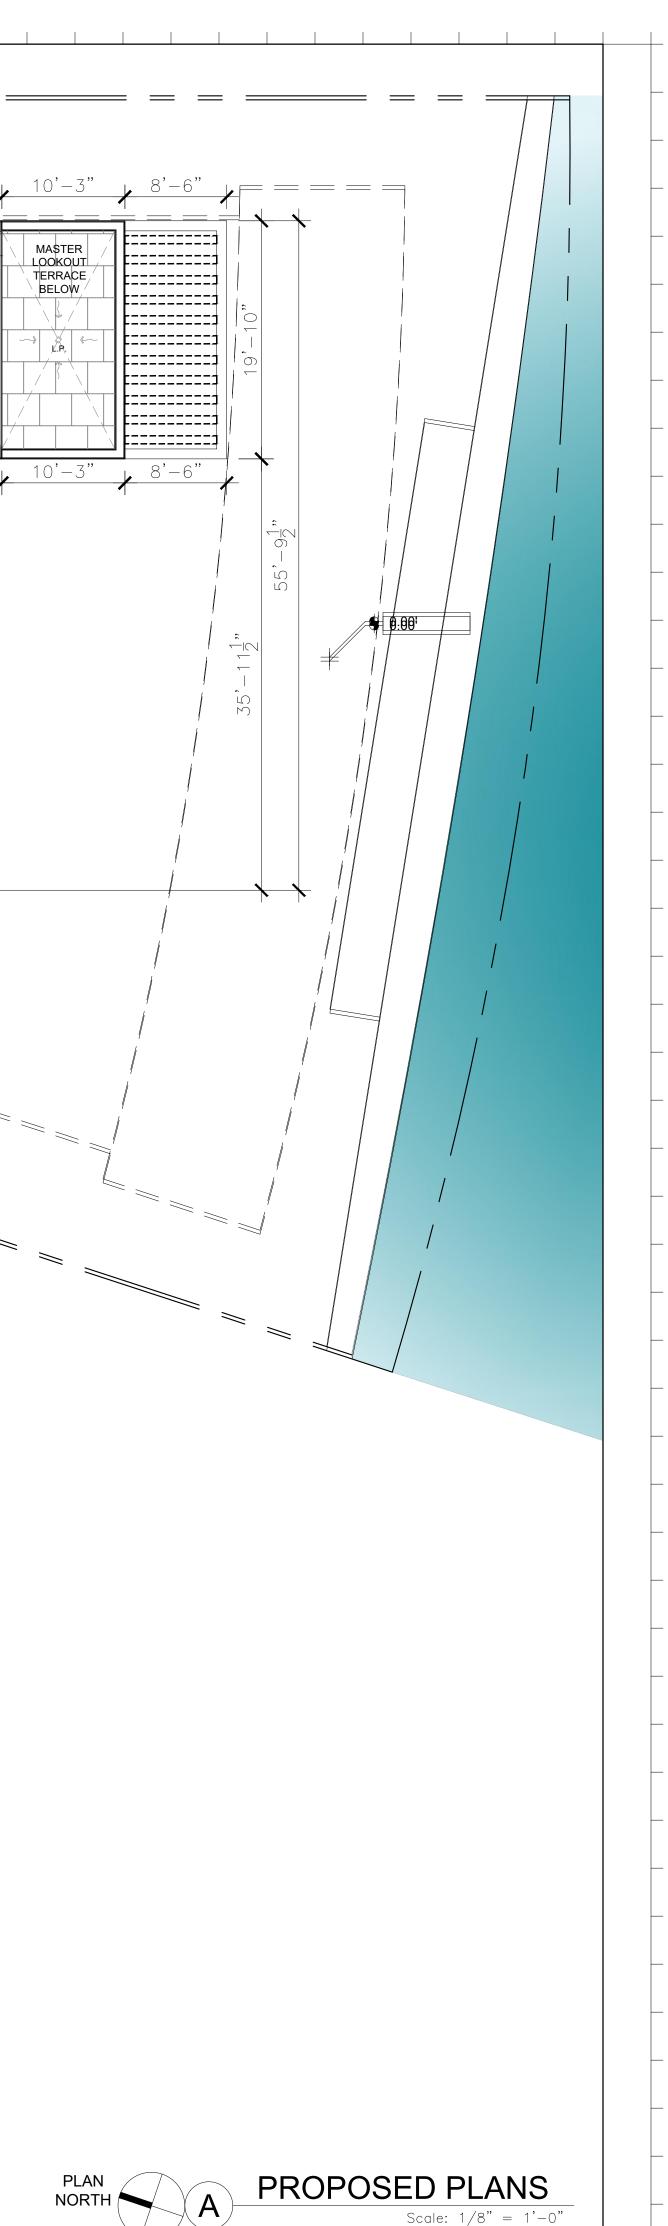
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PRIVATE RESIDENCE 11 EAST RIVO ALTO DRIVE

MIAMI BEACH, FL 33139

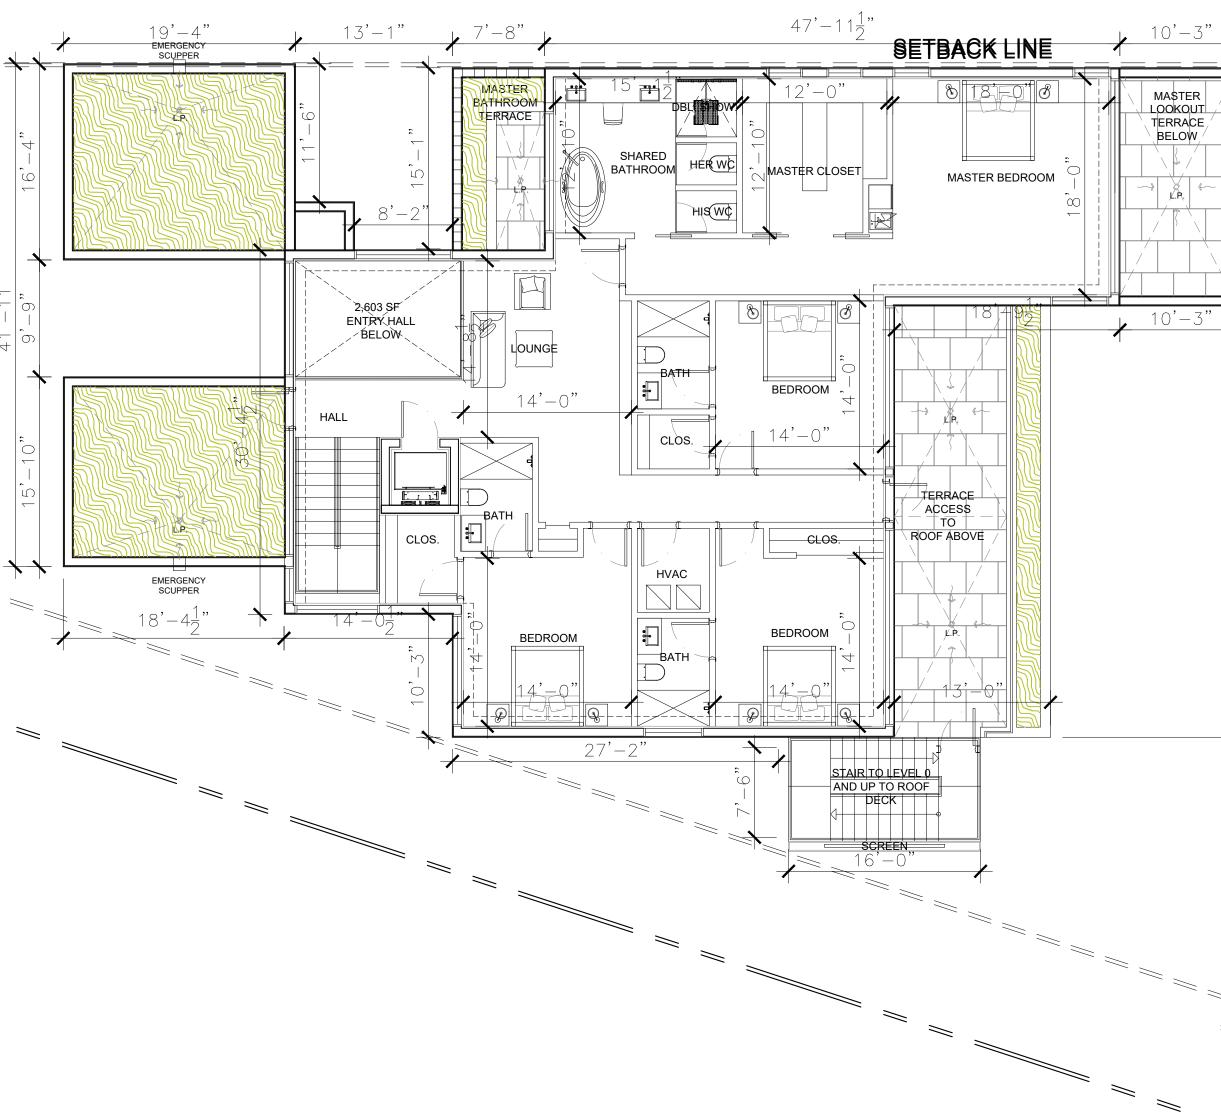Owner: Name Address Address Tel:

Email

OWNER OWNER_ADDRESS1 OWNER_ADDRESS2 OWNER_PHONE OWNER_EMAIL


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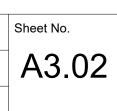





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PROPOSED LEVEL 2

Date	11-15-2021
Scale	
Project	2191



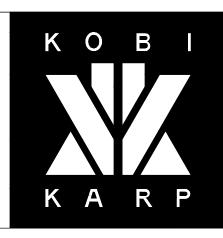

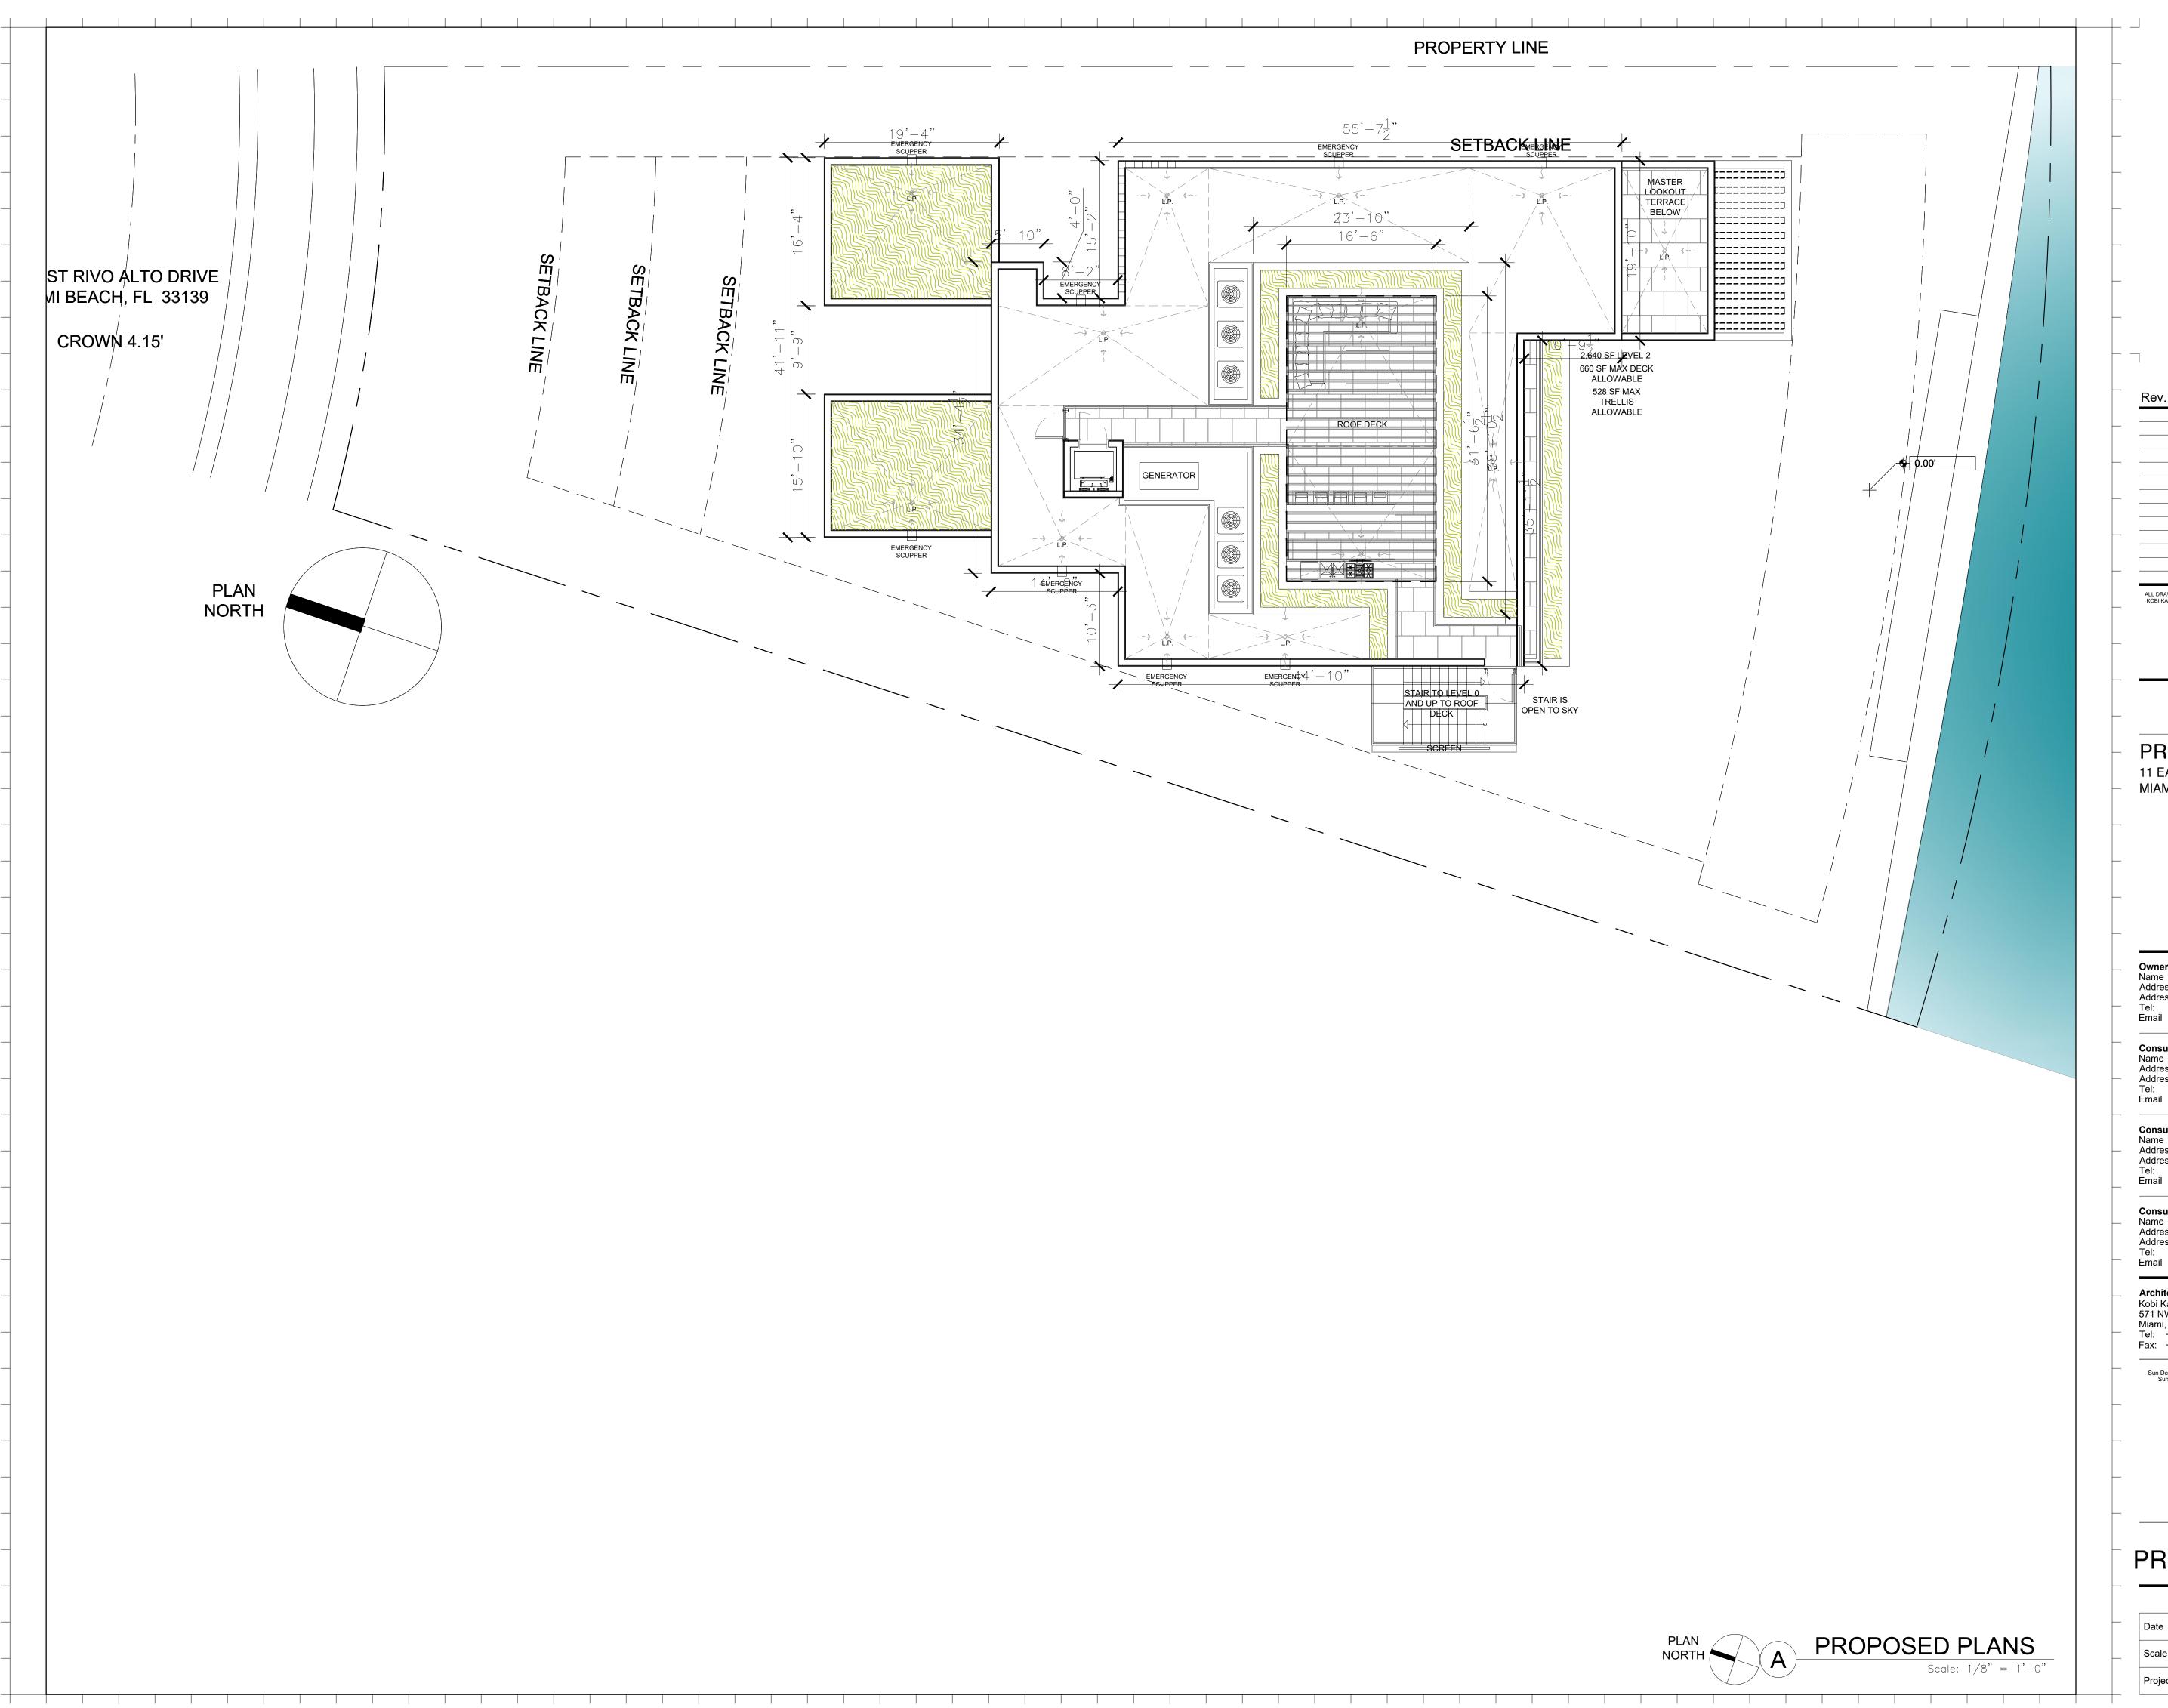Rev.	Date	Rev.	Date
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PRIVATE RESIDENCE 11 EAST RIVO ALTO DRIVE

MIAMI BEACH, FL 33139

Owner: Name Address Address Tel:


OWNER OWNER_ADDRESS1 OWNER_ADDRESS2 OWNER_PHONE OWNER_EMAIL

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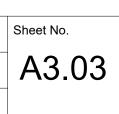






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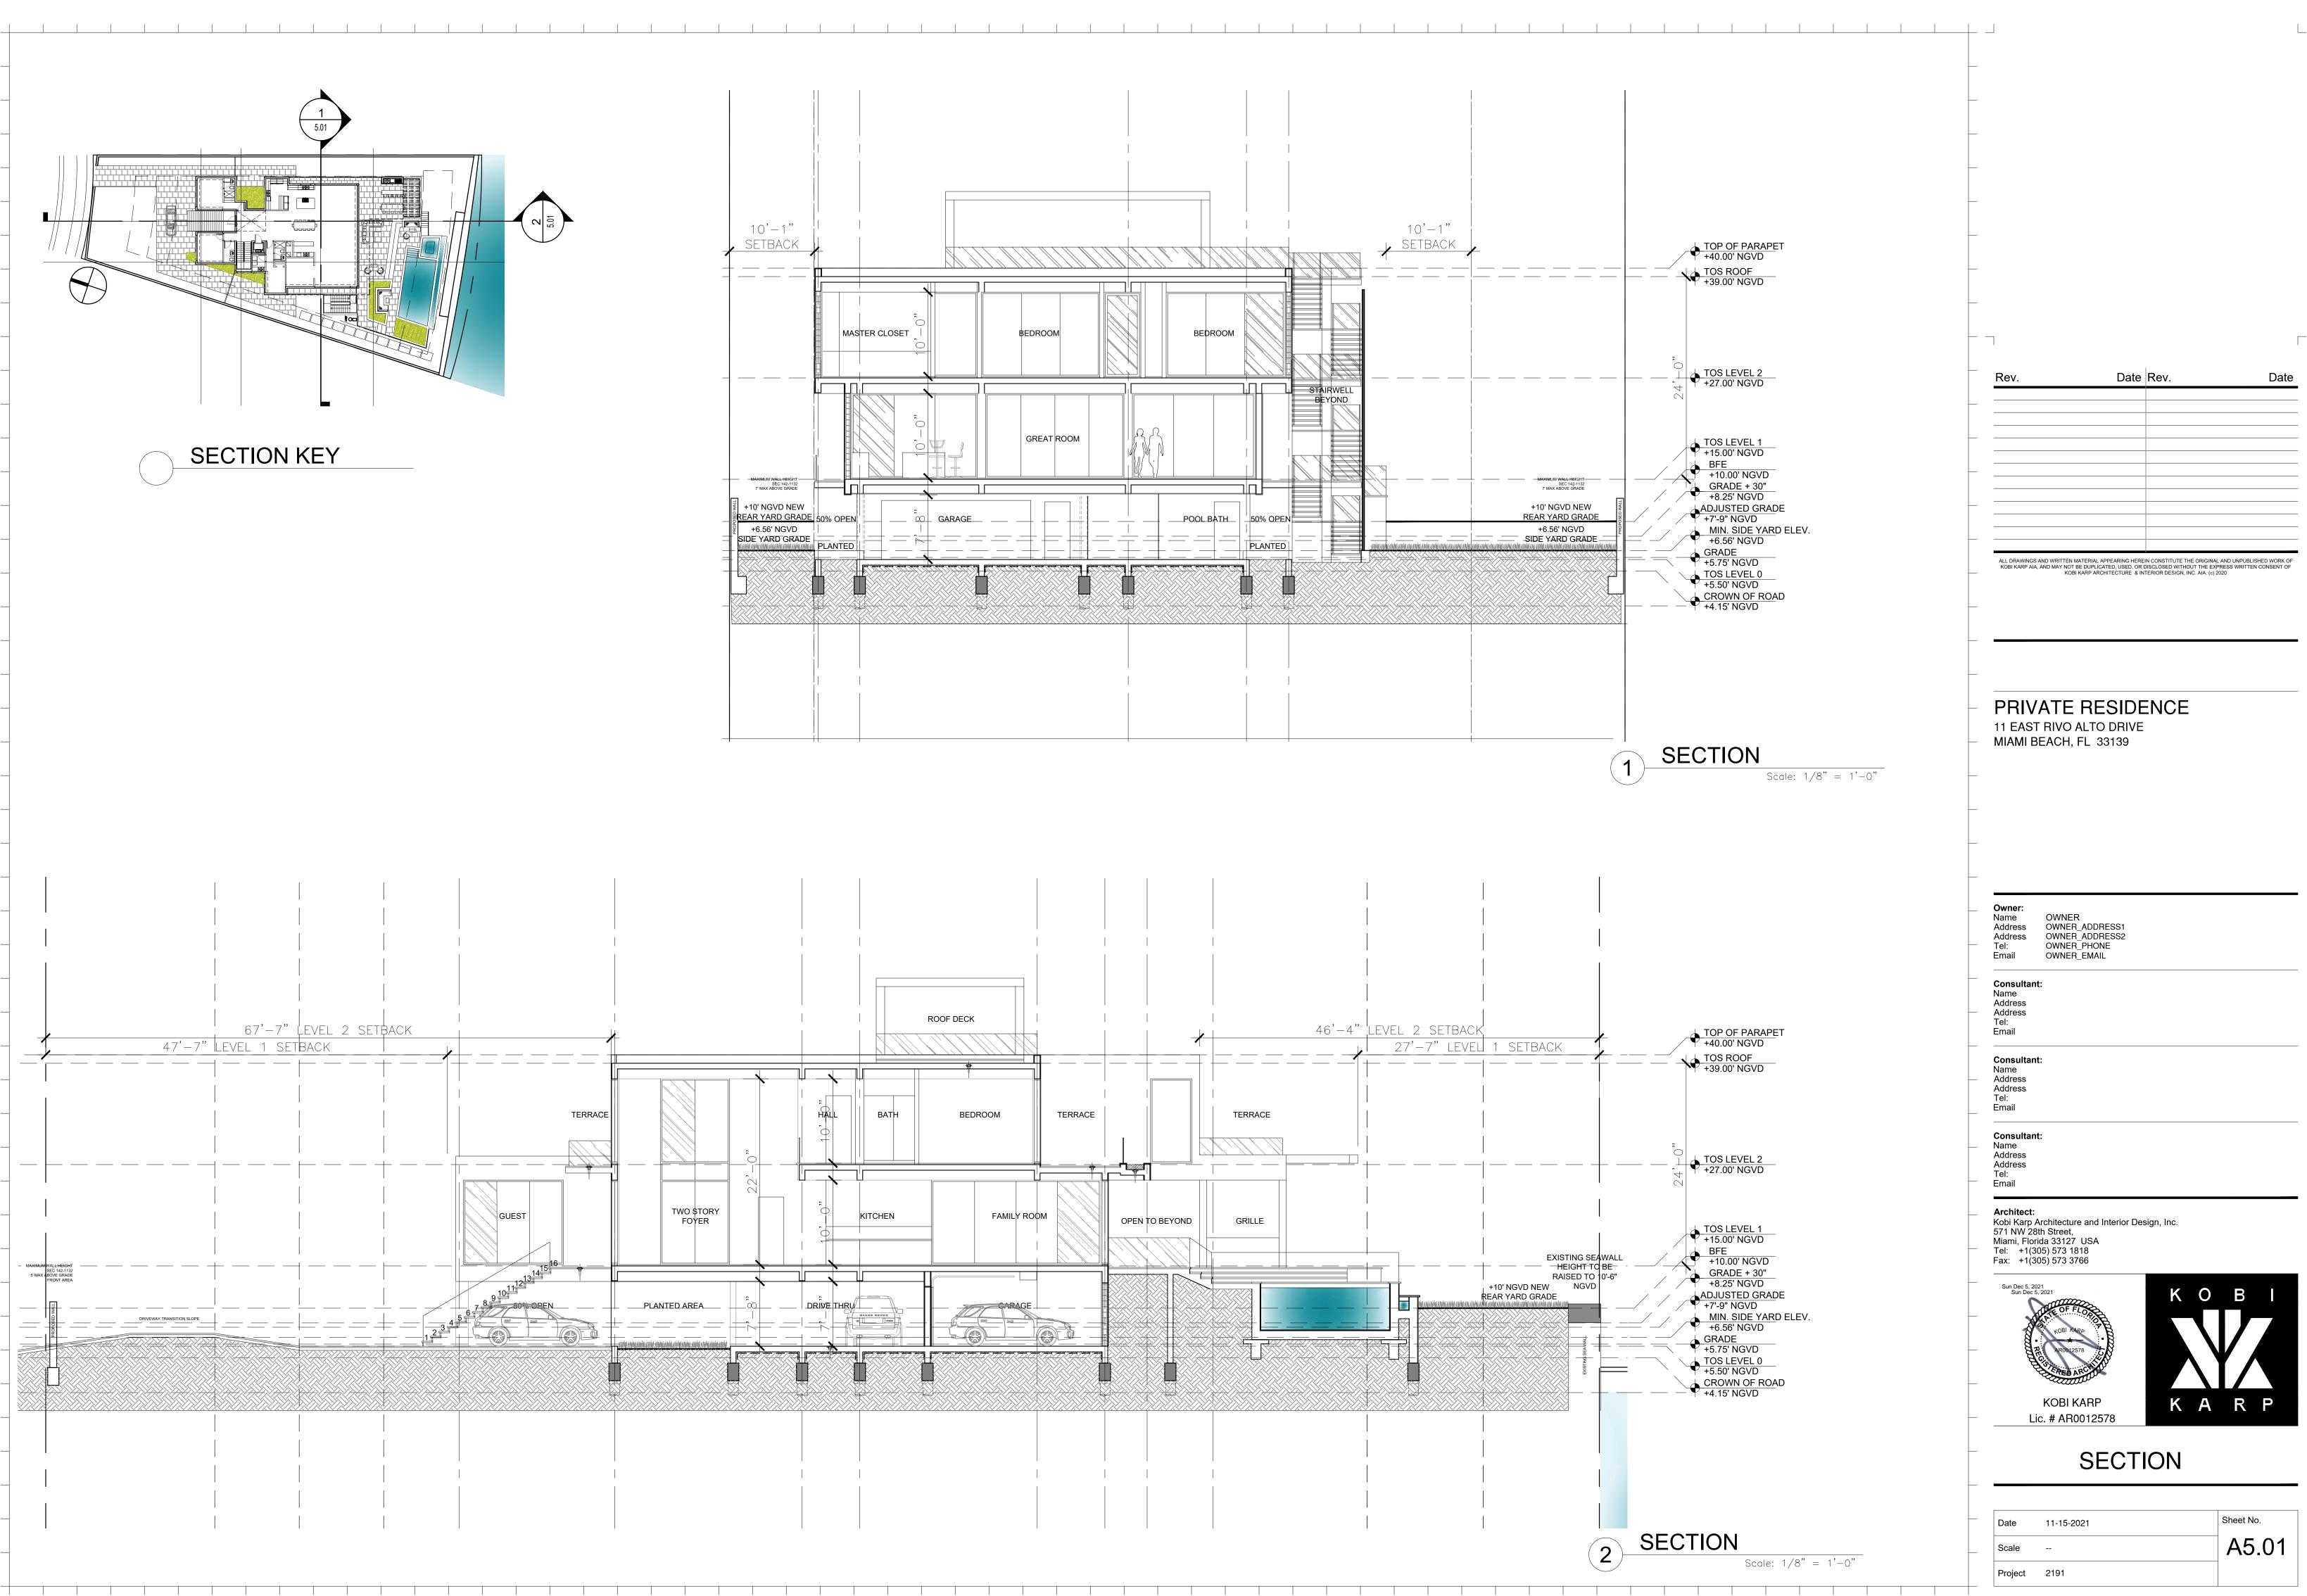
PROPOSED ROOF LEVEL


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MIAMI BEACH, FL 33139

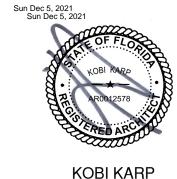Owner: Name Address Address Tel:

Email

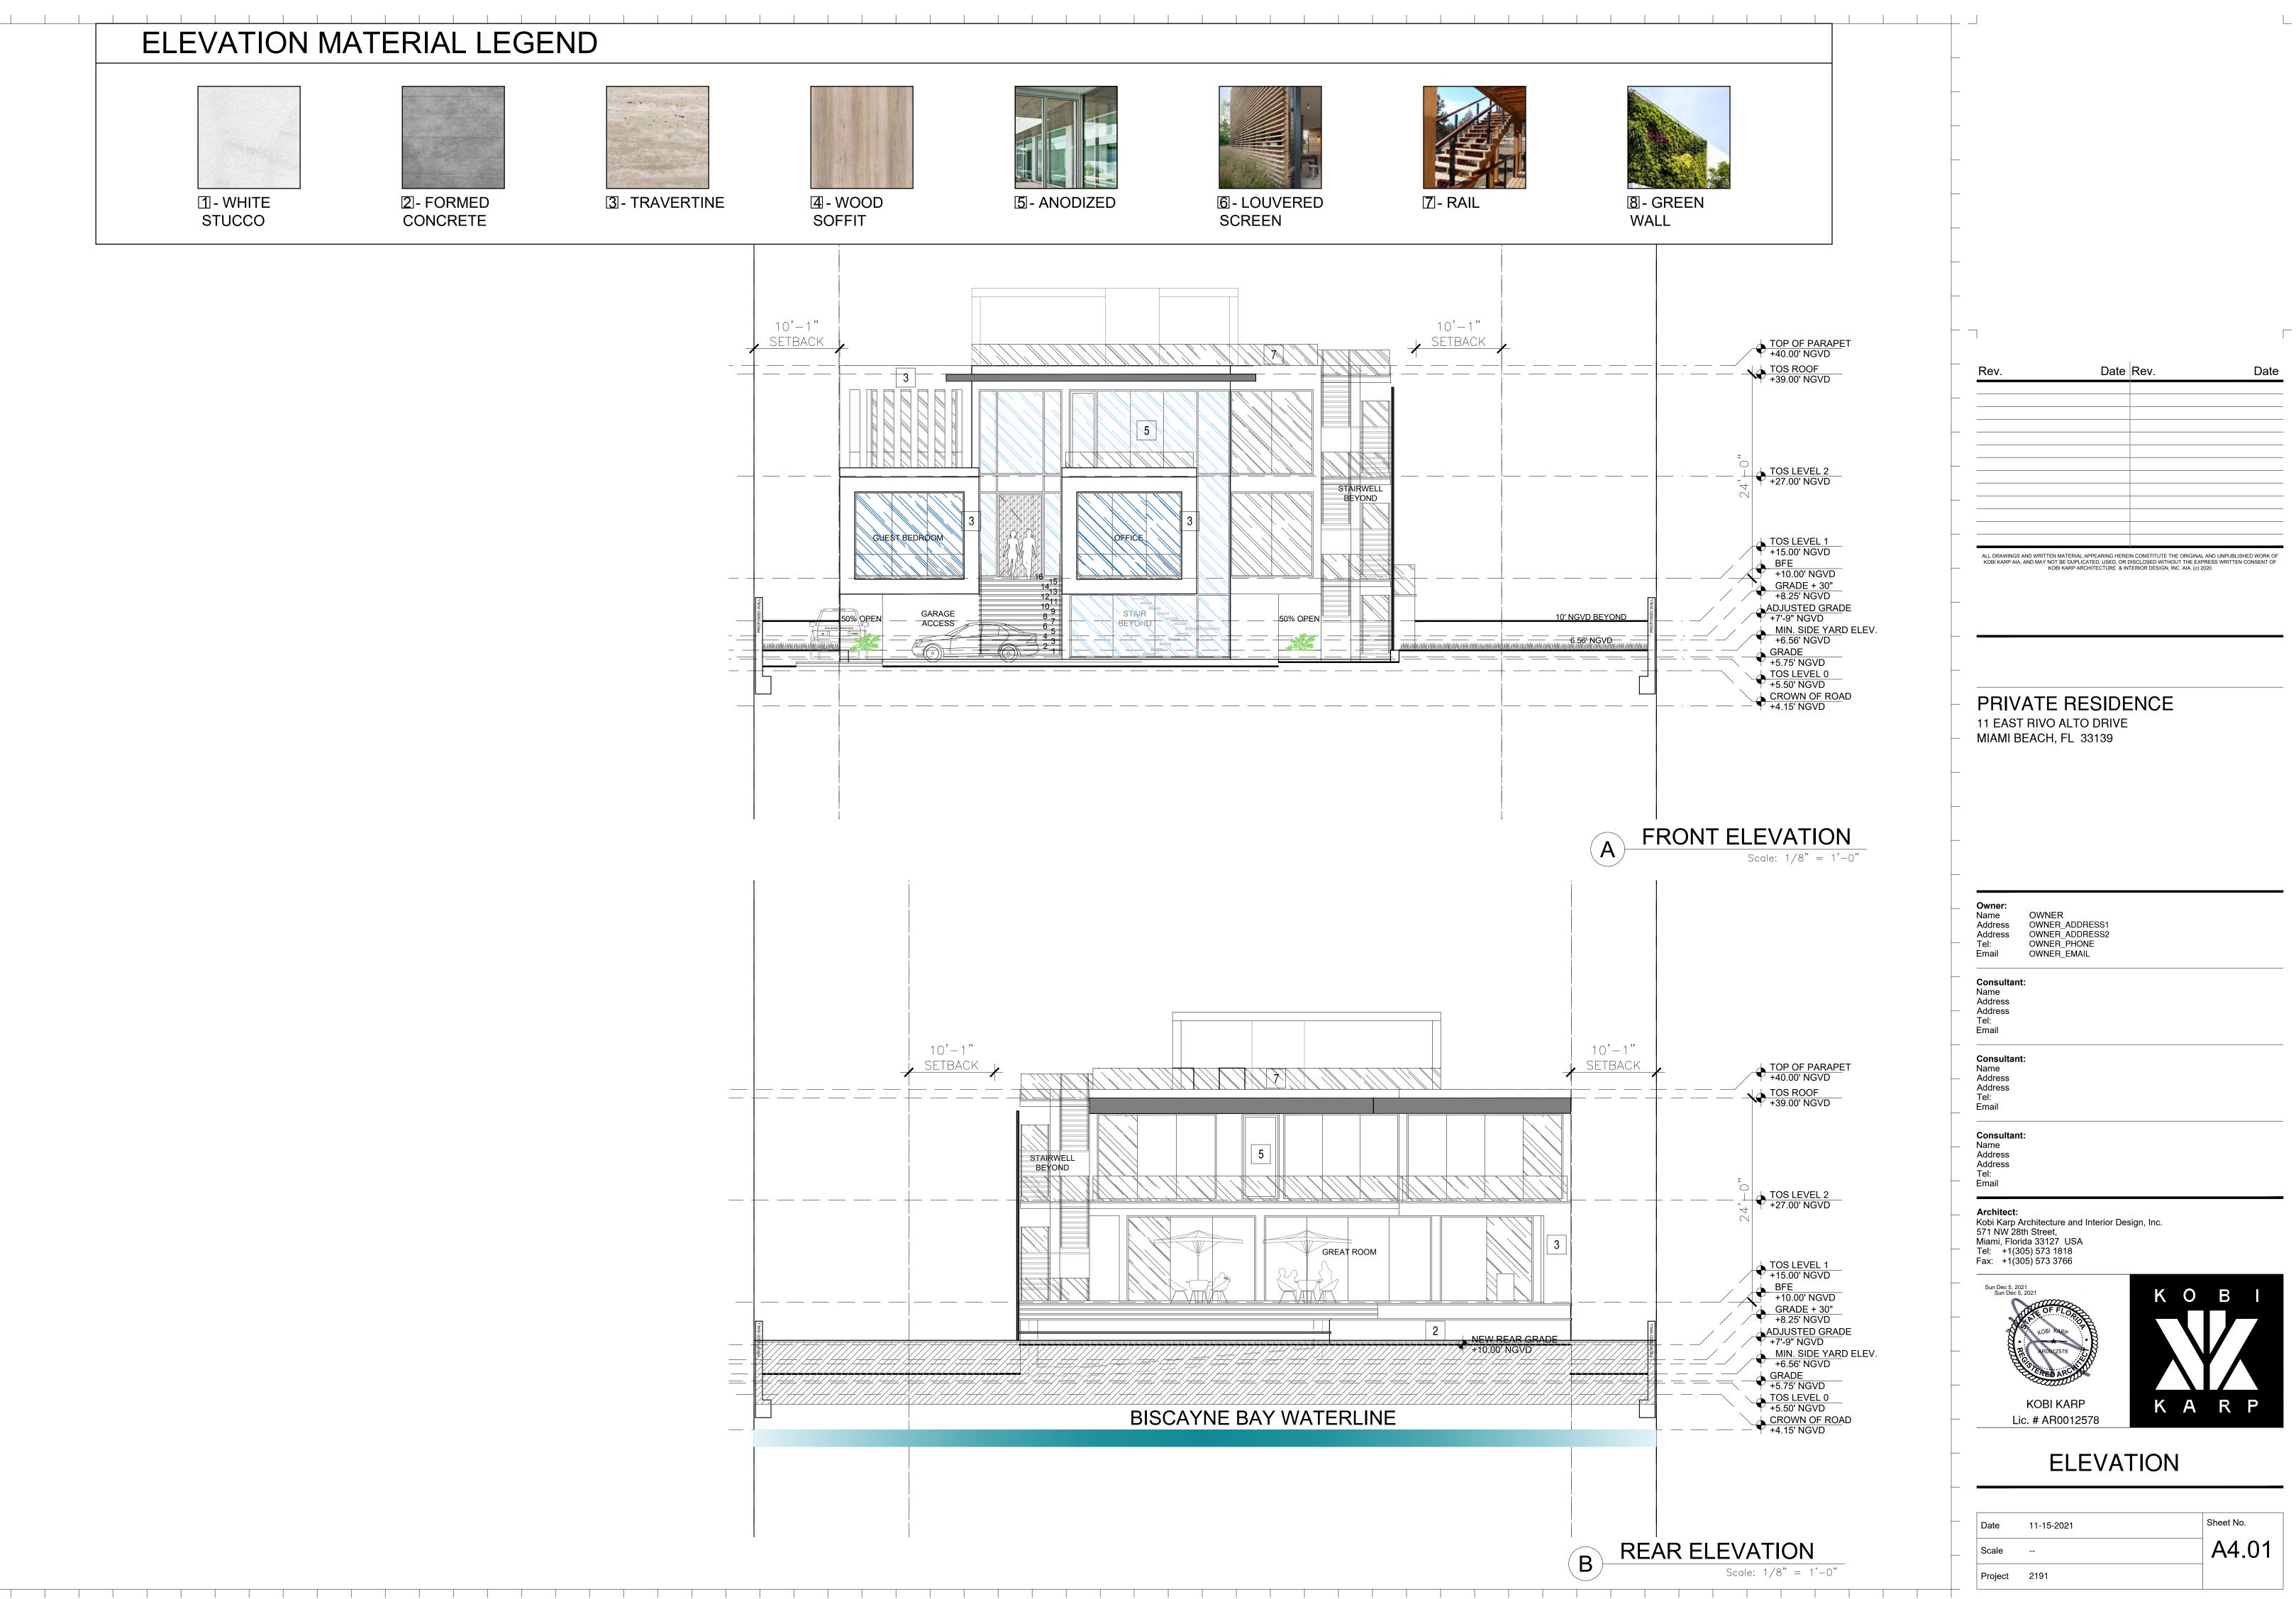
OWNER OWNER_ADDRESS1 OWNER_ADDRESS2 OWNER_PHONE OWNER_EMAIL
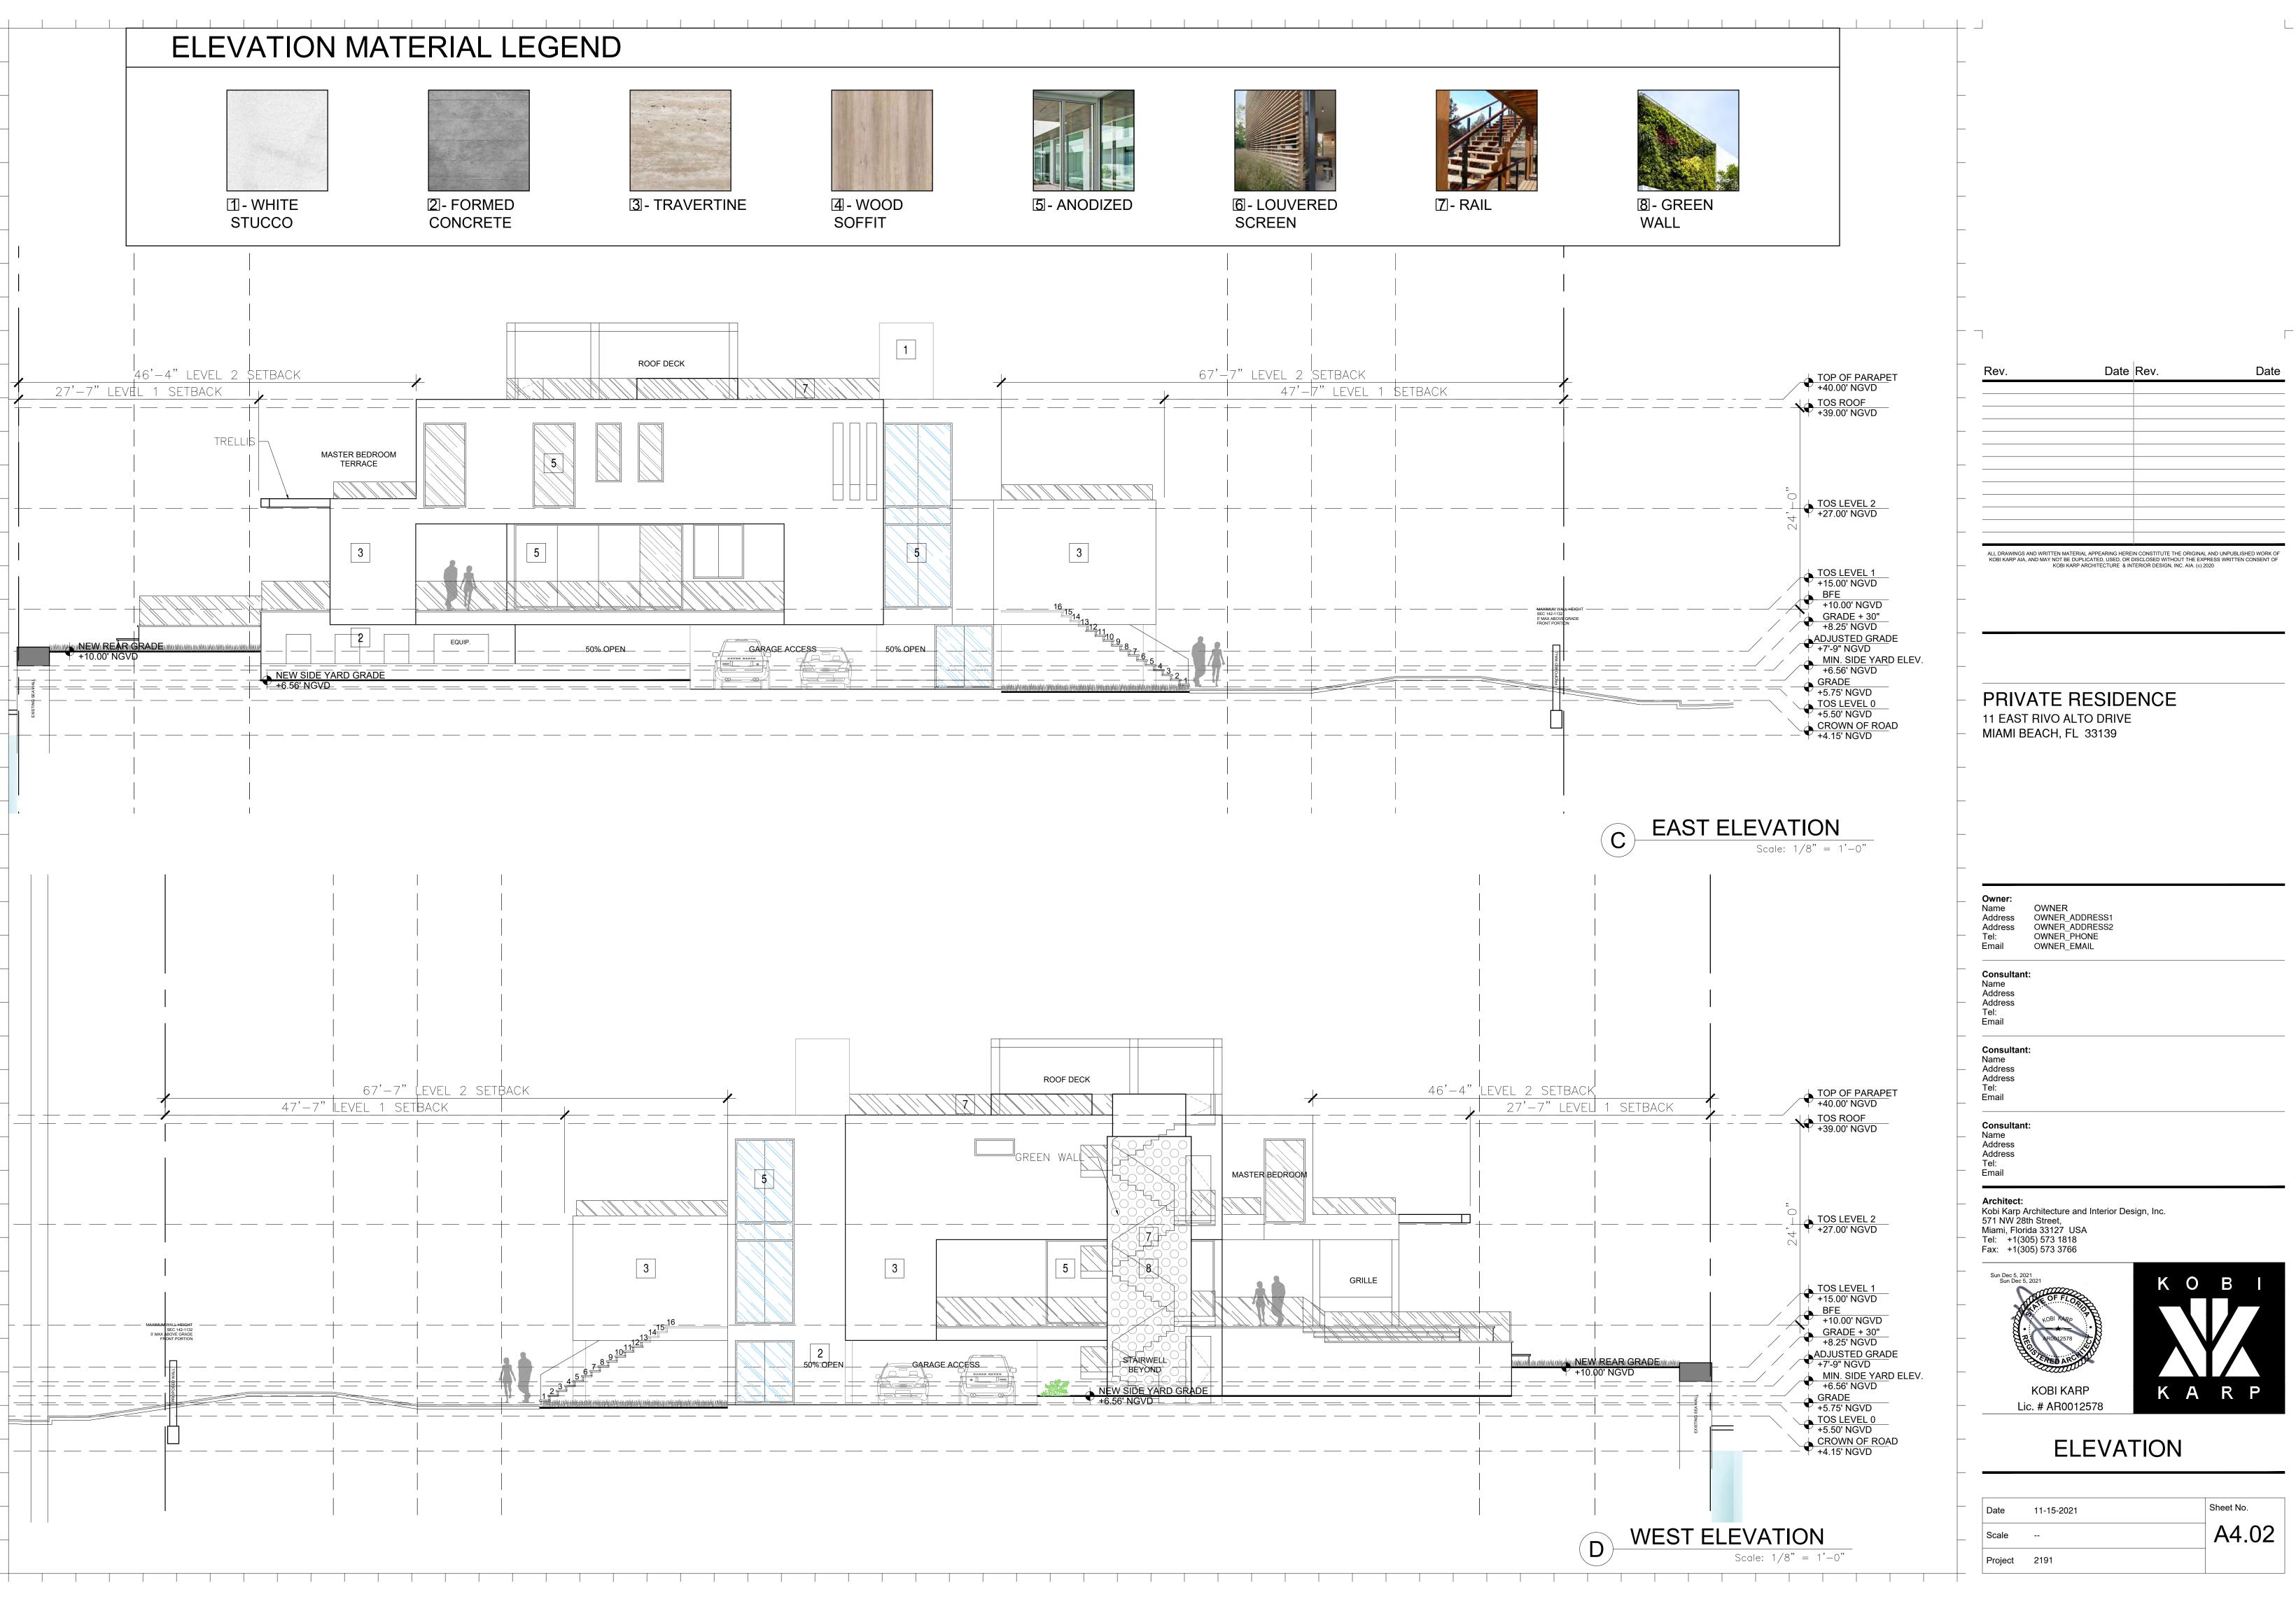
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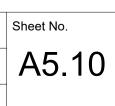


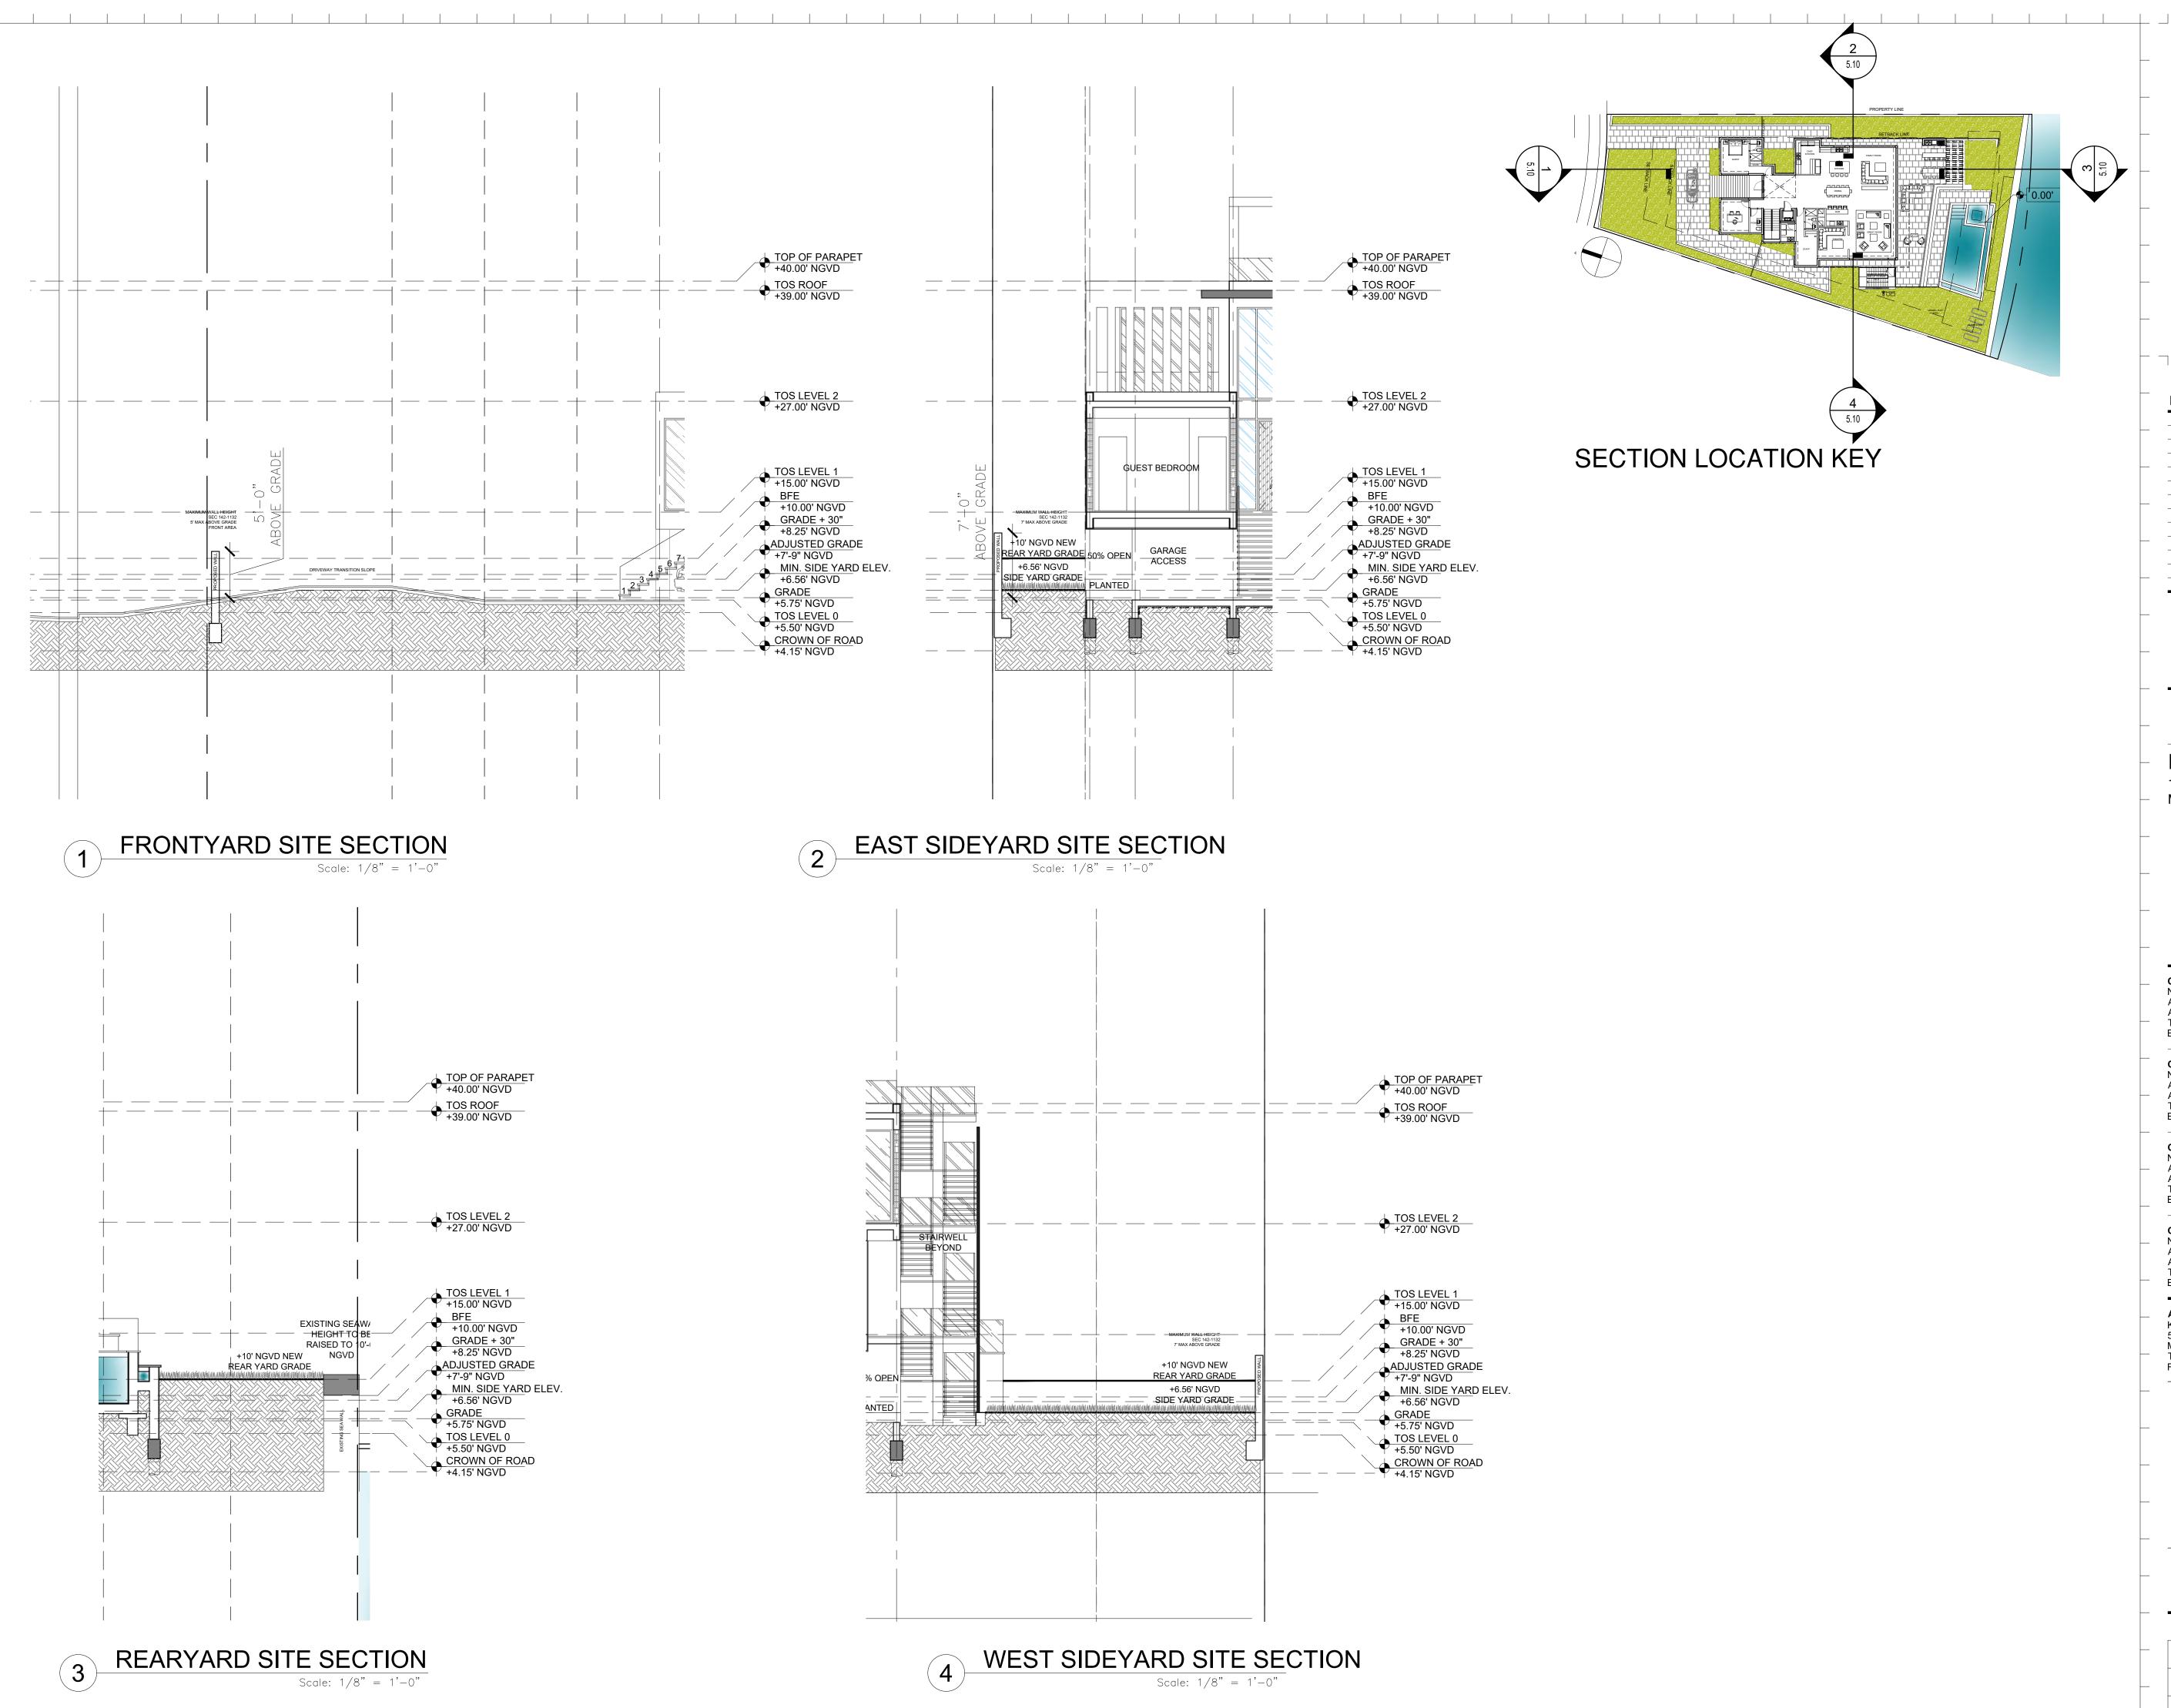
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SECTION

Date 11-15-2021 Scale --Project 2191



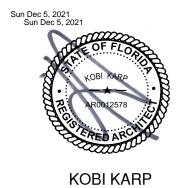

INDEX	
GI-100	COVER & INDEX
LR-100	TREE DISPOSITIO
LR-200	TREE DISPOSITIO
LR-300	TREE DISPOSITIO
LP-100	PLANTING CANO
LP-200	PLANTING UNDE
LP-201	PLANTING UNDE
LP-202	PLANTING UNDE
LP-203	PLANTING UNDE
LP-300	PLANTING SCHE
LP-400	TREE REPLACEM
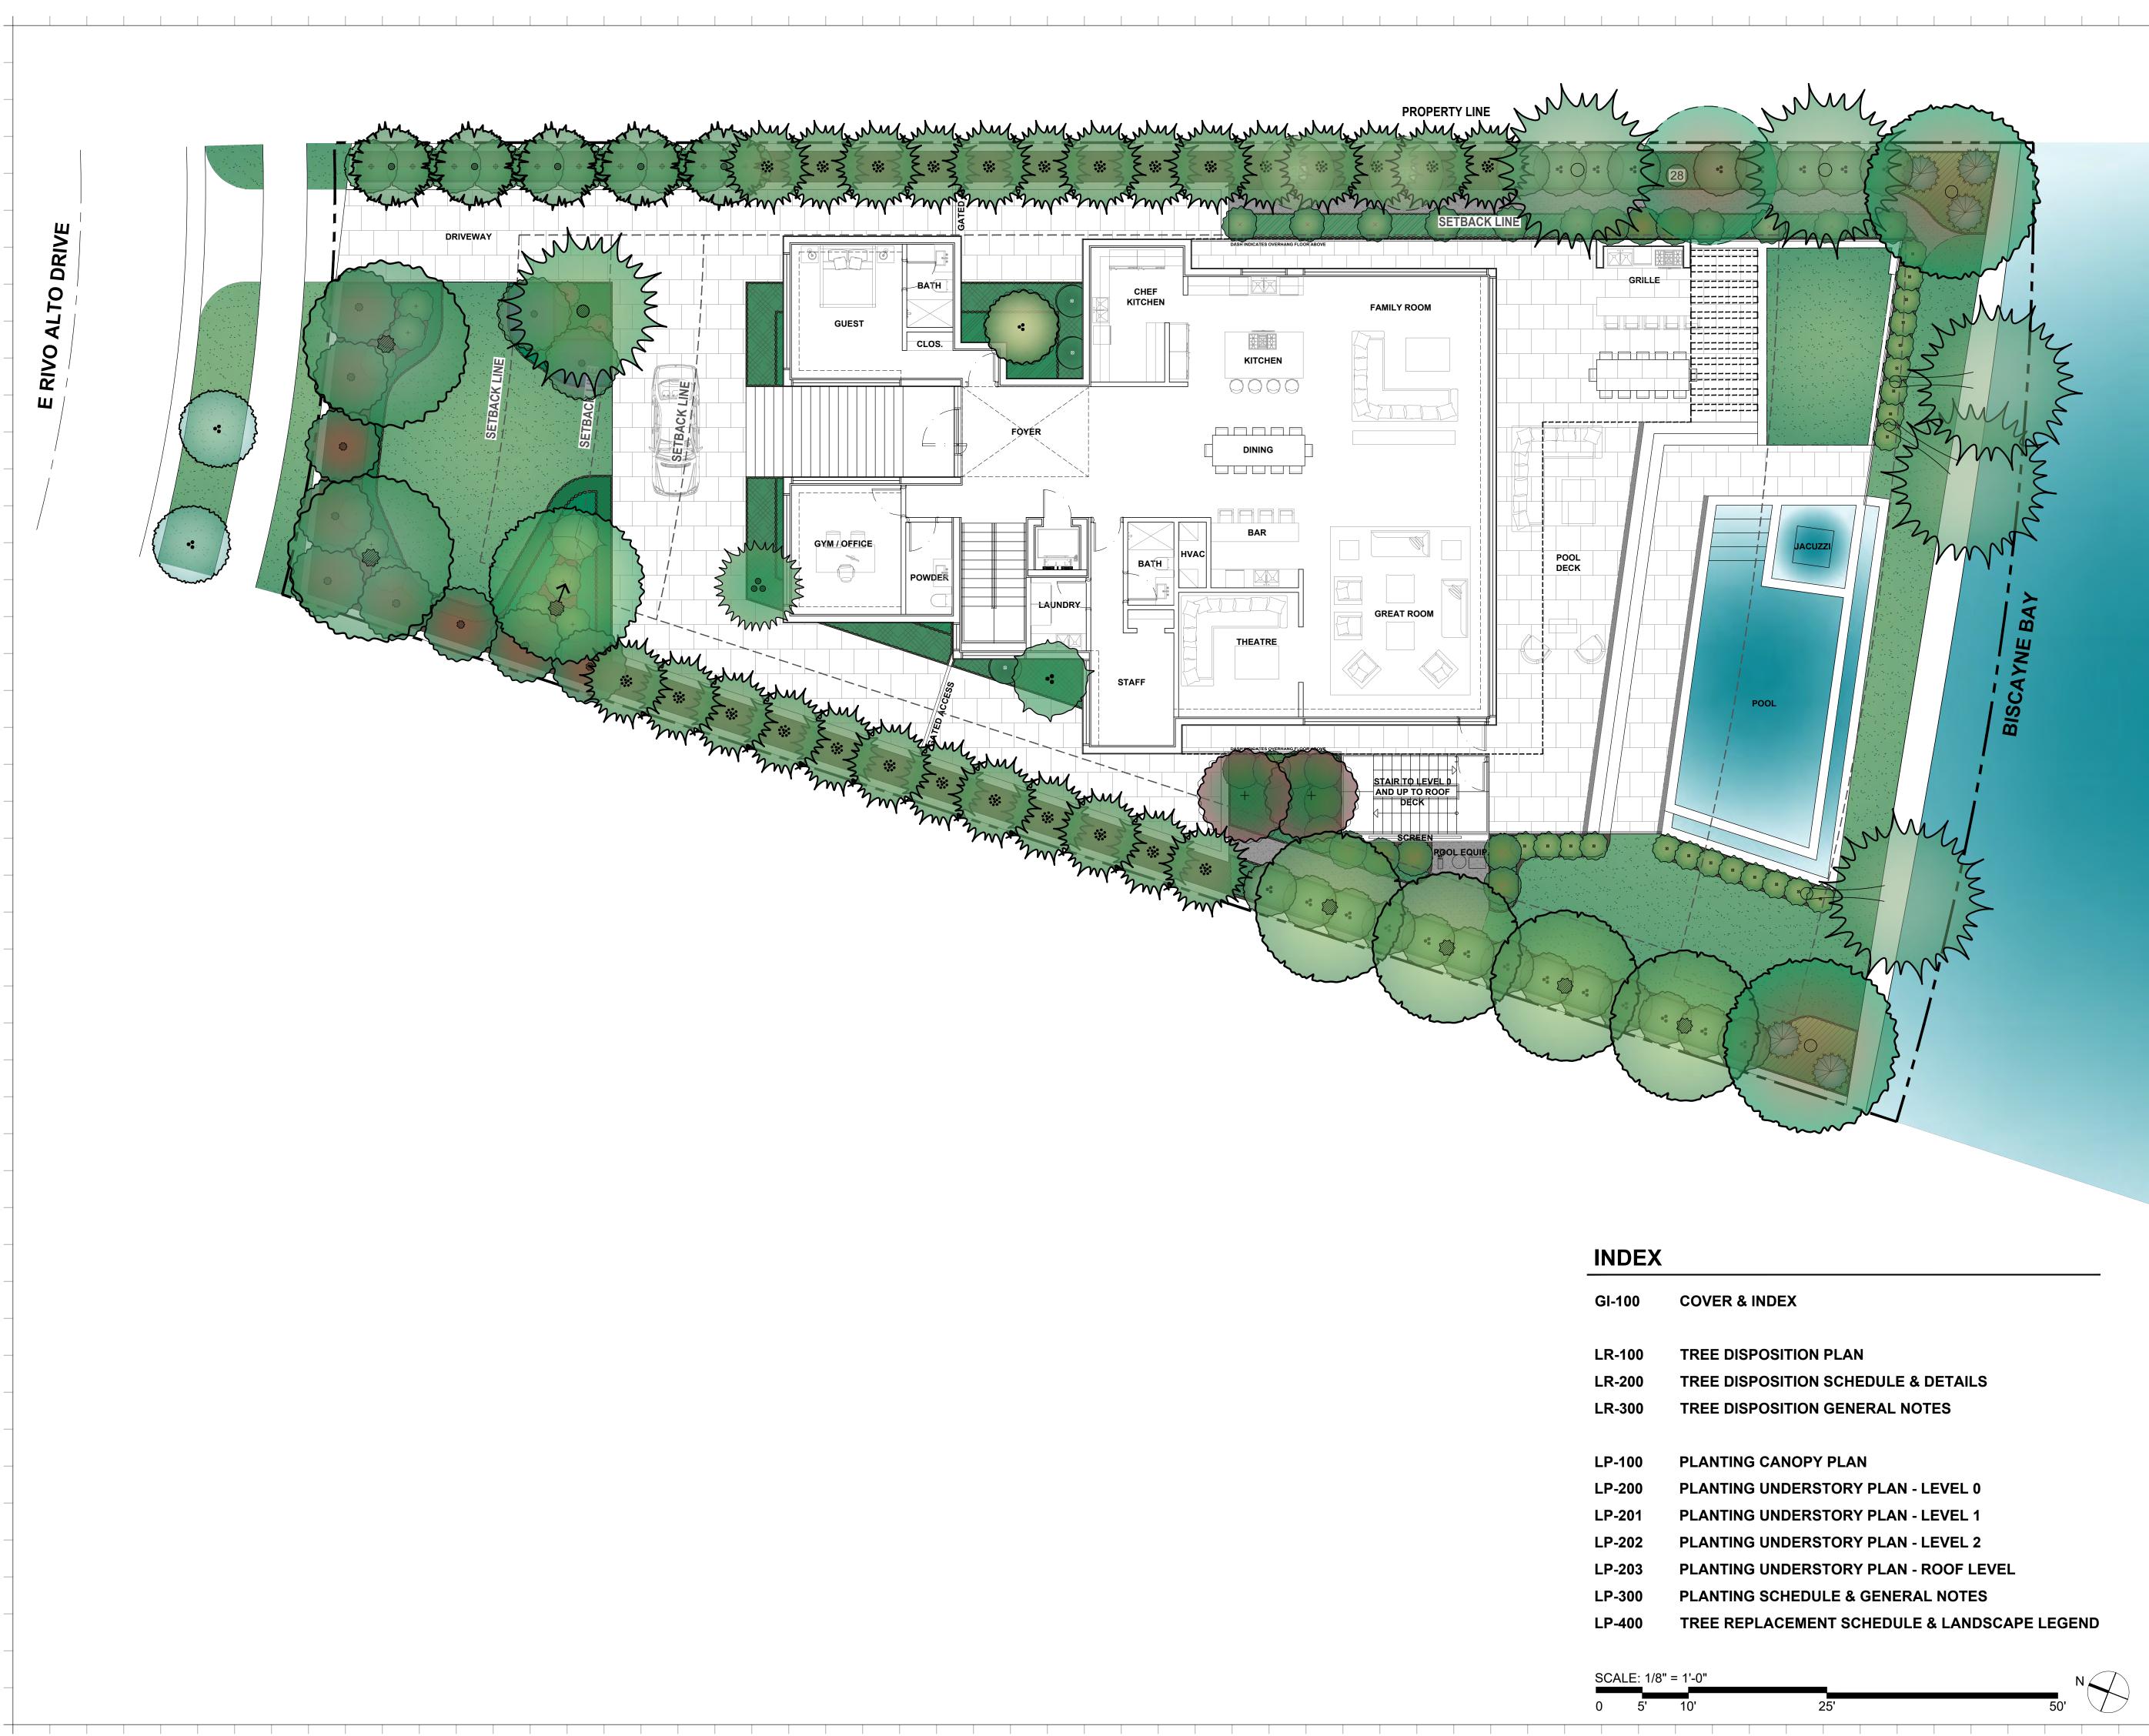
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Owner:


PRIVATE RESIDENCE

Consultant: Name Address Address Tel: Email

Consultant: Name Address Address Tel: Email

Architect of Record: Kobi Karp Architecture and Interior Design, Inc. 2915 Biscayne Boulevard, Suite #200 Miami, Florida 33137 USA Tel: +1(305) 573 1818 Fax: +1(305) 573 3766


Landscape Architect of Record: David O. Design p.o. box 331615 Coconut Grove, FL. 33233-1615, USA Tel: +1(305) 854.9299 - Fax: +1(305) 854.9882 Email: davidodesign@hotmail.com www.davidodishoo.com

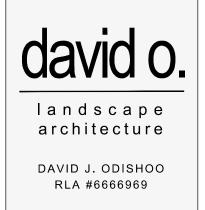

COVER AND INDEX

Date: 12-03-2021 Scale : 1/8"=1'-0" Project # : 21024

Sheet No. GI-100

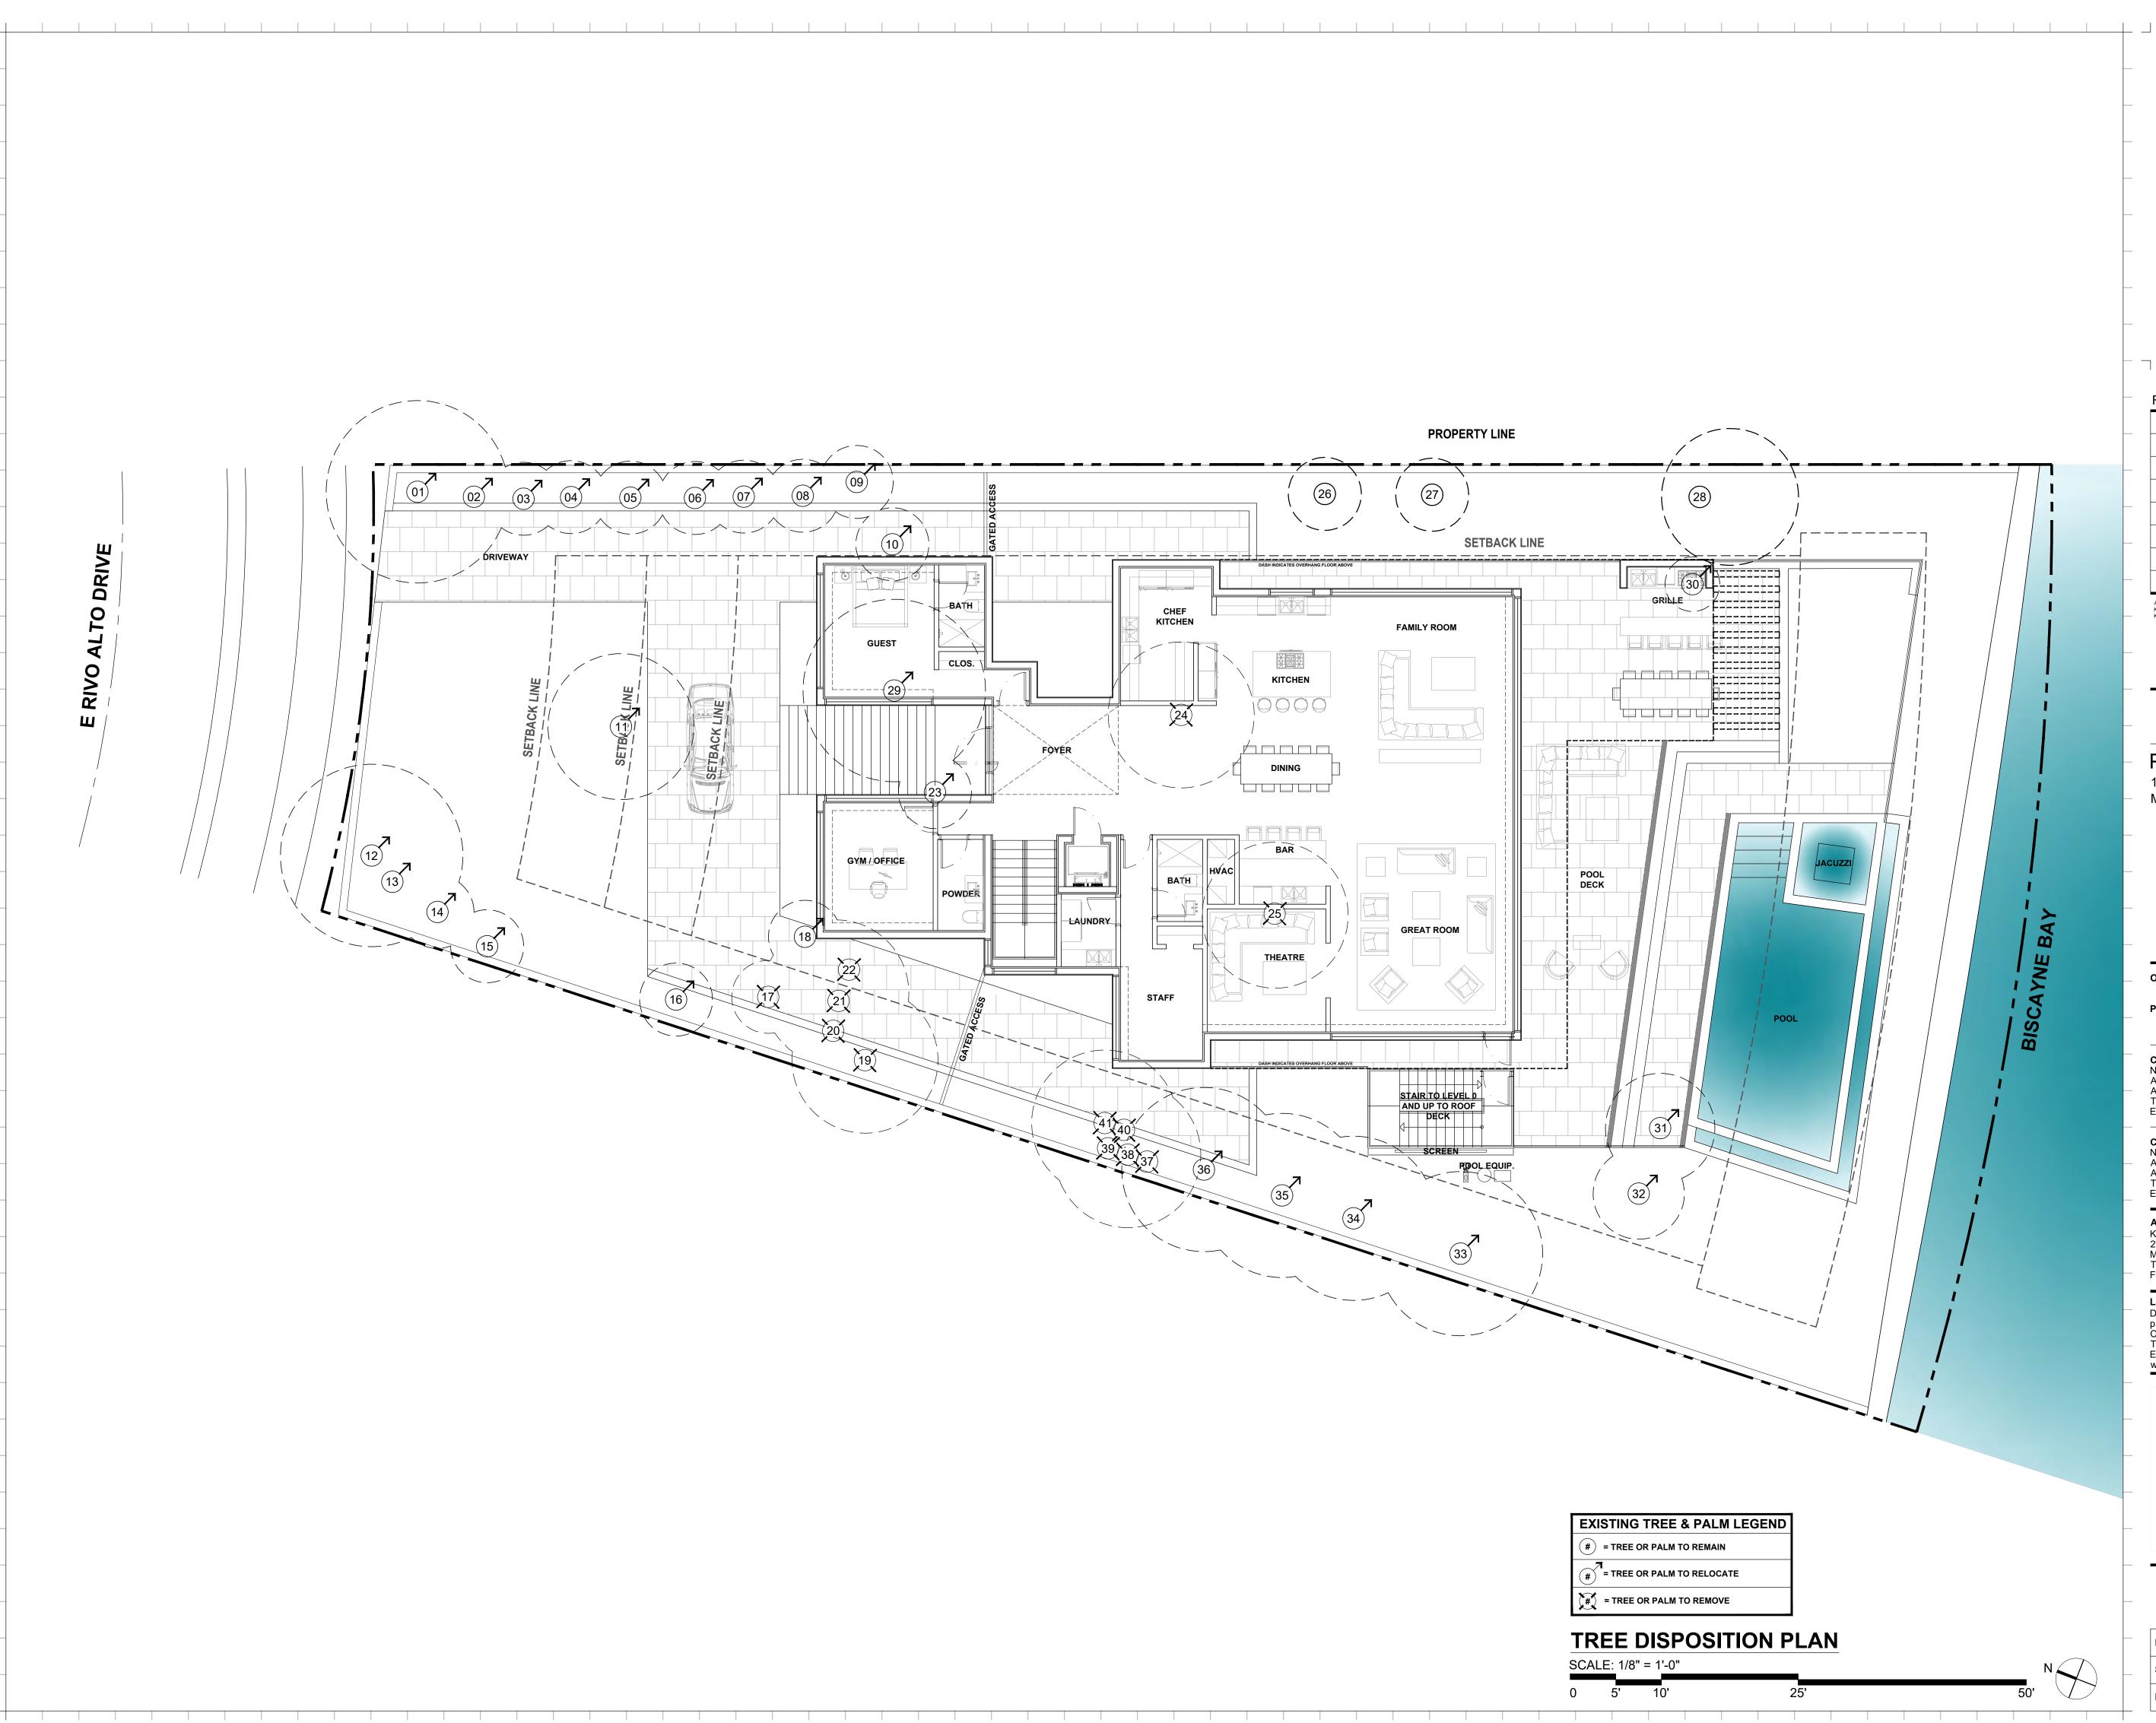

EXIS	TING 1	REE 8	k P/
# =	TREE OF	R PALM TO) RE
#	TREE OF	R PALM TO) REI
(#) =	TREE OF	R PALM TO) REI
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DRB SUBMITTAL

PRIVATE RESIDENCE

11 EAST RIVO ALTO DRIVE MIAMI BEACH, FL 33139

Owner:

PRIVATE RESIDENCE

Consultant: Name Address Address Tel: Email

Consultant: Name Address Address Tel: Email


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Landscape Architect of Record: David O. Design p.o. box 331615 Coconut Grove, FL. 33233-1615, USA Tel: +1(305) 854.9299 - Fax: +1(305) 854.9882 Email: davidodesign@hotmail.com www.davidodishoo.com



TREE DISPOSITION PLAN

Date: 12-03-2021 Scale : 1/8"=1'-0" Project # : 21024

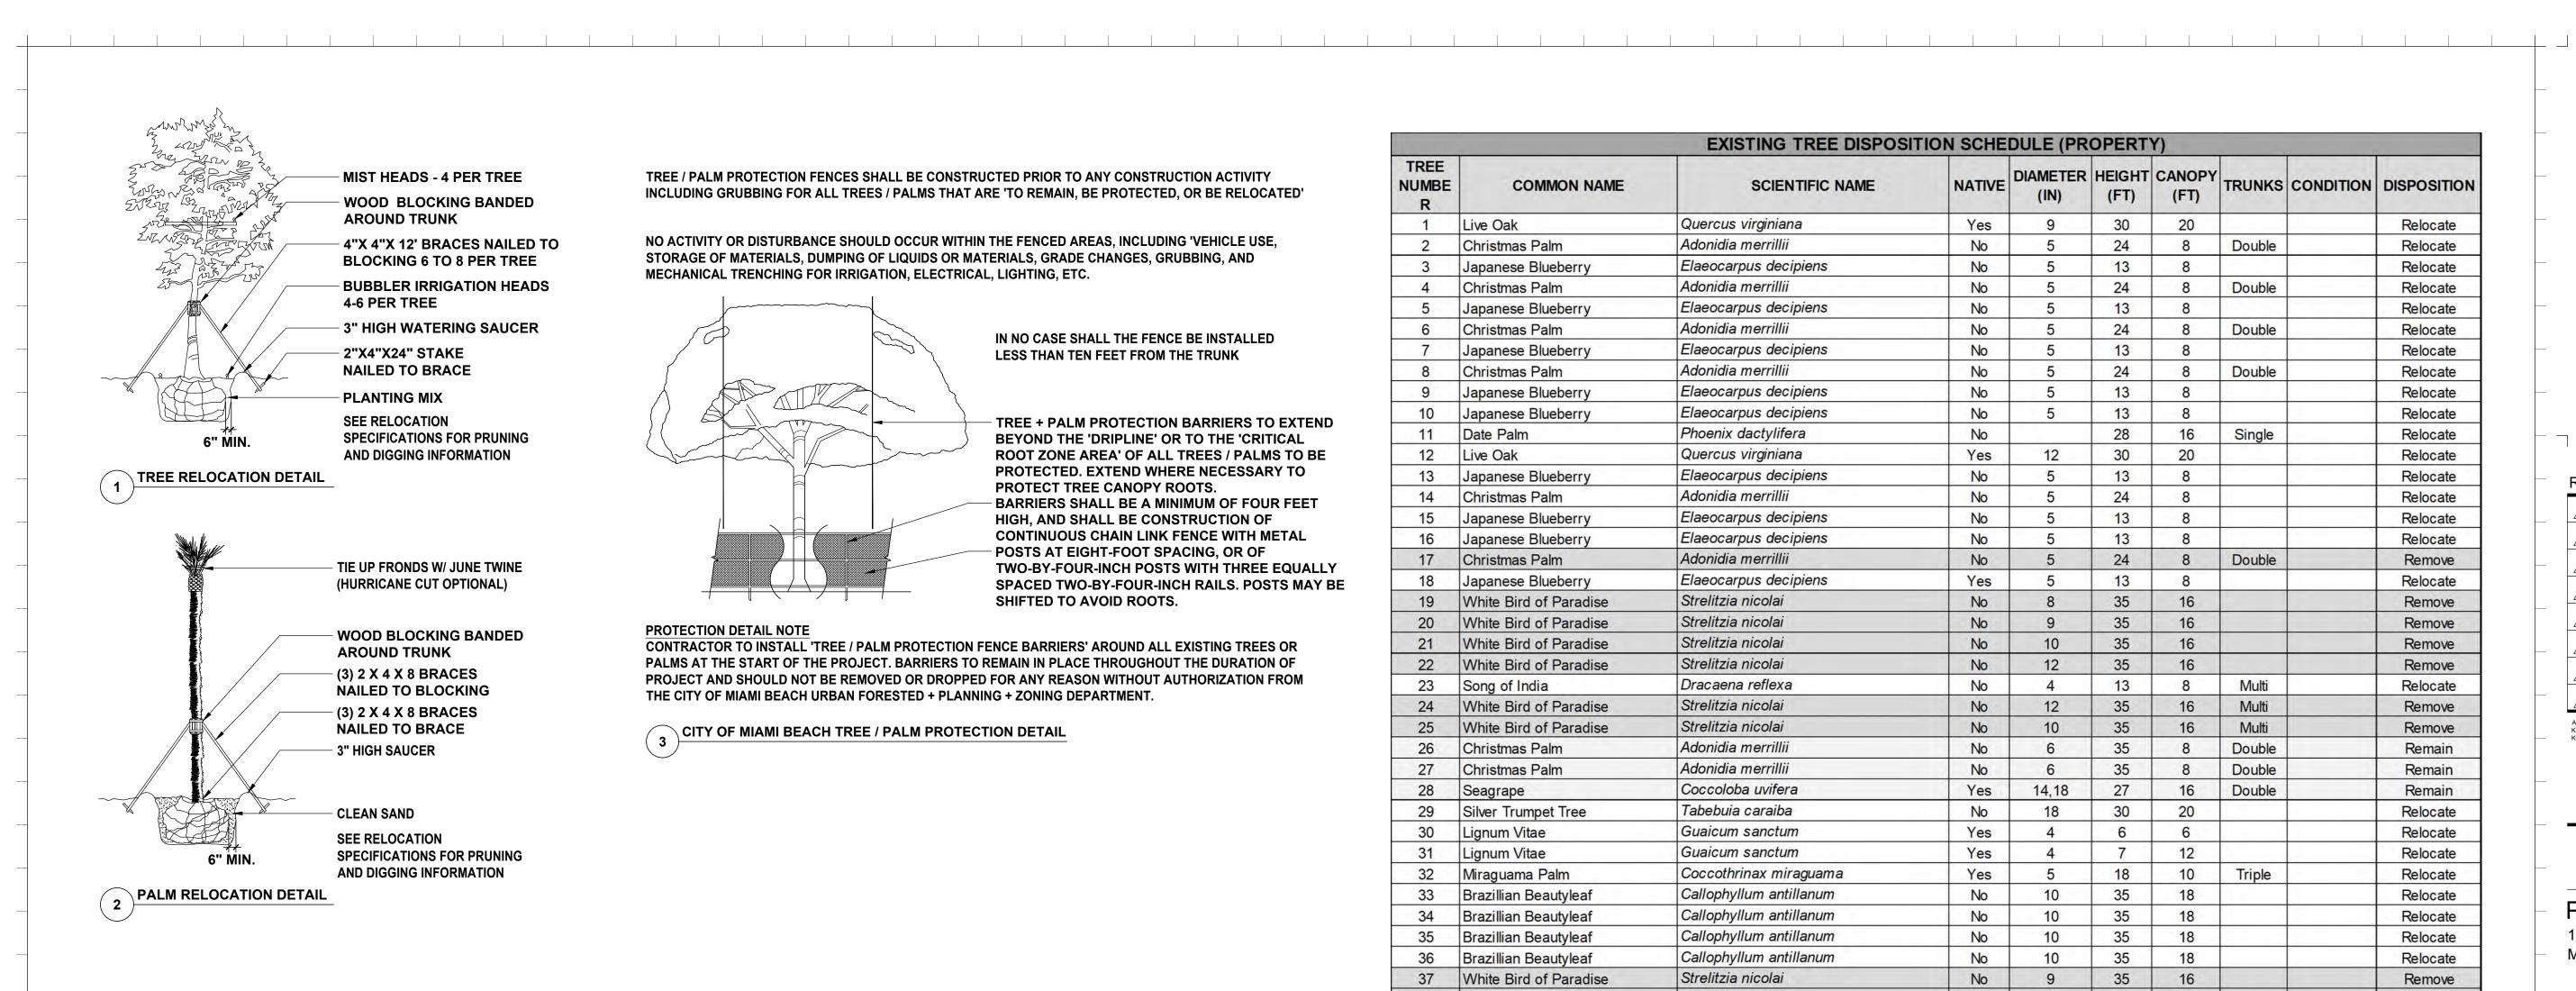

INCLUDING GRUBBING FOR ALL TREES / PALMS THAT ARE 'TO REMAIN, BE PROTECTED, OR BE RELOCATED'

IN NO CASE SHALL THE FENCE BE INSTALLED LESS THAN TEN FEET FROM THE TRUNK

- TREE + PALM PROTECTION BARRIERS TO EXTEND BEYOND THE 'DRIPLINE' OR TO THE 'CRITICAL ROOT ZONE AREA' OF ALL TREES / PALMS TO BE PROTECTED. EXTEND WHERE NECESSARY TO PROTECT TREE CANOPY ROOTS.
- BARRIERS SHALL BE A MINIMUM OF FOUR FEET HIGH, AND SHALL BE CONSTRUCTION OF CONTINUOUS CHAIN LINK FENCE WITH METAL POSTS AT EIGHT-FOOT SPACING, OR OF TWO-BY-FOUR-INCH POSTS WITH THREE EQUALLY SPACED TWO-BY-FOUR-INCH RAILS. POSTS MAY BE

CONTRACTOR TO INSTALL 'TREE / PALM PROTECTION FENCE BARRIERS' AROUND ALL EXISTING TREES OR PALMS AT THE START OF THE PROJECT. BARRIERS TO REMAIN IN PLACE THROUGHOUT THE DURATION OF PROJECT AND SHOULD NOT BE REMOVED OR DROPPED FOR ANY REASON WITHOUT AUTHORIZATION FROM

SHIFTED TO AVOID ROOTS.

	EXISTING TREE DISPOSITION SCHEDULE (PROPERTY)								
TREE NUMBE R	COMMON NAME	SCIENTIFIC NAME	NATIVE	DIAMETER (IN)	HEIGHT (FT)	CANOPY (FT)	TRUNKS	CONDITION	DISPOSITION
1	Live Oak	Quercus virginiana	Yes	9	30	20			Relocate
2	Christmas Palm	Adonidia merrillii	No	5	24	8	Double		Relocate
3	Japanese Blueberry	Elaeocarpus decipiens	No	5	13	8			Relocate
4	Christmas Palm	Adonidia merrillii	No	5	24	8	Double		Relocate
5	Japanese Blueberry	Elaeocarpus decipiens	No	5	13	8			Relocate
6	Christmas Palm	Adonidia merrillii	No	5	24	8	Double		Relocate
7	Japanese Blueberry	Elaeocarpus decipiens	No	5	13	8			Relocate
8	Christmas Palm	Adonidia merrillii	No	5	24	8	Double		Relocate
9	Japanese Blueberry	Elaeocarpus decipiens	No	5	13	8			Relocate
10	Japanese Blueberry	Elaeocarpus decipiens	No	5	13	8			Relocate
11	Date Palm	Phoenix dactylifera	No		28	16	Single	-	Relocate
12	Live Oak	Quercus virginiana	Yes	12	30	20			Relocate
13	Japanese Blueberry	Elaeocarpus decipiens	No	5	13	8		3	Relocate
14	Christmas Palm	Adonidia merrillii	No	5	24	8		1	Relocate
15	Japanese Blueberry	Elaeocarpus decipiens	No	5	13	8			Relocate
16	Japanese Blueberry	Elaeocarpus decipiens	No	5	13	8			Relocate
17	Christmas Palm	Adonidia merrillii	No	5	24	8	Double		Remove
18	Japanese Blueberry	Elaeocarpus decipiens	Yes	5	13	8			Relocate
19	White Bird of Paradise	Strelitzia nicolai	No	8	35	16			Remove
20	White Bird of Paradise	Strelitzia nicolai	No	9	35	16			Remove
21	White Bird of Paradise	Strelitzia nicolai	No	10	35	16			Remove
22	White Bird of Paradise	Strelitzia nicolai	No	12	35	16	-		Remove
23	Song of India	Dracaena reflexa	No	4	13	8	Multi	· · · · · · · · · · · · · · · · · · ·	Relocate
24	White Bird of Paradise	Strelitzia nicolai	No	12	35	16	Multi		Remove
25	White Bird of Paradise	Strelitzia nicolai	No	10	35	16	Multi		Remove
26	Christmas Palm	Adonidia merrillii	No	6	35	8	Double	-	Remain
27	Christmas Palm	Adonidia merrillii	No	6	35	8	Double	1	Remain
28	Seagrape	Coccoloba uvifera	Yes	14,18	27	16	Double		Remain
29	Silver Trumpet Tree	Tabebuia caraiba	No	18	30	20			Relocate
30	Lignum Vitae	Guaicum sanctum	Yes	4	6	6		1	Relocate
31	Lignum Vitae	Guaicum sanctum	Yes	4	7	12			Relocate
32	Miraguama Palm	Coccothrinax miraguama	Yes	5	18	10	Triple	1	Relocate
33	Brazillian Beautyleaf	Callophyllum antillanum	No	10	35	18			Relocate
34	Brazillian Beautyleaf	Callophyllum antillanum	No	10	35	18			Relocate
35	Brazillian Beautyleaf	Callophyllum antillanum	No	10	35	18			Relocate
36	Brazillian Beautyleaf	Callophyllum antillanum	No	10	35	18			Relocate
37	White Bird of Paradise	Strelitzia nicolai	No	9	35	16			Remove
38	White Bird of Paradise	Strelitzia nicolai	No	12	35	16			Remove
39	White Bird of Paradise	Strelitzia nicolai	No	10	35	16			Remove
40	White Bird of Paradise	Strelitzia nicolai	No	9	35	16			Remove
41	White Bird of Paradise	Strelitzia nicolai	No	10	35	16			Remove

	TREE DISPOSITION SUMMARY							
REMAIN RELOCATE REMOVE TOTAL TREES TOTAL PALMS TOTAL O						TOTAL OTHER		
TREES	1	18	0	19				
PALMS	2	8	1		11			
OTHER*	0	0	11			11		
*White Bird of Paradise								

Rev.	Date	Rev.	Date
		9	
		10	
3		11	
4		12	
5		14	
6		15	
$\boxed{7}$		16	
8		$1\overline{1}$	

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DRB SUBMITTAL

PRIVATE RESIDENCE 11 EAST RIVO ALTO DRIVE

MIAMI BEACH, FL 33139

Owner:

PRIVATE RESIDENCE

Consultant: Name Address Address Tel: Email

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DAVID J. ODISHOO RLA #6666969

TREE DISPOSITION SCHEDULE & TREE PROTECTION DETAILS

Date: 12-03-2021

Sheet No.

LR-200

Project # : 21024

Scale :

TREE / PALM PROTECTION NOTES	

1. CONTRACTOR QUALIFICATIONS

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1.1.	CONTRACTOR MUST BE A LICENSED LANDSCAPE CONTRACTOR.
1.2.	CONTRACTOR MUST HAVE A MINIMUM OF 10 YEARS OF PROVEN EXPERIENCE RELOCATING LARGE
	SPECIMEN TREES AND PALMS IN SOUTH FLORIDA.
1.3.	CONTRACTOR MUST HAVE PROVEN EXPERIENCE RELOCATING TREES AND PALMS OF THE SAME
	SPECIES AND SIZE AS THOSE TO BE RELOCATED FOR THE CURRENT PROJECT.
1.4.	CONTRACTOR MUST HAVE A CERTIFIED ARBORIST ON STAFF.

2. CONTRACTOR REQUIREMENTS

- 2.1. CONTRACTOR MUST VISIT THE JOBSITE AND INSPECT ALL TREES AND PALMS TO BE RELOCATED AS WELL AS EXISTING SITE CONDITIONS AND RESTRICTIONS PRIOR TO PREPARING BID. 2.2. CONTRACTOR MUST VERIFY AND ENSURE THAT ALL TREES AND PALMS IDENTIFIED ON THE PLANS AND THOSE TAGGED ON THE JOBSITE CORRESPOND AS TO NUMBER AND DESCRIPTION. ANY
- DISCREPANCIES MUST BE BROUGHT TO THE ATTENTION OF THE LANDSCAPE ARCHITECT IMMEDIATELY, PRIOR TO PREPARING BID. 2.3. CONTRACTOR MUST CONDUCT ALL WORK ASSOCIATED WITH RELOCATION AND MAINTENANCE OF TREES AND PALMS TO BE RELOCATED. NO WORK IS TO BE SUBCONTRACTED WITHOUT PRIOR
- WRITTEN CONSENT OF THE OWNER AND/OR LANDSCAPE ARCHITECT. 2.4. CONTRACTOR MUST DESIGNATE A COMPETENT, SUPERVISOR OR FOREMAN TO OVERSEE AND DIRECT ALL RELOCATION AND MAINTENANCE ACTIVITIES AS OUTLINED IN THESE SPECIFICATIONS
- 2.5. CONTRACTOR MUST SCHEDULE ROOT PRUNING TO PROVIDE THE MAXIMUM POSSIBLE TIME FOR NEW ROOT GROWTH. EVEN TREES AND PALMS THAT TYPICALLY DO NOT REQUIRE LONG (OR ANY) ROOT PRUNING WILL BENEFIT FROM MORE ROOT PRUNING TIME; THEREFORE, ALL TREES AND PALMS TO BE RELOCATED MUST BE ROOT PRUNED. CONTRACTOR MUST PROVIDE A ROOT PRUNE SCHEDULE FOR EACH TREE OR PALM TO BE RELOCATED AS AN ATTACHMENT TO THE BID.
- 2.6. CONTRACTOR MUST CALL SUNSHINE 811 TO HAVE ALL UNDERGROUND UTILITIES LOCATED UNDER OR IN THE VICINITY OF THE CURRENT OR FUTURE LOCATIONS OF ALL TREES AND PALMS TO BE RELOCATED PRIOR TO WORK COMMENCING.
- 2.7. CONTRACTOR MUST VERIFY WITH THE GENERAL CONTRACTOR THE ABSENCE OF ANY UNDERGROUND CONSTRUCTION OR OBSTRUCTIONS (E.G., BULKHEADS, SEPTIC SYSTEMS, ETC.) IN THE CURRENT AND FUTURE LOCATIONS OF ALL TREES AND PALMS TO BE RELOCATED.
- 2.8. CONTRACTOR MUST ALERT THE LANDSCAPE ARCHITECT OF ANY TREES OR PALMS THAT WILL NOT SUCCESSFULLY RELOCATE DUE TO POOR HEALTH PRIOR TO BEGINNING ROOT PRUNING.
- 2.9. CONTRACTOR MUST FLAG ALL PROPOSED TRANSPLANT LOCATIONS FOR THE LANDSCAPE ARCHITECT'S APPROVAL A MINIMUM OF 15 DAYS PRIOR TO RELOCATION.
- 2.10. CONTRACTOR MUST ENSURE THAT ALL TREES AND PALMS TO BE RELOCATED ARE INSTALLED AT THE CORRECT GRADE OR ELEVATION, ACCORDING TO THE GRADING PLAN.
- 2.11. CONTRACTOR MUST ENSURE THAT ALL ROOT FLARES ARE EXPOSED AFTER RELOCATION.
- 2.12. CONTRACTOR MUST REMOVE ALL RESIDUAL ROOTS, STUMPS, AND PORTIONS THEREOF AND BACKFILL PITS FROM WHICH RELOCATED TREES AND PALMS WERE REMOVED WITH CLEAN FILL FLUSH WITH THE SURROUNDING GRADE.
- 2.13. CONTRACTOR MUST REPAIR ANY DAMAGE TO OTHER PLANTS, LAWN, HARDSCAPES, OR NEW CONSTRUCTION WITHIN THE RELOCATION AREA AT CONTRACTOR'S EXPENSE. HARDSCAPES INCLUDE BUT ARE NOT LIMITED TO CURBS, WALKS, ROADS, FENCES, SITE FURNISHINGS, ETC.
- 2.14. CONTRACTOR MUST PHOTOGRAPHICALLY DOCUMENT NEW ROOT GROWTH FOLLOWING EACH ROOT PRUNE AND SUBMIT THIS DOCUMENTATION TO THE LANDSCAPE ARCHITECT. THE PURPOSE OF THIS REQUIREMENT IS TO ENSURE THAT SUFFICIENT ROOT GROWTH HAS OCCURRED PRIOR TO THE SECOND AND SUBSEQUENT ROOT PRUNES AND FOLLOWING THE FINAL ROOT PRUNE PRIOR TO RELOCATION
- 2.15. CONTRACTOR MUST INSTALL AND MAINTAIN PROTECTION FENCING AROUND EACH TREE AND PALM TO BE RELOCATED BOTH DURING ROOT PRUNING AND AFTER RELOCATION. PROTECTION FENCING MUST CONSIST OF GALVANIZED WELDED WIRE FABRIC OR PLASTIC MESH ATTACHED TO 4" X 4" POSTS INSERTED AROUND THE PERIMETER OF THE DRIPLINE OF THE TREE OR PALM. PROTECTION FENCING MUST BE PLUMB, TAUT, AND STURDY AT ALL TIMES AND MUST REMAIN IN PLACE THROUGHOUT THE ROOT PRUNING AND WARRANTY PERIODS, OR AS DIRECTED BY THE LANDSCAPE ARCHITECT.
- 2.16. CONTRACTOR MUST OBTAIN ALL NECESSARY OR REQUIRED PERMITS FOR THE RELOCATION AND TRANSPORTATION OF THE TREES AND PALMS TO BE RELOCATED.
- 2.17. CONTRACTOR MUST REPLACE ANY TREES OR PALMS SCARRED OR DAMAGED DURING RELOCATION, AT THE CONTRACTOR'S EXPENSE, WITH THE SAME OR SIMILAR SPECIES, SIZE, AND QUALITY. REPLACEMENT TREES OR PALMS MUST BE APPROVED BY THE LANDSCAPE ARCHITECT PRIOR TO PROCUREMENT, PREPARATION, AND/OR INSTALLATION. REPLACEMENT TREES AND PALMS MUST BE INSTALLED WITHIN 60 DAYS OF NOTICE. 2.18. CONTRACTOR MUST GUARANTEE ALL RELOCATED TREES AND PALMS FOR ONE YEAR FROM THE DATE
- OF RELOCATION TO THE FINAL LOCATION. GUARANTY MUST INCLUDE TREE HEALTH AND SETTLING 2.19. CONTRACTOR MUST PROVIDE ALL MATERIAL NECESSARY TO PERFORM THE WORK COVERED HEREIN, INCLUDING BUT NOT LIMITED TO BACKFILL MATERIAL, PROTECTION FENCING, FLAGGING, ADDITIVES AND SUPPLEMENTS, TEMPORARY IRRIGATION, BURLAP, WIRE, SHRINK WRAP, AND ALL NECESSARY TOOLS AND EQUIPMENT.

3. ROOT PRUNING SPECIFICATIONS

3.1. GENERAL

- 3.1.1. ALL TREES AND PALMS TO BE RELOCATED MUST BE WATERED DAILY FOR AT LEAST 2-3 DAYS PRIOR TO ANY ROOTS BEING CUT TO ENSURE THAT THEY ARE FULLY HYDRATED. EACH WATERING MUST THOROUGHLY SATURATE THE ROOTBALL TO ITS FULL DEPTH. 3.1.2. EACH TREE AND PALM MUST THEN BE WATERED EVERY OTHER DAY, NOT RELYING ON RAIN, DURING THE ENTIRE ROOT PRUNING PROCESS EITHER BY A TEMPORARY IRRIGATION SYSTEM OR BY HAND. EACH WATERING MUST THOROUGHLY SATURATE THE ROOTBALL TO ITS FULL DEPTH. 3.1.3. TREE AND PALM RELOCATION ACTIVITIES MUST BE SCHEDULED SO THAT REMOVAL AND REPLANTING TAKE PLACE IN THE SAME 24-HOUR PERIOD, NO TREES OR PALMS MAY BE "STOCKPILED" ONSITE OR
- OFFSITE FOR ANY PERIOD OF TIME WITHOUT PRIOR WRITTEN APPROVAL OF THE LANDSCAPE ARCHITECT. WHEN ALLOWED, APPROVAL FOR THE METHOD OF "STOCKPILING" MUST BE OBTAINED FROM THE LANDSCAPE ARCHITECT.
- 3.1.4. ALL DIGGING IN THE ROOT ZONE DURING THE ROOT PRUNE PROCESS MUST BE DONE BY HAND; NO MACHINERY WILL BE ALLOWED. PRUNING OF ROOTS MUST BE DONE BY HAND WITH CLEAN, SHARP TOOLS. DO NOT PAINT CUT ROOTS WITH TREE PAINT OR ANY KIND OF SEALANT. 3.1.5. MYCORRHIZA (ROOTS® TRANSPLANT OR EQUIVALENT) MUST BE INCORPORATED INTO THE BACKFILL
- SOIL PRIOR TO BACKFILLING AS PER MANUFACTURES RECOMMENDATIONS.
- 3.1.6. AFTER EACH ROOT PRUNE, EACH SECTION OF ROOTBALL THAT IS PRUNED MUST BE WRAPPED WITH BLACK PLASTIC AND THE TRENCH BACKFILLED WITH ORIGINAL EXCAVATED SOIL. A TREE RING WITH A MINIMUM HEIGHT OF 6" MUST BE CONSTRUCTED 6-12" OUTSIDE THE OUTERMOST EDGE OF THE ROOTBALL AND AROUND THE ENTIRE PERIMETER OF THE ROOTBALL TO DIRECT IRRIGATION WATER AND ANY ADDED SUPPLEMENTS DOWN INTO THE ROOTBALL DURING ROOT REGENERATION.
- 3.1.7. ONCE THE TREE RING IS CONSTRUCTED AFTER EACH ROOT PRUNE, A HIGH-PHOSPHORUS ROOT STIMULANT MUST BE LIBERALLY APPLIED TO THE SURFACE OF THE ROOTBALL AND THOROUGHLY WATERED IN TO ENCOURAGE NEW ROOT GROWTH.

3.2. <u>TREES</u>

3.2.1. PRIOR TO ANY ROOTS BEING CUT, ALL MAJOR ROOTS MUST BE IDENTIFIED TO DETERMINE THE ROOTBALL DIAMETER BASED ON THE RELATIVE LOCATION AND SIZE OF THE ROOTS 3.2.2. MANY TREE RELOCATION SPECIFICATIONS USE "GENERAL RULES" TO CALCULATE MINIMUM ROOTBALL DIAMETER, SUCH AS MULTIPLYING THE DIAMETER AT BREAST HEIGHT (DBH) OF THE TREE BY A FACTOR OF 10 OR ALLOWING A MINIMUM OF 9-12" OF ROOTBALL FOR EVERY 1" OF TREE CALIPER.

OTHERS LIST UNREALISTIC MINIMUM SIZES FOR THE ROOTBALLS OF VARIOUS TREE CALIPERS OR HEIGHTS. IN MANY CASES, SUCH APPROACHES RESULT IN ROOTBALLS THAT ARE EITHER TOO LARGE OR TOO SMALL FOR A GIVEN TREE. THE FOLLOWING TABLE LISTS MINIMUM ROOTBALL DIAMETERS BASED ON REAL-WORLD EXPERIENCE OF TREE RELOCATION SPECIALISTS IN SOUTH FLORIDA:

CALIPER	MIN. ROOTBALL	CALIPER	MIN. ROOTBALL
(inches)	DIA. (feet)	(inches)	DIA. (feet)
1 - 4	3	12 - 14	8
4 - 5	4	15 - 17	10
6 - 7	5	18 - 24	12 - 15
8 - 9	6	25 - 30	15 - 25
10 -11	7	30 +	as needed

3.2.3. WHENEVER POSSIBLE, ROOTBALLS MUST BE CIRCULAR IN SHAPE WITH AN EQUAL DISTANCE FROM THE TRUNK TO THE EDGE OF THE ROOTBALL ALL AROUND.

3.2.4. MINIMUM ROOTBALL DEPTH MUST BE 24-36" FOR ALL TREES TO BE RELOCATED, WITH THE ACTUAL DEPTH TO BE DETERMINED ONLY AFTER A THOROUGH EXAMINATION OF ALL ROOTS DURING THE INITIAL ROOT INSPECTION AND BASED ON THE ABSENCE OF MAJOR ROOTS AT THE BOTTOM OF THE ROOTBALL. ROOTBALLS DEEPER THAN 36" MAY BE REQUIRED FOR LARGE SPECIMEN TREES, DEPENDING ON THE RELATIVE LOCATIONS AND DEPTHS OF THE MAJOR ROOTS AS OBSERVED DURING THE INITIAL ROOT INSPECTION.

NEEDED DURING THE COOLER MONTHS OF THE YEAR.

- 3.2.6. AS A GENERAL RULE, MINIMUM ROOT PRUNE TIME FOR TREES WITH A DBH OF 10" OR GREATER IS 24 NEEDED DURING THE COOLER MONTHS OF THE YEAR. INCLUDE, BUT ARE NOT LIMITED TO, THE FOLLOWING:
- AVOCADO (PERSEA AMERICANA) BLACK OLIVE (BUCIDA BUCERAS)
- BRIDALVEIL (CAESALPINIA GRANADILLO)
- CASSIAS (ALL SPECIES OF CASSIA) LIGNUM VITAE (GUAIACUM SANCTUM & G. OFFICINALE)
- PODOCARPUS (*PODOCARPUS* SP.)
- LIVE OAK (QUERCUS VIRGINIANA) MAHOGANY (SWIETENIA MAHAGONI)
- MANGO (MANGIFERA INDICA)
- PIGEON PLUM (COCCOLOBA DIVERSIFOLIA) • SWEET ACACIA (ACACIA FARNESIANA)
- VERAWOOD (BULNESIA ARBOREA)

WILD TAMARIND (LYSILOMA LATISILIQUUM & L. SABICU)

FOR THESE TREES, THE MINIMUM ROOT PRUNE TIMES DISCUSSED IN SECTIONS 3.2.5 AND 3.2.6 ABOVE MAY BE INSUFFICIENT. ONLY WHEN SUFFICIENT NEW ROOT GROWTH HAS TAKEN PLACE FOLLOWING AN EARLIER ROOT PRUNE CAN THE NEXT ROOT PRUNE BE DONE, AND ONLY WHEN SUFFICIENT NEW ROOT GROWTH HAS TAKEN PLACE FOLLOWING THE FINAL ROOT PRUNE MAY THE TREE BE RELOCATED (SEE SECTION 2.14 ABOVE FOR SPECIFICATIONS ON PHOTOGRAPHICALLY DOCUMENTING NEW ROOT GROWTH DURING THE ROOT PRUNE PROCESS).

3.1. PALMS

PALM SPECIES

SABAL / CABBAGE PALM QUEEN & FOXTAIL PALMS **ROYAL & COCONUT PALMS** CANARY DATE PALM SLOW-GROWING PALMS (see sec. 3.3.4)

- ALL AROUND.
- MONTHS OF THE YEAR.
- PRUNING TIME. THESE INCLUDE, BUT ARE NOT LIMITED TO, THE FOLLOWING: ALL SPECIES OF ARCHONTOPHOENIX
- ALL SPECIES OF CORYPHA
- AMERICAN OIL PALMS (ALL SPECIES OF ATTALEA)
- BISMARCK PALM (BISMARCKIA NOBILIS) CUBAN & CARIBBEAN COPERNICIA
- CUBAN BELLY PALM (GASTROCOCOS CRISPA)
- GINGERBREAD/DOUM PALMS (ALL SPECIES OF HYPHAENE)
- PALMYRA PALMS (ALL SPECIES OF BORASSUS)
- SATAKE PALM (SATAKENTIA LIUKIUENSIS)
- SAW PALMETTO (SERENOA REPENS) SILVER PALM (COCCOTHRINAX ARGENTATA)
- ZOMBIE PALM (ZOMBIA ANTILLARUM)

FOR THESE PALMS, THE MINIMUM ROOT PRUNING TIME IS 4-6 MONTHS OR GREATER. ONLY WHEN SUFFICIENT NEW ROOT GROWTH HAS TAKEN PLACE FOLLOWING AN EARLIER ROOT PRUNE CAN THE NEXT ROOT PRUNE BE DONE, AND ONLY WHEN SUFFICIENT NEW ROOT GROWTH HAS TAKEN PLACE FOLLOWING THE FINAL ROOT PRUNE MAY THE TREE BE RELOCATED (SEE SECTION 2.14 ABOVE FOR SPECIFICATIONS ON PHOTOGRAPHICALLY DOCUMENTING NEW ROOT GROWTH DURING THE ROOT PRUNE PROCESS).

4. CANOPY PRUNING SPECIFICATIONS

4.1. TREES

- LIFTING THE TREE DURING RELOCATION.
- PRESERVED.
- AND ESCORTS TO TRANSPORT WIDE LOADS. PER FLORIDA LAW.
- BEST MANAGEMENT PRACTICES.
- 4.2. PALMS
- ENTIRELY AT THE DIRECTION OF THE LANDSCAPE ARCHITECT. 4.2.2. PALM LEAVES MUST BE TIED UP WITH 2-PLY BIODEGRADABLE TWINE PRIOR TO RELOCATION TO
- SPECIFICATIONS SPECIFIC TO EACH PALM.

3.2.5. AS A GENERAL RULE, MINIMUM ROOT PRUNE TIME FOR TREES WITH A DBH OF LESS THAN 10" IS 12 WEEKS. THE FIRST ROOT PRUNE MUST BE ON TWO OPPOSING SIDES OF THE ROOTBALL, WITH THE SECOND ROOT PRUNE ON ONE OF THE OTHER TWO SIDES DONE A MINIMUM OF 6 WEEKS LATER, AND A THIRD ROOT PRUNE ON THE LAST SIDE DONE A MINIMUM OF 3 WEEKS AFTER THAT. THE SECOND AND THIRD ROOT PRUNES MAY ONLY BE DONE WHEN HEALTHY NEW ROOT GROWTH FROM EARLIER ROOT PRUNES IS EVIDENT (SEE SECTION 2.14 ABOVE FOR SPECIFICATIONS ON PHOTOGRAPHICALLY DOCUMENTING NEW ROOT GROWTH DURING THE ROOT PRUNE PROCESS). MORE TIME MAY BE

WEEKS. THE FIRST ROOT PRUNE MUST BE ON TWO OPPOSING SIDES OF THE ROOTBALL, WITH THE SECOND ROOT PRUNE ON ONE OF THE OTHER TWO SIDES DONE A MINIMUM OF 12 WEEKS LATER, AND A THIRD ROOT PRUNE ON THE LAST SIDE DONE A MINIMUM OF 6 WEEKS AFTER THAT. THE SECOND AND THIRD ROOT PRUNES MAY ONLY BE DONE WHEN HEALTHY NEW ROOT GROWTH FROM EARLIER ROOT PRUNES IS EVIDENT (SEE SECTION 2.14 ABOVE FOR SPECIFICATIONS ON PHOTOGRAPHICALLY DOCUMENTING NEW ROOT GROWTH DURING THE ROOT PRUNE PROCESS). MORE TIME MAY BE

3.2.7. CERTAIN HARDWOOD TREES AND GYMNOSPERMS REQUIRE LONGER ROOT PRUNING TIMES. THESE

3.1.1. THE FOLLOWING TABLE LISTS MINIMUM ROOTBALL DIAMETERS FOR VARIOUS SPECIES OF PALMS BASED ON REAL-WORLD EXPERIENCE OF RELOCATION SPECIALISTS IN SOUTH FLORIDA:

> ROOTBALL SPECIFICATIONS 36" diameter 12" from trunk in all directions

18 - 24" from trunk in all directions 24" from trunk in all directions 24" from trunk in all directions

3.1.2. PALM ROOTBALLS MUST BE A MINIMUM OF 24" DEEP. WHENEVER POSSIBLE, ROOTBALLS MUST BE CIRCULAR IN SHAPE WITH AN EQUAL DISTANCE FROM THE TRUNK TO THE EDGE OF THE ROOTBALL

3.1.3. AS A GENERAL RULE, MINIMUM ROOT PRUNE TIME FOR PALMS IS 6-8 WEEKS. THE FIRST ROOT PRUNE MUST BE ON TWO OPPOSING SIDES OF THE ROOTBALL, WITH THE SECOND ROOT PRUNE ON ONE OF THE OTHER TWO SIDES DONE A MINIMUM OF 3-4 WEEKS LATER, AND A THIRD ROOT PRUNE ON THE LAST SIDE DONE A MINIMUM OF 4.5-6 WEEKS AFTER THAT. THE SECOND AND THIRD ROOT PRUNES MAY ONLY BE DONE WHEN HEALTHY NEW ROOT GROWTH FROM EARLIER ROOT PRUNES IS EVIDENT (SEE SECTION 2.14 ABOVE FOR SPECIFICATIONS ON PHOTOGRAPHICALLY DOCUMENTING NEW ROOT GROWTH DURING THE ROOT PRUNE PROCESS). MORE TIME MAY BE NEEDED DURING THE COOLER

3.1.4. CERTAIN PALMS, IN PARTICULAR THOSE THAT ARE SLOW GROWING, REQUIRE LONGER ROOT

4.1.1. PRIOR TO RELOCATION, THE CANOPY OF EACH TREE TO BE RELOCATED MUST BE SELECTIVELY PRUNED TO REMOVE CROSSING, DEAD, DISEASED, BROKEN, AND LOW-HANGING BRANCHES THAT MAY INTERFERE WITH CONSTRUCTION ACTIVITIES, OR THAT MAY INTERFERE OR RESTRICT STRAPPING OR

4.1.2. FOR TREES BEING RELOCATED ONSITE, THE CANOPY MAY BE SELECTIVELY THINNED AND REDUCED BY NO MORE THAN 1/3 OF THE OVERALL CANOPY MASS, AT THE DIRECTION OF THE LANDSCAPE ARCHITECT; HOWEVER, THE BASIC SHAPE, FORM, AND CHARACTER OF THE TREE MUST BE

4.1.3. FOR TREES BEING RELOCATED OFFSITE, THE CANOPY MUST BE PRUNED, AT THE DIRECTION OF THE LANDSCAPE ARCHITECT, TO FIT ON THE TRAILER FOR TRANSPORT. EVERY EFFORT MUST BE MADE TO RETAIN AS MANY LARGE BRANCHES AS POSSIBLE AND TO PRESERVE AS MUCH OF THE SHAPE, FORM, AND CHARACTER OF THE TREE AS POSSIBLE TO THE WIDEST LOAD WIDTH ALLOWABLE BY THE FLORIDA DEPARTMENT OF TRANSPORTATION. CONTRACTOR MUST OBTAIN ALL NECESSARY PERMITS

4.1.4. ALL CANOPY PRUNING MUST BE CONDUCTED FOLLOWING ANSI A-300 TREE PRUNING STANDARDS AND

4.1.5. ALL DEBRIS GENERATED DURING CANOPY PRUNING MUST BE REMOVED OFFSITE AND DISPOSED.

4.2.1. IT IS WELL KNOWN THAT SOME PALMS SURVIVE RELOCATION BETTER WHEN ALL OF THE LEAVES ARE REMOVED (E.G., CABBAGE PALM, SABAL PALMETTO), AND THAT OTHER PALMS BENEFIT FROM HAVING THEIR LEAVES CUT IN HALF DURING RELOCATION (E.G., COCONUT PALM, COCOS NUCIFERA). BOTH OF THESE HORTICULTURAL PRACTICES, WHILE TRUE, ARE ONLY APPLICABLE WHEN PALMS ARE NOT ROOT PRUNED. LEAVES DO NOT NEED TO BE CUT IN HALF OR REMOVED FROM PALMS THAT ARE ADEQUATELY ROOT PRUNED. ON OCCASION WHEN SUFFICIENT ROOT PRUNING TIME IS NOT AVAILABLE, PALMS TO BE RELOCATED MAY HAVE THEIR LEAVES CUT IN HALF OR REMOVED

PREVENT MECHANICAL DAMAGE DURING THE RELOCATION PROCESS. 4.2.3. PALM TRUNKS SHALL ONLY BE "CLEANED UP" ACCORDING TO THE LANDSCAPE ARCHITECT'S **5.RELOCATION SPECIFICATIONS**

5.1. GENERAL

- 5.1.1. LANDSCAPE CONTRACTOR TO FLAG ALL PROPOSED PLANT LOCATIONS FOR LANDSCAPE ARCHITECT'S APPROVAL PRIOR TO INSTALLATION. NOTIFY LANDSCAPE ARCHITECT A MINIMUM OF 15 DAYS PRIOR TO REVIEW.
- 5.1.2. ALL TREES AND PALMS TO BE RELOCATED MUST BE WATERED DAILY FOR AT LEAST 5 DAYS PRIOR TO ANY RELOCATION TO ENSURE THAT THEY ARE FULLY HYDRATED. EACH WATERING MUST THOROUGHLY SATURATE THE ROOTBALL TO ITS FULL DEPTH.
- 5.1.3. ALL ROOTBALLS MUST BE WRAPPED IN BURLAP AND THEN TIGHTLY WIRE-WRAPPED (USING REDLINE HORSE WIRE OR EQUIVALENT) TO KEEP THE ENTIRE ROOTBALL INTACT DURING RELOCATION. TREES AND PALMS GROWING IN LIMESTONE MUST BE DUG AND RELOCATED WITH THE ROOTS ATTACHED TO A SECTION OF ROCK AS PART OF THE ROOTBALL, SUCH THAT THE ROOTS REMAIN INTACT. ROOTBALLS COMING FROM SAND OR SANDY SOIL MAY ALSO NEED TO BE BOXED PRIOR TO RELOCATION, AT THE DISCRETION OF THE LANDSCAPE ARCHITECT.
- 5.1.4. TREES AND PALMS BEING RELOCATED OFFSITE MUST HAVE THEIR ENTIRE ROOTBALLS THOROUGHLY AND TIGHTLY WRAPPED WITH PLASTIC SHRINK WRAP ON THE OUTSIDE OF THE WIRE WRAP, AND THE ENTIRE TREE OR PALM (INCLUDING CANOPY, TRUNK, AND ROOTBALL) MUST BE COVERED WITH A BREATHABLE TARP (E.G., SHADE CLOTH) DURING TRANSPORT.
- 5.1.5. NEW PLANTING PITS FOR RELOCATED TREES AND PALMS MUST BE PREPARED PRIOR TO LIFTING THE PALM OR TREE FROM ITS CURRENT LOCATION AND MUST BE AT LEAST 3-4 FEET WIDER THAN THE ROOTBALL AND THE SAME DEPTH AS THE ROOTBALL, SUCH THAT THE FINAL ELEVATION OF THE TOP OF THE ROOTBALL IS AT OR SLIGHTLY ABOVE (NO MORE THAN 2" HIGHER) FINAL GRADE.
- 5.1.6. TREES AND PALMS TO BE RELOCATED MUST BE LIFTED BY THE ROOTBALL ONLY, USING APPROPRIATELY SIZED (LENGTH AND STRENGTH) LIFTING STRAPS OR CHAINS. DURING LIFTING, THE TREE OR PALM MUST BE BALANCED IN A MORE-OR-LESS UPRIGHT POSITION, WITH THE STRAP ON THE TRUNK USED ONLY FOR BALANCING AND MANEUVERING THE TREE OR PALM INTO POSITION. NO CHAINS MAY BE USED AROUND OR AGAINST THE TRUNK AT ANY TIME. AT NO TIME SHALL 100% OF THE WEIGHT OF THE TREE OR PALM BE ON THE STRAP ATTACHED TO THE TRUNK. TRUNKS MUST BE HEAVILY PADDED WITH 30-60 LAYERS (DEPENDING ON SIZE AND WEIGHT) OF BURLAP BENEATH THE BALANCING STRAP.
- 5.1.7. TREES AND PALMS MUST BE LIFTED WITH A CRANE OR BACKHOE APPROPRIATELY SIZED FOR THE SIZE AND WEIGHT OF THE TREE OR PALM AND LIFTED OR CARRIED DIRECTLY TO THE FINAL INSTALL LOCATION OR TRANSPORT TRAILER.
- 5.1.8. ONCE LIFTING BEGINS, ANY UNCUT ROOTS UNDER OR AROUND THE ROOTBALL THAT MAY YET REMAIN MUST BE IMMEDIATELY SEVERED WITH HAND PRUNING TOOLS TO MINIMIZE TEARING AND ROOT DAMAGE.
- 5.1.9. AGRIFORM PLANTING TABLETS (OR APPROVED EQUIVALENT) MUST BE EVENLY DISTRIBUTED AROUND THE PERIMETER OF THE PLANTING PIT AT THE RATE OF 2 TABLETS PER 1" TRUNK CALIPER PRIOR TO BACKFILLING.
- 5.1.10. MYCORRHIZA (ROOTS® TRANSPLANT OR EQUIVALENT) MUST BE INCORPORATED INTO THE BACKFILL SOIL PRIOR TO BACKFILLING.
- 5.1.11. RELOCATED TREES AND PALMS MUST BE CENTERED IN THE PLANTING PIT, AND THE PIT BACKFILLED USING A 1:1 MIXTURE OF EXISTING SOIL AND 80:20 (DOT SAND:MUCK) SOIL MIX THOROUGHLY BLENDED TOGETHER. DO NOT USE MUDDY SOIL AS BACKFILL. (SEE 5.2.2 BELOW FOR SPECIAL CONDITIONS REGARDING DATE PALM BACKFILL SPECIFICATIONS.)
- 5.1.12. SMALL TREES AND PALMS MUST BE FIRMLY BRACED USING A MINIMUM OF FOUR 4" X 4" WOODEN BRACES ATTACHED TO 2" X 4" WOODEN BATTENS HELD IN PLACE WITH TWO STEEL BANDS. LARGER TREES MAY REQUIRE 6" X 6" WOODEN POSTS OR EVEN TELEPHONE POLES TO PROVIDE SUFFICIENT BRACING STRENGTH TO PREVENT TOPPLING DURING WIND EVENTS. A SUFFICIENT NUMBER OF BATTENS MUST BE STRATEGICALLY PLACED AROUND THE TRUNK SUCH THAT THE STEEL BANDS NEVER CONTACT THE TRUNK. NO BURLAP IS TO REMAIN UNDER THE WOODEN BATTENS ON TREES DURING BRACING, BUT SEVERAL LAYERS OF BURLAP SHOULD BE LEFT UNDER THE WOODEN BATTENS WHEN BRACING PALMS. NAILS SHALL NEVER BE DRIVEN DIRECTLY INTO THE TRUNK DURING BRACING. BRACING MUST REMAIN IN PLACE FOR A MINIMUM OF ONE YEAR.
- 5.1.13. A TREE RING WITH A MINIMUM HEIGHT OF 6" MUST BE CONSTRUCTED 6-12" OUTSIDE THE OUTERMOST EDGE OF THE ROOTBALL AND AROUND THE ENTIRE PERIMETER OF THE ROOTBALL TO DIRECT IRRIGATION WATER AND ANY SUPPLEMENTS THAT ARE ADDED DOWN INTO THE ROOTBALL DURING ROOT REGENERATION.
- 5.1.14. ONCE THE TREE RING IS CONSTRUCTED, A HIGH-PHOSPHORUS ROOT STIMULANT MUST BE LIBERALLY APPLIED TO THE SURFACE OF THE ROOTBALL AND THOROUGHLY WATERED IN.
- 5.1.15. ROOTBALLS MUST BE THOROUGHLY WATERED IN USING A HOSE AND A JOHNSON BAR INSERTED TO THE VERY BOTTOM OF THE ROOTBALL AND SWUNG BACK AND FORTH TO PREVENT FORMATION OF AIR POCKETS. THE JOHNSON BAR TECHNIQUE MUST BE REPEATED AT LEAST ONCE MORE WITHIN ONE WEEK AFTER RELOCATION, AND AGAIN IF ANY SIGNS OF STRESS BECOME APPARENT.
- 5.1.16. ORGANIC MULCH (MELALEUCA IS PREFERRED) MUST BE APPLIED WITHIN 48 HOURS OF RELOCATION AT A DEPTH OF 3-4" OVER THE ENTIRE TOP OF THE ROOTBALL FROM THE TREE RING TO WITHIN 6" OF THE TRUNK. MULCH MUST NOT BE APPLIED OR ALLOWED TO ACCUMULATE DIRECTLY AGAINST THE TRUNK.
- 5.1.17. PITS FROM WHICH THE RELOCATED TREES AND PALMS WERE REMOVED MUST BE CLEANED OF ALL RESIDUAL ROOTS, STUMPS, AND PORTIONS THEREOF AND BACKFILLED WITH CLEAN FILL FLUSH WITH THE SURROUNDING GRADE.
- 5.1.18. RESTORE THE SURFACE WITH MATERIAL TO MATCH ADJACENT AREAS. MATERIAL TO BE APPROVED BY LANDSCAPE ARCHITECT. CONTRACTOR TO PROVIDE A MINIMUM OF ONE YEAR WARRANTY ON SETTLING AND PLANT MATERIAL FROM TIME OF SUBSTANTIAL COMPLETION.
- 5.2. SPECIAL CONDITIONS
- 5.2.1. MULTI-TRUNK TREES AND PALMS MUST BE RELOCATED AS ONE UNIT WITH A SINGLE ROOTBALL.

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MAINTENANCE SPECIFICATIONS

6.1. GENERAL

6.1.1. ALL RELOCATED TREES AND PALMS MUST BE MAINTAINED FOR ONE YEAR FROM THE DATE OF RELOCATION TO THEIR FINAL LOCATIONS.

6.1.2. CONTRACTOR MUST MAINTAIN ALL RELOCATED TREES AND PALMS FOR ONE FULL YEAR FROM THE DATE OF RELOCATION TO THE FINAL LOCATION.

EVER POSSIBLE, EACH TREE AND PALM MUST BE WATERED BY A PERMANENT MATIC IRRIGATION SYSTEM FOLLOWING RELOCATION. EACH WATERING MUST OUGHLY SATURATE THE ROOTBALL TO ITS FULL DEPTH: THIS WILL REQUIRE 25-50 ONS OF WATER FOR SMALL TREES AND PALMS, DEPENDING ON ROOTBALL SIZE, LARGE TREES WILL REQUIRE A MINIMUM OF 10 GALLONS PER FOOT OF ROOTBALL TER (I.E., A 10' DIAMETER ROOTBALL WILL REQUIRE A MINIMUM OF 100 GALLONS PER RING EVENT), WATERING FREQUENCY MUST BE EVERY DAY FOR THE FIRST TWO (S, EVERY OTHER DAY FOR THE NEXT THREE WEEKS, AND EVERY THIRD DAY FOR THE 6-8 WEEKS.

AN AUTOMATIC IRRIGATION SYSTEM IS NOT POSSIBLE, CONTRACTOR IS DNSIBLE FOR HAND WATERING RELOCATED TREES AND PALMS THROUGHOUT THE ENANCE PERIOD AND UNTIL FINAL ACCEPTANCE BY THE LANDSCAPE ARCHITECT OR CLIENT.

DIATELY AFTER RELOCATION TO THE FINAL LOCATION, A HIGH-PHOSPHORUS ROOT ILANT MUST BE APPLIED TO THE SURFACE OF THE ROOTBALL AT THE RECOMMENDED RATE AND WATERED IN WITH A DRENCH CONSISTING OF A SYSTEMIC INSECTICIDE CONTACT ROOT ROT FUNGICIDE, FOLLOWING LABEL INSTRUCTIONS, AS INITIAL ENTATIVE MAINTENANCE.

THREE MONTHS THEREAFTER, A HIGH-PHOSPHORUS ROOT STIMULANT MUST BE ED TO THE SURFACE OF THE ROOTBALL AT THE RECOMMENDED LABEL RATE AND RED IN WITH A DRENCH CONSISTING OF A SYSTEMIC INSECTICIDE AND A D-SPECTRUM SYSTEMIC FUNGICIDE, FOLLOWING LABEL INSTRUCTIONS, AS NUING PREVENTATIVE MAINTENANCE.

ATION AND BRACING MUST BE CHECKED AND EACH TREE OR PALM THOROUGHLY CTED FOR SIGNS OF STRESS, DISEASE, OR PEST PROBLEMS ON A MONTHLY BASIS.

TREES

DIATELY AFTER RELOCATION TO THE FINAL LOCATION AND EVERY THREE MONTHS EAFTER, A HIGH-QUALITY, SLOW-RELEASE 15-2-15 GRANULAR FERTILIZER MUST BE IED, AT THE RECOMMENDED LABEL RATE, SPREAD EVENLY ACROSS THE SURFACE OF ROOTBALL.

R FEED FOUR TIMES PER YEAR.

ERING TREES

DIATELY AFTER RELOCATION TO THE FINAL LOCATION AND EVERY THREE MONTHS EAFTER, A HIGH-QUALITY, SLOW-RELEASE 5-10-15 GRANULAR FERTILIZER MUST BE IED, AT THE RECOMMENDED LABEL RATE, SPREAD EVENLY ACROSS THE SURFACE OF ROOTBALL.

R FEED FOUR TIMES PER YEAR.

G MUST BE REMOVED FROM THE TIED UP LEAVES IMMEDIATELY AFTER RELOCATION E FINAL LOCATION IF THE PALM WAS ROOT PRUNED OR WITHIN 30-45 DAYS AFTER CATION ON THE OCCASION THE LANDSCAPE ARCHITECT APPROVED RELOCATION OUT ROOT PRUNING DUE TO TIME CONSTRAINTS.

DIATELY AFTER RELOCATION TO THE FINAL LOCATION AND EVERY THREE MONTHS EAFTER, A HIGH-QUALITY, SLOW-RELEASE 8-4-12 GRANULAR PALM FERTILIZER WITH RS MUST BE APPLIED, AT THE RECOMMENDED LABEL RATE, SPREAD EVENLY ACROSS URFACE OF THE ROOTBALL

R FEED SIX TIMES PER YEAR

OCATED TREES AND PALMS MUST BE GUARANTEED FOR ONE YEAR FROM THE DATE. OCATION TO THEIR FINAL LOCATIONS.

EE OR PALM DIES WITHIN THE 1-YEAR WARRANTY PERIOD, IT MUST BE REMOVED AND REPLACED AT CONTRACTOR'S EXPENSE.

7.3. IF A TREE OR PALM PERFORMS POORLY WITHIN THE 1-YEAR WARRANTY PERIOD, IT MUST BE REMOVED AND REPLACED AT THE CONTRACTOR'S EXPENSE. THE DECISION TO REPLACE BASED ON POOR HEALTH IS AT THE DISCRETION OF THE LANDSCAPE ARCHITECT

7.4. IF A TREE OR PALM SETTLES TO AN UNHEALTHY DEPTH WITHIN THE 1-YEAR WARRANTY PERIOD, AS DEEMED BY THE LANDSCAPE ARCHITECT, IT MUST BE RAISED TO THE CORRECT GRADE AT CONTRACTOR'S EXPENSE.

Rev.	Date Rev.	Date
1	<u>e</u>	
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3	11	
4	12	
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DRB SUBMITTAL

PRIVATE RESIDENCE

11 EAST RIVO ALTO DRIVE MIAMI BEACH, FL 33139

Owner:

PRIVATE RESIDENCE

Consultant: Name Address Address Tel: Email

Consultant: Name Address Address Tel: Email

Architect of Record: Kobi Karp Architecture and Interior Design, Inc. 2915 Biscayne Boulevard, Suite #200 Miami, Florida 33137 USA Tel: +1(305) 573 1818 Fax: +1(305) 573 3766

Landscape Architect of Record: David O. Design p.o. box 331615 Coconut Grove, FL. 33233-1615, USA Tel: +1(305) 854.9299 - Fax: +1(305) 854.9882 Email: davidodesign@hotmail.com www.davidodishoo.com




TREE DISPOSITION GENERAL NOTES

Date: 12-03-2021 Scale :

Project #: 21024

Sheet No.

LR-300

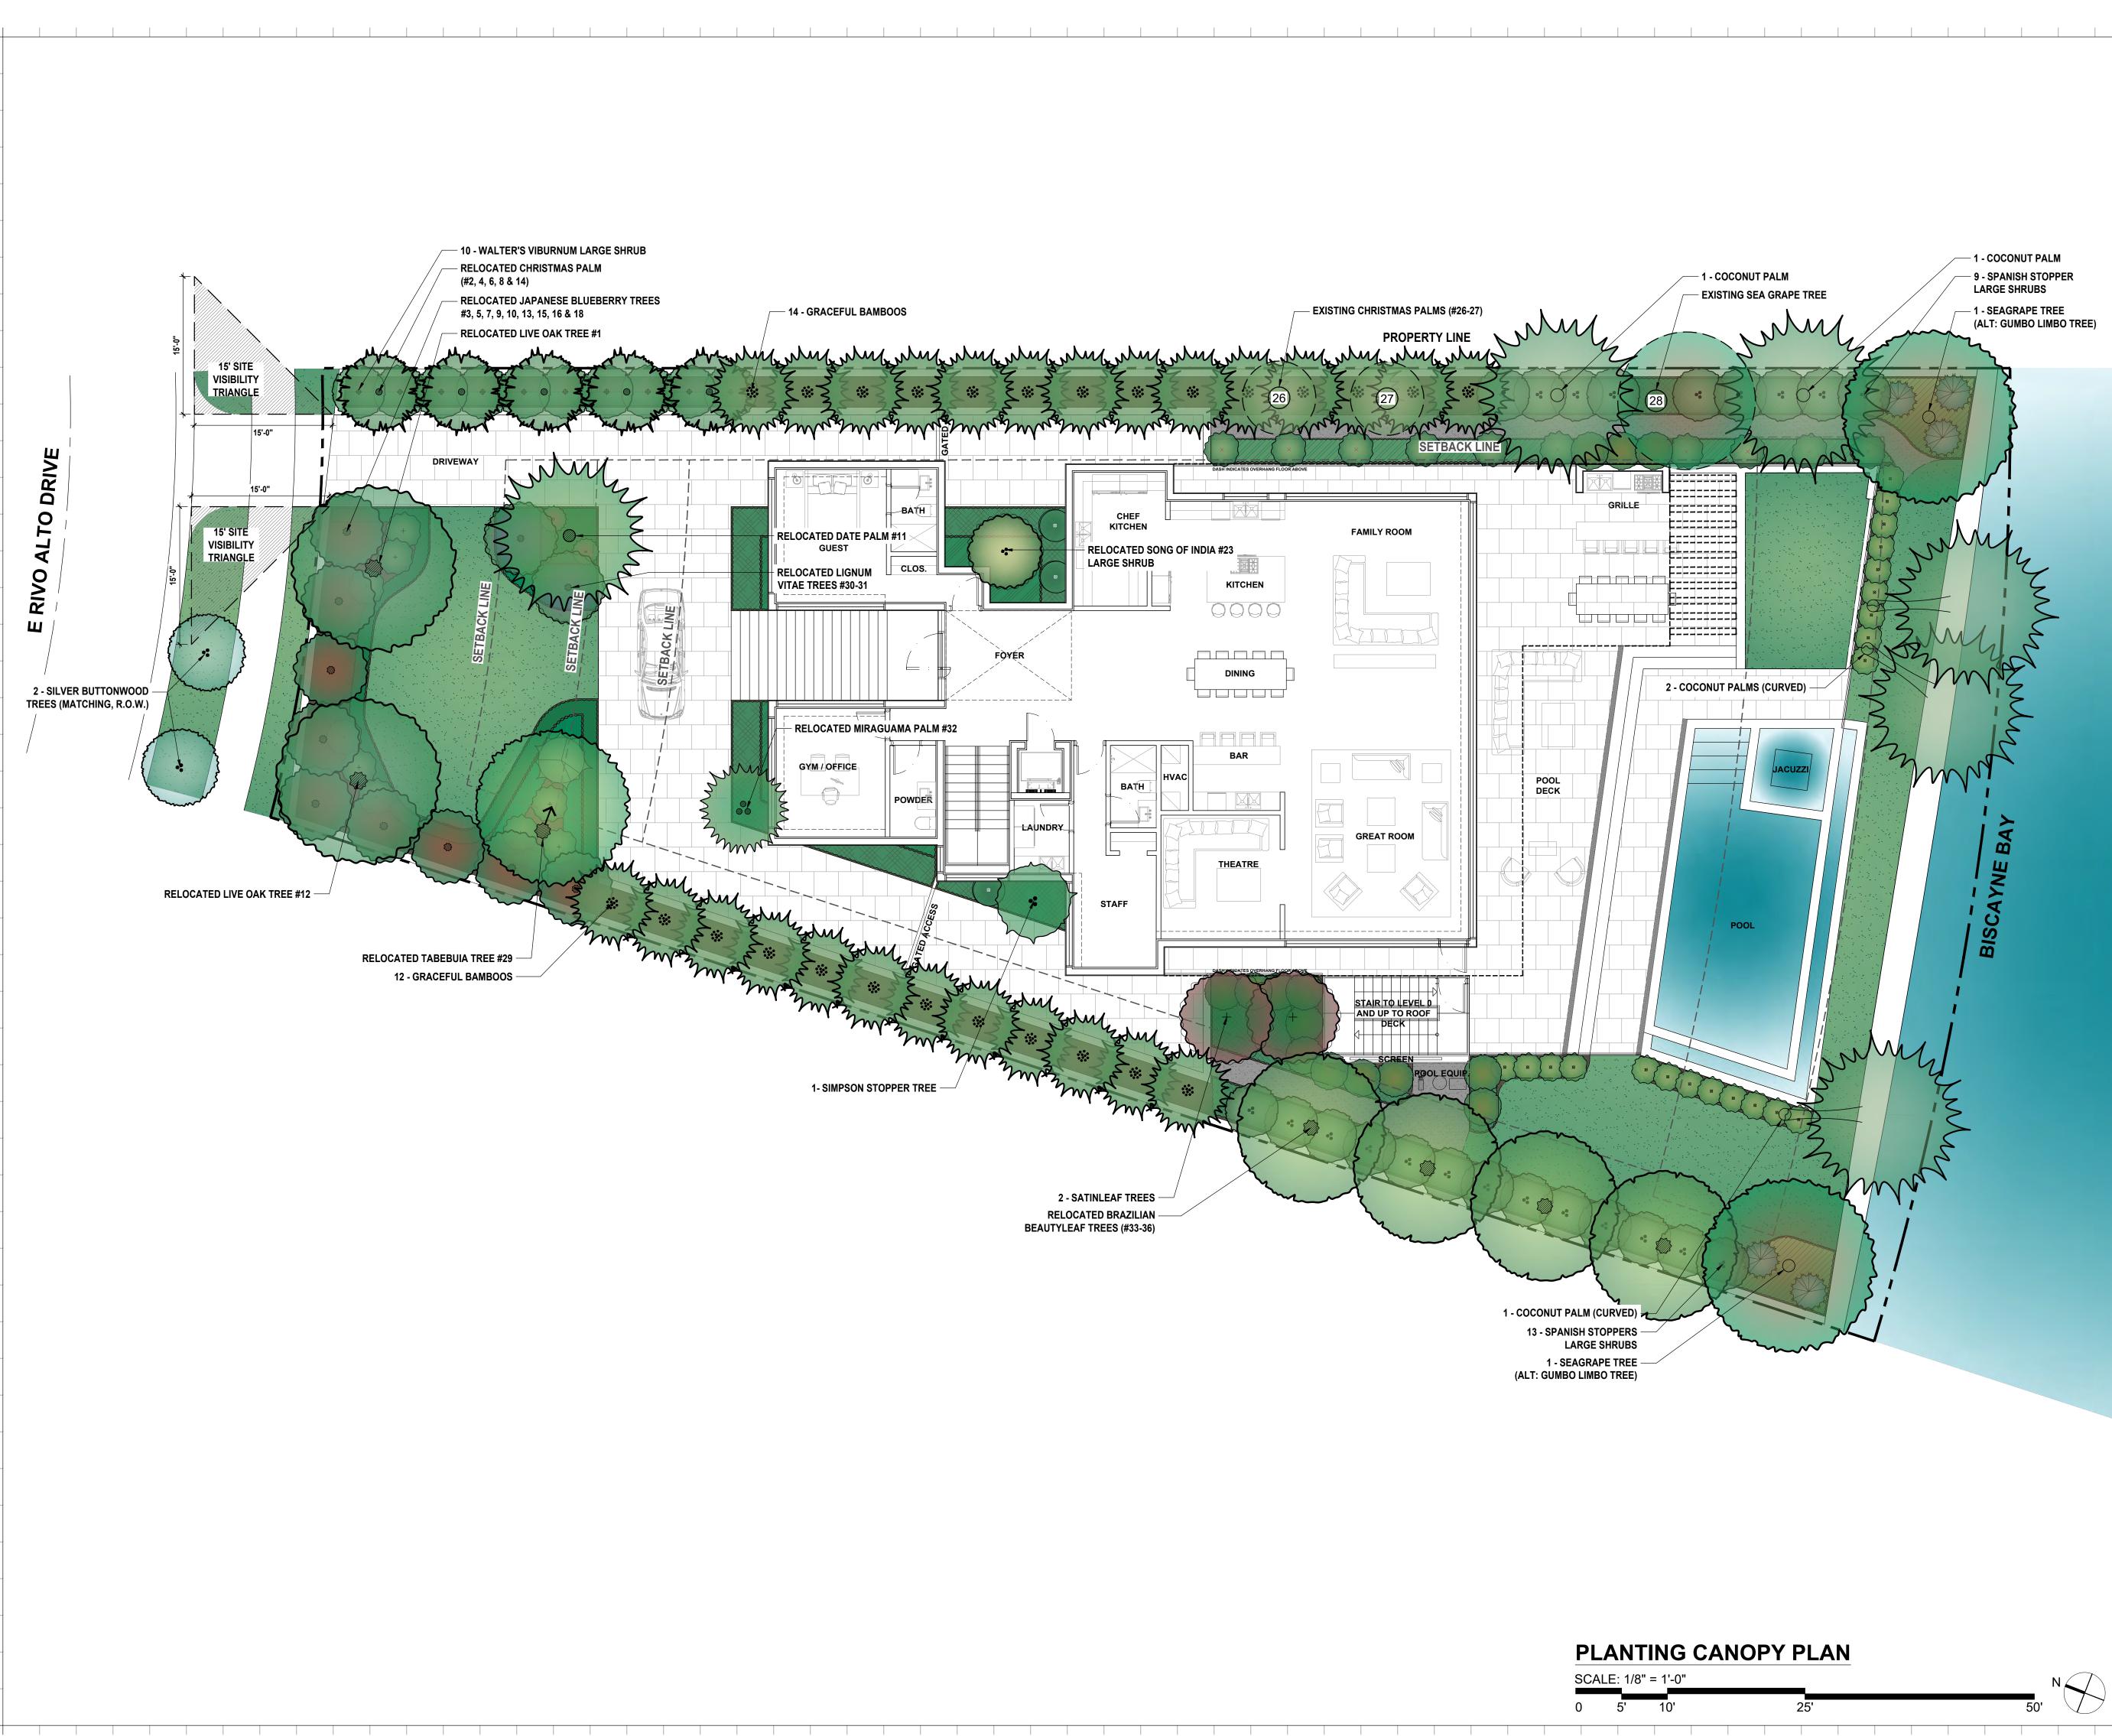

Rev.	Date Rev.	Date
2	10	
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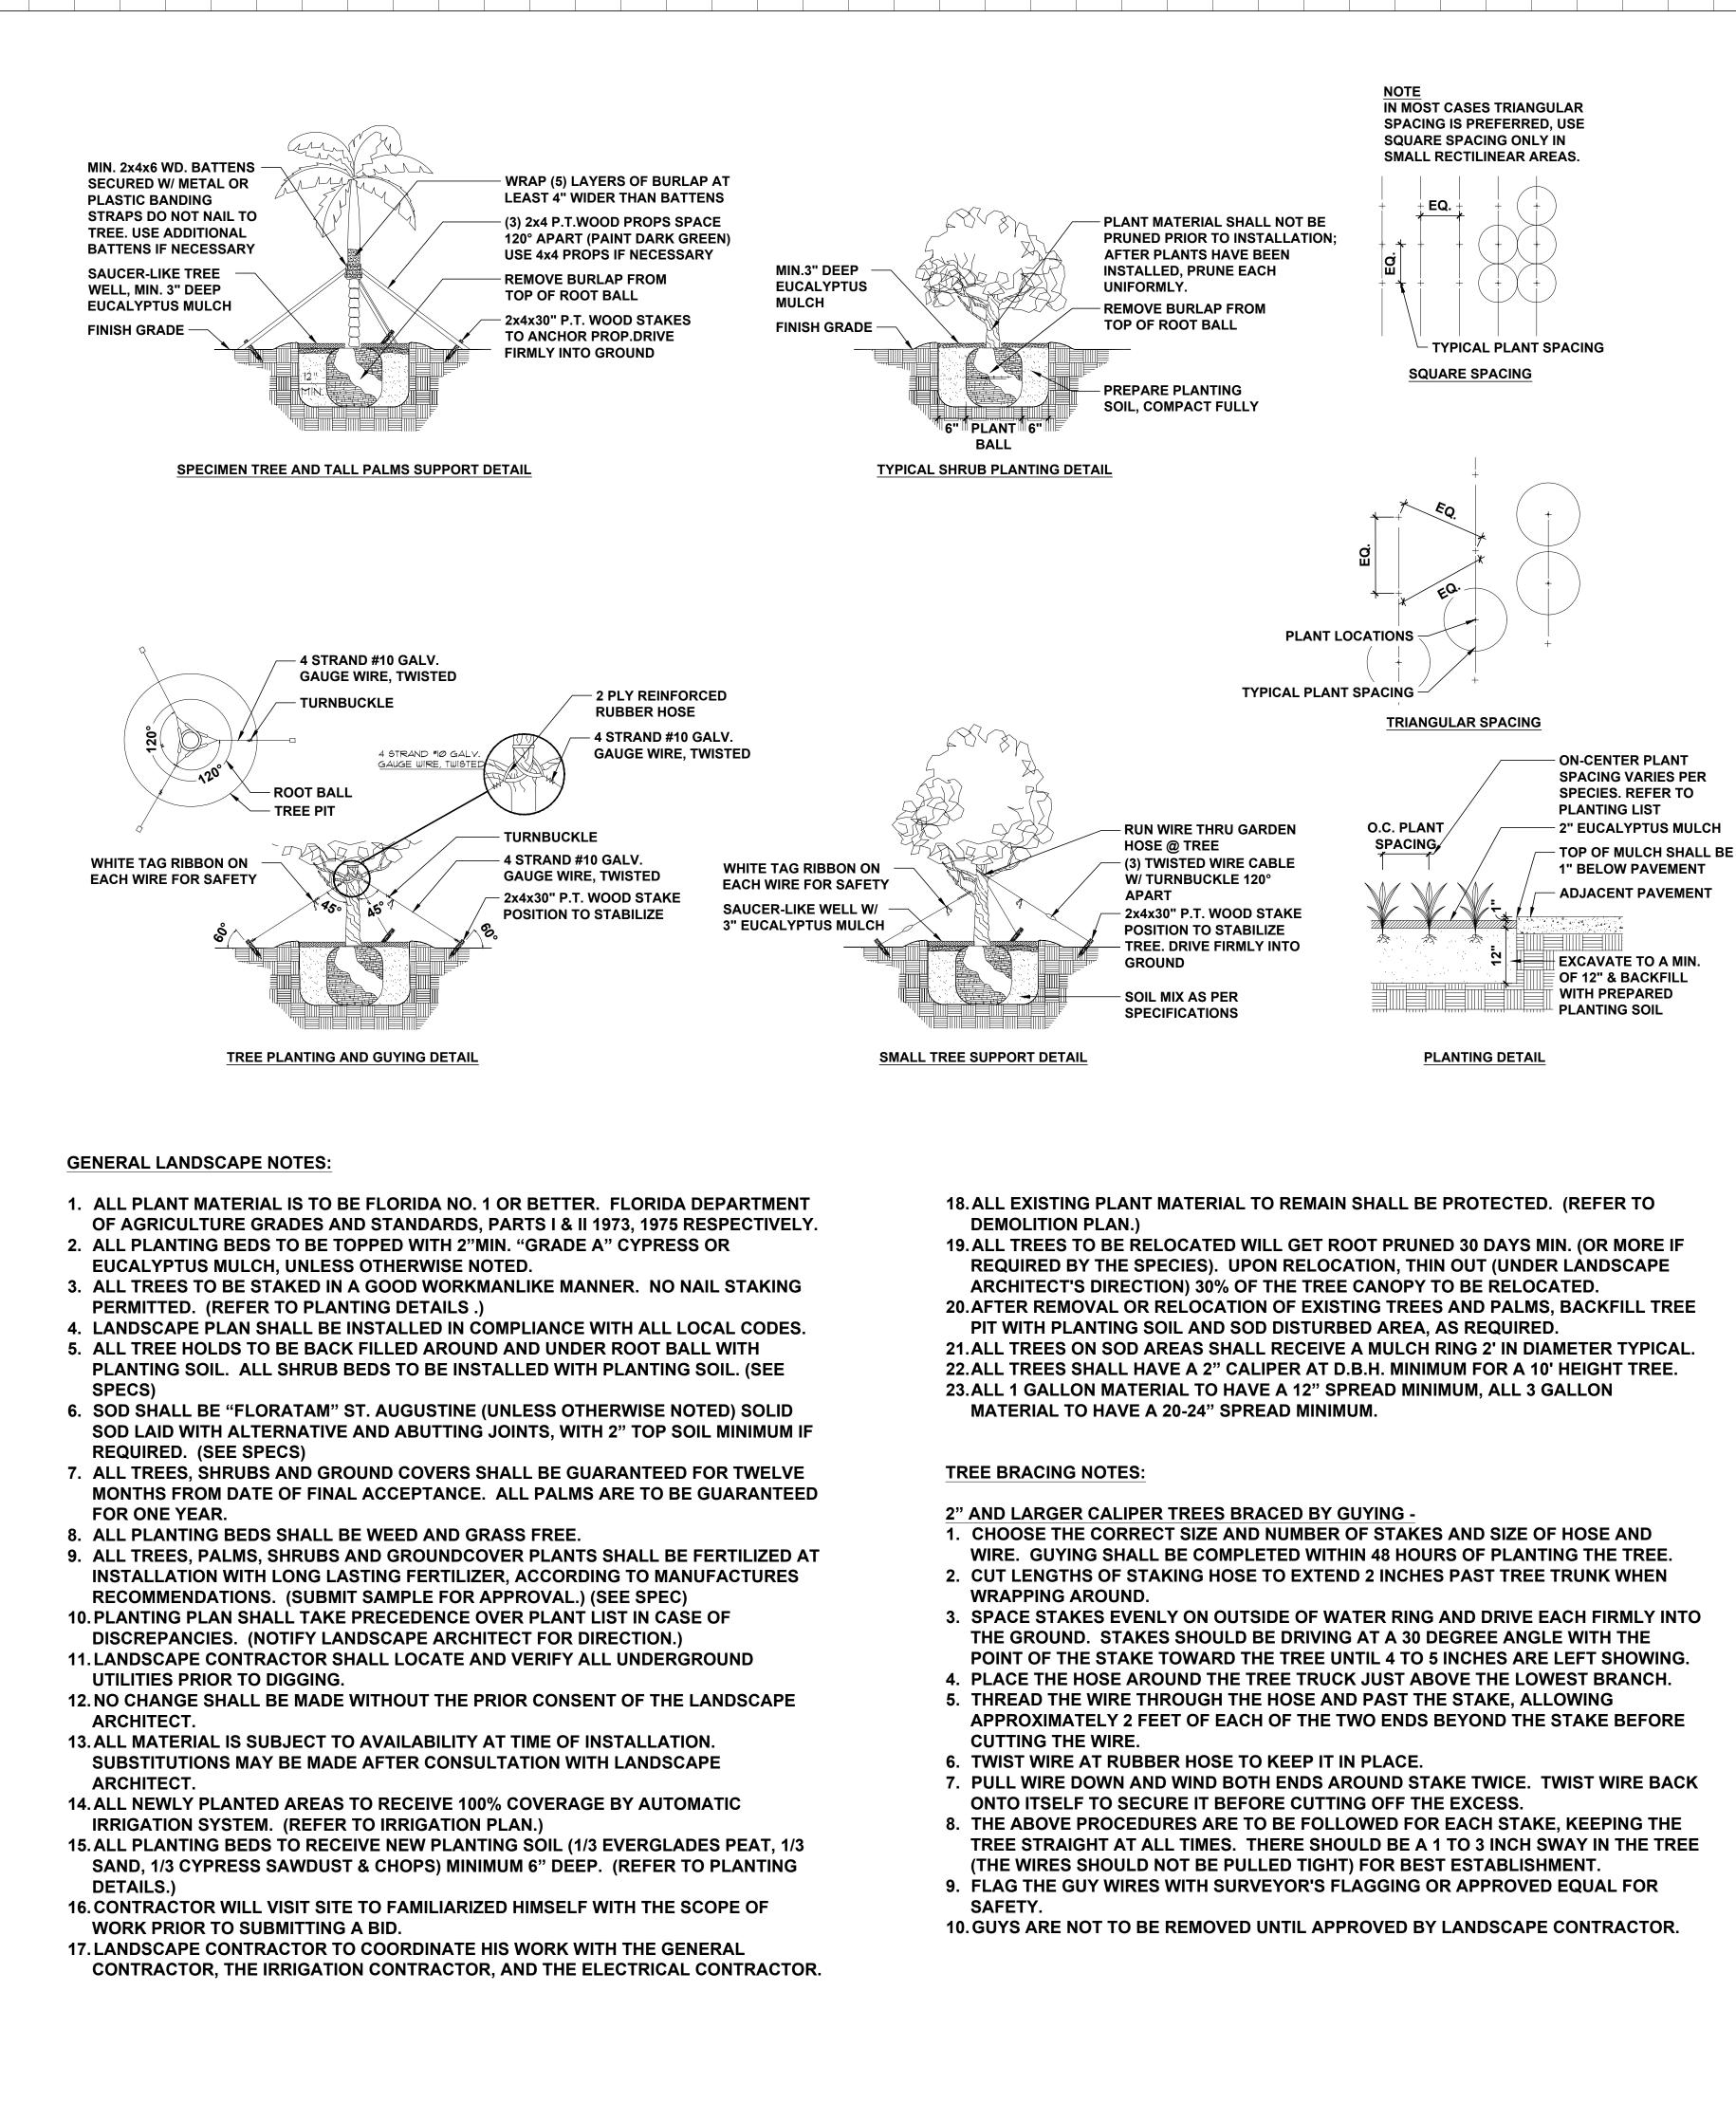
Architect of Record: Kobi Karp Architecture and Interior Design, Inc. 2915 Biscayne Boulevard, Suite #200 Miami, Florida 33137 USA Tel: +1(305) 573 1818 Fax: +1(305) 573 3766

Landscape Architect of Record: David O. Design p.o. box 331615 Coconut Grove, FL. 33233-1615, USA Tel: +1(305) 854.9299 - Fax: +1(305) 854.9882 Email: davidodesign@hotmail.com www.davidodishoo.com



PLANTING CANOPY PLAN

Date: 12-03-2021 Scale : 1/8"=1'-0" Project # : 21024



POINT OF THE STAKE TOWARD THE TREE UNTIL 4 TO 5 INCHES ARE LEFT SHOWING.

APPROXIMATELY 2 FEET OF EACH OF THE TWO ENDS BEYOND THE STAKE BEFORE

TREE STRAIGHT AT ALL TIMES. THERE SHOULD BE A 1 TO 3 INCH SWAY IN THE TREE

		DULE (PROPERTY)	
ative	Qty	Botanical/Common Name	Specifications
Y	2	Chrysophyllum oliviforme Satinleaf Tree	2" DBH. x 12' Ht. x 6' Sp. Min., FL Grade #1 or Better. (See General Note #1 Below)
Y	2	Coccoloba uvifera	4" DBH. x 16' Ht. x 12' Sp. Min., FL Grade #1 or Better;
		Seagrape Cocos nucifera	Alternative: Gumbo Limbo (See General Note #1 Below) 25' Wd., Matching (3 Curved Trunks & 2 Straight Trunks)
N	5	Coconut Palm	(See General Note #1 Below)
Y	1	Myrcianthes fragrans	2" DBH. x 12' Ht. x 6' Sp. Min., FL Grade #1 or Better. (See General Note #1 Below)
		Simpson Stopper Tree	(See General Note #1 Delow)
BAMBO	DS		
Ν	26	Bambusa textilis 'Gracilis' Graceful Bamboo	45 Gal., 15'-18' Ht., Full, 10-15 Canes Min., 6 Ft O.C. (See General Note #1 Below)
SHRUBS Native	GROUN	D COVERS AND VINES Botanical/Common Name	Specifications
	Qıy 22	Agave attenuata	
Ν	22	Spineless Agave	17" Pot (Level 2, Roof Level)
N	20	Agave parryi var truncata Artichoke Agave	10 Gal., Min. (Level 2, Roof Level)
N	7	Alcantarea imperialis	17" Pot (Level 0, Level 2)
	1	Bromeliad Imperialis Barleria repens	3 Gal., 24" O.C. (Roof Floor)
Ν	34	Coral Creeper	3 Gai., 24 O.C. (Roof Floor)
Y	14	Capparis cynophallophora	10-15 Gal. Full to Base, 4'-6' Ht.; Shrub/Bush Form, Multi Stem
		Jamaican Caper Dioon mejiae	(Level 1)
Ν	1	Giant Dioon	4'x4' Min. (Level 0)
Y	144	Ernodea littoralis	3 Gal., 24" O.C. (Level 1, Level 2)
		Golden Creeper Eugenia foetida	
Y	22	Spanish Stopper	45 Gal.,12' Ht.
N	44	Ficus microcarpa 'Green Island'	3 Gal., Min., 24" O.C. (Level 0)
V	24	Ficus Green Island Hymenocallis latifolia	
Y	21	Spider Lily	7 Gal., 30" O.C. (Level 1)
N	122	Liriope muscari 'Big Blue' Big Blue Liriope	3 Gal., 18" O.C. (Level 0)
N	66	Monstera deliciosa	15 Gal., 42" O.C. (Level 0)
IN	00	Swiss Cheese Plant	
Y	302	Nephrolepis exaltata Boston Fern	3 Gal., 24" O.C. (Level 0, Level 1)
Ν	32	Pennisetum setaceum 'Alba'	3 Gal., 30" O.C. (Level 2)
		White Fountain Grass Philodendron 'Burle Marx'	
N	43	Philodendron Burle Marx	3 Gal., 24" O.C. (Level 1)
N	9	Philodendron speciosum	10 Gal. (Level 0)
		Philodendron Speciosum Philodendron 'Weeks Red Hybrid'	
N	10	Philodendron Weeks Red	10 Gal. (Level 1)
N	15	Podocarpus macrophyllus 'Pringles'	15 Gal., 30" O.C., 4ft Ht Min. (Roof Level)
	_	Podocarpus 'Pringles' Serenoa repens	
Y	5	Silver Saw Palmetto	10 Gal., Min. (Level 1)
N	16	Spathiphyllum sp. Peace Lily	7 Gal., Min. (Level 0)
N	9	Tradescantia microfolia 'Argentine Ivy'	
Ν	9	Argentine Ivy	3 Gal., Min., 24" O.C. (Level 2)
Y	10	<i>Viburnum obovatum</i> Walter Viburnum	10 Gal., Min.
		·	
MISCELI Native	ANEOUS	Botanical/Common Name	Specifications
N		Zoysia Sod	Empire (Level 0, Level 1)
REES	IG SCHEI	DULE (RIGHT-OF-WAY)	
Native	Qty	Botanical/Common Name	Specifications
Y	2	Conocarpus erectus 'Sericeus'	4ft Clear Trunk, 12-14ft Overall Height, 3in Min. Caliper,
	_	Silver Buttonwood Tree	2in DBH, Single Leader, Florida Grade #1
MISCELI	ANEOUS)	
Native	Qty	Botanical/Common Name	Specifications
N	362 S.F.	Zoysia Sod in Right-of-Way	Empire
		TERIAL	
TREES	<u> </u>		
<u>Tree #</u> 2, 4, 6, 8,	Qty	Botanical/Common Name Adonidia merrillii	Specifications
14	5	Christmas Palm	Refer to Sheets LR-200
33, 34, 35, 36	4	Callophyllum antillanum	Refer to Sheets LR-200
35, 36	4	Brazillian Beautyleaf Coccothrinax miraguama	
32	1	Miraguama Palm	Refer to Sheets LR-200
23	1	Dracaena reflexa Song of India	Refer to Sheets LR-200
3, 5, 7, 9,		Elaeocarpus decipiens	
10, 13,	9	Japanese Blueberry	Refer to Sheets LR-200
5, 16, 18	_	Guaicum sanctum	
30, 31	2	Lignum Vitae	Refer to Sheets LR-200
11	1	Phoenix dactylifera	Refer to Sheets LR-200
4 15	-	Date Palm Quercus virginiana	
1, 12	2	Live Oak	Refer to Sheets LR-200
29	1	Tabebuia caraiba Silver Trumpet Tree	Refer to Sheets LR-200
		Silver Trumpet Tree	
SENERA			
1		Contractor shall provide photographic submi al prior to purchasing plants.	ttal with person for scale reference to Landscape Architect for review
2		Architect to approve all specimen trees & pa	Ims in person.
		ations to approved on site by Landscape Arc	
4	rinal drade	s shall be approved in the field by Landscape	e Architect prior to planting.

		DULE (PROPERTY)	
ative	Qty	Botanical/Common Name	Specifications
Y	2	Chrysophyllum oliviforme Satinleaf Tree	2" DBH. x 12' Ht. x 6' Sp. Min., FL Grade #1 or Better. (See General Note #1 Below)
Y	2	Coccoloba uvifera	4" DBH. x 16' Ht. x 12' Sp. Min., FL Grade #1 or Better;
N		Seagrape Cocos nucifera	Alternative: Gumbo Limbo (See General Note #1 Below) 25' Wd., Matching (3 Curved Trunks & 2 Straight Trunks)
Ν	5	Coconut Palm	(See General Note #1 Below)
Y	1	Myrcianthes fragrans Simpson Stopper Tree	2" DBH. x 12' Ht. x 6' Sp. Min., FL Grade #1 or Better. (See General Note #1 Below)
AMBO	20	· · · · · · · · · · · · · · · · · · ·	
		Bambusa textilis 'Gracilis'	45 Gal., 15'-18' Ht., Full, 10-15 Canes Min., 6 Ft O.C.
Ν	26	Graceful Bamboo	(See General Note #1 Below)
HRUBS	, GROUN	ID COVERS AND VINES	
Native	Qty	Botanical/Common Name	Specifications
Ν	22	Agave attenuata Spineless Agave	17" Pot (Level 2, Roof Level)
Ν	20	Agave parryi var truncata	10 Gal., Min. (Level 2, Roof Level)
		Artichoke Agave Alcantarea imperialis	
N	7	Bromeliad Imperialis	17" Pot (Level 0, Level 2)
N	34	Barleria repens Coral Creeper	3 Gal., 24" O.C. (Roof Floor)
Y	14	Capparis cynophallophora	10-15 Gal. Full to Base, 4'-6' Ht.; Shrub/Bush Form, Multi Stem
		Jamaican Caper Dioon mejiae	(Level 1)
Ν	1	Giant Dioon	4'x4' Min. (Level 0)
Y	144	Ernodea littoralis Golden Creeper	3 Gal., 24" O.C. (Level 1, Level 2)
Y	22	Eugenia foetida	45 Gal.,12' Ht.
		Spanish Stopper Ficus microcarpa 'Green Island'	
N	44	Ficus Green Island	3 Gal., Min., 24" O.C. (Level 0)
Y	21	Hymenocallis latifolia Spider Lily	7 Gal., 30" O.C. (Level 1)
N	122	Liriope muscari 'Big Blue'	3 Gal., 18" O.C. (Level 0)
		Big Blue Liriope Monstera deliciosa	
N	66	Swiss Cheese Plant	15 Gal., 42" O.C. (Level 0)
Υ	302	Nephrolepis exaltata Boston Fern	3 Gal., 24" O.C. (Level 0, Level 1)
N	32	Pennisetum setaceum 'Alba'	3 Gal., 30" O.C. (Level 2)
		White Fountain Grass Philodendron 'Burle Marx'	
N	43	Philodendron Burle Marx	3 Gal., 24" O.C. (Level 1)
N	9	Philodendron speciosum Philodendron Speciosum	10 Gal. (Level 0)
N	10	Philodendron 'Weeks Red Hybrid'	10 Gal. (Level 1)
		Philodendron Weeks Red Podocarpus macrophyllus 'Pringles'	
N	15	Podocarpus 'Pringles'	15 Gal., 30" O.C., 4ft Ht Min. (Roof Level)
Y	5	Serenoa repens Silver Saw Palmetto	10 Gal., Min. (Level 1)
N	16	Spathiphyllum sp.	7 Gal., Min. (Level 0)
	10	Peace Lily Tradescantia microfolia 'Argentine Ivy'	
Ν	9	Argentine Ivy	3 Gal., Min., 24" O.C. (Level 2)
Y	10	<i>Viburnum obovatum</i> Walter Viburnum	10 Gal., Min.
AISCELI Native	ANEOUS	Botanical/Common Name	Specifications
N		Zoysia Sod	Empire (Level 0, Level 1)
		DULE (RIGHT-OF-WAY)	
REES		DOLE (RIGHT-OF-WAT)	
Native	Qty	Botanical/Common Name	Specifications
Y	2	Conocarpus erectus 'Sericeus' Silver Buttonwood Tree	4ft Clear Trunk, 12-14ft Overall Height, 3in Min. Caliper, 2in DBH, Single Leader, Florida Grade #1
		•	
Native	ANEOUS	Botanical/Common Name	Specifications
N	362 S.F.	Zoysia Sod in Right-of-Way	Empire
REES			
ree #	Qty	Botanical/Common Name	Specifications
, 4, 6, 8, 14	5	Adonidia merrillii Christmas Palm	Refer to Sheets LR-200
33, 34,	4	Callophyllum antillanum	Refer to Sheets LR-200
35, 36		Brazillian Beautyleaf Coccothrinax miraguama	
32	1	Miraguama Palm	Refer to Sheets LR-200
23	1	Dracaena reflexa Song of India	Refer to Sheets LR-200
, 5, 7, 9,		Elaeocarpus decipiens	
10, 13, 5, 16, 18	9	Japanese Blueberry	Refer to Sheets LR-200
30, 31	2	Guaicum sanctum	Refer to Sheets LR-200
	2	Lignum Vitae Phoenix dactylifera	
11	1	Date Palm	Refer to Sheets LR-200
1, 12	2	Quercus virginiana	Refer to Sheets LR-200
	4	Live Oak Tabebuia caraiba	Befor to Shoota L D 200
29	1	Silver Trumpet Tree	Refer to Sheets LR-200
ENERA		3	
1		Contractor shall provide photographic submi al prior to purchasing plants.	ittal with person for scale reference to Landscape Architect for review
2		Architect to approve all specimen trees & pa	Ilms in person.
3	All plant loc	ations to approved on site by Landscape Arc	chitect.
4	rinal grade	s shall be approved in the field by Landscape	e Architect prior to planting.

	NG SCHE	DULE (PROPERTY)	
	& PALMS		
ative	Qty	Botanical/Common Name Chrysophyllum oliviforme	2" DBH. x 12' Ht. x 6' Sp. Min., FL Grade #1 or Better.
Y	2	Satinleaf Tree	(See General Note #1 Below)
Y	2	Coccoloba uvifera Seagrape	4" DBH. x 16' Ht. x 12' Sp. Min., FL Grade #1 or Better; Alternative: Gumbo Limbo (See General Note #1 Below)
N	5	Cocos nucifera	25' Wd., Matching (3 Curved Trunks & 2 Straight Trunks)
V		Coconut Palm Myrcianthes fragrans	(See General Note #1 Below) 2" DBH. x 12' Ht. x 6' Sp. Min., FL Grade #1 or Better.
Y	1	Simpson Stopper Tree	(See General Note #1 Below)
AMBO	OS		
N	26	Bambusa textilis 'Gracilis'	45 Gal., 15'-18' Ht., Full, 10-15 Canes Min., 6 Ft O.C.
		Graceful Bamboo	(See General Note #1 Below)
	ŕ	ID COVERS AND VINES	
Native	Qty 22	Botanical/Common Name Agave attenuata	Specifications
Ν	22	Spineless Agave	17" Pot (Level 2, Roof Level)
Ν	20	Agave parryi var truncata Artichoke Agave	10 Gal., Min. (Level 2, Roof Level)
N	7	Alcantarea imperialis	17" Pot (Level 0, Level 2)
		Bromeliad Imperialis Barleria repens	3 Gal., 24" O.C. (Roof Floor)
N	34	Coral Creeper	
Y	14	Capparis cynophallophora Jamaican Caper	10-15 Gal. Full to Base, 4'-6' Ht.; Shrub/Bush Form, Multi Stem (Level 1)
N	1	Dioon mejiae	4'x4' Min. (Level 0)
	,	Giant Dioon Ernodea littoralis	3 Gal., 24" O.C. (Level 1, Level 2)
Y	144	Golden Creeper	3 Gal., 24 0.0. (Level 1, Level 2)
Y	22	Eugenia foetida	45 Gal.,12' Ht.
N1		Spanish Stopper Ficus microcarpa 'Green Island'	
N	44	Ficus Green Island	3 Gal., Min., 24" O.C. (Level 0)
Y	21	Hymenocallis latifolia Spider Lily	7 Gal., 30" O.C. (Level 1)
N	122	Liriope muscari 'Big Blue'	3 Gal., 18" O.C. (Level 0)
		Big Blue Liriope Monstera deliciosa	
Ν	66	Swiss Cheese Plant	15 Gal., 42" O.C. (Level 0)
Y	302	Nephrolepis exaltata Boston Fern	3 Gal., 24" O.C. (Level 0, Level 1)
N	32	Pennisetum setaceum 'Alba'	3 Gal., 30" O.C. (Level 2)
		White Fountain Grass Philodendron 'Burle Marx'	
Ν	43	Philodendron Burle Marx	3 Gal., 24" O.C. (Level 1)
N	9	Philodendron speciosum	10 Gal. (Level 0)
N	10	Philodendron Speciosum Philodendron 'Weeks Red Hybrid'	
Ν	10	Philodendron Weeks Red	10 Gal. (Level 1)
Ν	15	Podocarpus macrophyllus 'Pringles' Podocarpus 'Pringles'	15 Gal., 30" O.C., 4ft Ht Min. (Roof Level)
Y	5	Serenoa repens	10 Gal., Min. (Level 1)
		Silver Saw Palmetto Spathiphyllum sp.	
Ν	16	Peace Lily	7 Gal., Min. (Level 0)
Ν	9	Tradescantia microfolia 'Argentine Ivy' Argentine Ivy	3 Gal., Min., 24" O.C. (Level 2)
Y	10	Viburnum obovatum	10 Gal., Min.
	10	Walter Viburnum	
IISCEL	LANEOUS	3	
Native N	Qty	Botanical/Common Name Zoysia Sod	Specifications Empire (Level 0, Level 1)
	1,750 0.1 .		
	NG SCHE	DULE (RIGHT-OF-WAY)	
REES Native	Qty	Botanical/Common Name	Specifications
	City		
	2	Conocarpus erectus 'Sericeus'	4ft Clear Trunk, 12-14ft Overall Height, 3in Min. Caliper,
Y	2		
Y	2 LANEOUS	Conocarpus erectus 'Sericeus' Silver Buttonwood Tree	4ft Clear Trunk, 12-14ft Overall Height, 3in Min. Caliper,
Y IISCEL Native	LANEOUS Qty	Conocarpus erectus 'Sericeus' Silver Buttonwood Tree Botanical/Common Name	4ft Clear Trunk, 12-14ft Overall Height, 3in Min. Caliper, 2in DBH, Single Leader, Florida Grade #1 Specifications
Y	LANEOUS	Conocarpus erectus 'Sericeus' Silver Buttonwood Tree	4ft Clear Trunk, 12-14ft Overall Height, 3in Min. Caliper, 2in DBH, Single Leader, Florida Grade #1
Y IISCEL Native N ELOCA	LANEOUS Qty	Conocarpus erectus 'Sericeus' Silver Buttonwood Tree Botanical/Common Name Zoysia Sod in Right-of-Way	4ft Clear Trunk, 12-14ft Overall Height, 3in Min. Caliper, 2in DBH, Single Leader, Florida Grade #1 Specifications
Y IISCEL Native N ELOCA REES	ATED MA	Conocarpus erectus 'Sericeus' Silver Buttonwood Tree Botanical/Common Name Zoysia Sod in Right-of-Way	4ft Clear Trunk, 12-14ft Overall Height, 3in Min. Caliper, 2in DBH, Single Leader, Florida Grade #1 Specifications Empire
Y IISCELI Native N ELOCA REES ree # , 4, 6, 8,	ANEOUS Qty 362 S.F. ATED MA	Conocarpus erectus 'Sericeus' Silver Buttonwood Tree Botanical/Common Name Zoysia Sod in Right-of-Way	4ft Clear Trunk, 12-14ft Overall Height, 3in Min. Caliper, 2in DBH, Single Leader, Florida Grade #1 Specifications Empire Specifications
Y IISCEL Native N ELOCA REES ree # 4, 6, 8, 14	LANEOUS Qty 362 S.F. ATED MA ^T Qty	Conocarpus erectus 'Sericeus' Silver Buttonwood Tree Botanical/Common Name Zoysia Sod in Right-of-Way FERIAL Botanical/Common Name Adonidia merrillii Christmas Palm	4ft Clear Trunk, 12-14ft Overall Height, 3in Min. Caliper, 2in DBH, Single Leader, Florida Grade #1 Specifications Empire
Y IISCEL Native N ELOCA REES ree # , 4, 6, 8, 14 33, 34,	ANEOUS Qty 362 S.F. ATED MA	Conocarpus erectus 'Sericeus' Silver Buttonwood Tree Botanical/Common Name Zoysia Sod in Right-of-Way FERIAL Botanical/Common Name Adonidia merrillii	4ft Clear Trunk, 12-14ft Overall Height, 3in Min. Caliper, 2in DBH, Single Leader, Florida Grade #1 Specifications Empire Specifications
Y IISCEL Native N ELOCA REES ee # 4, 6, 8, 14 33, 34,	LANEOUS Qty 362 S.F. ATED MA ^T Qty 5	Conocarpus erectus 'Sericeus' Silver Buttonwood Tree Botanical/Common Name Zoysia Sod in Right-of-Way FERIAL Botanical/Common Name Adonidia merrillii Christmas Palm Callophyllum antillanum Brazillian Beautyleaf Coccothrinax miraguama	4ft Clear Trunk, 12-14ft Overall Height, 3in Min. Caliper, 2in DBH, Single Leader, Florida Grade #1 Specifications Empire Specifications Refer to Sheets LR-200
Y IISCEL Native N ELOCA REES ee # 4, 6, 8, 14 33, 34, 35, 36 32	ATED MA Qty 362 S.F. ATED MA Qty 5 4 1	Conocarpus erectus 'Sericeus' Silver Buttonwood Tree Botanical/Common Name Zoysia Sod in Right-of-Way FERIAL Botanical/Common Name Adonidia merrillii Christmas Palm Callophyllum antillanum Brazillian Beautyleaf	4ft Clear Trunk, 12-14ft Overall Height, 3in Min. Caliper, 2in DBH, Single Leader, Florida Grade #1 Specifications Empire Specifications Refer to Sheets LR-200 Refer to Sheets LR-200 Refer to Sheets LR-200 Refer to Sheets LR-200
Y ISCEL Native N ELOCA REES ee # 4, 6, 8, 14 33, 34, 35, 36 32 23	ATED MAT	Conocarpus erectus 'Sericeus' Silver Buttonwood Tree Botanical/Common Name Zoysia Sod in Right-of-Way FERIAL Botanical/Common Name Adonidia merrillii Christmas Palm Callophyllum antillanum Brazillian Beautyleaf Coccothrinax miraguama Miraguama Palm Dracaena reflexa Song of India	4ft Clear Trunk, 12-14ft Overall Height, 3in Min. Caliper, 2in DBH, Single Leader, Florida Grade #1 Specifications Empire Specifications Refer to Sheets LR-200 Refer to Sheets LR-200
Y ISCEL Native N ELOCA REES ee # 4, 6, 8, 14 33, 34, 35, 36 32 23 5, 7, 9,	ATED MA Qty 362 S.F. ATED MA Qty 5 4 1	Conocarpus erectus 'Sericeus' Silver Buttonwood Tree Botanical/Common Name Zoysia Sod in Right-of-Way FERIAL Botanical/Common Name Adonidia merrillii Christmas Palm Callophyllum antillanum Brazillian Beautyleaf Coccothrinax miraguama Miraguama Palm Dracaena reflexa Song of India Elaeocarpus decipiens	4ft Clear Trunk, 12-14ft Overall Height, 3in Min. Caliper, 2in DBH, Single Leader, Florida Grade #1 Specifications Empire Specifications Refer to Sheets LR-200 Refer to Sheets LR-200 Refer to Sheets LR-200 Refer to Sheets LR-200
Y IISCEL Native N ELOCA REES ee # 4, 6, 8, 14 33, 34, 35, 36 32 23 5, 7, 9, 10, 13,	AREOUS Qty 362 S.F. ATED MA Qty 5 4 1 1 1 9	Conocarpus erectus 'Sericeus' Silver Buttonwood Tree Botanical/Common Name Zoysia Sod in Right-of-Way FERIAL Botanical/Common Name Adonidia merrillii Christmas Palm Callophyllum antillanum Brazillian Beautyleaf Coccothrinax miraguama Miraguama Palm Dracaena reflexa Song of India Elaeocarpus decipiens Japanese Blueberry	4ft Clear Trunk, 12-14ft Overall Height, 3in Min. Caliper, 2in DBH, Single Leader, Florida Grade #1 Specifications Empire Specifications Refer to Sheets LR-200
Y IISCEL Native N ELOCA REES ee # 4, 6, 8, 14 33, 34, 35, 36 32 23 , 5, 7, 9, 10, 13, 5, 16, 18	AREOUS Qty 362 S.F. ATED MA Qty 5 4 1 1 1 9	Conocarpus erectus 'Sericeus' Silver Buttonwood Tree Botanical/Common Name Zoysia Sod in Right-of-Way FERIAL Botanical/Common Name Adonidia merrillii Christmas Palm Callophyllum antillanum Brazillian Beautyleaf Coccothrinax miraguama Miraguama Palm Dracaena reflexa Song of India Elaeocarpus decipiens Japanese Blueberry Guaicum sanctum	4ft Clear Trunk, 12-14ft Overall Height, 3in Min. Caliper, 2in DBH, Single Leader, Florida Grade #1 Specifications Empire Specifications Refer to Sheets LR-200
Y IISCEL Native N ELOCA REES ee # 4, 6, 8, 14 33, 34, 35, 36 32 23 , 5, 7, 9, 10, 13, 5, 16, 18 30, 31	LANEOUS Qty 362 S.F. ATED MA ^T Qty 5 4 1 1 9 2	Conocarpus erectus 'Sericeus' Silver Buttonwood Tree Botanical/Common Name Zoysia Sod in Right-of-Way FERIAL Botanical/Common Name Adonidia merrillii Christmas Palm Callophyllum antillanum Brazillian Beautyleaf Coccothrinax miraguama Miraguama Palm Dracaena reflexa Song of India Elaeocarpus decipiens Japanese Blueberry	4ft Clear Trunk, 12-14ft Overall Height, 3in Min. Caliper, 2in DBH, Single Leader, Florida Grade #1 Specifications Empire Specifications Refer to Sheets LR-200
Y IISCEL Native N EELOCA REES ree # , 4, 6, 8, 14 33, 34, 35, 36 32 23 , 5, 7, 9, 10, 13,	LANEOUS Qty 362 S.F. ATED MA Qty 5 4 1 1 1 9	Conocarpus erectus 'Sericeus' Silver Buttonwood Tree Botanical/Common Name Zoysia Sod in Right-of-Way FERIAL Botanical/Common Name Adonidia merrillii Christmas Palm Callophyllum antillanum Brazillian Beautyleaf Coccothrinax miraguama Miraguama Palm Dracaena reflexa Song of India Elaeocarpus decipiens Japanese Blueberry Guaicum sanctum Lignum Vitae Phoenix dactylifera Date Palm	4ft Clear Trunk, 12-14ft Overall Height, 3in Min. Caliper, 2in DBH, Single Leader, Florida Grade #1 Specifications Empire Specifications Refer to Sheets LR-200
Y IISCEL Native N ELOCA REES ee # 4, 6, 8, 14 33, 34, 35, 36 32 23 , 5, 7, 9, 10, 13, 5, 16, 18 30, 31	LANEOUS Qty 362 S.F. ATED MA ^T Qty 5 4 1 1 9 2	Conocarpus erectus 'Sericeus' Silver Buttonwood Tree Botanical/Common Name Zoysia Sod in Right-of-Way FERIAL Botanical/Common Name Adonidia merrillii Christmas Palm Christmas Palm Christmas Palm Callophyllum antillanum Brazillian Beautyleaf Coccothrinax miraguama Miraguama Palm Dracaena reflexa Song of India Elaeocarpus decipiens Japanese Blueberry Guaicum sanctum Lignum Vitae Phoenix dactylifera	4ft Clear Trunk, 12-14ft Overall Height, 3in Min. Caliper, 2in DBH, Single Leader, Florida Grade #1 Specifications Empire Specifications Refer to Sheets LR-200
Y IISCEL Native N ELOCA REES ree # , 4, 6, 8, 14 33, 34, 35, 36 32 23 , 5, 7, 9, 10, 13, 5, 16, 18 30, 31 11	LANEOUS Qty 362 S.F. ATED MA ⁻ Qty 5 4 1 1 9 2 1	Conocarpus erectus 'Sericeus' Silver Buttonwood Tree Botanical/Common Name Zoysia Sod in Right-of-Way FERIAL Botanical/Common Name Adonidia merrillii Christmas Palm Callophyllum antillanum Brazillian Beautyleaf Coccothrinax miraguama Miraguama Palm Dracaena reflexa Song of India Elaeocarpus decipiens Japanese Blueberry Guaicum sanctum Lignum Vitae Phoenix dactylifera Date Palm Quercus virginiana Live Oak Tabebuia caraiba	4ft Clear Trunk, 12-14ft Overall Height, 3in Min. Caliper, 2in DBH, Single Leader, Florida Grade #1 Specifications Empire Specifications Refer to Sheets LR-200
Y IISCEL Native N ELOCA REES ree # , 4, 6, 8, 14 33, 34, 35, 36 32 23 , 5, 7, 9, 10, 13, 5, 16, 18 30, 31 11 1, 12	LANEOUS Qty 362 S.F. ATED MA ⁻ Qty 5 4 1 1 9 2 1 2 1 2	Conocarpus erectus 'Sericeus' Silver Buttonwood Tree Botanical/Common Name Zoysia Sod in Right-of-Way FERIAL Botanical/Common Name Adonidia merrillii Christmas Palm Callophyllum antillanum Brazillian Beautyleaf Coccothrinax miraguama Miraguama Palm Dracaena reflexa Song of India Elaeocarpus decipiens Japanese Blueberry Guaicum sanctum Lignum Vitae Phoenix dactylifera Date Palm Quercus virginiana Live Oak	4ft Clear Trunk, 12-14ft Overall Height, 3in Min. Caliper, 2in DBH, Single Leader, Florida Grade #1 Specifications Empire Specifications Refer to Sheets LR-200
Y IISCEL Native N ELOCA REES ree # 4, 6, 8, 14 33, 34, 35, 36 32 23 , 5, 7, 9, 10, 13, 5, 16, 18 30, 31 11 1, 12 29	LANEOUS Qty 362 S.F. ATED MA ^T Qty 5 4 1 1 9 2 1 2 1 2 1 2 1 2 1	Conocarpus erectus 'Sericeus' Silver Buttonwood Tree Botanical/Common Name Zoysia Sod in Right-of-Way FERIAL Botanical/Common Name Adonidia merrillii Christmas Palm Callophyllum antillanum Brazillian Beautyleaf Coccothrinax miraguama Miraguama Palm Dracaena reflexa Song of India Elaeocarpus decipiens Japanese Blueberry Guaicum sanctum Lignum Vitae Phoenix dactylifera Date Palm Quercus virginiana Live Oak Tabebuia caraiba Silver Trumpet Tree	4ft Clear Trunk, 12-14ft Overall Height, 3in Min. Caliper, 2in DBH, Single Leader, Florida Grade #1 Specifications Empire Specifications Refer to Sheets LR-200
Y IISCELI Native N ELOCA REES ee # 4, 6, 8, 14 33, 34, 35, 36 32 23 , 5, 7, 9, 10, 13, 5, 16, 18 30, 31 11 1, 12 29	LANEOUS Qty 362 S.F. ATED MA ^T Qty 5 4 1 1 9 2 1 2 1 2 1 AL NOTES Landscape	Conocarpus erectus 'Sericeus' Silver Buttonwood Tree Botanical/Common Name Zoysia Sod in Right-of-Way FERIAL Botanical/Common Name Adonidia merrillii Christmas Palm Callophyllum antillanum Brazillian Beautyleaf Coccothrinax miraguama Miraguama Palm Dracaena reflexa Song of India Elaeocarpus decipiens Japanese Blueberry Guaicum sanctum Lignum Vitae Phoenix dactylifera Date Palm Quercus virginiana Live Oak Tabebuia caraiba Silver Trumpet Tree	4ft Clear Trunk, 12-14ft Overall Height, 3in Min. Caliper, 2in DBH, Single Leader, Florida Grade #1 Specifications Empire Specifications Refer to Sheets LR-200
Y IISCEL Native N ELOCA REES ree # , 4, 6, 8, 14 33, 34, 35, 36 32 23 , 5, 7, 9, 10, 13, 5, 16, 18 30, 31 11 1, 12 29 ENERA 1 2	LANEOUS Qty 362 S.F. ATED MA ^T Qty 5 4 1 1 9 2 1 2 1 2 1 AL NOTES Landscape and approv Landscape	Conocarpus erectus 'Sericeus' Silver Buttonwood Tree Botanical/Common Name Zoysia Sod in Right-of-Way FERIAL Botanical/Common Name Adonidia merrillii Christmas Palm Callophyllum antillanum Brazillian Beautyleaf Coccothrinax miraguama Miraguama Palm Dracaena reflexa Song of India Elaeocarpus decipiens Japanese Blueberry Guaicum sanctum Lignum Vitae Phoenix dactylifera Date Palm Quercus virginiana Live Oak Tabebuia caraiba Silver Trumpet Tree	4ft Clear Trunk, 12-14ft Overall Height, 3in Min. Caliper, 2in DBH, Single Leader, Florida Grade #1 Specifications Empire Specifications Refer to Sheets LR-200 main person for scale reference to Landscape Architect for review ms in person.
Y IISCEL Native N ELOC/ REES ree # 4, 6, 8, 14 33, 34, 35, 36 32 23 , 5, 7, 9, 10, 13, 5, 16, 18 30, 31 11 1, 12 29 ENER/ 1 2 3	LANEOUS Qty 362 S.F. ATED MA ^T Qty 5 4 1 1 9 2 1 2 1 2 1 Landscape and approv Landscape All plant loc	Conocarpus erectus 'Sericeus' Silver Buttonwood Tree Botanical/Common Name Zoysia Sod in Right-of-Way FERIAL Botanical/Common Name Adonidia merrillii Christmas Palm Callophyllum antillanum Brazillian Beautyleaf Coccothrinax miraguama Miraguama Palm Dracaena reflexa Song of India Elaeocarpus decipiens Japanese Blueberry Guaicum sanctum Lignum Vitae Phoenix dactylifera Date Palm Quercus virginiana Live Oak Tabebuia caraiba Silver Trumpet Tree	4ft Clear Trunk, 12-14ft Overall Height, 3in Min. Caliper, 2in DBH, Single Leader, Florida Grade #1 Specifications Empire Specifications Refer to Sheets LR-200 Ital with person for scale reference to Landscape Architect for review ms in person. hitect.
Y IISCEL Native N ELOCA REES ree # , 4, 6, 8, 14 33, 34, 35, 36 32 23 , 5, 7, 9, 10, 13, 5, 16, 18 30, 31 11 1, 12 29 ENERA 1 2	LANEOUS Qty 362 S.F. ATED MA ^T Qty 5 4 1 1 9 2 1 2 1 2 1 AL NOTES Landscape and approv Landscape All plant loc Final grade Landscape	Conocarpus erectus 'Sericeus' Silver Buttonwood Tree Botanical/Common Name Zoysia Sod in Right-of-Way FERIAL Botanical/Common Name Adonidia merrillii Christmas Palm Callophyllum antillanum Brazillian Beautyleaf Coccothrinax miraguama Miraguama Palm Dracaena reflexa Song of India Elaeocarpus decipiens Japanese Blueberry Guaicum sanctum Lignum Vitae Phoenix dactylifera Date Palm Quercus virginiana Live Oak Tabebuia caraiba Silver Trumpet Tree Contractor shall provide photographic submit al prior to purchasing plants. Architect to approve all specimen trees & pal ations to approved on site by Landscape Arc schall be approved in the field by Landscape contractor to coordinate installation with Land	4ft Clear Trunk, 12-14ft Overall Height, 3in Min. Caliper, 2in DBH, Single Leader, Florida Grade #1 Specifications Empire Specifications Refer to Sheets LR-200 Ital with person for scale reference to Landscape Architect for review ms in person. hitect.

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DRB SUBMITTAL

PRIVATE RESIDENCE

11 EAST RIVO ALTO DRIVE MIAMI BEACH, FL 33139

Owner: PRIVATE RESIDENCE **Consultant:** Name Address Address Tel: Email Consultant: Name Address Address Tel: Email Architect of Record: Kobi Karp Architecture and Interior Design, Inc. 2915 Biscayne Boulevard, Suite #200 Miami, Florida 33137 USA Tel: +1(305) 573 1818 Fax: +1(305) 573 3766 Landscape Architect of Record: David O. Design p.o. box 331615 Coconut Grove, FL. 33233-1615, USA Tel: +1(305) 854.9299 - Fax: +1(305) 854.9882 Email: davidodesign@hotmail.com www.davidodishoo.com

landscape architecture DAVID J. ODISHOO RLA #6666969

PLANTING SCHEDULE, DETAILS, & NOTES

Date: 12-03-2021 Scale : Project #: 21024

TREE NUMBER	COMMON NAME	SCIENTIFIC NAME	DIAMETER (INCHES)	HEIGHT (FT)	CANOPY (FT)
17	Christmas Palm	Adonidia merrillii	5	24	8
_	Int of Palms to be Mitigated =				
MITIGAT	INT of Palms to be Mitigated =		PROVIDED		

NATIVE	QUANTITY	BOTANICAL/COMMONG NAME	SPECIFICATIONS	
Y	2	Chrysophyllum oliviforme Satinleaf Tree	2" DBH. x 12' Ht. x 6' Sp. Min., FL Grade #1 or Better.	
Y	2	Coccoloba uvifera Seagrape	4" DBH. x 16' Ht. x 12' Sp. Min., FL Grade #1 or Better.	
Y	1	<i>Myrcianthes fragrans</i> Simpson Stopper Tree	2" DBH. x 12' Ht. x 6' Sp. Min., FL Grade #1 or Better.	
Total Tre	es Required	= 1 Trees at 12ft Ht. x 2in D.B.H. Min.		
Total Tre	es Provided	= 3 Trees at 12ft Ht. x 2in D.B.H. Min.		
		2 Trees at 16ft Ht. x 4in D.B.H. Min.		

CITY OF MIAMI BEACH

LANDSCAPE LEGEND

OPEN SPACE

- A. Square feet of required Open Space as indica Lot Area = <u>12,900</u> s.f.x <u>50</u> % = _
- B. Square feet of parking lot open space requir Number of parking spaces <u>N/A</u> x 10 s.f. p
- C. Total square feet of landscaped open space r

LAWN AREA CALCULATION

A. Square feet of landscaped open space require B. Maximum lawn area (sod) permitted= <u>5</u>

TREES

- A. Number of trees required per lot or net lot a trees meeting minimum requirements= ______ trees x _____N/A ___ net lot acres -
- B. % Natives required: Number of trees provide C. % Low maintenance / drought and salt tolera
- Number of trees provided x 50%= D. Street Trees (maximum average spacing of
- 49.5 linear feet along street divide E. Street tree species allowed directly beneath (maximum average spacing of 20' o.c.):

<u>SHRUBS</u>

- A. Number of shrubs required: Sum of lot and s
- B. % Native shrubs required: Number of shrubs

LARGE SHRUBS OR SMALL TREES

- A. Number of large shrubs or small trees requir x 10%=
- B. % Native large shrubs or small trees required small trees provided x 50%=

	LANDSCAPE LEGEND		
	INFORMATION REQUIRED TO BE PERMANENTLY AFFIXED TO PLANS		
		s0.3	
		REQUIRED/	
	OPEN SPACE	ALLOWED	PROVIDED
	Square feet of required Open Space as indicated on site plan:		
	Lot Area = $12,900$ s.f.x 50 % = $6,450$ s.f.	6,450 s.f.	6,299 s.f.
	Square feet of parking lot open space required as indicated on site plan:		
	Number of parking spaces <u>N/A</u> x 10 s.f. parking space =	N/A	N/A
,	Total square feet of landscaped open space required: A+B=	6,450 s.f.	6,299 s.f.
	LAWN AREA CALCULATION	6 450 - 5	6 200 o f
	Square feet of landscaped open space required Maximum lawn area (sod) permitted= <u>50</u> % x <u>6,299</u> s.f.	6,450 s.f.	6,299 s.f.
	$\frac{1}{3} = \frac{1}{3} = \frac{1}$	3,149.50 s.f.	1,758 s.f.
	TREES		
	Number of trees required per lot or net lot acre, less existing number of		24 Total (5 new + 19
	trees meeting minimum requirements=		existing trees to remain &
	12trees xN/A net lot acres - number of existing trees=	12	relocated)
	% Natives required: Number of trees provided x 30% =	8	10 (5 new + 5 existing)
	% Low maintenance / drought and salt tolerant required:	10	18 (5 new + 13 existing)
	Number of trees provided x 50%= Street Trees (maximum average spacing of 20' o.c.)	12	2 (2 of 3 due to conflicts
	49.5 linear feet along street divided by 20'=	3	with Site Visibility Triangles.
	Street tree species allowed directly beneath power lines:		7 Trees planted along Private
	(maximum average spacing of 20' o.c.):		Property Street Frontage.)
	N/A linear feet along street divided by 20'=	N/A	N/A
	<u>SHRUBS</u>		
	Number of shrubs required: Sum of lot and street trees required x 12=	180	804
	% Native shrubs required: Number of shrubs provided x 50%=	402	518
		402	
	LARGE SHRUBS OR SMALL TREES		
	Number of large shrubs or small trees required: Number of required shrubs		
	x 10%=	18	52
	% Native large shrubs or small trees required: Number of large shrubs or	26	07
	small trees provided x 50%=	26	37

Rev.	Date Rev.	Date
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	<u>/1</u>	
4	12	
5	<u>/14</u>	
6	15	
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8	17	

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DRB SUBMITTAL

PRIVATE RESIDENCE

11 EAST RIVO ALTO DRIVE MIAMI BEACH, FL 33139

Owner:

PRIVATE RESIDENCE


Consultant: Name Address Address Tel: Email

Consultant: Name Address Address Tel: Email

Architect of Record: Kobi Karp Architecture and Interior Design, Inc. 2915 Biscayne Boulevard, Suite #200 Miami, Florida 33137 USA Tel: +1(305) 573 1818 Fax: +1(305) 573 3766

Landscape Architect of Record: David O. Design p.o. box 331615 Coconut Grove, FL. 33233-1615, USA Tel: +1(305) 854.9299 - Fax: +1(305) 854.9882 Email: davidodesign@hotmail.com www.davidodishoo.com



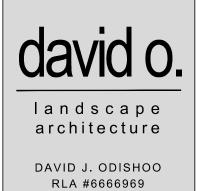

TREE REPLACEMENT SCHEDULE & LANDSCAPE LEGEND

Date: 12-03-2021 Scale :

Project # : 21024

LP-400

Sheet No.