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BUILDING SECTIONS

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PROJECT ADDRESS

253 N COCONUNT LN MIAMI BEACH, FL. 33139

PROJECT PROGRAM

THIS PROJECT CONSISTS OF A SINGLE FAMILY HOME: (2) STORY HOUSE, BASEMENT, AND PARKING GARAGE AT GROUND FLOOR AND ROOF DECK TERRACE.

CONSTRUCTION TYPE : III B

OCCUPANCY GROUP : RESIDENTIAL RS-4

ZONING DISTRICT : RS-4 DISTRICT (SINGLE-FAMILY RESIDENTIAL DISTRICTS)

CODES IN EFFECT

FLORIDA BUILDING CODE, RESIDENTIAL 2020
- BUILDING

- STRUCTURAL - PLUMBING - MECHANICAL

CITY OF MIAMI BEACH ZONING ORDINANCES

TOTAL GROSS AREA : 3,577 SF

PROJECT DATA

ELEVATION INFORMATION:

FEMA FLOOD ZONE : AE

BASE FLOOD ELEVATION: +8.00' NGVD +2.00' FREE BOARD = 10.00' NGVD

ISSUE DATE: 01/03/2022 DRB FINAL SUBMITTAL

No. Date Description

1 12/20/2021 Revision 1

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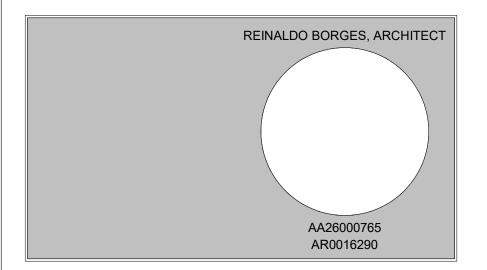
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architecture urban-planning interior-design

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Project Team

### Project Name

## CASA BAHIA

253 N COCONUT LN MIAMI BEACH, FLORIDA, 33139 FOLIO # 02-4205-002-0160

Project Number 21-3600

Drawing Name

INDEX OF DRAWINGS

Scale:

12" = 1'-0"

Drawing Number

A-002

#### **ABBREVIATIONS**

	ANCHOR	НТ	HEIGHT
С	AIR CONDITIONING	HORIZ	HORIZONTAL
COUST	ACOUSTICAL	H.B.	HOSE BIBB
P	ACOUSTICAL CEILING PANEL	I.D.	INTERIOR DIMENSION
F.F.	ABOVE FINISH FLOOR	INSUL.	INSULATION
OR ALUM	ALUMINUM	INTERM	INTERMEDIATE
IOD.	ANODIZE	JAN.	JANITOR
)	BOARD	MANUF.	MANUFACTURER
F.F.	BELOW FINISH FLOOR	MAT	MATERIAL
K'G	BLOCKING	MAX	MAXIMUM
K	BLOCK	MIN	MINIMUM
EM	CEMENT	MTL	METAL
ER .	CERAMIC	NIC	NOT IN CONTRACT
F.V.	CONTRACTOR FIELD VERIFY	NEOPR	NEOPRENE
J.	CONTROL JOINT	O.D.	OUTSIDE DIMENSION
.G	CEILING	O.C.	ON CENTER
DL	COLUMN	O.S.	OVERFLOW SCUPPER
	CLOSET	O.R.S.	OVERFLOW ROOF SCUP
ONC	CONCRETE	PTN	PARTITION
DNT	CONTINUOUS	PJ	PANEL JOINT
OVER'G	COVERING	PL	PLATE
3	CURB SCUPPER	L.P.	LIGHT POLE
-	CERAMIC TILE	PLYWD	PLYWOOD
BL	DOUBLE	PNL	PANEL
М	DIMENSION	PLAM	PLASTIC LAMINATE
L/DTLS	DETAILS	P.T.	PRESSURE TREATED
W	DISH WASHER	REINF.	REINFORCING
۹.	EACH	REQ'D	REQUIRED
ECT/ELEC	ELECTRICAL	RM	ROOM
	ELEVATION	R.D.	ROOF DRAIN
EV.	ELEVATOR	R.S.	ROOF SCUPPER
3	EMERGENCY SCUPPER	SHT	SHEET
H.	EXHAUST	SCH	SCHEDULE
IST.	EXISTING	S.S.	STAINLESS STEEL
P.	EXPANSION	STL	STEEL
T.	EXTERIOR	STD.	STANDARD
<b>D</b> .	FLOOR DRAIN	SECT	SECTION
≣.	FIRE EXTINGUISHER	SIM	SIMILAR
F.L.	FINISH FLOOR	SPEC'S	SPECIFICATIONS
RE EXT. CAB.	FIRE EXTINGUISHER CABINET	STRUCT	STRUCTURE
O.I.C.	FURNISHED BY OWNER,	SC	SOLID CORE WOOD
5.1.0.	INSTALLED BY CONTRACTOR	PH.	TELEPHONE
UOR	FLUORESCENT	TEMP	TEMPERED
٧.	FINISH	VCT	VINYL COMPOSITION TIL
<b>\</b>	GAUGE	VERT	VERTICAL
VB	GYPSUM WALL BOARD	VEST.	VESTIBULE
P. BD.	GYPSUM BOARD	WH	WATER HEATER
ALV.	GALVANIZED		

GALVANIZED STEEL

HOLLOW METAL

GLASS

	SYMBOI	_ LEGENI	)
Ę	CENTER LINE	??.??' 	SITE TERRAIN ELEV.
R	PROPERTY LINE	M	ELECTRICAL METER
(1t)	WINDOW TAG	\$\( \bar{M} \)\$	WATER METER
(1t)	DOOR TAG	<u> </u>	REVISION TAG
	SECTION MARK	Room name	ROOM TAG
	DATUM FLOOR ELEV.	SIM A101	CALLOUT HEAD TAG
?	KEYNOTE TAG		ELECTRICAL PANEL
>	BREAKLINE	- LP	LOW POINT ELEVATION
4"	CHANGE OF ELEVATION	•	SPOT ELEVATION
1i	WALL TYPE TAG	5 12	ROOF SLOPE TAG
$\rightarrow$	RAIN WATER SLOPE ARROW	1i	CURTINE WALL TAG
+ ?? PSF - ?? PSF	WINDOW PRESSURE		LEVEL HEAD CIRCLE
	NORTH ARROW	0	GRID BUBBLE TAG
SD	LINEAR DIFFUSER	LD	LINEAR DIFFUSER
LR	LINEAR RETURN	LT	LINEAR TRANSFER
<b>①</b>	JUNCTION BOX		

## **GENERAL NOTES**

- CONTRACTOR SHALL COMPLY WITH ALL APPLICABLE LOCAL, STATE AND FEDERAL BUILDING CODES HAVING JURISDICTION OVER THIS PROJECT. PERMIT(S) SHALL BE POSTED ON A VISIBLE PLACE AT ALL TIMES.
- CONTRACTOR SHALL BE RESPONSIBLE FOR VISITING THE SITE PRIOR TO BIDDING AND FAMILIARIZING HIMSELF WITH ALL EXISTING CONDITIONS AFFECTING THE WORK, INCLUDING BUT NOT LIMITED TO PRIVATE AND PUBLIC UTILITIES, ON AND OFF SITE, ACCESS ROADS, AND OTHER SUPPORT FACILITIES. CONTRACTOR IS RESPONSIBLE FOR INCLUDING IN HIS BID, LABOR AND MATERIAL COSTS FOR ANY CHARGE OR ALTERATION OF ADJACENT AREAS TO BE DISTURBED DURING CONSTRUCTION SUCH AS, BUT NOT LIMITED TO, PAVING SIDEWALKS, STREETS, EXISTING TREES AND LANDSCAPING TO INSURE THEIR PROPER DRAINAGE AND RETURN THEM TO THE ORIGINAL FINISHED CONDITION.
- CONTRACTOR SHALL REMOVE. RELOCATE OR RE-ROUTE AS NECESSARY ELECTRICAL, WATER, GAS OR ANY OTHER UTILITY LINES ENCOUNTERED DURING CONSTRUCTION, AND AS INDICATED IN THESE DOCUMENTS.
- CONTRACTOR SHALL BE RESPONSIBLE FOR THE REPAIR AND/OR THE REPLACEMENT OF ANY EQUIPMENT DAMAGED DURING CONSTRUCTION OR CLEAN UP. CONSTRUCTION PERSONNEL SHALL BE CONFINED TO THE LIMITS OF THE CONSTRUCTION AREA. ALL OSHA REGULATIONS FOR CONSTRUCTION AREAS SHALL BE STRICTLY FOLLOWED. CONTRACTOR SHALL PREPARE AND MAINTAIN ALL CONSTRUCTION AREAS, AS WELL AS SURROUNDING AREAS FREE OF DEBRIS OR HAZARDOUS EQUIPMENT.
- BY THE CONTRACTOR IN FULL COORDINATION WITH ALL THE CONTRACT DOCUMENTS ISSUED BY BORGES + ASSOCIATES ARCHITECTS, CONTRACTOR MUST NOTIFY ARCHITECT FOR CLARIFICATION PRIOR TO BIDDING OF ANY DISCREPANCIES FOUND ON THE DRAWINGS

CIVIL ENGINEERING, INTERIOR DESIGN, LANDSCAPING AND IRRIGATION DRAWINGS ARE PART OF THIS PROJECT AND SHALL BE PROVIDED

- BETWEEN BUT NOT LIMITED TO THE CIVIL ENGINEERING, ARCHITECTURAL, STRUCTURAL, MECHANICAL, PLUMBING AND ELECTRICAL DRAWINGS. ANY DISCREPANCIES FOUND AFTER BIDDING SHALL BE INTERPRETED AS IF IT WAS BID BASED ON THE MOST EXPENSIVE METHOD OR FINISH.
- CONTRACTOR MUST NOTIFY ARCHITECT IMMEDIATELY OF ANY UNEXPECTED OR UNKNOWN CONDITIONS IN THE FIELD. DISCREPANCIES IN THE DRAWINGS, PRIOR TO PROCEEDING WITH WORK OR SHOP FABRICATION.
- CONTRACTOR TO OBTAIN WRITTEN APPROVAL FROM OWNER OR ARCHITECT PRIOR TO ANY CHANGES OR DEVIATION FROM CONTRACT DOCUMENTS. UNDER NO CIRCUMSTANCES WILL ASSUMPTIONS BY THE CONTRACTOR BE CONSIDERED THE DESIGN INTENT OR APPROVAL OF THE ARCHITECT OR ENGINEER UNLESS THERE IS WRITTEN APPROVAL BY THEM. FAILURE TO NOTIFY THE ARCHITECT AND/OR COMMENCEMENT OF THE WORK WITHOUT APPROPRIATE AUTHORIZATION TO PROCEED SHALL BE REGARDED AS ACCEPTANCE OF THE CONDITIONS AND NOT SUBJECT TO ALTERATIONS ON THE TERMS OF THE CONTRACT.
- ALL WORK, MATERIALS AND EQUIPMENT UTILIZED IN THIS PROJECT SHALL BE NEW AND INSTALLED IN STRICT ACCORDANCE WITH THE MANUFACTURER'S PRINTED INSTALLATION RECOMMENDATIONS AND SPECIFICATIONS. ALL WORK FOR THIS PROJECT SHALL CONFORM TO STANDARDS PUBLISHED BY RECOGNIZED PROFESSIONAL AND INDUSTRY ORGANIZATIONS.
- DRAWINGS ARE NOT TO BE SCALED. DIMENSIONS SHALL BE FOLLOWED. ALL DIMENSIONS ARE BASED ON NOMINAL SIZES OF MEMBERS AND ARE GIVEN TO THE OUTER FACE OF SUCH MEMBERS, NOT TO FACE OF FINISH MATERIAL UNLESS OTHERWISE NOTED ON DRAWINGS.
- CONTRACTOR TO SUBMIT A MINIMUM OF FIVE (5) SETS OF COMPLETE SHOP DRAWINGS OR AS SUBMITTALS FOR APPROVAL BEFORE COMMENCING FABRICATION AND OR INSTALLATION OF ALL APPLICABLE ITEMS OF CONSTRUCTION. ALL SHOP DRAWING AND DIMENSIONS SHALL BE FIELD VERIFIED, REVIEWED AND APPROVED BY THE CONTRACTOR <u>BEFORE</u> SUBMITTAL, AND SO NOTED. INCOMPLETE SHOP DRAWINGS OR LACKING SUFFICIENT INFORMATION WILL BE RETURNED WITHOUT REVIEW. RE-REVIEWS BY ARCHITECT OR ENGINEER REQUIRED DUE TO SUBMITTALS NOT EVALUATED AND APPROVED BY CONTRACTOR SHALL BE BILLABLE AND PAID FOR BY THE CONTRACTOR ON HOURLY RATES ESTABLISHED IN THE ARCHITECTS CONTRACT FOR SERVICES FOR THIS PROJECT.
- THE CONTRACTOR SHALL BE AWARE THAT SPECIFIC FIRE RATED SEPARATIONS AND STATED SOUND TRANSMISSION COEFFICIENTS (STC) WITHIN THE BUILDING'S CONSTRUCTION ARE REQUIRED BY CODE. THE USE OF SPECIFIC MATERIALS AND COMBINATIONS OF MATERIALS WITHIN FIRE RATED ASSEMBLIES AS CALLED FOR ON THE DRAWINGS AND SPECIFICATIONS ARE FOR THE PURPOSE OF ACHIEVING THOSE REQUIRED FIRE SEPARATIONS. IT SHALL BE THE CONTRACTORS RESPONSIBILITY TO VERIFY THAT ANY CHANGE IN MATERIAL REQUESTED AND/OR MADE BY THE CONTRACTOR AND/OR SUBCONTRACTORS, FROM THOSE MATERIALS DRAWN OR SPECIFIED HEREIN, DOES NOT IN ANY WAY AFFECT OR LESSEN THE REQUIRED FIRE RATED CONSTRUCTION OR STC ASSEMBLY. WHERE CMU IS INDICATED TO HAVE A SPECIFIC HOURLY FIRE RATING AND STC RATING, THESE SHALL BE TAKEN AS THE MINIMUM REQUIRED.
- ALL PIPING SHALL BE SLEEVED THROUGH SLAB AND STRUCTURAL ELEMENTS PENETRATED. CONTRACTOR SHALL FULLY SEAL SPACE AROUND PIPES WITH A 2-HOUR U.L. APPROVED FIRE RESISTIVE ("THERMAFIBER" GLASS FIBER SAFING INSULATION AS MANUFACTURED BY U.S. GYPSUM CO. COMPLYING WITH ASTM E-119 OR APPROVED SIMILAR). PENETRATIONS THROUGH FIRE RATED WALLS SHALL BE PROTECTED AS TO MAINTAIN THE FIRE RATING OF SAID WALL. REFER TO WALL TYPES AND PENETRATION PROTECTION U.L. DETAILS INCLUDED IN THE DRAWINGS.
- ALL SHAFTS WHERE APPLICABLE SHALL BE 2-HOUR RATED WITHOUT EXCEPTION, (UL DESIGN NO. U-505 OR APPROVED SIMILAR) AND SHALL EXTEND AS SUCH TO UNDERSIDE OF ROOF OR FLOOR STRUCTURAL DECKING. SEE WALL TYPE DETAILS FOR WALL DESIGNS. PROJECT TO COMPLY WITH APPLICABLE REQUIREMENTS OF FBC CHAPTER 39, SEE FIRE PROTECTION, MECHANICAL, ELECTRICAL AND PLUMBING DRAWINGS.
- CONTRACTOR SHALL FURNISH AND INSTALL BLOCKING (METAL AND/OR WOOD AS ALLOWED BY CODE) WITHIN VERTICAL OR HORIZONTAL FRAMING AS REQUIRED OR RECOMMENDED FOR WALL MOUNTED OR BRACED FIXTURES, MILLWORK, SHELVES, BATHROOM FIXTURES, ACCESSORIES, TILE AND STONE WORK OR BY OTHER ITEMS DESCRIBED IN INTERIOR DESIGN AND ARCHITECTURAL DRAWINGS. ALL WOOD FRAMING, INCLUDING PLYWOOD, WHICH IS CONCEALED WITHIN WALLS OR CEILINGS OR USED FOR SUPPORT OF WALLS OR CEILINGS MUST BE FIRE RETARDANT. PRESSURE TREATED WOOD MUST BE USED WHERE IN CONTRACT WITH CONCRETE OR MASONRY AS PERMISSIBLE BY THE AUTHORITIES HAVING JURISDICTION.
- THE UNDERSIDE OF ALL EXTERIOR SOFFITS, BALCONIES AND SLABS EXPOSED TO WEATHER SHALL RECEIVE A CONTINUOUS 1-INCH DRIP STRIP CAST IN SAID SLAB WITHOUT EXCEPTION.
- ALL METAL FLASHING, SCUPPERS, ETC. SHALL BE PAINTED AS RECOMMENDED BY MANUFACTURER, UNLESS OTHERWISE NOTED ON DRAWINGS OR PROJECT MANUAL. COLOR TO MATCH ADJACENT SURFACES OR AS INDICATED BY THE ARCHITECT
- IN ADDITION TO WALL TYPES SHOWN ON PLANS THE CONTRACTOR SHALL REFER TO THE ROOM FINISH SCHEDULE, INTERIOR
- ELEVATIONS AND DETAILS FOR ADDITIONAL INFORMATION REGARDING FINISHES, INCLUDING INTERIOR DESIGN DRAWINGS. CONTRACTOR SHALL PROVIDE ACCESS PANELS FOR ANY CONCEALED PLUMBING, FIRE PROTECTION AND/OR MECHANICAL VALVES, FIRE DAMPERS. FIRE ALARM AND ELECTRICAL JUNCTION BOXES AS REQUIRED BY CODE AND AUTHORITIES HAVING JURISDICTION. ACCESS PANELS AND/OR DOORS SHALL BE U.L. LISTED AND SHALL MAINTAIN THE FIRE RATING SPECIFIED FOR THE DESIGN ASSEMBLY. THE LOCATION OF ALL ACCESS DOORS/PANELS SHALL ALLOW FOR PROPER EQUIPMENT ACCESSIBILITY, MAINTENANCE AND/OR OPERATION OF THE BUILDING SYSTEMS. THE OMISSION OF SUCH IN THESE DOCUMENTS DOES NOT RELIEVE THE CONTRACTOR OF THE
- RESPONSIBILITY FROM PROVIDING AND INSTALLING SUCH PANELS OR DOORS. CONTRACTOR SHALL PAINT ALL VISIBLE SURFACES OF FACTORY PRIMED OR FACTORY PAINT FINISHED EQUIPMENT, A/C GRILLS OR REGISTERS, COVERS, ETC, UNLESS SPECIFICALLY NOTED OTHERWISE, VERIFY AND COORDINATE COLORS WITH INTERIOR DESIGNER AND
- BEFORE INSTALLATION, THE CONTRACTOR SHALL COORDINATE WITH THE ARCHITECT AND INTERIOR DESIGNER THE EXACT MOUNTING LOCATION OF ALL SWITCHES, WALL RECEPTACLES, PLUGS, THERMOSTATS AND OTHER WALL MOUNTED FIXTURES IN ACCORDANCE WITH ADOPTED ACCESSIBILITY GUIDELINES, UNLESS SPECIFICALLY NOTED ON THE DRAWINGS.
- ALL INTERIOR AND EXTERIOR CONNECTIONS BETWEEN DISSIMILAR MATERIALS AND/OR FINISHES SHALL BE ISOLATED FROM DIRECT CONTACT BY MEANS OF COMPATIBLE MATERIALS. IT SHALL RECEIVE A BEAD OF CAULKING OR SEALANT TO MATCH COLOR OF ADJACENT SURFACES INSTALLED OVER A COMPRESSIBLE BACKER ROD OF COMPATIBLE MATERIAL AND APPROPRIATE WIDTH FOR THE JOINT. COORDINATE COLORS WITH ARCHITECT, INTERIOR DESIGNER AND/OR OWNER.
- AS A **PRE-REQUISITE** TO SUBSTANTIAL COMPLETION, THE CONTRACTOR SHALL BE RESPONSIBLE FOR REMOVING ALL DEBRIS AND CONSTRUCTION MATERIAL FROM THE PROJECT SITE. CONTRACTOR SHALL ALSO BE RESPONSIBLE FOR PROPERLY CLEANING ALL AREAS PRIOR TO FINAL ACCEPTANCE BY THE OWNER INCLUDING BUT NOT LIMITED TO WINDOWS, STOREFRONT, FLOOR TILES, CARPETS, WALLS, DOORS, LIGHT FIXTURES, DIFFUSERS, LOUVERS AND GRILLES, ETC.
- AS A PRE-REQUISITE TO SUBSTANTIAL COMPLETION, THE CONTRACTOR SHALL PROVIDE THE OWNER A COMPLETE SET OF AS-BUILT DRAWINGS DOCUMENTING ANY DEVIATIONS FROM THESE DOCUMENTS TO INCLUDE ARCHITECTURAL, STRUCTURAL, PLUMBING, FIRE PROTECTION, MECHANICAL AND ELECTRICAL DRAWINGS ALONG WITH THE WRITTEN GUARANTIES, OPERATION AND MAINTENANCE MANUALS OF ALL EQUIPMENT AND FINISHES INSTALLED. THE CONTRACTOR SHALL MAINTAIN A CURRENT SET OF AS-BUILT DRAWINGS ON SITE AT ALL TIMES. ALL DEVIATIONS FROM THESE DRAWINGS SHALL BE RECORDED BY THE CONTRACTOR AS CONSTRUCTION PROGRESSES.
- THE CONTRACTOR, ALL SUBCONTRACTORS AND SUPPLIERS SHALL GRANT TO THE OWNER/DEVELOPER, INSTITUTIONAL MORTGAGEE AND TO THE PURCHASER OF EACH UNIT, EXPRESSED AND IMPLIED WARRANTIES OF FITNESS FOR THE LABOR/WORK PERFORMED AND MATERIALS SUPPLIED BY THEM AS FOLLOWS: a. FOR A PERIOD OF FIVE (5) YEARS FROM THE DATE OF SUBSTANTIAL COMPLETION, A WARRANTY AS TO THE ROOFING SYSTEM, WATERPROOFING, STRUCTURAL COMPONENTS OF THE BUILDING AND MECHANICAL AND PLUMBING ELEMENTS, EXCEPT MECHANICAL ELEMENTS SERVING ONLY ONE UNIT; b. FOR A PERIOD OF THREE (3) YEARS FROM DATE OF SUBSTANTIAL COMPLETION, A WARRANTY AS TO ALL OTHER IMPROVEMENTS AND MATERIALS; c. AS TO PERSONAL PROPERTY, A WARRANTY WHICH IS FOR THE SAME PERIOD AS THAT PROVIDED BY THE MANUFACTURER OF THE PERSONAL PROPERTY, COMMENCING FROM THE DATE OF CLOSING OF THE PURCHASE OR THE DATE OF POSSESSION OF THE UNIT, WHICHEVER IS EARLIEST. d. THE TERM "COMPLETION OF A BUILDING OR IMPROVEMENT" MEANS **FINAL** COMPLETION OF CONSTRUCTION, FINISHING AND EQUIPPING OF THE BUILDING IN ACCORDANCE WITH THE PLANS AND SPECIFICATIONS, THE ISSUANCE OF A CERTIFICATE OF OCCUPANCY FOR THE ENTIRE BUILDING BY THE LOCAL AUTHORITY HAVING JURISDICTION AND FINAL ACCEPTANCE BY THE OWNER.
- COMPLY WITH THE FOLLOWING APPLICABLE ITEMS OF FBC CHAPTER 36- SECURITY ENFORCED ENTRY PREVISION: a. ALL LOCKS ON EXTERIOR DOORS SHALL BE CAPABLE OF RESISTING A FORCE OF 300 LB APPLIED IN ANY MOVABLE DIRECTION AND IN ACCORDANCE WITH RESISTANCE STANDARDS SET FORTH IN FBC SUBSECTION 3601.2. b. ALL SINGLE EXTERIOR SWING DOORS SHALL HAVE A LOCK TO BE KEY OPERATED FROM EXTERIOR WITH A MIN. OF 600 POSSIBLE KEY CHANGES OR LOCKING COMBINATIONS AUXILIARY SINGLE DEAD BOLT WITH HARDENED BOLT INSERTS. c. THE ACTIVE LEAF OF PAIRS OF EXTERIOR SWING DOORS SHALL HAVE SAME LOCKS AS REQUIRED FOR SINGLE EXTERIOR SWING DOORS. THE INACTIVE LEAF OF THESE PAIR OF DOORS SHALL HAVE MULTIPLE POINT LOCKS WITH 5/8" MIN. THROW BOLTS WITH INSERTS. d. SLIDING GLASS DOORS SHALL BE PROVIDED WITH SLIDING DOORS DEAD BOLTS OR A BOLT OR PIN NOT REMOVABLE OR OPERABLE FROM EXTERIOR, AT THE JAMB, HEAD, SILL OR AT MEETING MULLIONS. THESE DOORS SHALL BE REINFORCED IN THE STRIKE AND MAINTAIN BOLT STRENGTH EFFECTIVENESS, IF NECESSARY, AND SUCH DOORS SHALL HAVE NO SCREWS REMOVABLE FROM OUTSIDE WHICH WOULD FACILITATE READY ENTRY FROM OUTSIDE. e. HINGES ON EXTERIOR OUT SWINGING DOORS SHALL HAVE NO REMOVABLE PINS. f. SINGLE, SWINGING EXTERIOR DOORS, IF WOOD SHALL BE SOLID CORED AND INSULATED OF NOT LESS THAN 1-3/4" THICK. g. GLASS SHALL COMPLY WITH THE AMERICAN NATIONAL STANDARDS INSTITUTE (ANSI) Z97.1. h. SLIDING GLASS DOORS SHALL BE INSTALLED AND CONSTRUCTED SO THAT NO PANEL CAN BE LIFTED FROM THE TRACKS WHEN IN THE LOCKED POSITION AND SO AS TO COMPLY WITH ARCHITECTURAL ALUMINUM MFGS ASSOC. STANDARDS FOR FORCED ENTRY RESISTANCE AAMA 1303.5 AND ANSI/AAMA 101.
- SWIMMING POOL AND SPA, COMPLETE WITH ALL SHOWN PIPING, PUMPS, PANELS, ALARMS AND SUPPORTING EQUIPMENT SHALL BE PART OF A SEPARATE PERMIT BY THE APPROPRIATE AGENCIES HAVING JURISDICTION.
- A SEPARATE PERMIT AND PRODUCT CONTROL APPROVAL, WHEN APPLICABLE, ARE REQUIRED FOR THE FOLLOWING: STRUCTURAL GLAZING, CURTAIN WALLS, RAINSCREEN SYSTEMS, SIGNS, FENCES, WINDOWS, DOORS, AWNINGS, DEMOLITION, STEEL JOISTS, STOREFRONTS, PRECAST SYSTEMS, ROOFING, RAILINGS, MULLIONS, HANDRAILS, GLASS BLOCK, ALUMINUM TRELLIS & GRID PANELS & LOUVERS, CANOPIES, & METAL STRUCTURAL COLUMN, METAL ROOF FEATURES, ELEVATORS, GLASS & ALUMINUM RAIL, STAIR RAIL & BALCONY GUARDRAIL, STEEL FRAMES & METAL DECKS, TRANSLUCENT MATERIAL "KALWALL". SPIRAL STAIR (TO RESIST PENDULUM LATERAL IMPACT 400#)
- ROOF SYSTEM SHALL BE INSTALLED IN COMPLETE CONFORMANCE WITH THE SOUTH FLORIDA BUILDING CODE/ MIAMI DADE COUNTY PRODUCT APPROVAL AND MANUFACTURERS SPECIFICATIONS. REFER TO ROOFING AND WATERPROOFING NOTES AND DETAILS ELSEWHERE IN THESE DRAWINGS.
- ALL ELECTRICAL, MECHANICAL AND PLUMBING EQUIPMENT MUST BE LOCATED AT OR ABOVE BASE FLOOD ELEVATION (10.00'). ALL FINISH MATERIALS BELOW BFE MUST BE MADE OF FLOODDPROOF MATERIALS.
- ALL LIGHTING FIXTURES BELOW BFE MUST BE WATER SUMERSIBLE.
- AS PER FBC R 320 TERMITE PROTECTION SHALL BE PROVIDED BY REGISTERED TERMITICIDES, INCLUDING SOIL APPLIED PESTICIDES, BAITING SYSTEMS, AND PESTICIDES APPLIED TO WOOD, OR OTHER APPROVED METHODS OF TERMITE PROTECTION LABELED FOR USE AS A PREVENTATIVE TREATMENT TO NEW CONSTRUCTION (SEE SECTION, REGISTERED TERMITICIDE). UPON COMPLETION OF THE APPLICATION OF THE TERMITE PROTECTIVE TREATMENT, A CERTIFICATE OF COMPLIANCE SHALL BE ISSUED TO THE BUILDING DEPARTMENT BY THE LICENSED PEST CONTROL COMPANY THAT CONTAINS THE FOLLOWING STATEMENT: "THE BUILDING HAS RECEIVED A COMPLETE TREATMENT FOR THE PREVENTION OF SUBTERRANEAN TERMITES. TREATMENT IS IN ACCORDANCE WITH RULES AND LAWS ESTABLISHED BY THE FLORIDA DEPARTMENT OF AGRICULTURE AND CONSUMER SERVICES."

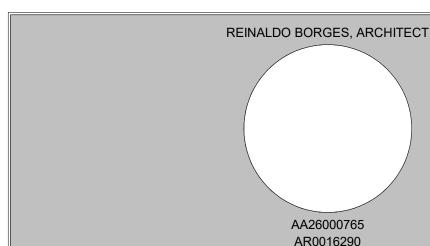
ISSUE [	DATE: 01/0	03/2022	DRB FINAL SUBMITTAL
No.	Date		Description

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	AR0010290
Project Team	

#### Project Name

## CASA BAHIA

253 N COCONUT LN MIAMI BEACH, FLORIDA, 33139 FOLIO # 02-4205-002-0160

21-3600

Drawing Name	
OFNEDAL NOTEO	
GENERAL NOTES	

Drawing Number

As indicated

Scale:

Project Number

#### ZONING DATA

PROJECT DESCRIPTION: NEW CONSTRUCTION-SINGLE FAMILY MUNICIPALITY: MIAMI BEACH STREET ADDRESS: 253 N COCONUT LN MIAMI BEACH, FLORIDA, 33139 FOLIO NUMBER: 02-4205-002-0160 ZONING DISTRICT RS-4

FEMA ZONE: AH BFE: 8.00' NGVD +2.00' NGVD (FREE BOARD) = 10.00' NGVD

CODE OF ORDINANCES' REFERENCES: LOT AREA: 142-105 MINIMUM LOT WIDTH: 142-105 GROSS BUILDING AREA: 142-105 LOT COVERAGE: 142-105 BUILDING HEIGHT: 54-35 BUILDING SETBACKS: 142-106 FENCE HEIGHT:142-1132 DRIVEWAYS: 142-1132 POOL SETBACK: 142-1133 PROJECTIONS: 142-1132, 142-105 OTHER DIMENSIONAL REQUIREMENTS:142-105

### MIAMIBEACH

Planning Department. 1700 Convention Center Drive Miami Beach, Florida 33139. www.miamibeachfl.gov 305.673.7550

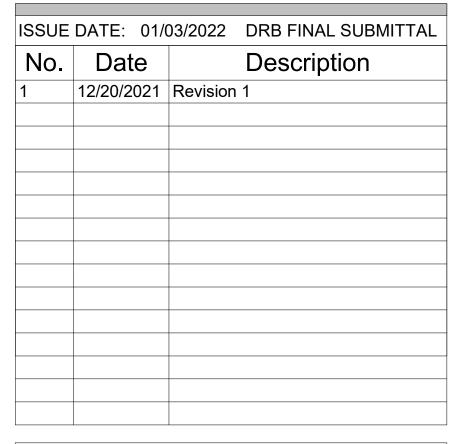
#### **ZONING DATA SHEET**

ITEM #	Zoning Information				
1	Address:	253 COCONUT LN. MIAMI BEACH, FLORIDA 33139			
2	Folio number(s):	02-4205-002-0160			
3	Board and file numbers:	N/A	-		
4	Year built:	1935	Zoning District:		RS-4
5	Based Flood Elevation:	8.00' NGVD (8'+2' FB)	Grade value in NGVD:		3.08' NGVD
6	Adjusted grade (Flood+Grade/2):	8'+3.08/2=5.54' NGVD	Free board:		2'-0"
7	Lot Area:	7,000 sf (0.16 ac)			
3	Lot width:	50 ft.	Lot Depth:		140 ft.
)	Max Lot Coverage SF and %:	2,100 sf (30%)	Proposed Lot Coverage	e SF and %:	2,100 sf (30%)
10	Existing Lot Coverage SF and %:	N/A	Lot coverage deducted	(garage-storage) SF:	500 sf (garage)
11	Front Yard Open Space SF and %:	750 sf (50%)	Rear Yard Open Space	SF and %:	735 sf (70%)
12	Max Unit Size SF and %:	3,500 sf (50%)	Proposed Unit Size SF a	and %:	3,500 sf (50%)
13	Existing First Floor Unit Size:	2,283 sf	Proposed First Floor U	nit Size:	1,718 sf
14	Existing Second Floor Unit Size	N/A	353	volumetric Unit Size SF and of the first floor of the B Approval)	
15			Proposed Second Floor Unit Size SF and %:		1,705 sf
16			Proposed Roof Deck And Maximum is 25% of the immediately below):		426 sf (25%) (1,705 x 0.25)
		Required	Existing	Proposed	Deficiencies
L7	Height:	24 ft.	1 Story	24 ft. / 2 stories	
L8	Setbacks:				
19	Front First level:	20 ft.	N/A	20 ft.	
20	Front Second level:	30 ft.	N/A	40 ft.	
21	Side 1:	7'-6"	N/A	7'-6"	
22	Side 2 or (facing street):	7'-6"	N/A	7'-6"	
23	Rear:	21'-0"	N/A	21'-0"	
	Accessory Structure Side 1:		N/A	N/A	
24	Accessory Structure Side 2 or (facing street):		N/A	N/A	
25	Accessory Structure Rear:		N/A	N/A	
26	Sum of Side yard:	15'-0"	N/A	15'-0"	
27	Located within a Local Historic District?			No	
28	Designated as an individual Historic Sing	rle Family Residence Site?		No	

29 Determined to be Architecturally Significant?



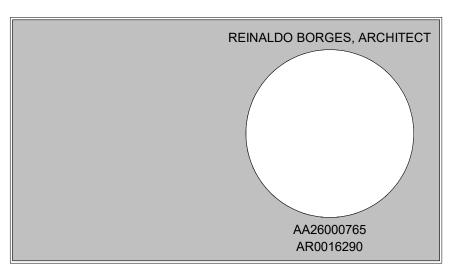




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Project Team

Project Name

## CASA BAHIA

253 N COCONUT LN MIAMI BEACH, FLORIDA, 33139 FOLIO # 02-4205-002-0160

Project Number 21-3600 Drawing Name LOT COVERAGE AND OPEN AREA DIAGRAMS

Scale:

Drawing Number 3/32" = 1'-0"

## MIAMIBEACH

Planning Department. 1700 Convention Center Drive Miami Beach, Florida 33139. www.miamibeachfl.gov 305.673.7550

#### **ZONING DATA SHEET**

ITEM #	Zoning Information				
1	Address:	253 COCONUT LN. MIAMI BEACH, FLORIDA 33139			
2	Folio number(s):	02-4205-002-0160	,		
3	Board and file numbers:	N/A			
4	Year built:	1935	Zoning District:		RS-4
5	Based Flood Elevation:	8.00' NGVD (8'+2' FB)	Grade value in NGVD:		3.08' NGVD
6	Adjusted grade (Flood+Grade/2):	8'+3.08/2=5.54' NGVD	Free board:		2'-0"
7	Lot Area:	7,000 sf (0.16 ac)			
8	Lot width:	50 ft.	Lot Depth:		140 ft.
9	Max Lot Coverage SF and %:	2,100 sf (30%)	Proposed Lot Coverage	SF and %:	2,100 sf (30%)
10	Existing Lot Coverage SF and %:	N/A	Lot coverage deducted (	garage-storage) SF:	500 sf (garage)
11	Front Yard Open Space SF and %:	750 sf (50%)	Rear Yard Open Space S	F and %:	735 sf (70%)
12	Max Unit Size SF and %:	3,500 sf (50%)	Proposed Unit Size SF ar	nd %:	3,500 sf (50%)
13	Existing First Floor Unit Size:	2,283 sf	Proposed First Floor Uni	t Size:	1,718 sf
14	Existing Second Floor Unit Size	N/A	Proposed Second Floor % (Note: to exceed 70% main home require DRB		
15			Proposed Second Floor Unit Size SF and %: 1,705 sf		
16			Proposed Roof Deck Area SF and % (Note: 426 sf (25%) Maximum is 25% of the enclosed floor area immediately below):		
		Required	Existing	Proposed	Deficiencies
17	Height:	24 ft.	1 Story	24 ft. / 2 stories	
18	Setbacks:				
19	Front First level:	20 ft.	N/A	20 ft.	
20	Front Second level:	30 ft.	N/A	40 ft.	
21	Side 1:	7'-6"	N/A	7'-6"	
22	Side 2 or (facing street):	7'-6"	N/A	7'-6"	
23	Rear:	21'-0"	N/A	21'-0"	
	Accessory Structure Side 1:		N/A	N/A	
24	Accessory Structure Side 2 or (facing street):		N/A	N/A	
25	Accessory Structure Rear:		N/A	N/A	
26	Sum of Side yard:	15'-0"	N/A	15'-0"	
		,	,	<u>.</u>	*
27	Located within a Local Historic District?			No	
28	Designated as an individual Historic Single Family Residence Site?		No		

27	Located within a Local Historic District?	No
28	Designated as an individual Historic Single Family Residence Site?	No
29	Determined to be Architecturally Significant?	No
** <u></u>		

**Notes:** 





Description

12/20/2021 Revision 1

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CASA BAHIA

253 N COCONUT LN MIAMI BEACH, FLORIDA, 33139

FOLIO # 02-4205-002-0160

UNIT SIZE DIAGRAMS

Drawing Number

3/32" = 1'-0"

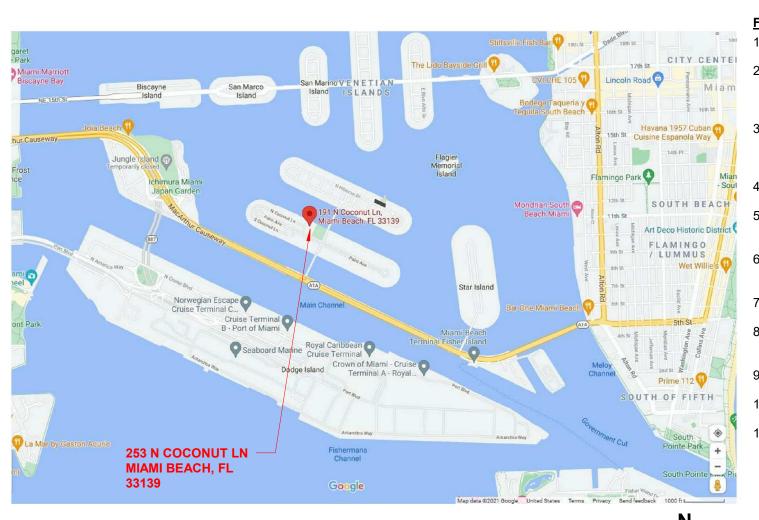
REINALDO BORGES, ARCHITECT

AA26000765 AR0016290

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**ZONING DATA** 

MUNICIPALITY: MIAMI BEACH

MIAMI BEACH, FL 33139

**ZONING DISTRICT RS-4** 

FIRM MAP: 12086 C 0316-L

ADJUSTED GRADE

BASE FLOOD ELEV.

1ST FLOOR ELEV.

2ND FLOOR ELEV.

ROOF ELEV.

FEMA ZONE: AE

STREET ADDRESS: 253 N COCONUT LN

GARAGE FLOOR ELEV. @ 5.25' NGVD

FOLIO NUMBER: 02-4205-002-0160

PROJECT DESCRIPTION: NEW CONSTRUCTION-SINGLE

5.54' NGVD

@ 11.00' NGVD

@ 23.92' NGVD

@ 35.00' NGVD

@ 8.00' NGVD +2.00' (10.00' NGVD) 1929

## CITY MAP - NTS

#### CODE OF ORDINANCES' **REFERENCES:**

**CODE OF ORDINANCES' REFERENCES:** LOT AREA: 142-105 MINIMUM LOT WIDTH: 142-105 **GROSS BUILDING AREA: 142-105** LOT COVERAGE: 142-105 **BUILDING HEIGHT: 54-35 BUILDING SETBACKS: 142-106** FENCE HEIGHT:142-1132 DRIVEWAYS: 142-1132 POOL SETBACK: 142-1133 PROJECTIONS: 142-1132, 142-105 OTHER DIMENSIONAL REQUIREMENTS:142-105

### **ELEVATIONS NOTE**

ALL ELEVATIONS ARE BASED UPON NATIONAL GEODETIC VERTICAL DATUM OF1929 (NGVD 1929). SCOPE OF WORK

1. DESCRIPTION

2. SCOPE INCLUDES 2.1 Demolition of existing structure 2.2 New construction 2 stories single family residence

New construction 2 stories single family residence

### **FLOOD-RESISTANT DESIGN AND CONSTRUCTION NOTES**

CLASSIFICATION OF STRUCTURES FOR FLOOD RESISTANCE DESIGN SHALL BE CATEGORY II IN ACCORDANCE WITH ASCE 24.05 TABLE 1.1. NEW CONSTRUCTION & SUBSTANTIAL IMPROVEMENTS IN FLOOD HAZARD AREAS SHALL BE CONSTRUCTED WITH FLOOD-DAMAGE-RESISTANT MATERIALS BELOW

THE DESIGN FLOOD ELEVATION. (+11.00") PER FBC FIFTH EDITION (2014) BUILDING SECTION 1612 AND TABLE 5-1 OF ASCE 24. LATEST EDITION. FLOOD DAMAGE-RESISTANT MATERIALS SHALL HAVE SUFFICIENT STRENGTH, RIGIDITY, & DURABILITY TO ADEQUATELY RESIST ALL FLOOD-RELATED AND OTHER LOADS UNLESS DESIGNED TO BREAK AWAY PER ASCE 24, LATEST EDITION.

UTILITIES & ATTENDANT EQUIPMENT SHALL BE ELEVATED AT OR ABOVE THE DESIGN FLOOD ELEVATION. (+11.00') PER TABLE 7-1 OF ASCE 24, LATEST EDITION. FLOOD OPENINGS WILL PROVIDE EQUALIZATION OF HYDROSTATIC FLOOD FORCES ON EXTERIOR WALLS BY ALLOWING FOR THE AUTOMATIC ENTRY AND EXIT OF FLOODWATER AS SPECIFIED IN FBC R322.2.2 AND ASCE 24. CONTRACTOR TO SUBMIT AN ELEVATION CERTIFICATE UPON PLACEMENT OF THE LOWEST FLOOR AND PRIOR TO FURTHER VERTICAL CONSTRUCTION TO

BUILDING DEPARTMENT FOR REVIEW AND APPROVAL CONTRACTOR SHALL SUBMIT FINISHED CONSTRUCTION ELEVATION CERTIFICATE PRIOR TO FINAL BUILDING INSPECTION APPROVAL OR CO. FLOOD OPENINGS LOUVERS, SCREEN OR OTHER OPENING COVER SHALL NOT BLOCK OR IMPEDE THE AUTOMATIC FLOW OF FLOOD WATER INTO OR OUT OF

ENCLOSED AREA. FLOOD OPENINGS SHALL NOT BE LESS THAN 3 INCHES IN ANY DIRECTION IN THE PLANE OF THE WALL

ENCLOSED AREAS BELOW DESIGN FLOOD ELEVATION (+11.00' NGVD) SHALL BE USED SOLELY FOR PARKING, BUILDING ACCESS OR STORAGE. THE BOTTOM OF EACH FLOOD OPENING SHALL BE NO HIGHER THAN 1.0 FT. ABOVE THE HIGHER OF THE EXTERIOR OR INTERIOR GRADE OR FLOOR IMMEDIATELY BELOW THE OPENING. DISTANCE SHALL BE NOTED ON EXTERIOR ELEVATIONS SHEETS BELOW EACH OPENING. THE TOP OF THE FLOOD OPENING SHALL NOT BE ABOVE DFE, ANY PART OF THE FLOOD OPENING ABOVE THE DFE CANNOT BE COUNTED TOWARDS THE COMPLIANCE WITH THE FLOOD OPENING

#### PUBLIC WORKS NOTES

REQUIREMENTS.

RECONSTRUCT SWALE/SOD ALONG THE ENTIRE PROPERTY. MILL AND RESURFACE 2 INCHES AVERAGE USING TYPE S-III ASPHALT MIX DESIGN ON THE DRIVING LANE (10 FOOT WIDE) ALONG THE ENTIRE PROPERTY. ANY WORK AND/OR IMPROVEMENTS FROM/TO THE RIGHT-OF-WAY INCLUDING LANDSCAPING AND IRRIGATION REQUIRE A SEPARATE CMB PUBLIC WORKS

DEPARTMENT RIGHT-OF-WAY CONSTRUCTION PERMIT. ALL CONSTRUCTION AND/OR USE OF EQUIPMENT IN THE RIGHT-OF-WAY WILL REQUIRE A SEPARATE CITY OF MIAMI BEACH PUBLIC WORKS DEPARTMENT RIGHT-OF-WAY CONSTRUCTION PERMIT PRIOR TO START OF CONSTRUCTION.

#### **PUBLIC WORKS-REMINDER NOTES**

THE CONTRACTOR/PERMIT HOLDER SHALL EMPLOY AN EFFECTIVE INTEGRATED MOSQUITO MANAGEMENT PROGRAM UTILIZING BEST MANAGEMENT PRACTICES DURING THE ENTIRE TIME THE PERMIT IS IN EFFECT.

A CMB RIGHT OF WAY CONSTRUCTION PERMIT IS REQUIRED BEFORE STARTING ANY DEMOLITION AND/OR CONSTRUCTION ACTIVITY INSIDE RIGHT-OF-WAY. THE PUBLIC WORKS DEPARTMENT RECOMMENDS THAT THE SANITARY SEWER LATERAL BETWEEN PROPERTY LINE AND THE SANITARY SEWER MAIN BE REPLACED IN ALL SUBSTANTIAL IMPROVEMENT PROJECTS. AS A SUBJECTION CONTRACTOR TO DO A VIDEO INSPECTION OF THE SIX INCHES SANITARY SEWER LATERAL TO CONFIRM THE CONDITION OF THE PIPE AND PROVIDE TWO DIGITAL COPY FOR THE PUBLIC WORKS DEPARTMENT TO REVIEW AND TO CONFIRM THE CONDITION OF THE LATERAL PIPE.

CONCRETE DECORATIVE REQUIRE A CITY OF MIAMI BEACH RIGHT OF WAY PERMITS FOR CONCRETE DECORATIVE DRIVEWAY CONNECTION (PUBLIC WORKS MANUAL PART I / SECTION 2 / A / 4).

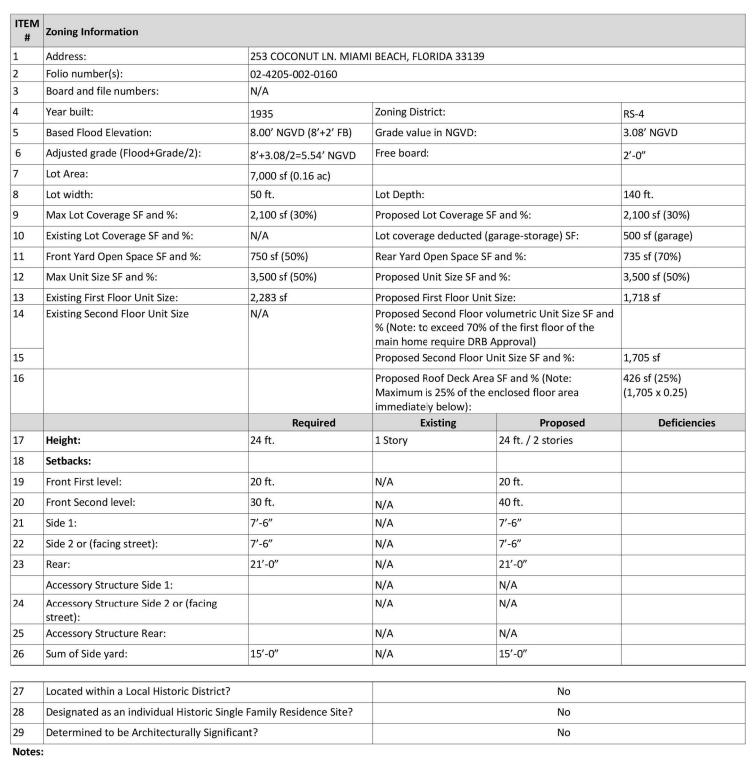
LANDSCAPE IMPROVEMENTS WITHIN THE RIGHT-OF-WAY REQUIRE PRELIMINARY APPROVALS FROM THE PUBLIC WORKS URBAN FORESTER PRIOR TO APPLYING FOR A PUBLIC WORKS DEPARTMENT RIGHT-OF-WAY CONSTRUCTION PERMIT.

#### MIAMIBEACH

#### Planning Department, 1700 Convention Center Drive Miami Beach, Florida 33139. www.miamibeachfl.gov

305.673.7550

#### **ZONING DATA SHEET**



SITE NOTE:

RECONSTRUCT THE SWALE ALONG THE ENTIRE PROPERTY.

IMPROVEMENT WITHTIN THE RIGHT-OF-WAY.

- MILL AND RESURFACE 2" AVERAGE (USE TYPE S-III ASPHALT MIX DESIGN) AT THE DRIVING LANE (10' WIDE) ALONG THE ENTIRE PROPERTY.
- IMPROVEMENTS TO THE RIGHT-OF-WAY REQUIRES A SEPARATE CMB PUBLIC WORK DEPARTMENT PERMIT WITH CITY OF MIAMI BEACH CAPITALIMPROVEMENT PROJECTS OFFICE APPROVAL IN REGARDS TO PALM-HIBISCUS NEIGHBORHOOD IMPROVEMENTS PROJECT. USE THE CMB PUBLIC WORKS DEPARTMENT MANUAL FOR CMB UTILITIES AND/OR ANY
- ALL DOORS AND WINDOWS PROVIDING DIRECT ACCESS FROM THE HOME TO THE POOL SHALL BE EQUIPPED WITH AN ALARM COMPLYING WITH UL-2017 THAT HAS A MINIMUM SOUND PRESSURE RATING OF 85 DBA AT 10 FEET AS PER FBC R4101.17.1.9.1. AN ALARM WHICH PRODUCES AN AUDIBLE WARNING WHEN THE DOOR AND ITS SCREEN ARE OPENED. THE ALARM SHALL SOUND CONTINUOUSLY FOR A MINIMUM OF 30 SECONDS IMMEDIATELY AFTER THE DOOR IS OPENED AND BE CAPABLE OF BEING HEARD THROUGHOUT THE HOUSE DURING NORMAL HOUSEHOLD ACTIVITIES. THE ALARM SHALL AUTOMATICALLY RESET UNDER ALL CONDITIONS. THE ALARM SHALL BE EQUIPPED WITH A MANUAL MEANS TO TEMPORARILY DEACTIVATE THE ALARM FOR A SINGLE OPENING. SUCH DEACTIVATION SHALL LAST NO MORE THAN 15 SECONDS. THE DEACTIVATION SWITCH SHALL BE LOCATED AT LEAST 54 INCHES

ABOVE THE THRESHOLD OF THE DOOR. VAPOR BARRIER 15 ml POLYETHYLENE VAPOR RETARDER W/JOINTS LAPPED NOT LESS THAN 6

INCHES, OR OTHER APPROVED EQUIVALENT METHODS OR MATERIALS. PROTECTION AGAINST TERMITES: R318.1 TERMITE PROTECTION SHALL BE PROVIDED BY REGISTERED TERMITICIDES, INCLUDING SOIL APPLIED PESTICIDES, BAITING SYSTEMS, AND PESTICIDES APPLIED TO WOOD, OR OTHER APPROVED METHODS OF TERMITE PROTECTION LABELED FOR USE AS A PREVENTATIVE TREATMENT TO NEW CONSTRUCTION (SEE SECTION 202, REGISTERED TERMITICIDE). UPON COMPLETION OF THE APPLICATION OF THE TERMITE PROTECTIVE TREATMENT, A CERTIFICATE OF COMPLIANCE SHALL BE ISSUED TO THE BUILDING DEPARTMENT BY THE LICENSED PEST CONTROL COMPANY THAT CONTAINS THE FOLLOWING STATEMENT: "THE BUILDING HAS RECEIVED A COMPLETE TREATMENT FOR THE PREVENTION OF SUBTERRANEAN TERMITES. TREATMENT IS IN ACCORDANCE WITH RULES AND LAWS ESTABLISHED BY THE FLORIDA DEPARTMENT OF AGRICULTURE AND CONSUMER

REFER TO LANDSCAPE DRAWINGS FOR PLANTS SPECS, DIMENSIONS, IRRIGATION LAYOUT AND DETAILS.

REFER TO CIVIL DRAWINGS FOR DRAINAGE LAYOUT AND CALCULATION. SEE LANDSCAPE DRAWINGS FOR: TREE MITIGATION/RELOCATION, LANDSCAPE SOFTSCAPE AND HARDSCAPE LAYOUT.

ALL YARDS SHALL BE SLOPED TO RETAIN ALL STORMWATER ON SITE, AND SHALL NOT DRAIN ONTO ADJACENT PROPERTIES. CONTRACTOR SHALL REQUEST VERIFICATIONS AND LOCATION MARKINGS FROM UTILITY

COMPANIES FOR ALL UNDERGROUND UTILITY SERVICES PRIOR TO BEGINNING ANY CONTRACTOR IS RESPONSIBLE FOR PROVIDING SURVEYOR SITE LAYOUT OF ALL

FOUNDATIONS AND STRUCTURE LOCATIONS, IN ADDITION TO SITE GRADE ELEVATION ALL DOWNSPOUTS, STORM DRAINS, FOOTING, AND FOUNDATION DRAINS SHALL BE CONNECTED TO THE STORM DRAINAGE SYSTEM AS INDICATED IN CIVIL DWGS. DOWNSPOUTS

SHALL BE TIGHT LINED SEPARATE FROM FOUNDATION DRAINS. SHOULD ANY UNUSUAL CONDITIONS BECOME APPARENT DURING GRADING, TRENCHING, FOUNDATION WORK, ETC. CONTRACTOR SHALL CONTACT OWNER AND ARCHITECT FOR INSTRUCTIONS PRIOR TO CONTINUATION OF WORK.

THE GEOTECHNICAL REPORTS FOR THE SITE PROVIDED BY THE OWNER SHALL BE PART OF THE CONSTRUCTION AND CONTRACT DOCUMENTS.

SLOPE ALL DECKS, WALKWAYS, DRIVEWAYS, IMPERVIOUS GRADE, AND PATIOS AWAY FROM BUILDINGS AT 2% MAXIMUM. PERVIOUS GRADE AREAS SHALL SLOPE AWAY FROM THE

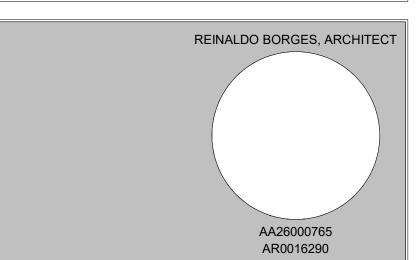
BUILDING AS INDICATED IN CIVIL GRADING PLAN. GC TO PROVIDE A SWIMING POOL ALARM THAT, WHEN PLACED IN A POOL, SOUNDS AN ALARM UPON DETECTION OF AN ACCIDENTAL OR UNAUTHORIZED ENTRANCE INTO THE WATER. REFER TO 2016 FLORIDA STATUTES, CHAPTER 515.

ISSUE DATE: 01/03/2022 DRB FINAL SUBMITTAL Description 12/20/2021 | Revision 1

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Project Team	

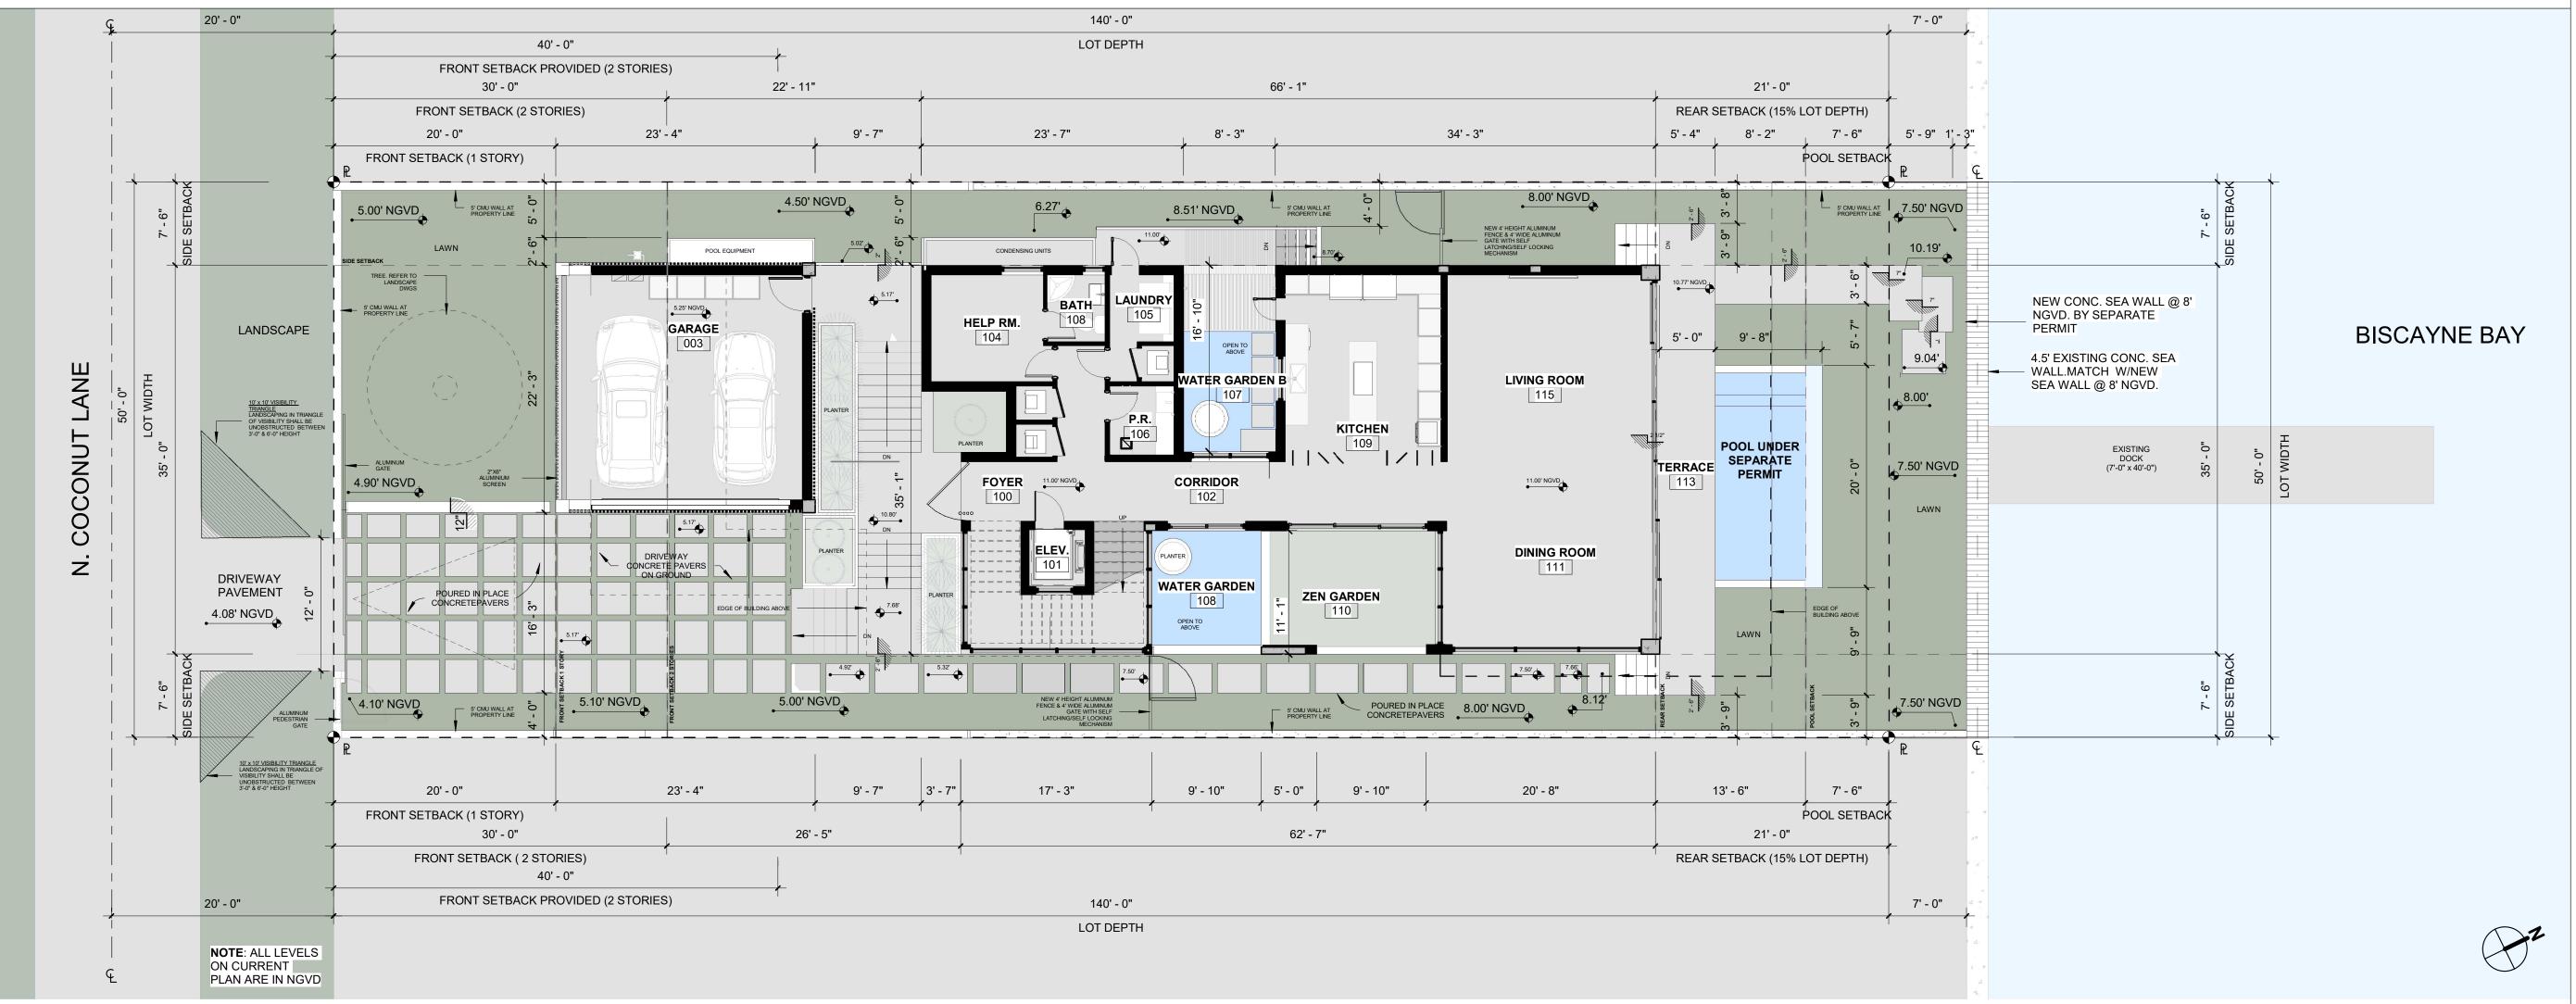
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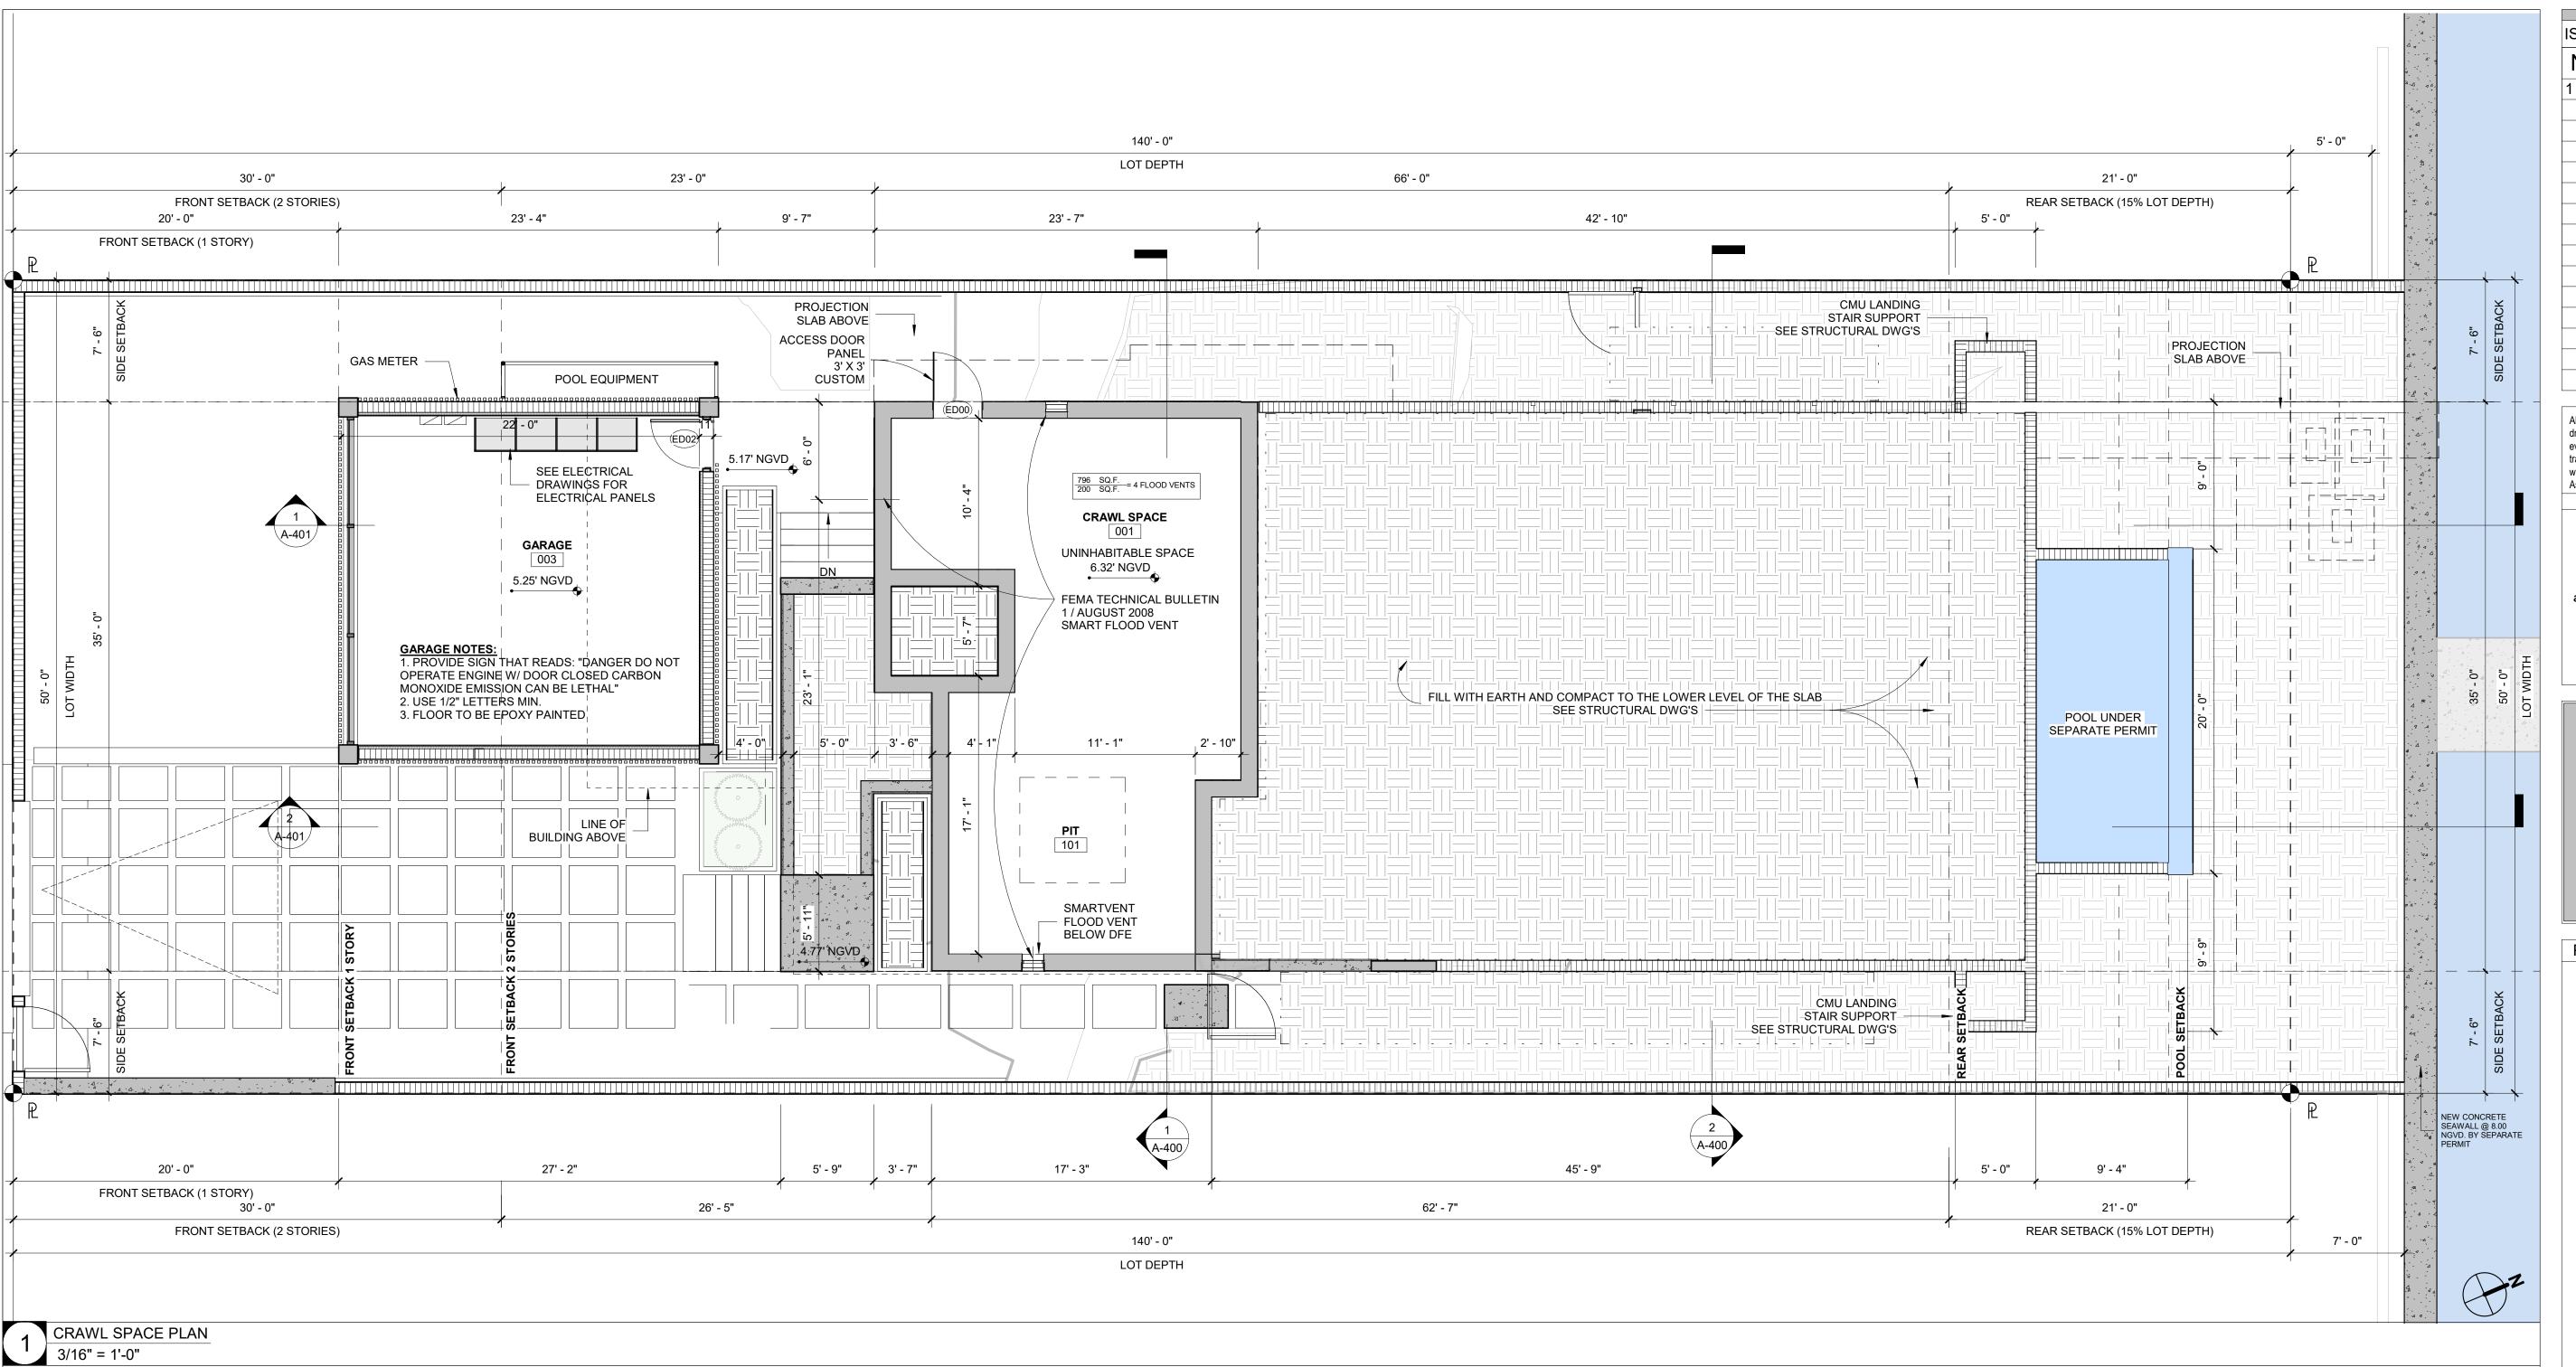
## CASA BAHIA

253 N COCONUT LN MIAMI BEACH, FLORIDA, 33139 FOLIO # 02-4205-002-0160

Project Number	21-3600	
Drawing Name	$\wedge$	
	SITE PLAN	
Scale:	Drawing Number	

1/8" = 1'-0"





**FLOOD NOTES:** 

OUT OF ENCLOSED AREA.

THE PLANE OF THE WALL

WITH THE FLOOD OPENING REQUIREMENTS.

FLOOD OPENINGS WILL PROVIDE EQUALIZATION OF HYDROSTATIC FLOOD

FORCES ON EXTERIOR WALLS BY ALLOWING FOR THE AUTOMATIC ENTRY

AND EXIT OF FLOODWATER AS SPECIFIED IN FBC R322.2.2 AND ASCE 24.

FLOOD OPENINGS LOUVERS, SCREEN OR OTHER OPENING COVER SHALL

NOT BLOCK OR IMPEDE THE AUTOMATIC FLOW OF FLOOD WATER INTO OR

FLOOD OPENINGS SHALL NOT BE LESS THAN 3 INCHES IN ANY DIRECTION IN

THE BOTTOM OF EACH FLOOD OPENING SHALL BE NO HIGHER THAN 1.0 FT.

ABOVE THE HIGHER OF THE EXTERIOR OR INTERIOR GRADE OR FLOOR

EXTERIOR ELEVATIONS SHEETS BELOW EACH OPENING. THE TOP OF THE

MATERIALS BELOW DFE (11' NGVD) SHALL BE FLOOD-DAMAGE RESISTANT

PER FEMA TECHNICAL BULLETIN 2, MATERIALS CLASS 4 AND 5.

OPENING ABOVE THE DFE CANNOT BE COUNTED TOWARDS THE COMPLIANCE

FLOOD OPENING SHALL NOT BE ABOVE DFE, ANY PART OF THE FLOOD

IMMEDIATELY BELOW THE OPENING. DISTANCE SHALL BE NOTED ON

## FLOOR PLAN NOTES

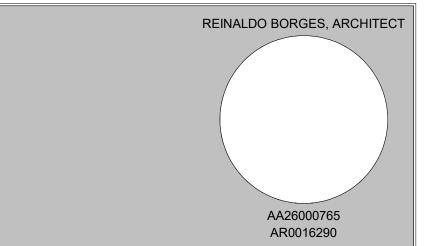
- GC TO PROVIDE MIAMI D.C. PRODUCT CONTROL APPROVAL FOR IMPACT RESISTANT EXTERIOR DOOR AND WINDOWS. ALL BEDROOMS SHALL HAVE 'EGRESS' TYPE DOORS OR WINDOWS, U.O.N. REFER TO DOOR / WINDOW SCHEDULE. THE EGRESS WINDOW SHALL BE OPERABLE FROM THE INSIDE WITHOUT THE USE OF TOOLS AND PROVIDING A CLEAR OPENING OF NOT LESS THAN 20" IN WIDTH, 24" IN HEIGHT, AND 5.7 SQ.FT. IN AREA. THE BOTTOM OF THE OPENING SHALL NOT BE MORE THAN 44" OFF THE FLOOR. THE MODE OF OPERATION DOES NOT REQUIRE THE USE OF A KEY, TOOL, SPECIAL KNOWLEDGE, OR EFFORT TO MAKE AVAILABLE THE REQUIRED CLEAR OPENING, AND NO PART OF THE MECHANISM SHALL BE PLACED HIGHER THAN 54" ABOVE THE FINISHED FLOOR.
- GENERAL CONTRACTOR TO VERIFY AND COORDINATE ACTUAL WINDOW DIMENSIONS AND ROUGH OPENINGS PRIOR TO CONSTRUCTION.
- ANY CHANGE OF INTERIOR FINISHES BY OWNER/G.C. SHALL BE COORDINATED WITH ARCHITECT OF RECORD.
- INTERIOR / EXTERIOR PARTITION FRAMING, SIZING AND REINFORCING TO BE BY SPECIALTY ENGINEERING. BATH DOORS SHALL BE OPERABLE FROM OUTSIDE IN EMERGENCY SITUATIONS.
- CLOSET DOORS SHALL BE OPERABLE BY CHILDREN FROM INSIDE.
- SEPARATE PERMIT REQUIRED FOR ROOFING, RAILINGS, WINDOWS AND DOORS. FOR SECURITY ENTRY NOTES REFER TO BUGLARY NOTES SHEET A-003.
- SHOWERS. SHOWER COMPARTMENTS SHALL HAVE FLOORS AND WALLS CONSTRUCTED OF SMOOTH, CORROSION RESISTANT AND NONABSORBENT WATER-RESISTANT MATERIALS TO A HEIGHT OF NOT LESS THAN 70 INCHES (1778 MM) ABOVE THE COMPARTMENT FLOOR AT THE DRAIN.
- 11. SHOWER PANS SHOULD BE WATERPROOFED A MIN. OF 12" UP EACH PERIMETER WALL.
- WINDOWS AT LESS THAN 4FT. FROM DOORS SHALL HAVE CAT. II GLAZING PER FBC SEC. R4410.2.4.3.2
- WHEN THERE IS A DROP OF LESS THAN 4 FT. ON EITHER SIDE OF A WINDOW IT SHALL COMPLY WITH FBC SEC R4410.2.4.2 AND R4403.7.3.1 ALL SHOWER ENCLOSURES AND ANY GLAZING WITHIN 60" OF THE FINISHED FLOOR SURFACE IN WALLS SURROUNDING ANY TUB OR SHOWER ENCLOSURE SHALL BE CAT. II SAFETY GLASS PER FBC 2010 R4410.2.6.2 SAFEGUARDS.
- ALL GLASS RAILINGS TO COMPLY WITH FBC SEC. R4403.7.3.6
- GC TO REFER TO INTERIOR DESIGN DRAWINGS FOR CLARIFICATION OF ALL FINISHES AND RELATED DETAILS.
- ALL FINISHES TO BE SELECTED BY OWNER/INTERIOR DESIGNER.
- ALL FINISH HARDWARE TO BE SELECTED BY OWNER/INTERIOR DESIGNER.
- SEE INTERIOR DESIGN FOR ALL BATH ACCESSORIES. GC TO PROVIDE BACKING AS NECESSARY. REFER TO INTERIOR DESIGN DRAWINGS FOR LOCATIONS OF MILLWORK AND OTHER BUILT-IN FURNITURE. PROIVDE PROPER BACKING AS
- NECESSARY. FINISH DIMENSIONS SUBJECT TO CHANGE. REFER TO INTERIOR DESIGN DRAWINGS FOR FINAL DIMENSIONS AND NOTIFY ARCHITECT OF ANY
- CONFLICTS. WALL AND CEILING FINISHES SHALL HAVE A FLAME-SPREAD CLASSIFICATION OF NOT GREATER THAN 200 AND A SMOKE-DEVELOPED INDEX NOT GREATER THAN 450 AS PER ASTM E-84 OR UL 273. FBCR 302.9.
- INSULATION MATERIALS, FACINGS, VAPOR RETARDERS SHALL HAVE A FLAME-SPREAD CLASSIFICATION OF NOT GREATER THAN 25 AND A SMOKE-DEVELOPED INDEX NOT GREATER THAN 450 AS PER ASTM E-84 OR UL 273. FBCR 302.10 ALL ELEVATIONS ARE BASED UPON NATIONAL GEODETIC VERTICAL DATUM 1929 (NGVD 1929). ALL ELEVATIONS IN RCPs ARE RELATIVE TO
- GC TO COORDINATE FINAL LOCATION OF ACCESS HATCH WITH MECHANICAL EQUIPMENT AND NOTIFY ARCHITECT OF ANY CONFLICTS.
- GC TO VERIFY SPACE REQUIRED FOR VERTICAL AIR DIFFUSERS AND RETURNS IN COVES.

ISSUE DATE: 01/03/2022 DRB FINAL SUBMITTAL Description 12/20/2021 Revision 1

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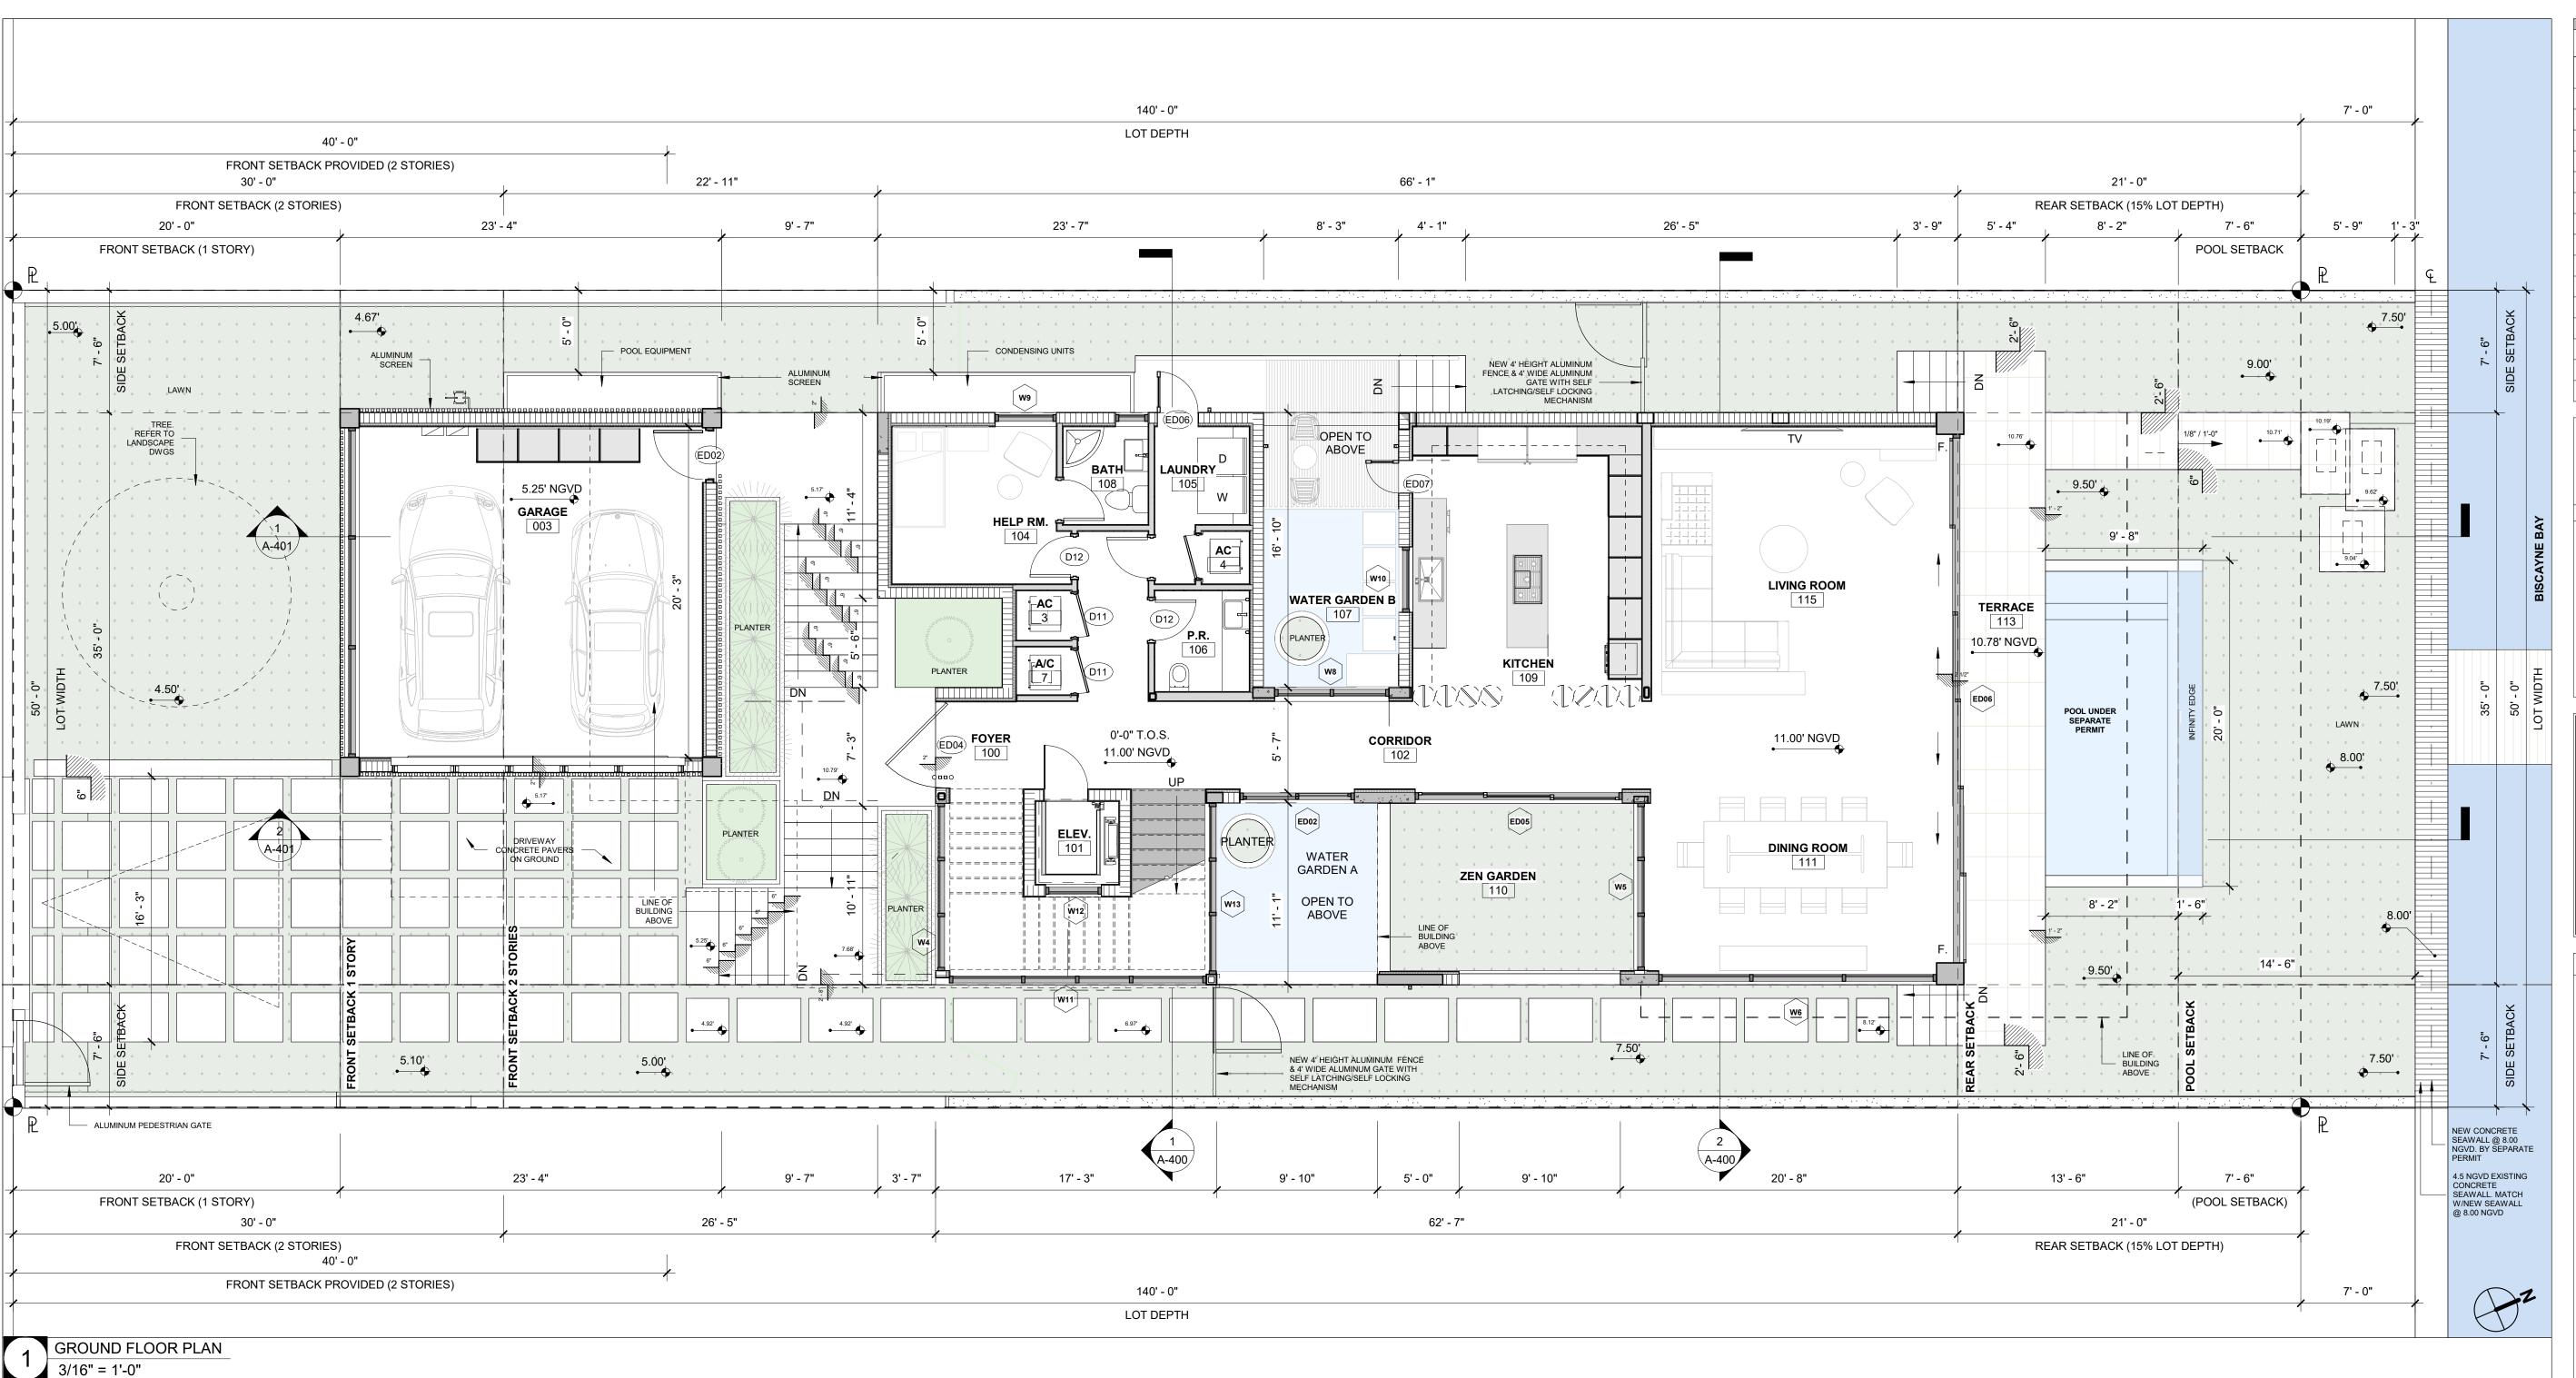
Project Name

## CASA BAHIA

253 N COCONUT LN MIAMI BEACH, FLORIDA, 33139 FOLIO # 02-4205-002-0160

21-3600 Project Number Drawing Name

Scale:

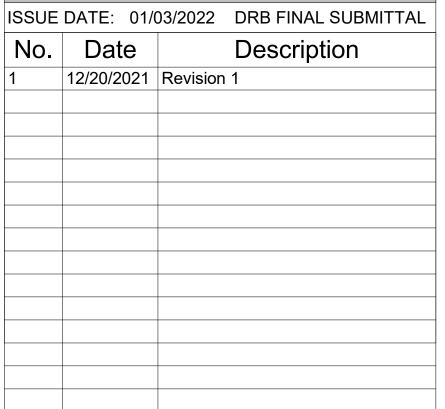


## **FLOOD NOTES:**

- FLOOD OPENINGS WILL PROVIDE EQUALIZATION OF HYDROSTATIC FLOOD FORCES ON EXTERIOR WALLS BY ALLOWING FOR THE AUTOMATIC ENTRY
- AND EXIT OF FLOODWATER AS SPECIFIED IN FBC R322.2.2 AND ASCE 24. FLOOD OPENINGS LOUVERS, SCREEN OR OTHER OPENING COVER SHALL NOT BLOCK OR IMPEDE THE AUTOMATIC FLOW OF FLOOD WATER INTO OR OUT OF ENCLOSED AREA.
- FLOOD OPENINGS SHALL NOT BE LESS THAN 3 INCHES IN ANY DIRECTION IN THE PLANE OF THE WALL
- THE BOTTOM OF EACH FLOOD OPENING SHALL BE NO HIGHER THAN 1.0 FT. ABOVE THE HIGHER OF THE EXTERIOR OR INTERIOR GRADE OR FLOOR IMMEDIATELY BELOW THE OPENING. DISTANCE SHALL BE NOTED ON EXTERIOR ELEVATIONS SHEETS BELOW EACH OPENING. THE TOP OF THE FLOOD OPENING SHALL NOT BE ABOVE DFE, ANY PART OF THE FLOOD OPENING ABOVE THE DFE CANNOT BE COUNTED TOWARDS THE COMPLIANCE WITH THE FLOOD OPENING REQUIREMENTS.
- MATERIALS BELOW DFE (11' NGVD) SHALL BE FLOOD-DAMAGE RESISTANT PER FEMA TECHNICAL BULLETIN 2, MATERIALS CLASS 4 AND 5.

## FLOOR PLAN NOTES

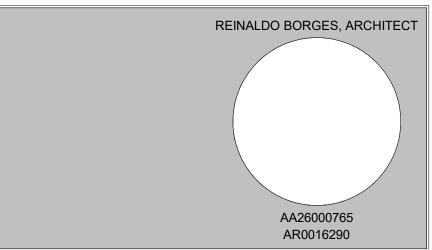
- GC TO PROVIDE MIAMI D.C. PRODUCT CONTROL APPROVAL FOR IMPACT RESISTANT EXTERIOR DOOR AND WINDOWS. ALL BEDROOMS SHALL HAVE 'EGRESS' TYPE DOORS OR WINDOWS, U.O.N. REFER TO DOOR / WINDOW SCHEDULE. THE EGRESS WINDOW SHALL BE OPERABLE FROM THE INSIDE WITHOUT THE USE OF TOOLS AND PROVIDING A CLEAR OPENING OF NOT LESS THAN 20" IN WIDTH, 24" IN HEIGHT, AND 5.7 SQ.FT. IN AREA. THE BOTTOM OF THE OPENING SHALL NOT BE MORE THAN 44" OFF THE FLOOR. THE MODE OF OPERATION DOES NOT REQUIRE THE USE OF A KEY, TOOL, SPECIAL KNOWLEDGE, OR EFFORT TO MAKE AVAILABLE THE REQUIRED CLEAR OPENING, AND
- NO PART OF THE MECHANISM SHALL BE PLACED HIGHER THAN 54" ABOVE THE FINISHED FLOOR. GENERAL CONTRACTOR TO VERIFY AND COORDINATE ACTUAL WINDOW DIMENSIONS AND ROUGH OPENINGS PRIOR TO CONSTRUCTION.
- ANY CHANGE OF INTERIOR FINISHES BY OWNER/G.C. SHALL BE COORDINATED WITH ARCHITECT OF RECORD.
- INTERIOR / EXTERIOR PARTITION FRAMING, SIZING AND REINFORCING TO BE BY SPECIALTY ENGINEERING.
- BATH DOORS SHALL BE OPERABLE FROM OUTSIDE IN EMERGENCY SITUATIONS.
- CLOSET DOORS SHALL BE OPERABLE BY CHILDREN FROM INSIDE.
- SEPARATE PERMIT REQUIRED FOR ROOFING, RAILINGS, WINDOWS AND DOORS. FOR SECURITY ENTRY NOTES REFER TO BUGLARY NOTES SHEET A-003.
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- SHOWER PANS SHOULD BE WATERPROOFED A MIN. OF 12" UP EACH PERIMETER WALL.
- WINDOWS AT LESS THAN 4FT. FROM DOORS SHALL HAVE CAT. II GLAZING PER FBC SEC. R4410.2.4.3.2
- WHEN THERE IS A DROP OF LESS THAN 4 FT. ON EITHER SIDE OF A WINDOW IT SHALL COMPLY WITH FBC SEC R4410.2.4.2 AND R4403.7.3.1 ALL SHOWER ENCLOSURES AND ANY GLAZING WITHIN 60" OF THE FINISHED FLOOR SURFACE IN WALLS SURROUNDING ANY TUB OR SHOWER ENCLOSURE SHALL BE CAT. II SAFETY GLASS PER FBC 2010 R4410.2.6.2 SAFEGUARDS.
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- ALL FINISHES TO BE SELECTED BY OWNER/INTERIOR DESIGNER. ALL FINISH HARDWARE TO BE SELECTED BY OWNER/INTERIOR DESIGNER.
- SEE INTERIOR DESIGN FOR ALL BATH ACCESSORIES. GC TO PROVIDE BACKING AS NECESSARY.
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Project Team

Project Name

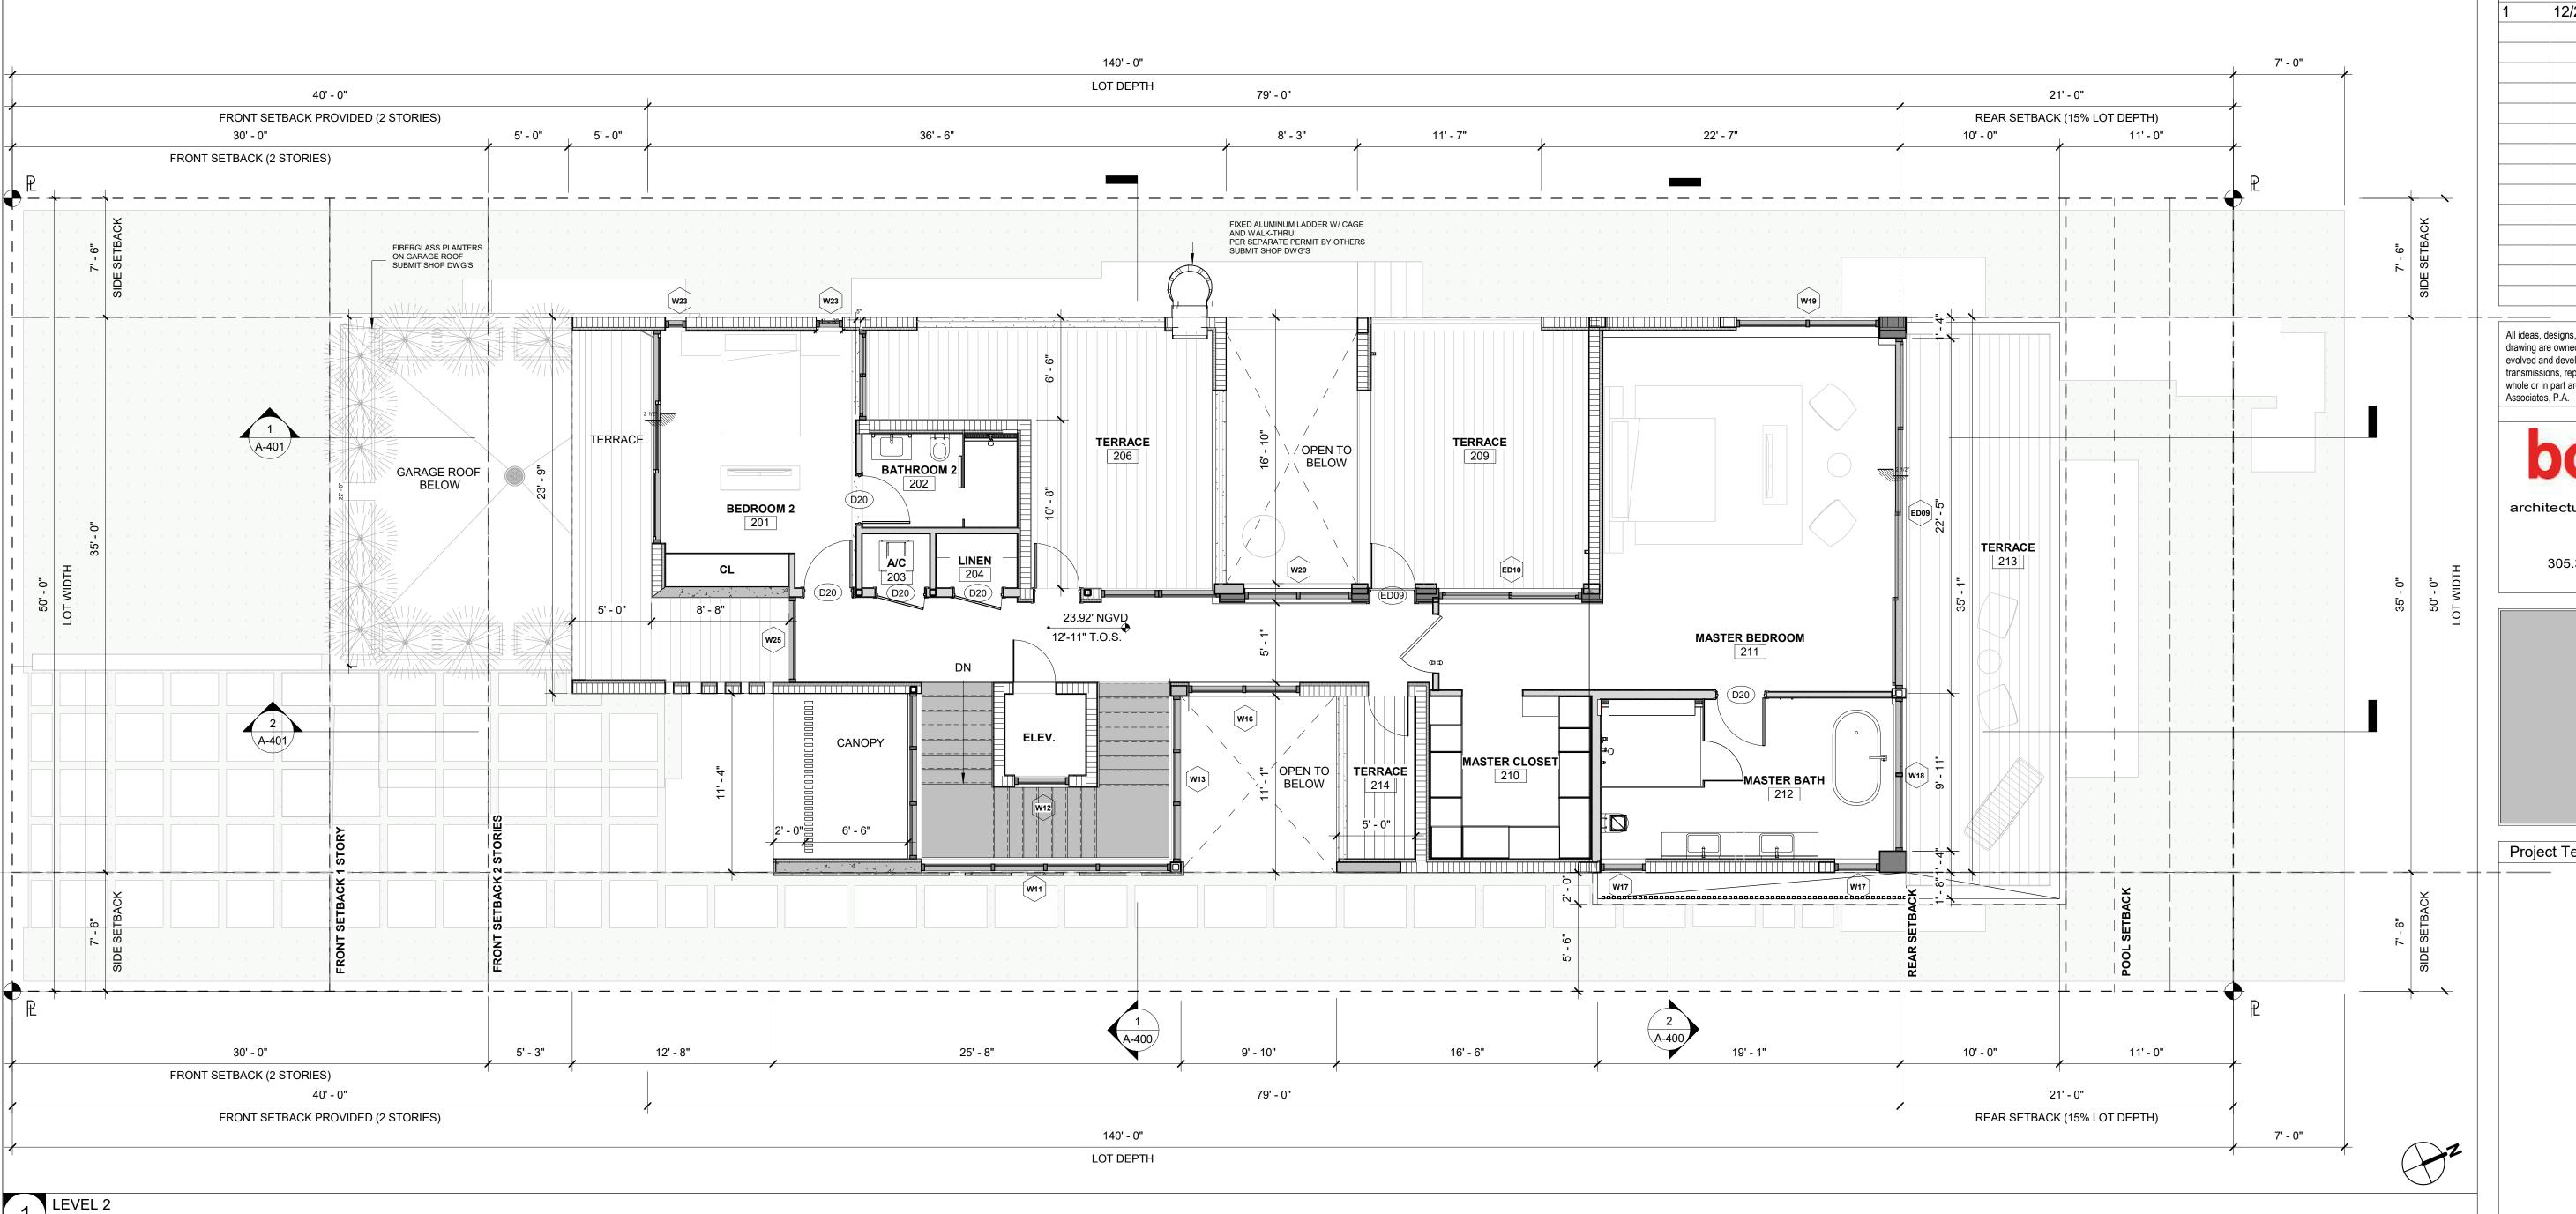
## CASA BAHIA

253 N COCONUT LN MIAMI BEACH, FLORIDA, 33139 FOLIO # 02-4205-002-0160

Project Number 21-3600 Drawing Name **GROUND FLOOR PLAN** 

Scale: Drawing Number

As indicated



3/16" = 1'-0"

#### **FLOOD NOTES:**

ENCLOSED AREA.

- FLOOD OPENINGS WILL PROVIDE EQUALIZATION OF HYDROSTATIC FLOOD FORCES ON EXTERIOR WALLS BY ALLOWING FOR THE AUTOMATIC ENTRY AND
- EXIT OF FLOODWATER AS SPECIFIED IN FBC R322.2.2 AND ASCE 24. FLOOD OPENINGS LOUVERS, SCREEN OR OTHER OPENING COVER SHALL NOT BLOCK OR IMPEDE THE AUTOMATIC FLOW OF FLOOD WATER INTO OR OUT OF
- FLOOD OPENINGS SHALL NOT BE LESS THAN 3 INCHES IN ANY DIRECTION IN THE PLANE OF THE WALL
- THE BOTTOM OF EACH FLOOD OPENING SHALL BE NO HIGHER THAN 1.0 FT. ABOVE THE HIGHER OF THE EXTERIOR OR INTERIOR GRADE OR FLOOR IMMEDIATELY BELOW THE OPENING. DISTANCE SHALL BE NOTED ON EXTERIOR ELEVATIONS SHEETS BELOW EACH OPENING. THE TOP OF THE FLOOD OPENING SHALL NOT BE ABOVE DFE, ANY PART OF THE FLOOD OPENING ABOVE THE DFE CANNOT BE COUNTED TOWARDS THE COMPLIANCE WITH THE FLOOD OPENING REQUIREMENTS.
- MATERIALS BELOW DFE (11' NGVD) SHALL BE FLOOD-DAMAGE RESISTANT PER FEMA TECHNICAL BULLETIN 2, MATERIALS CLASS 4 AND 5.

## FLOOR PLAN NOTES

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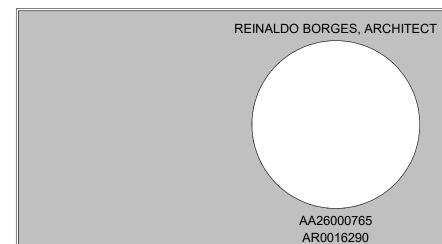
ISSUE DATE: 01/03/2022 DRB FINAL SUBMITTAL

12/20/2021 Revision 1

Description

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Project Team

Project Name

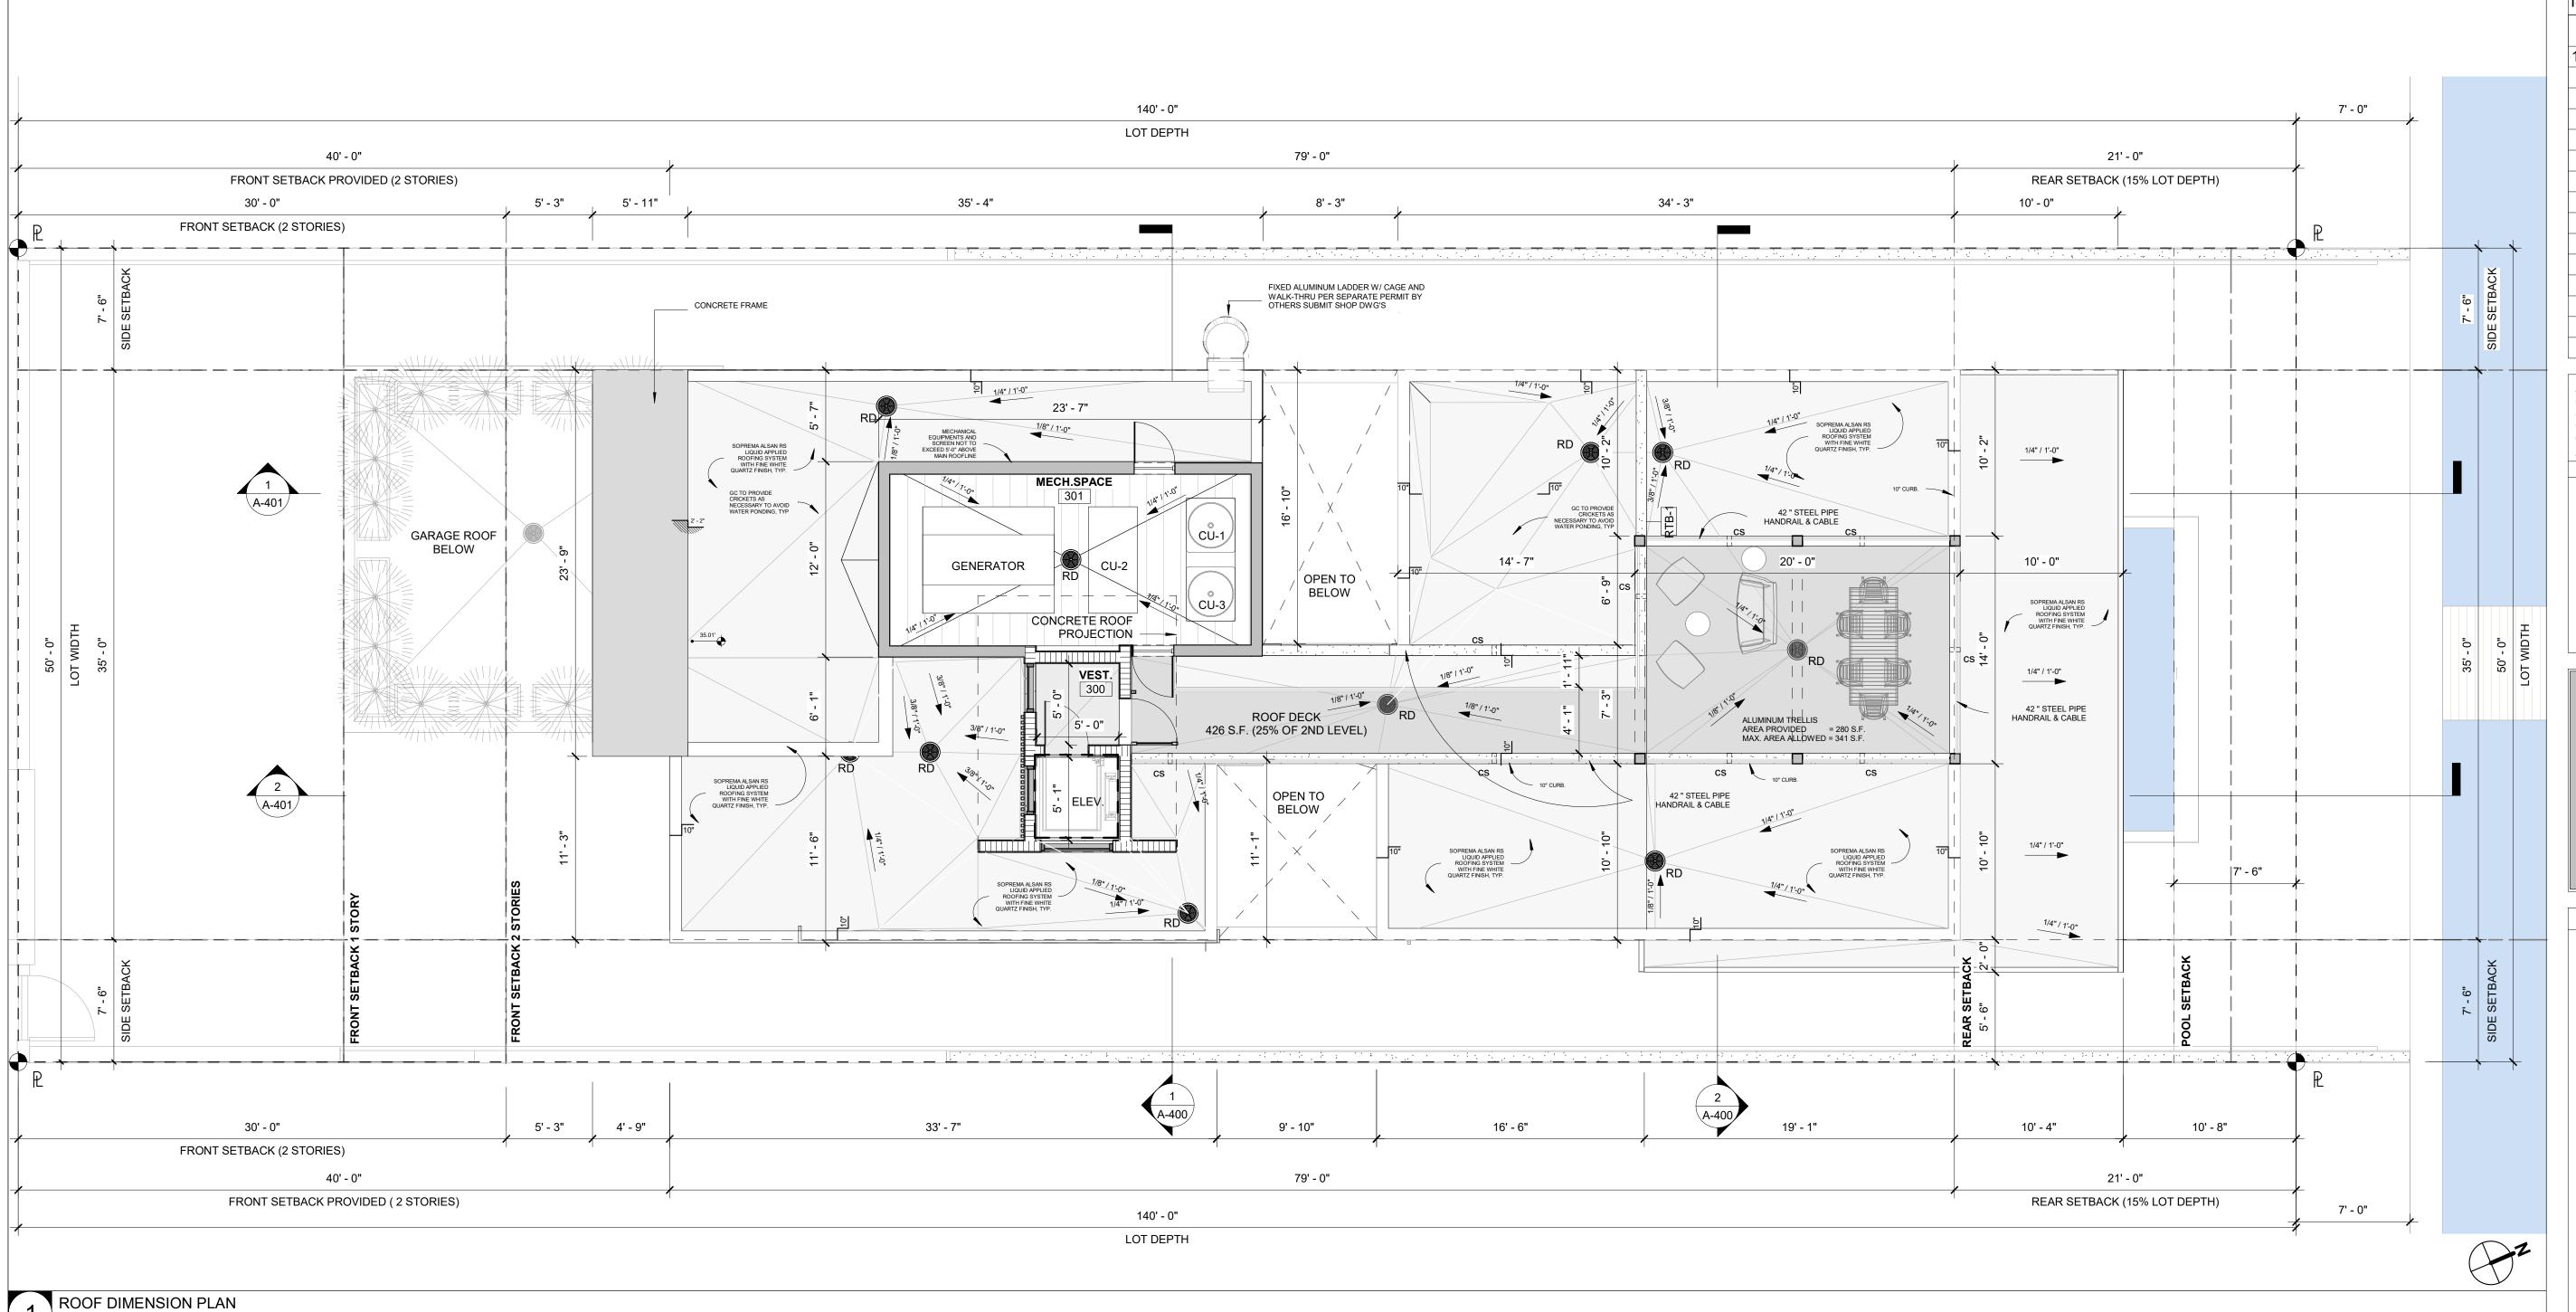
CASA BAHIA

253 N COCONUT LN MIAMI BEACH, FLORIDA, 33139 FOLIO # 02-4205-002-0160

21-3600 Project Number Drawing Name LEVEL 2 - FLOOR PLAN

Scale:

As indicated



3/16" = 1'-0"

#### **FLOOD NOTES:**

- FLOOD OPENINGS WILL PROVIDE EQUALIZATION OF HYDROSTATIC FLOOD FORCES ON EXTERIOR WALLS BY ALLOWING FOR THE AUTOMATIC ENTRY AND EXIT OF FLOODWATER AS SPECIFIED IN FBC R322.2.2 AND ASCE 24. FLOOD OPENINGS LOUVERS, SCREEN OR OTHER OPENING COVER SHALL NOT BLOCK OR IMPEDE THE AUTOMATIC FLOW OF FLOOD WATER INTO OR
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#### **ROOF NOTES:**

- CLOSED CELL ICYNENE SPRAYED FOAM INSULATION OR SIMILAR APPROVED. PROVIDE OVERCOAT INTUMESCENT. MUST BE SEPARATED FROM THE INTERIOR OF THE BUILDING BY AN APPROVED THERMAL BARRIER SUCH A S 1/2- INCH GYPSUM WALLBOARD INSTALLED USING MECHANICAL FASTENERS IN ACCORDANDE WITH APPLIACABLE CODE OR AN EQUIVALENT 15-MINUTE THERMAL BARRIER. GC TO INSTALL PRODUCT AS PER MANUFACTURER SPECIFICATIONS. INSTALL UNDER ROOF SLABS OVER ALL INHABITABLE AREAS. R-30 MIN. TYP.
- ALL ROOF TO BE COVERED WITH LIQUID APPLIED SOPREMA ALSAN RS ROOFING SYSTEM WITH FINE WHITE QUARTZ FINISH OR APPROVED
- ALL ROOFING AND WATERPROOFING DIAGRAMS AND DETAILS TO BE USED IN CONJUNCTION WITH SOPREMA'S GENERAL REQUIREMENTS. APPLICATION METHODS, COUNTY APPROVALS AND APPROVED DETAILS.
- CONTACT THE ARCHITECT SHOULD ANY DISCREPANCY ARISE. COORDINATE FINAL LOCATION OF ROOF PENETRATIONS WITH ARCHITECT AND MEP DRAWINGS.
- ALL ELEVATIONS ARE BASED UPON NATIONAL GEODETIC VERTICAL DATUM 1929 (NGVD 1929).

## FLOOR PLAN NOTES

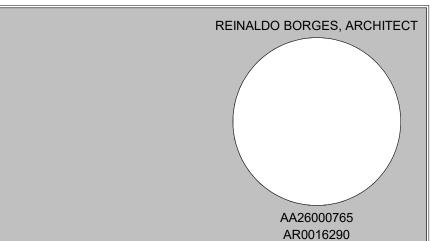
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ISSUE DATE: 01/03/2022 DRB FINAL SUBMITTAL Description 12/20/2021 Revision 1

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Project Team

Project Name

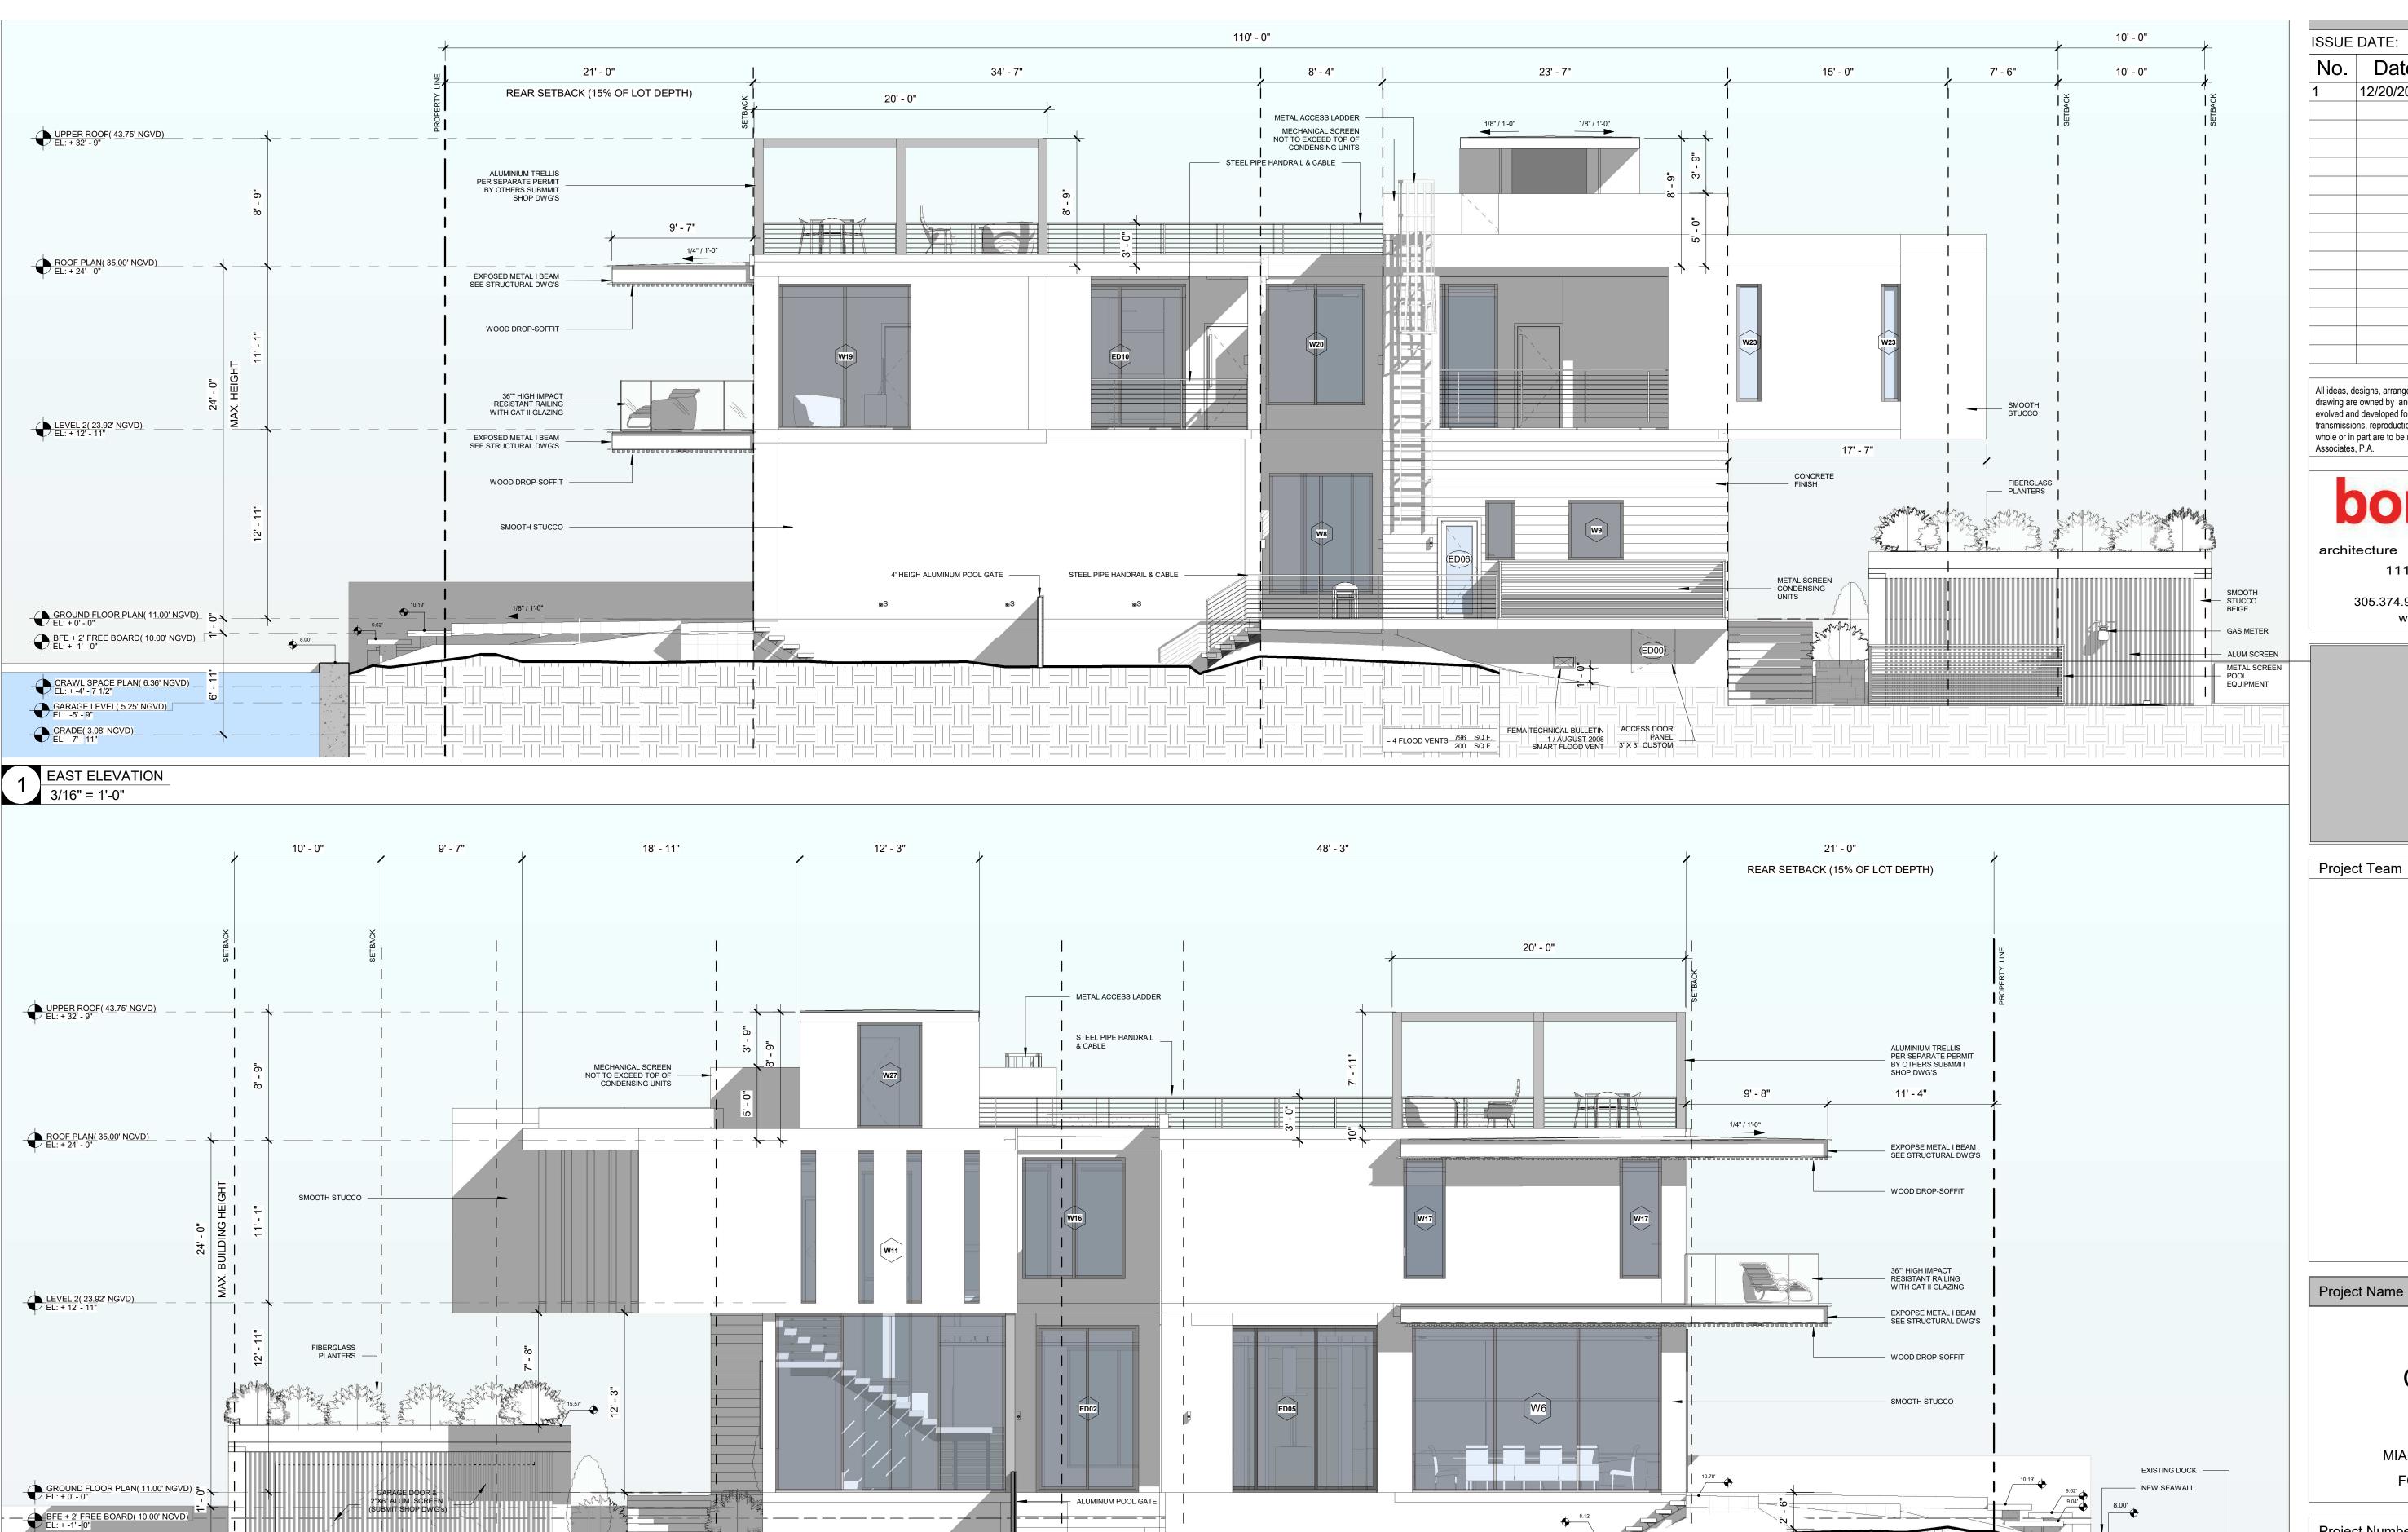
## **CASA BAHIA**

253 N COCONUT LN MIAMI BEACH, FLORIDA, 33139 FOLIO # 02-4205-002-0160

Project Number 21-3600 Drawing Name **ROOF PLAN** 

Scale:

As indicated



FEMA TECHNICAL BULLETIN

1 / AUGUST 2008
SMART FLOOD VENT

= 4 FLOOD VENTS 796 SQ.F. 200 SQ.F.

CRAWL SPACE PLAN( 6.36' NGVD)
EL: + -4' - 7 1/2"

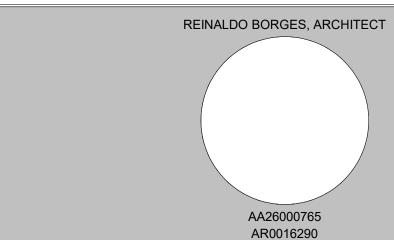
2 WEST ELEVATION
3/16" = 1'-0"

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### Project Name

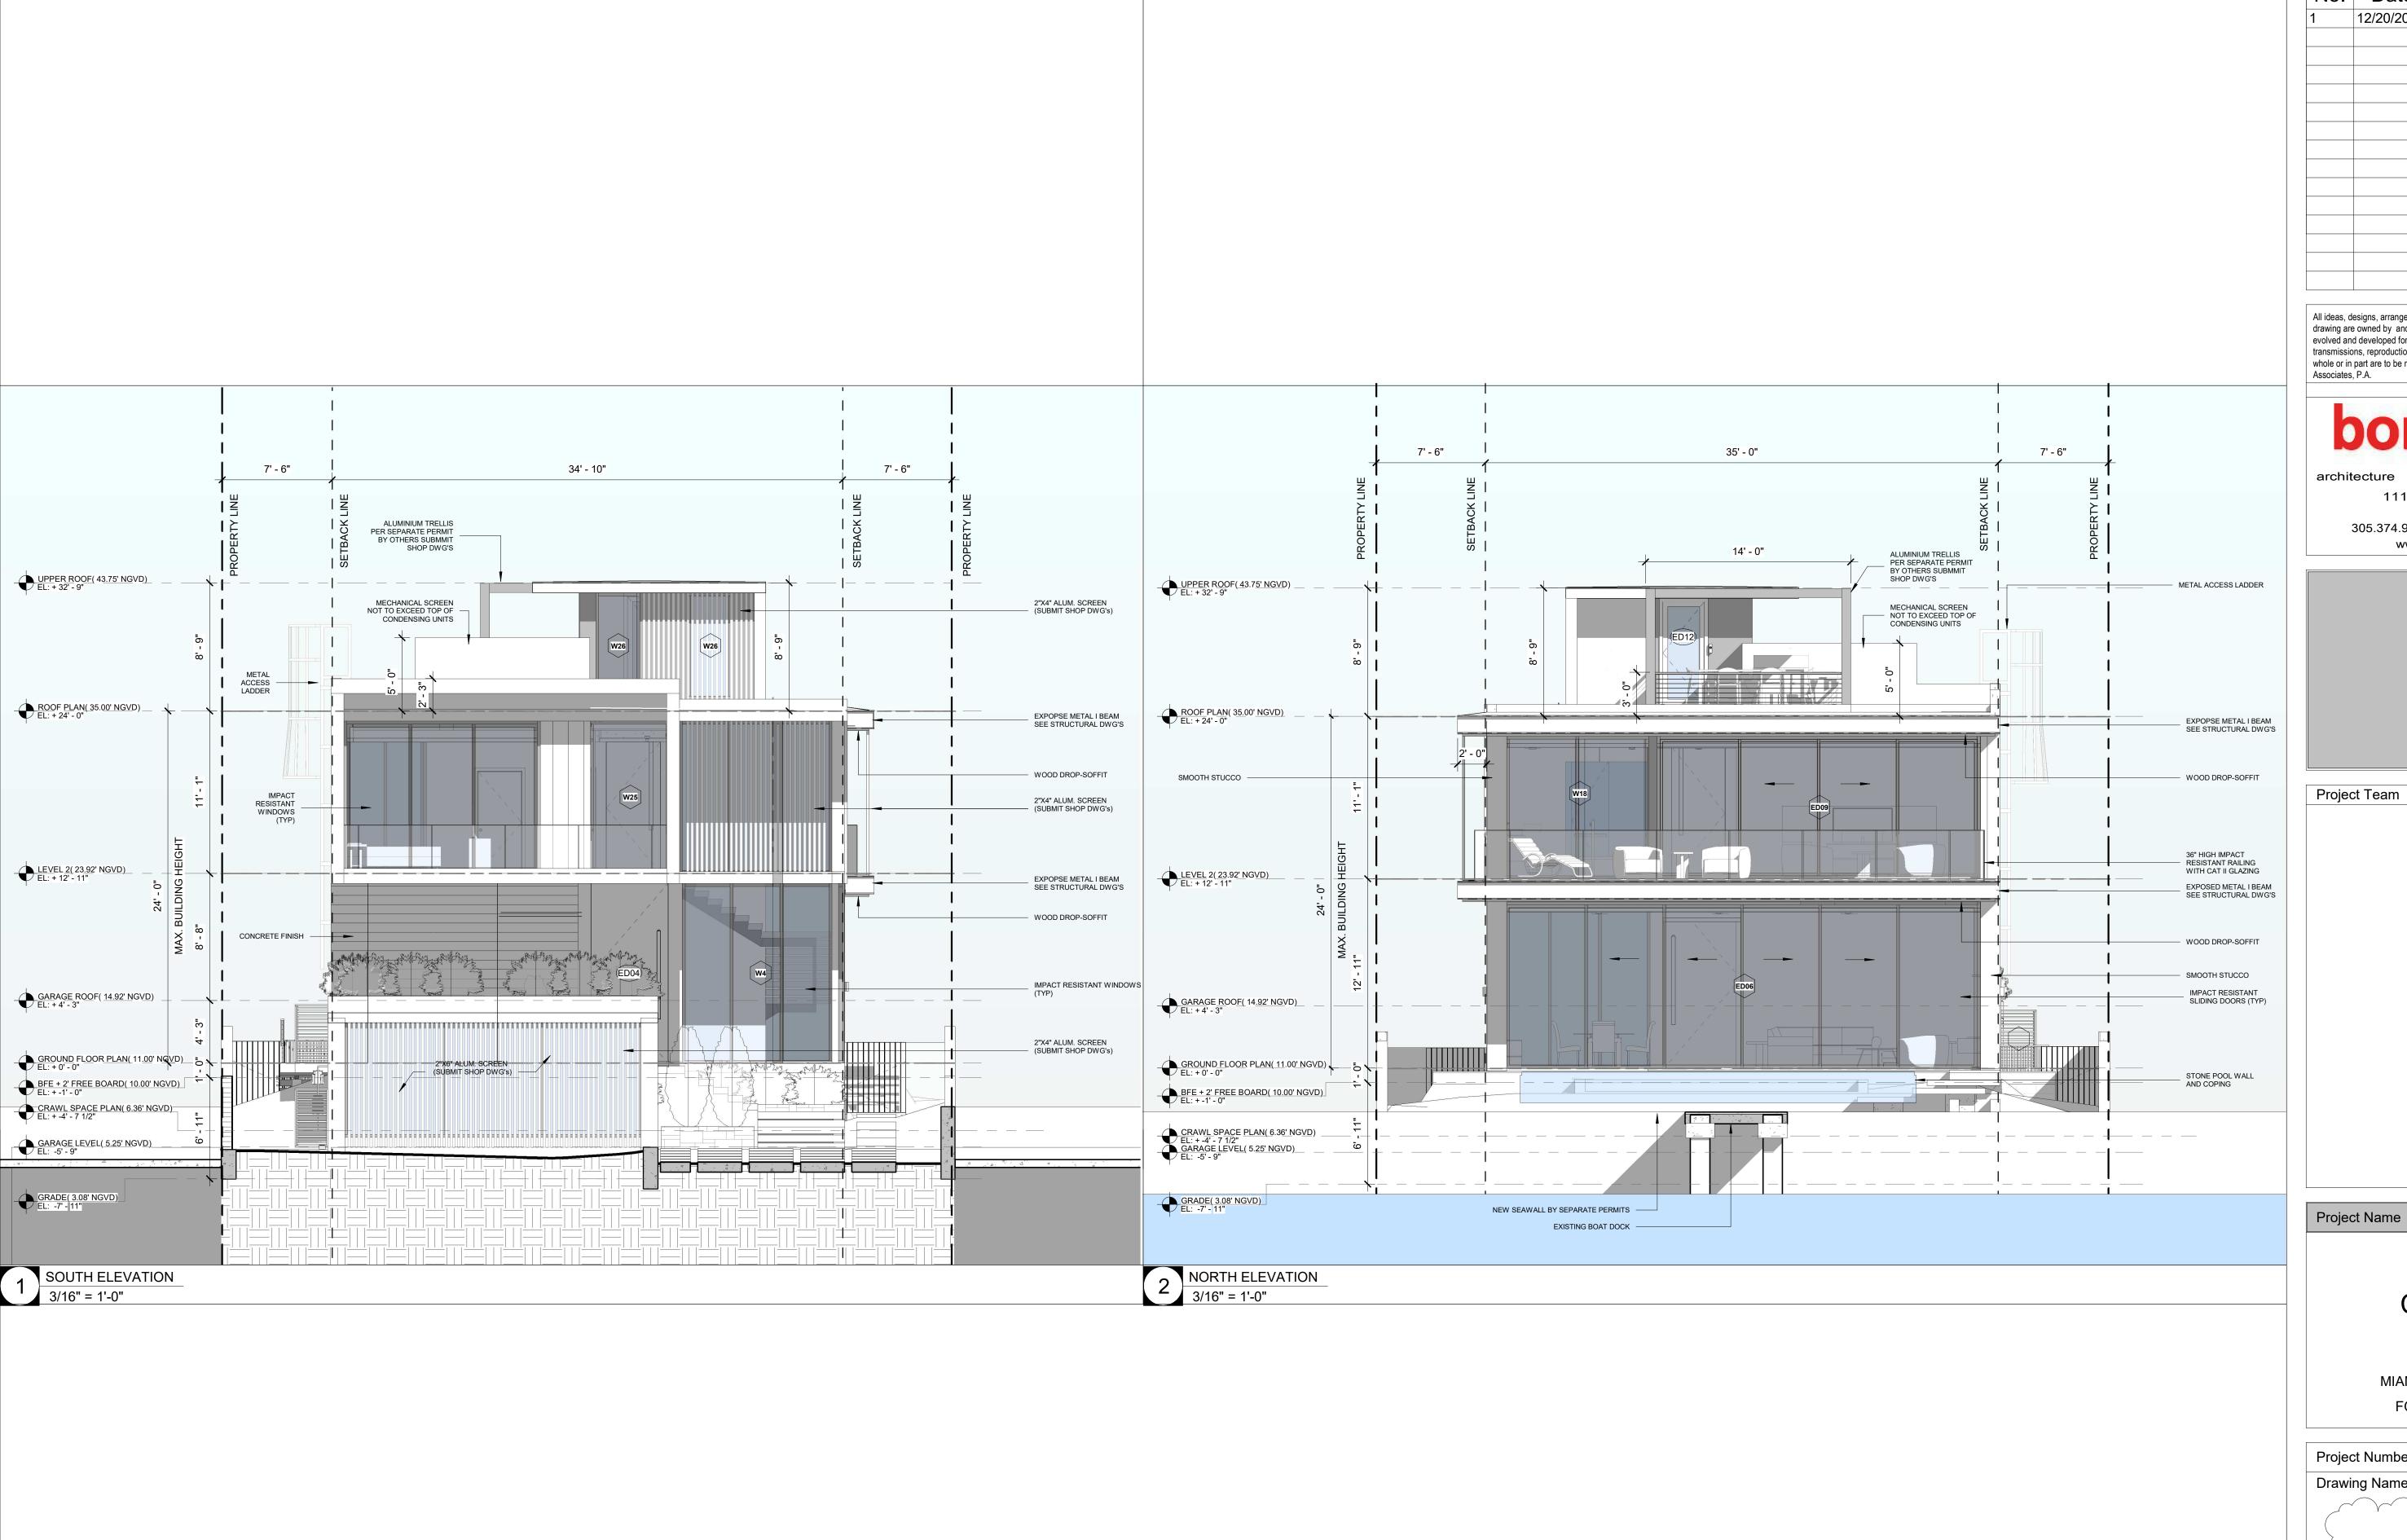
## CASA BAHIA

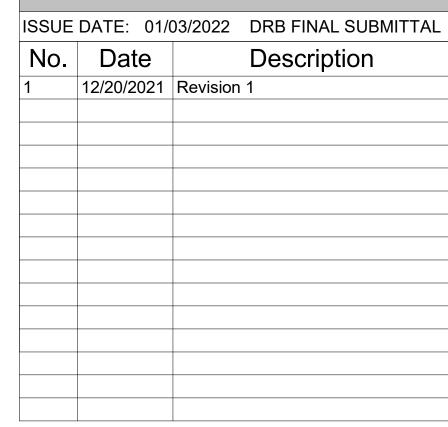
253 N COCONUT LN MIAMI BEACH, FLORIDA, 33139 FOLIO # 02-4205-002-0160

21-3600 Project Number **Drawing Name BUILDING ELEVATIONS** 

Scale:

BISCAYNE BAY

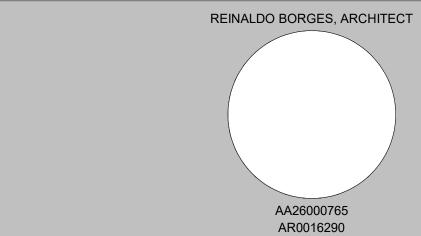




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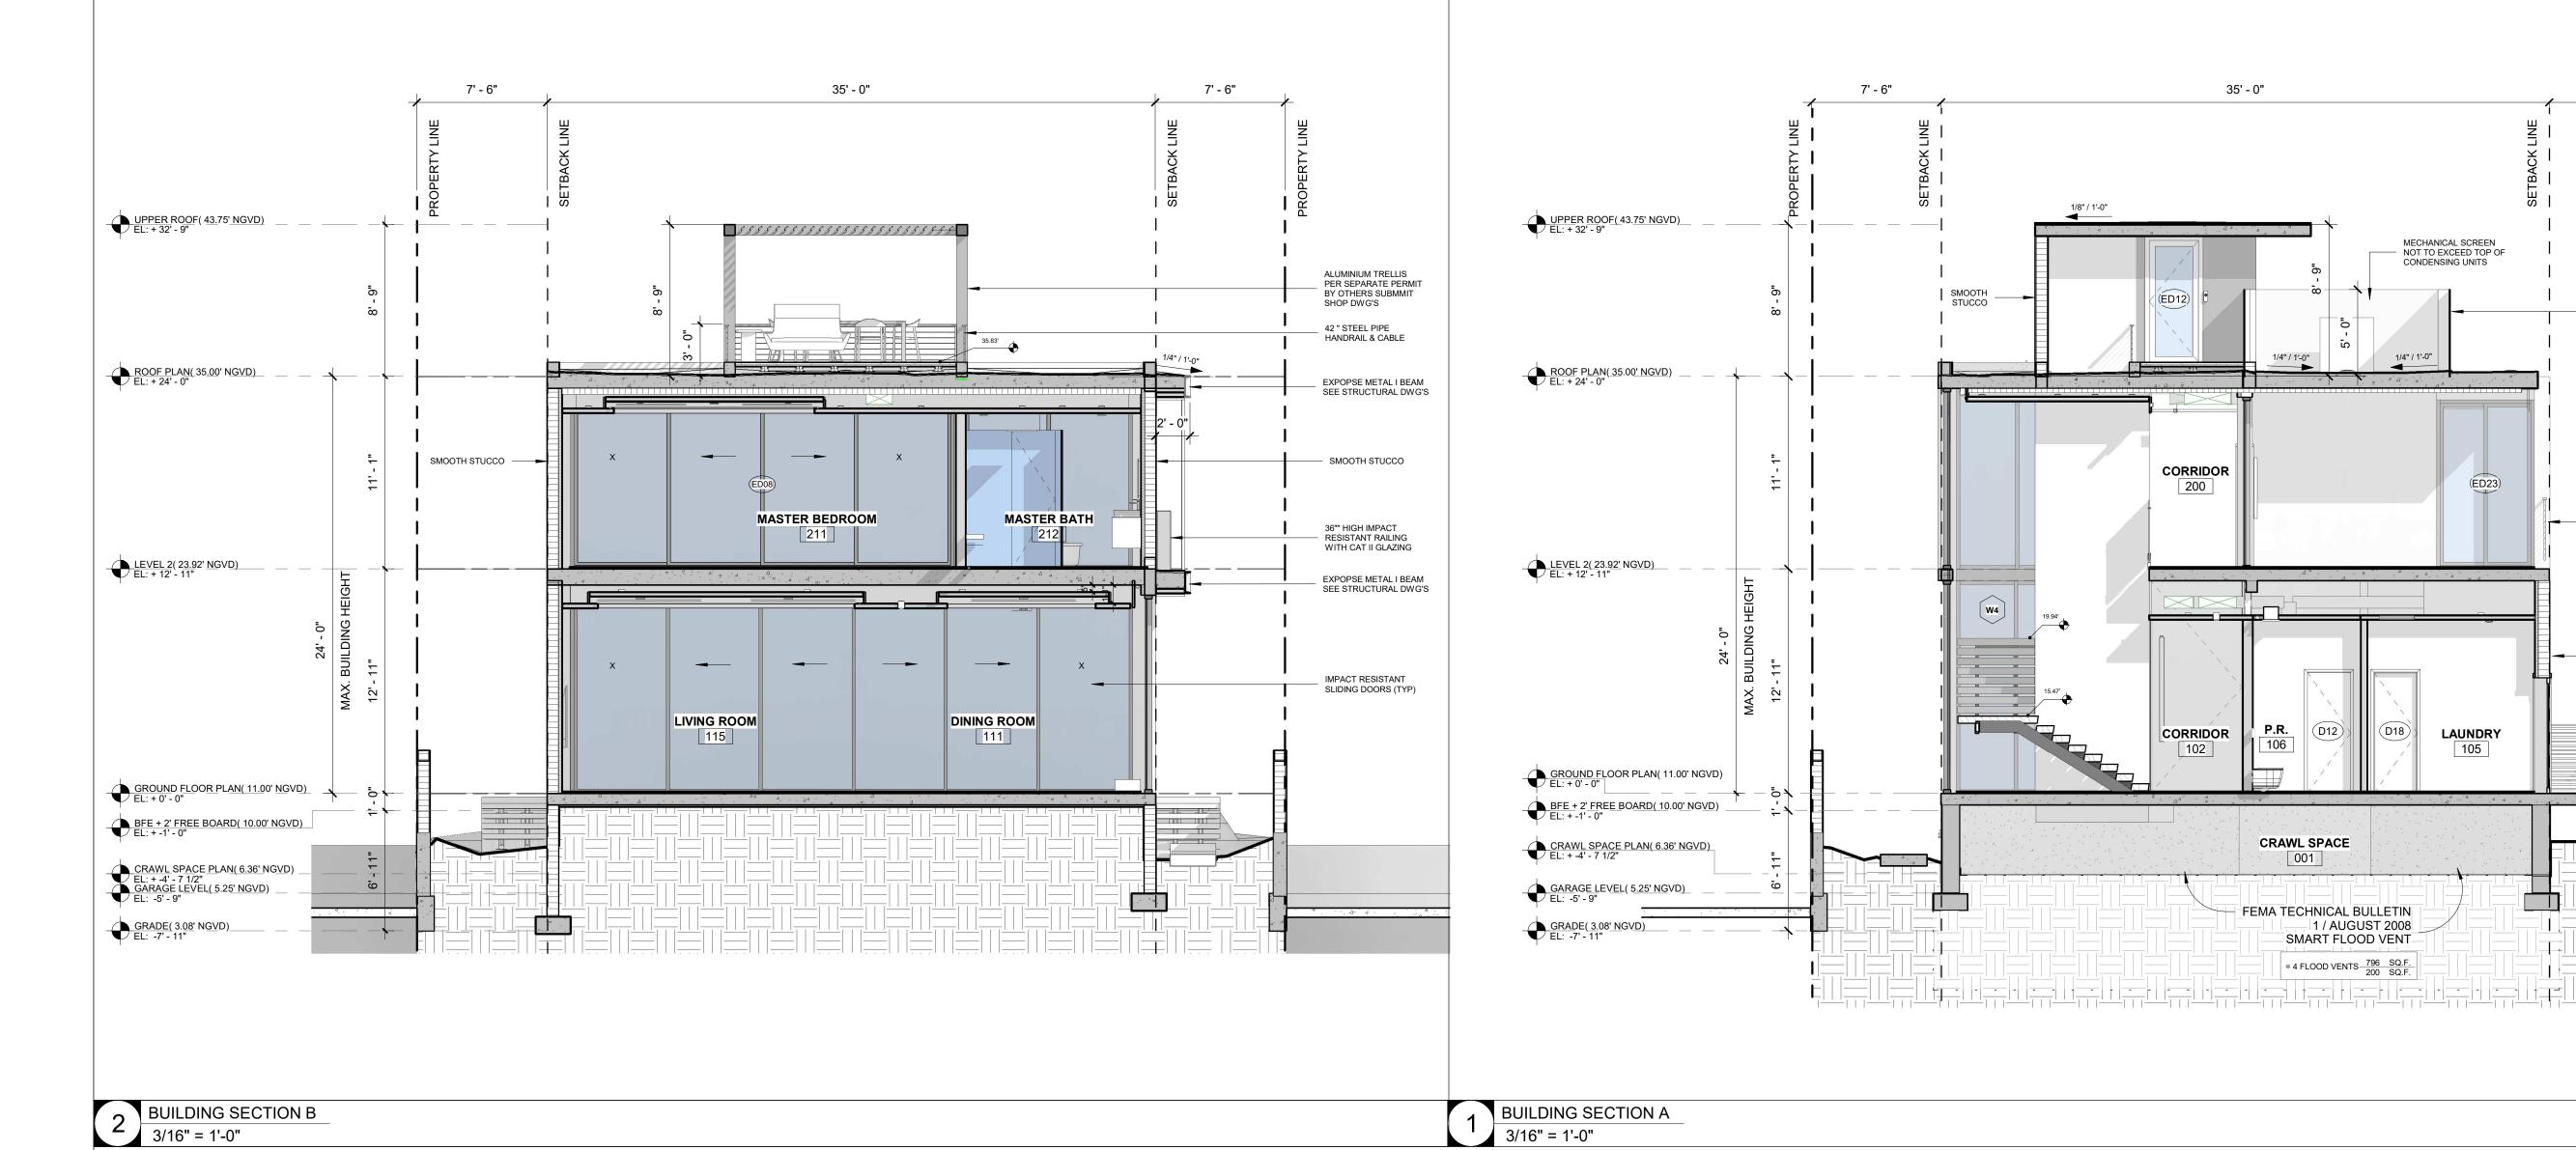
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253 N COCONUT LN MIAMI BEACH, FLORIDA, 33139 FOLIO # 02-4205-002-0160

Project Number 21-3600 Drawing Name **BUILDING ELEVATIONS** 

Scale:

3/16" = 1'-0"



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7' - 6"

- SMOOTH STUCCO

STEEL PIPE — HANDRAIL & CABLE

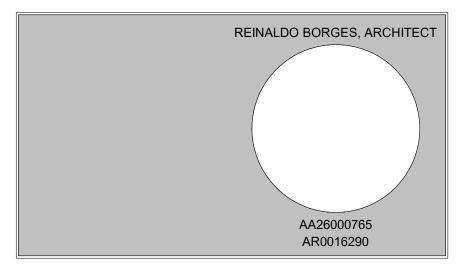
SMOOTH STUCCO

# borges/architects + associates

architecture urban-planning interior-design

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Project Team

Project Name

CASA BAHIA

253 N COCONUT LN MIAMI BEACH, FLORIDA, 33139 FOLIO # 02-4205-002-0160

Project Number 21-3600

Drawing Name

BUILDING SECTIONS

Scale:

Drawing Number

3/16" = 1'-0" \ \textsquare \Lambda - \Lambda \rightarrow \rightar

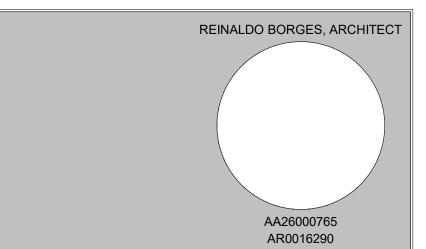
2 BUILDING SECTION D
3/16" = 1'-0"

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21-3600 Project Number **Drawing Name BUILDING SECTIONS** 

Scale: