

**PROFILE** SCALE: 1"=20' (H), 1"=2' (V)

DRAWN BY: N.R.C.

CHECKER: H.J.N.

SCALE: AS SHOWN

100% SET

1700 CONVENTION CENTER DRIVE, MIAMI BEACH, FL.33139

NEIGHBORHOOD:

WEST AVENUE IMPROVEMENTS PHASE II NORTH OF 14 STREET

TITLE:

ROADWAY PLAN AND PROFILE



CITY MANAGER: ALINA T. HUDAK P.W. DIRECTOR: JOSE "JOE" GOMEZ CITY ENGINEER: NELSON PEREZ-JACOME


ENG. OF RECORD: <u>58670</u> ENGINEER OF RECORD: DESIGN ENGINEER: L.F.L. LUIS F. LEON, P.E. VICE PRESIDENT


NO. DATE REVISION


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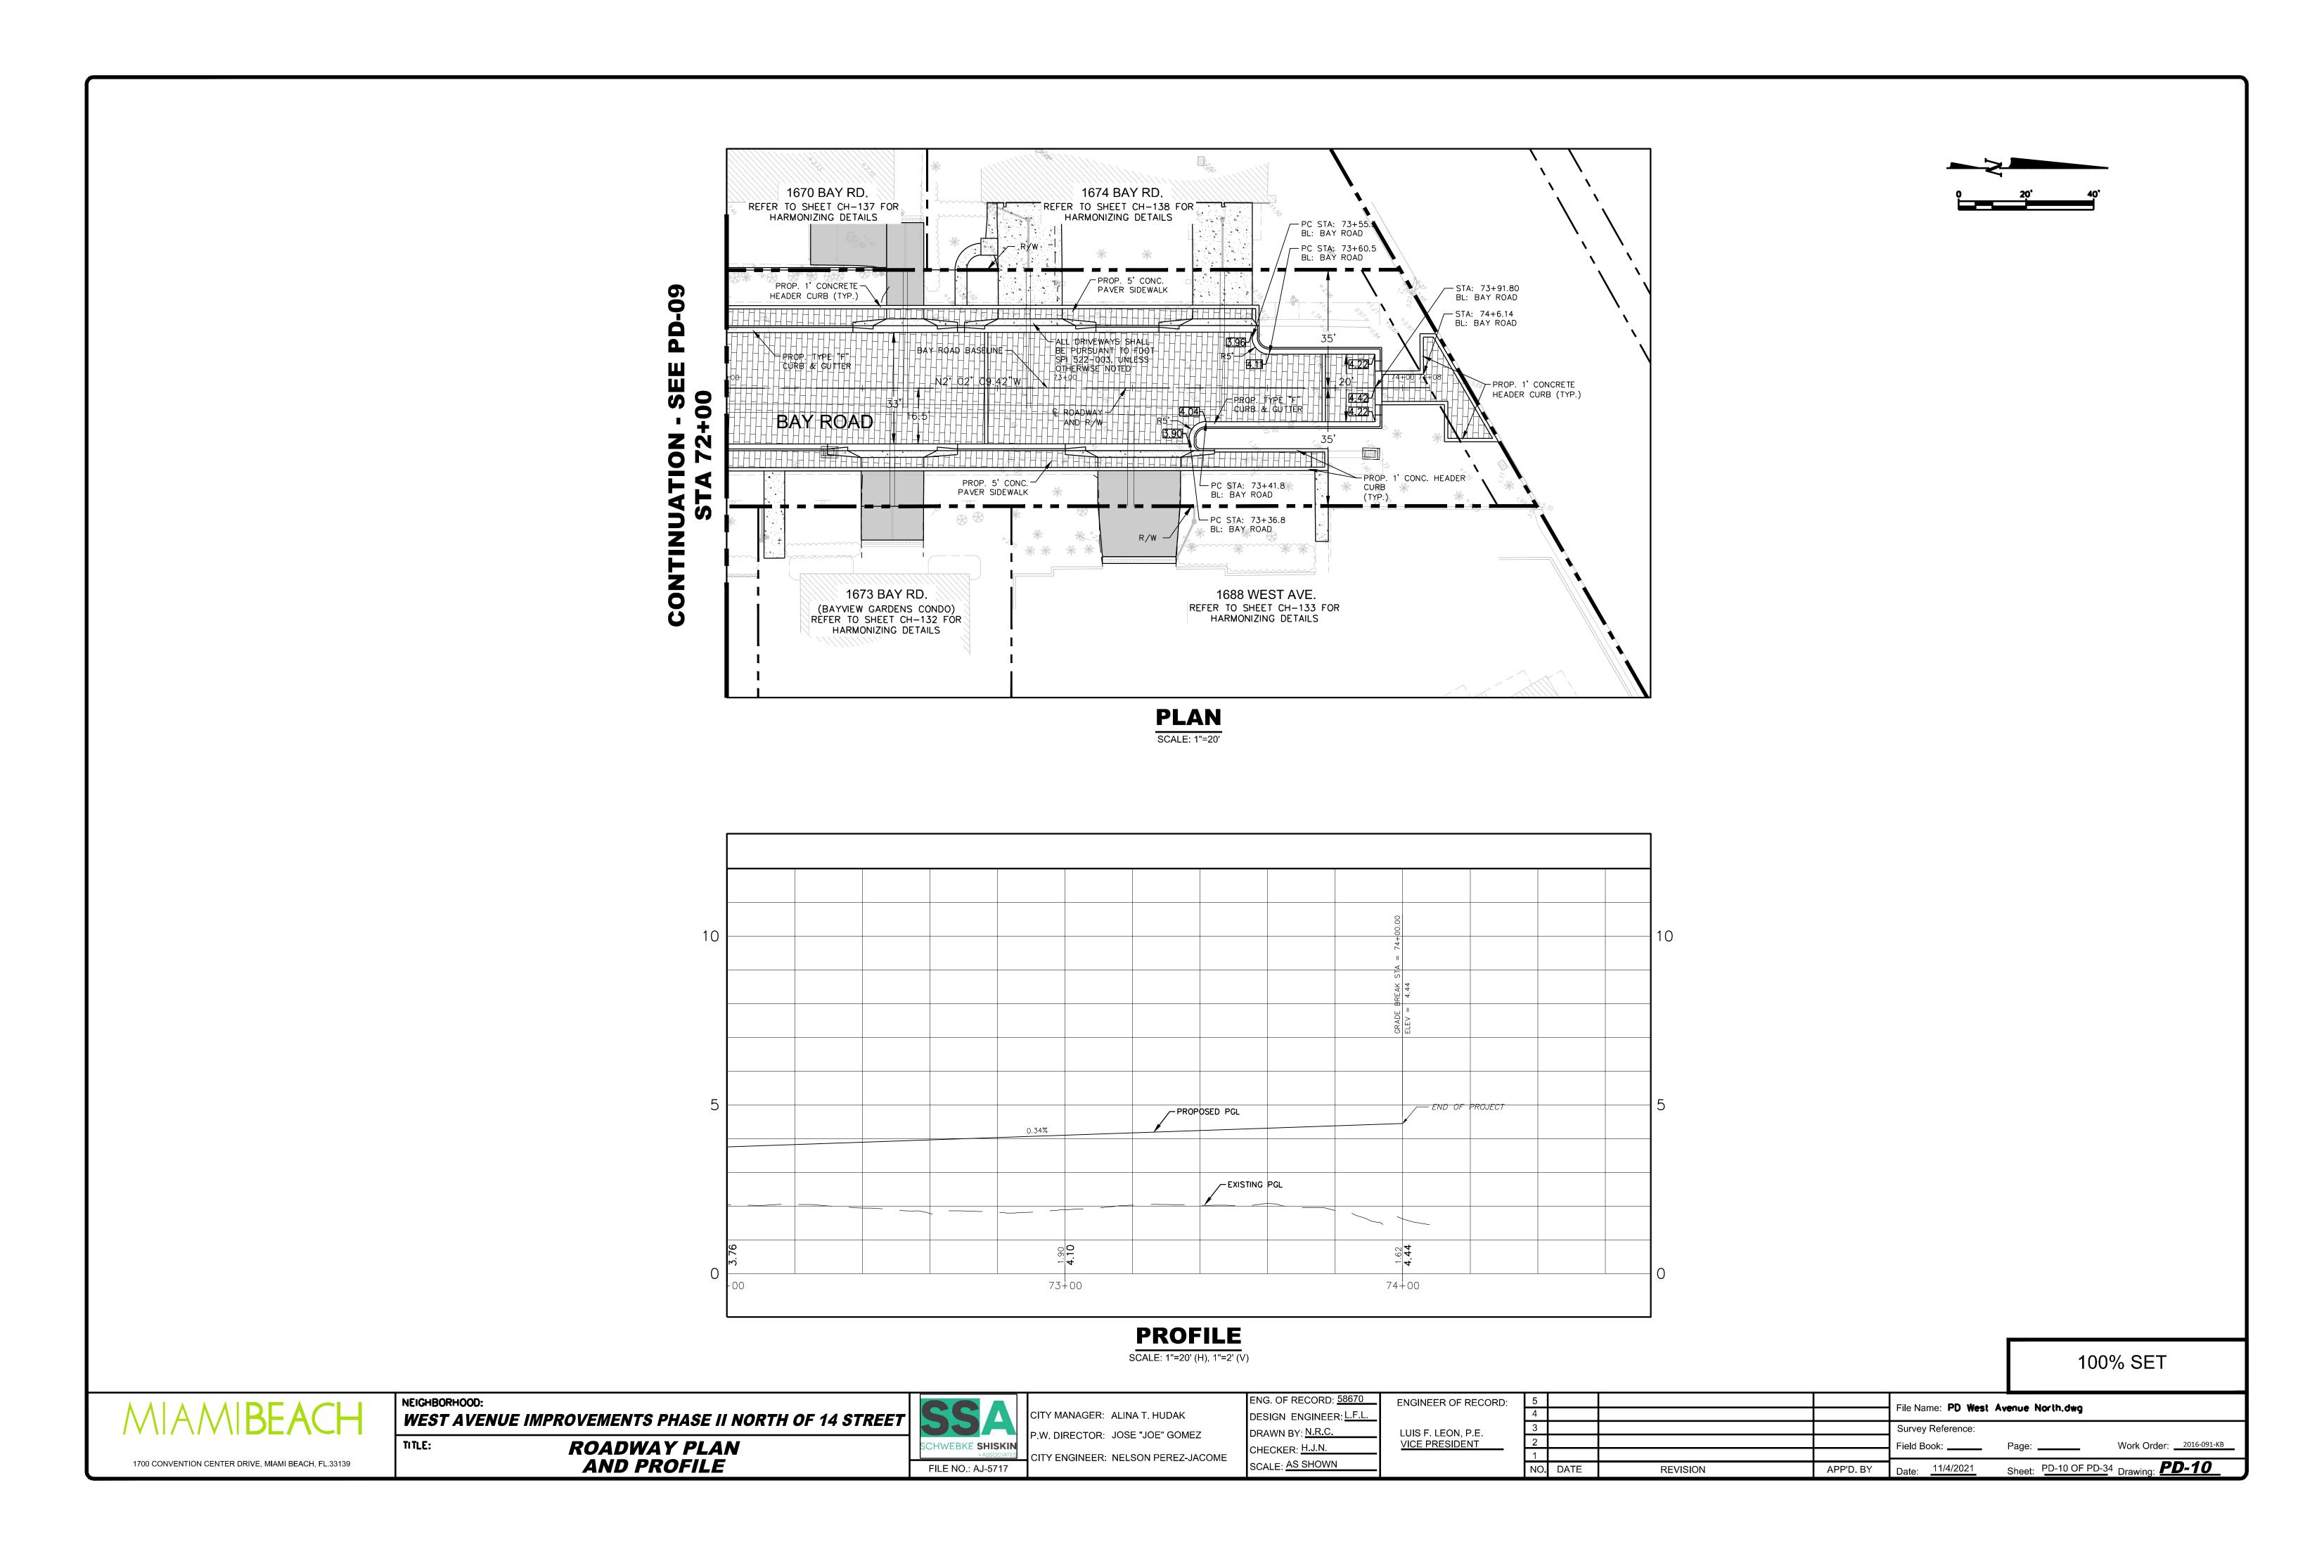
Work Order: 2016-091-KB Sheet: PD-06 OF PD-34 Drawing: **PD-06** 

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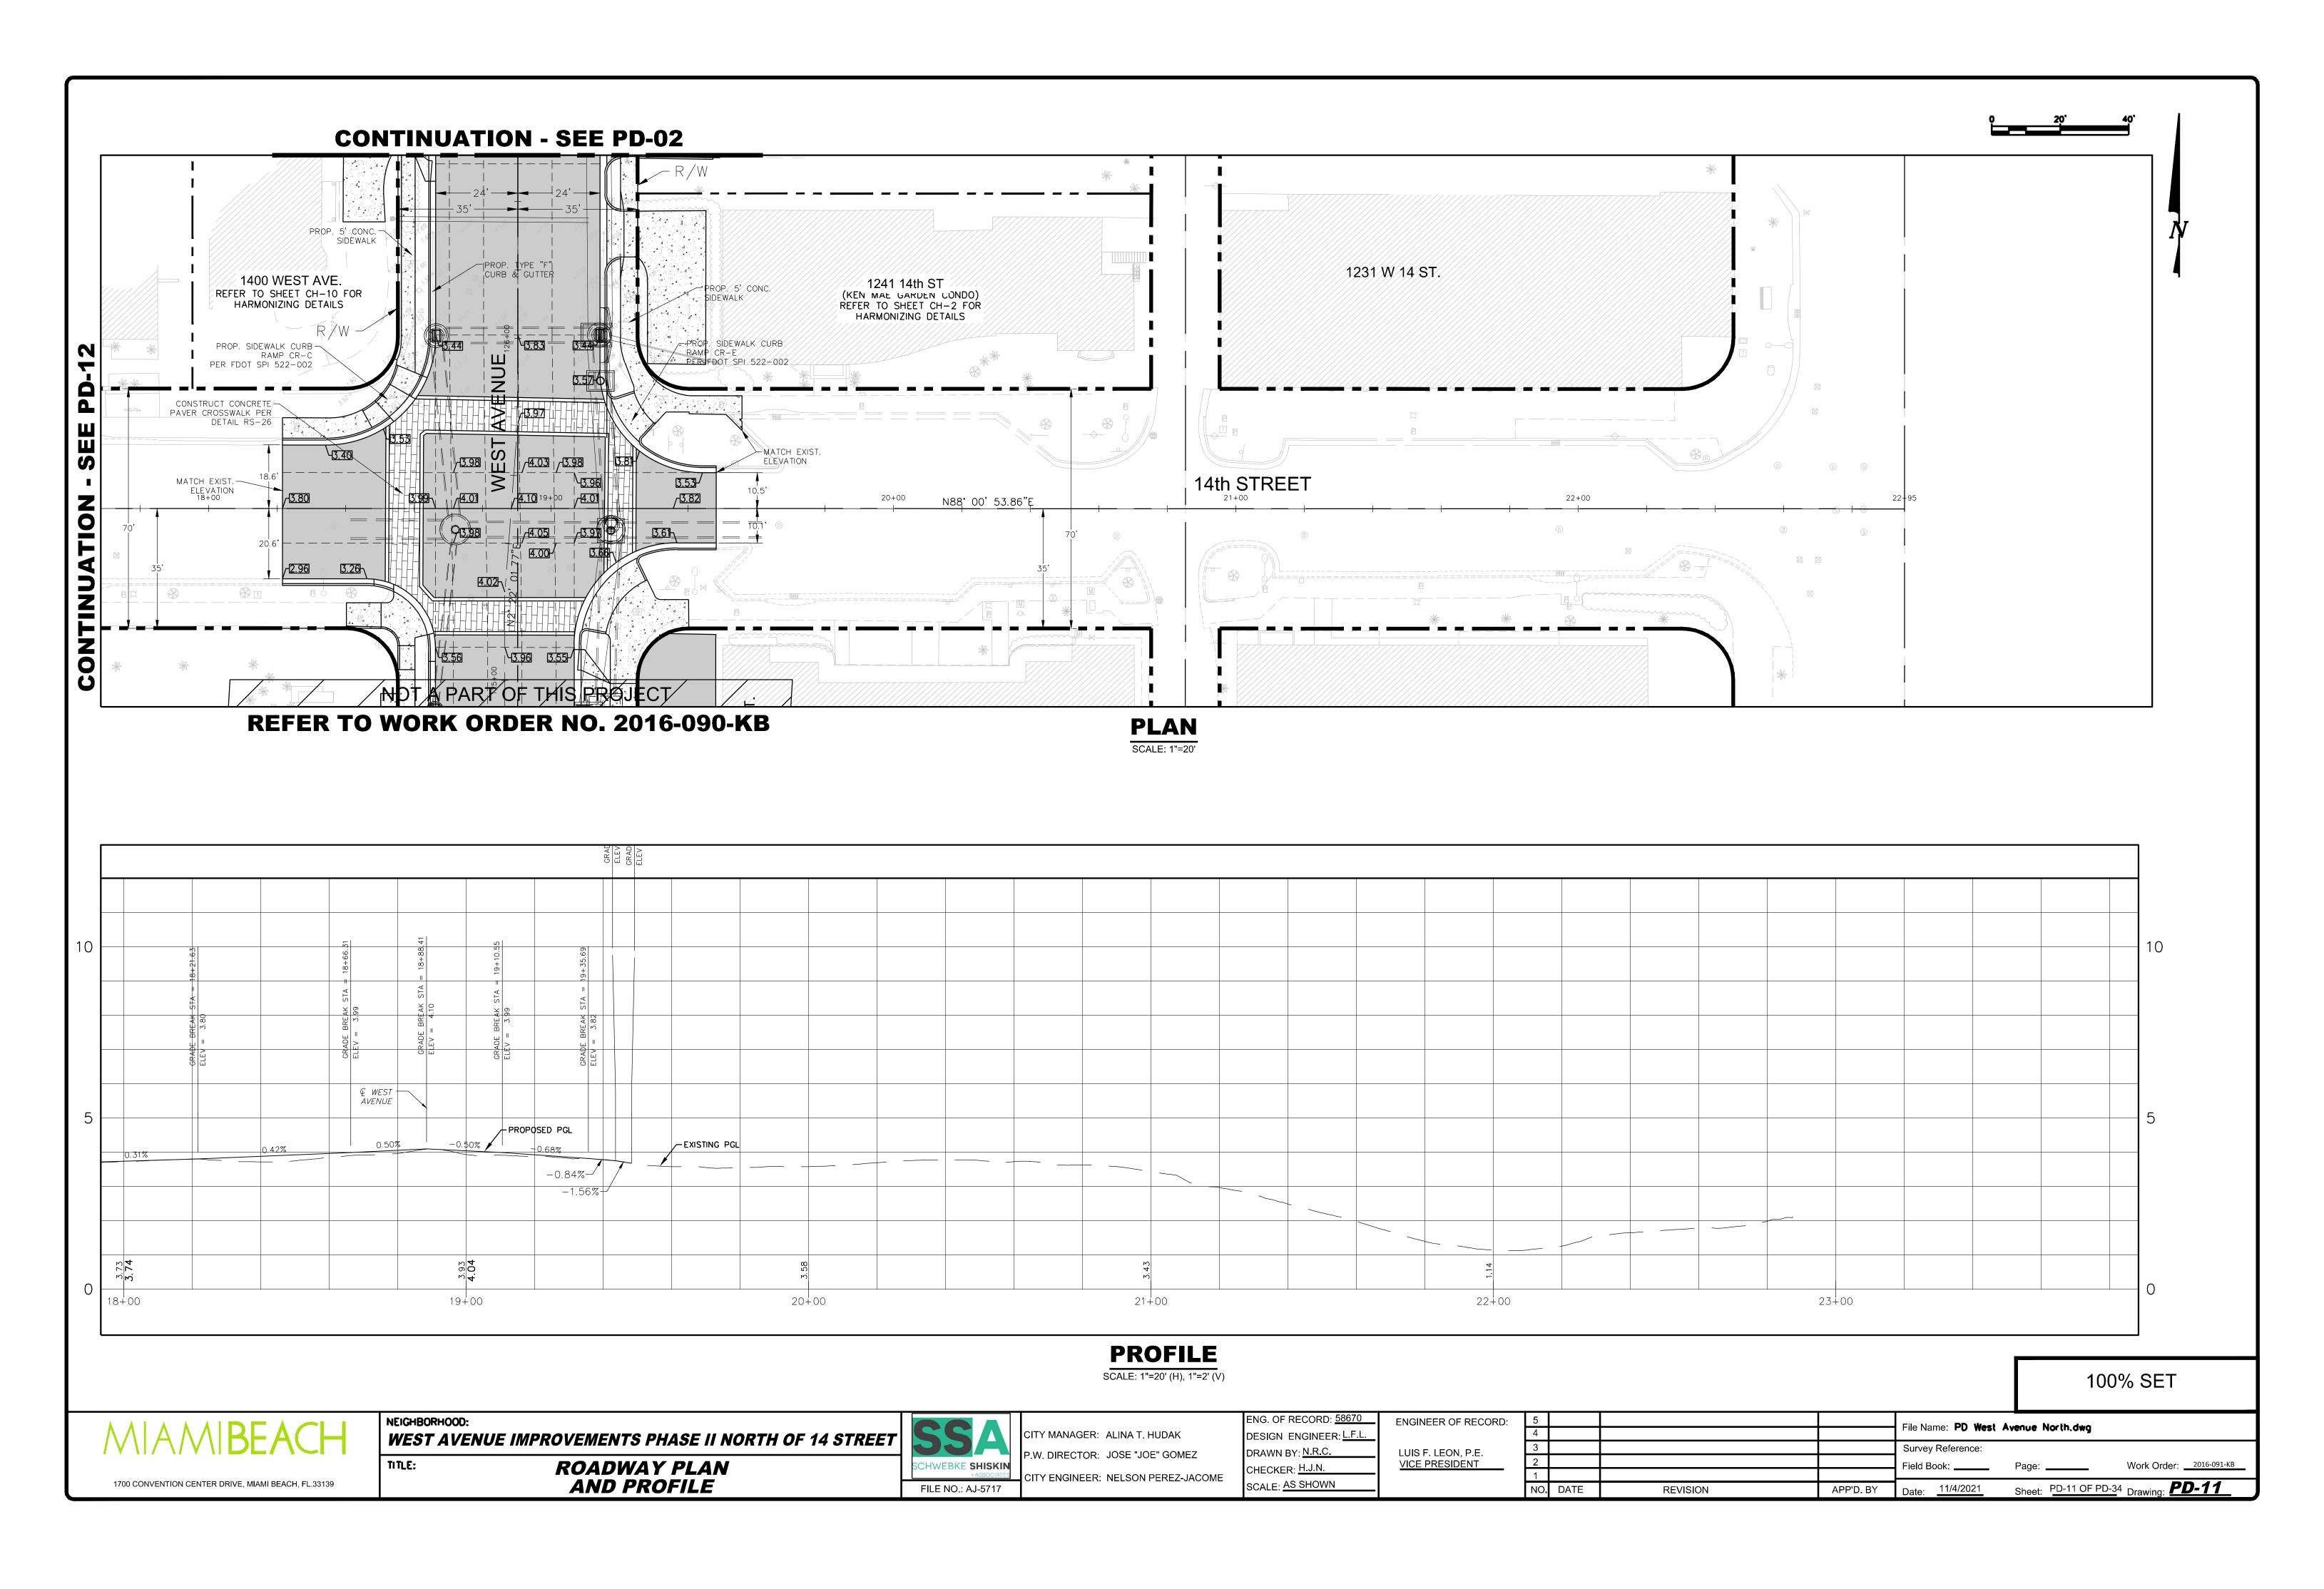





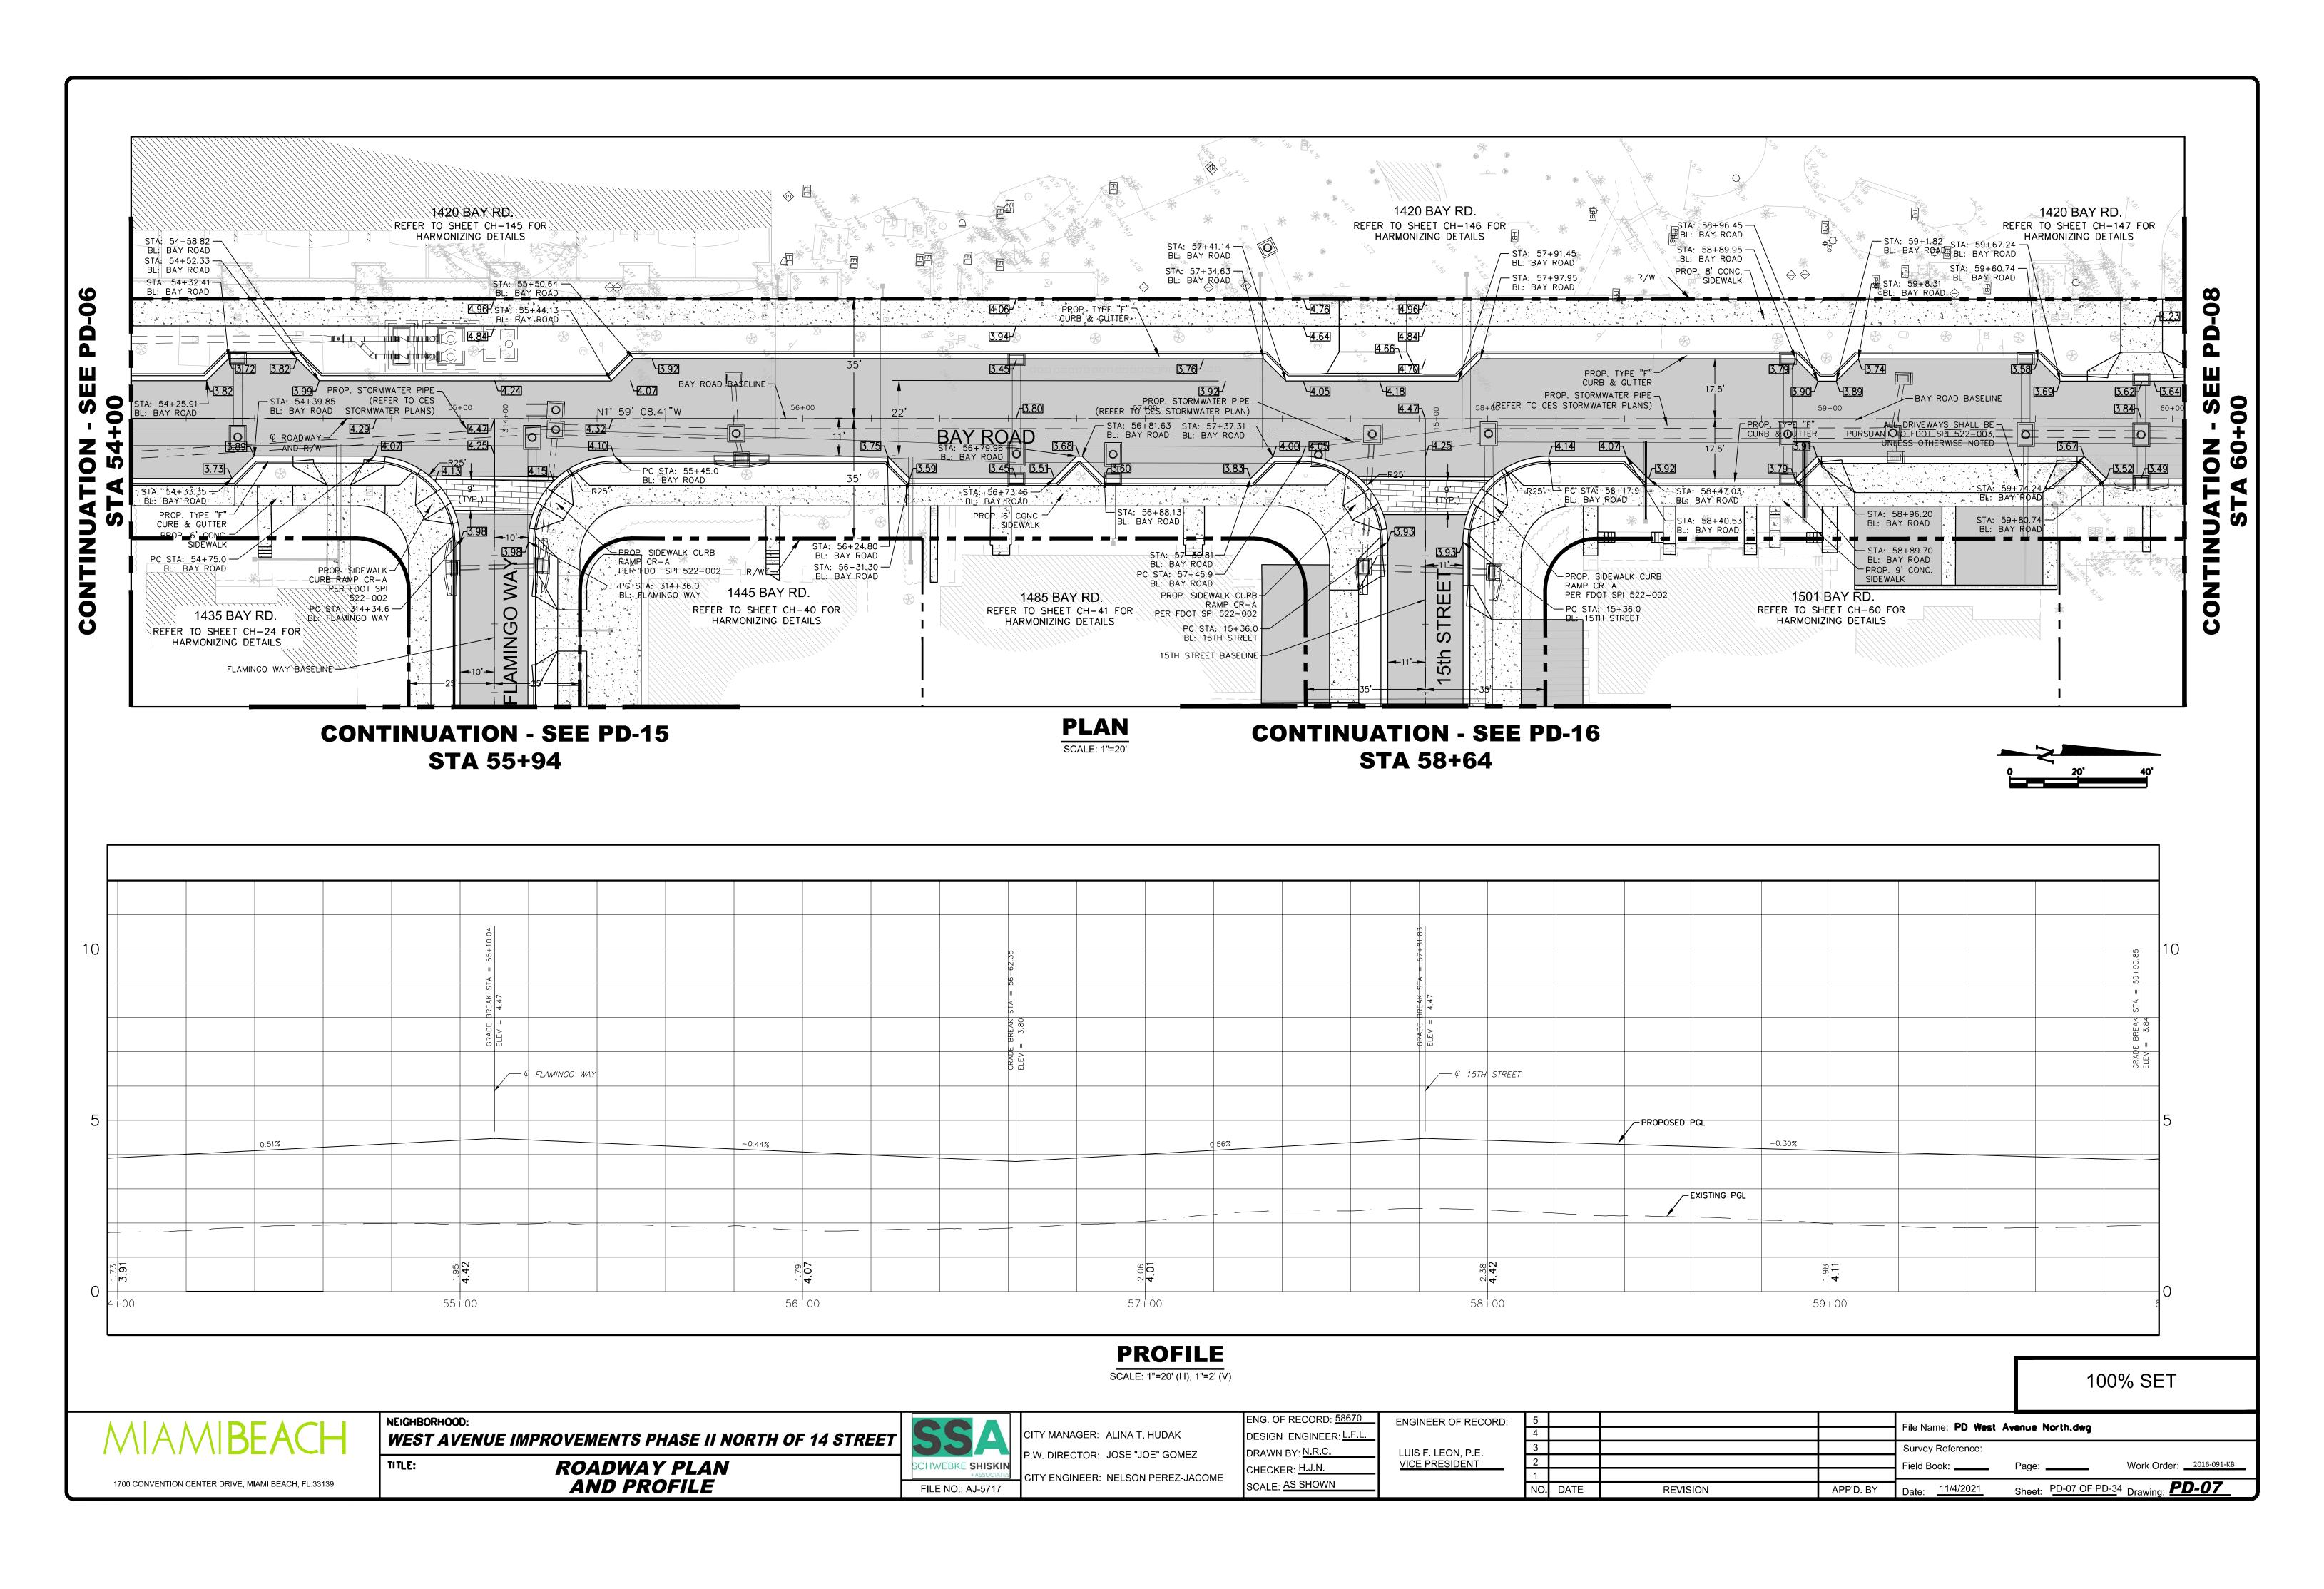


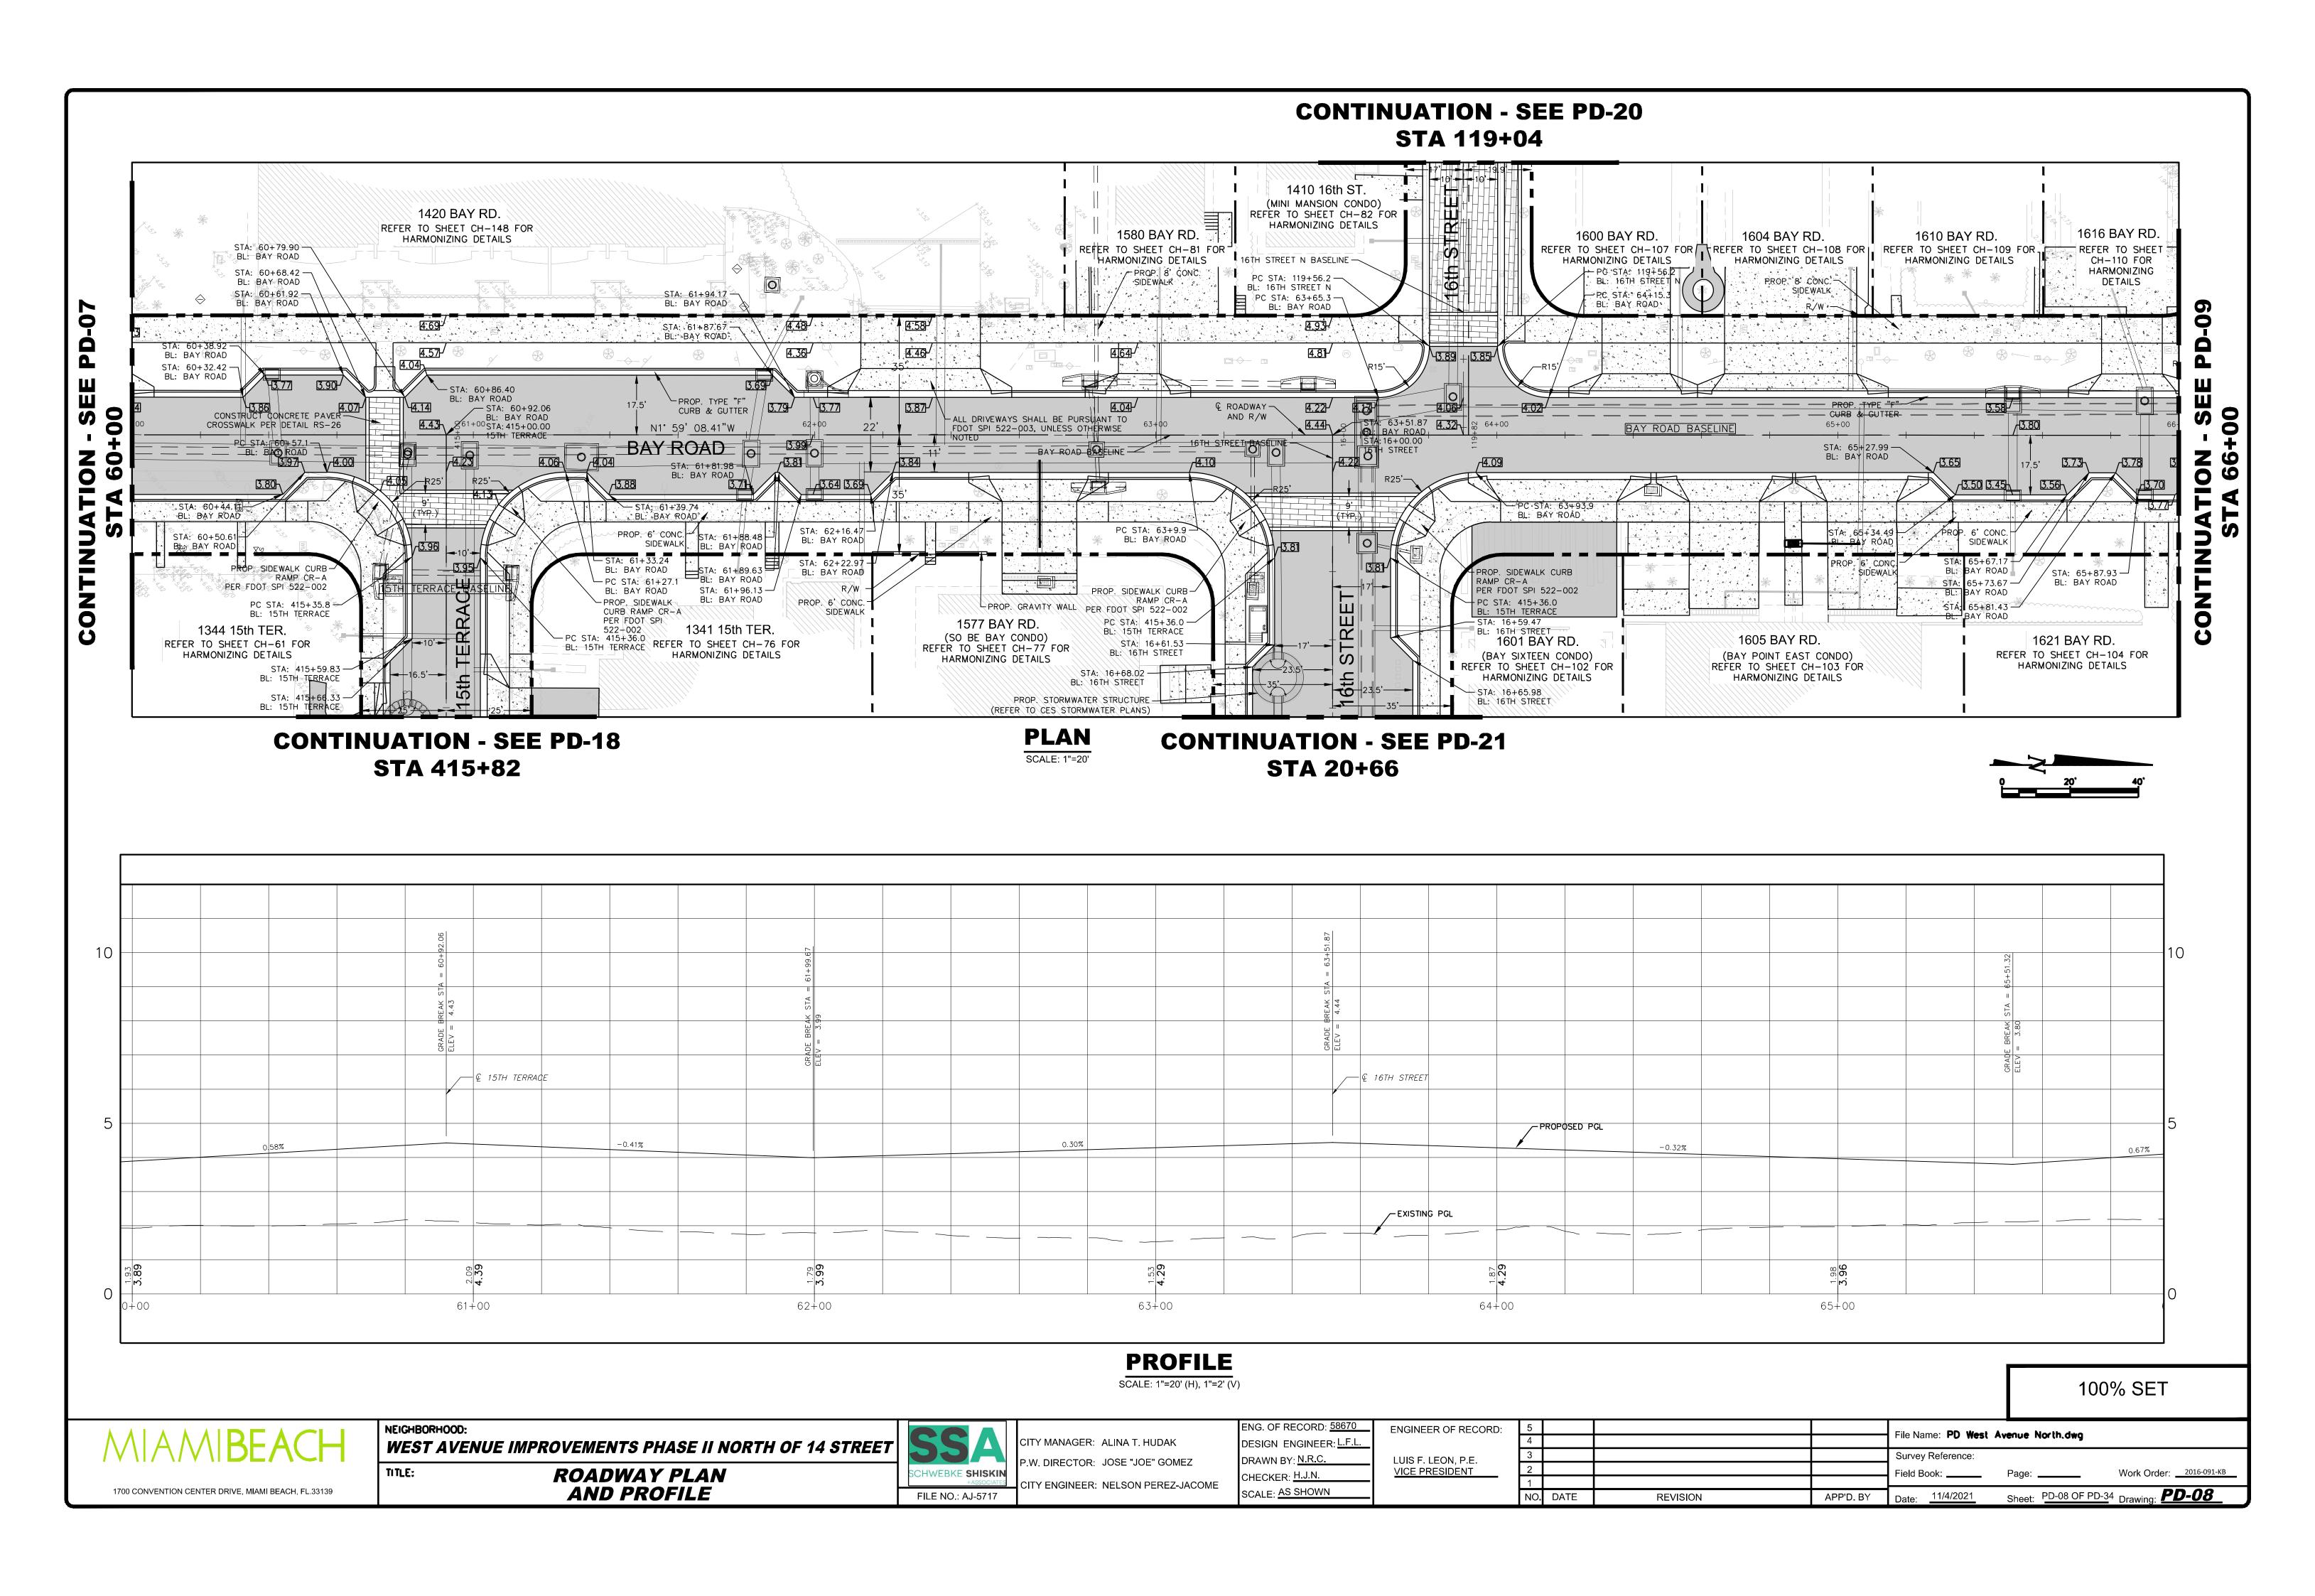


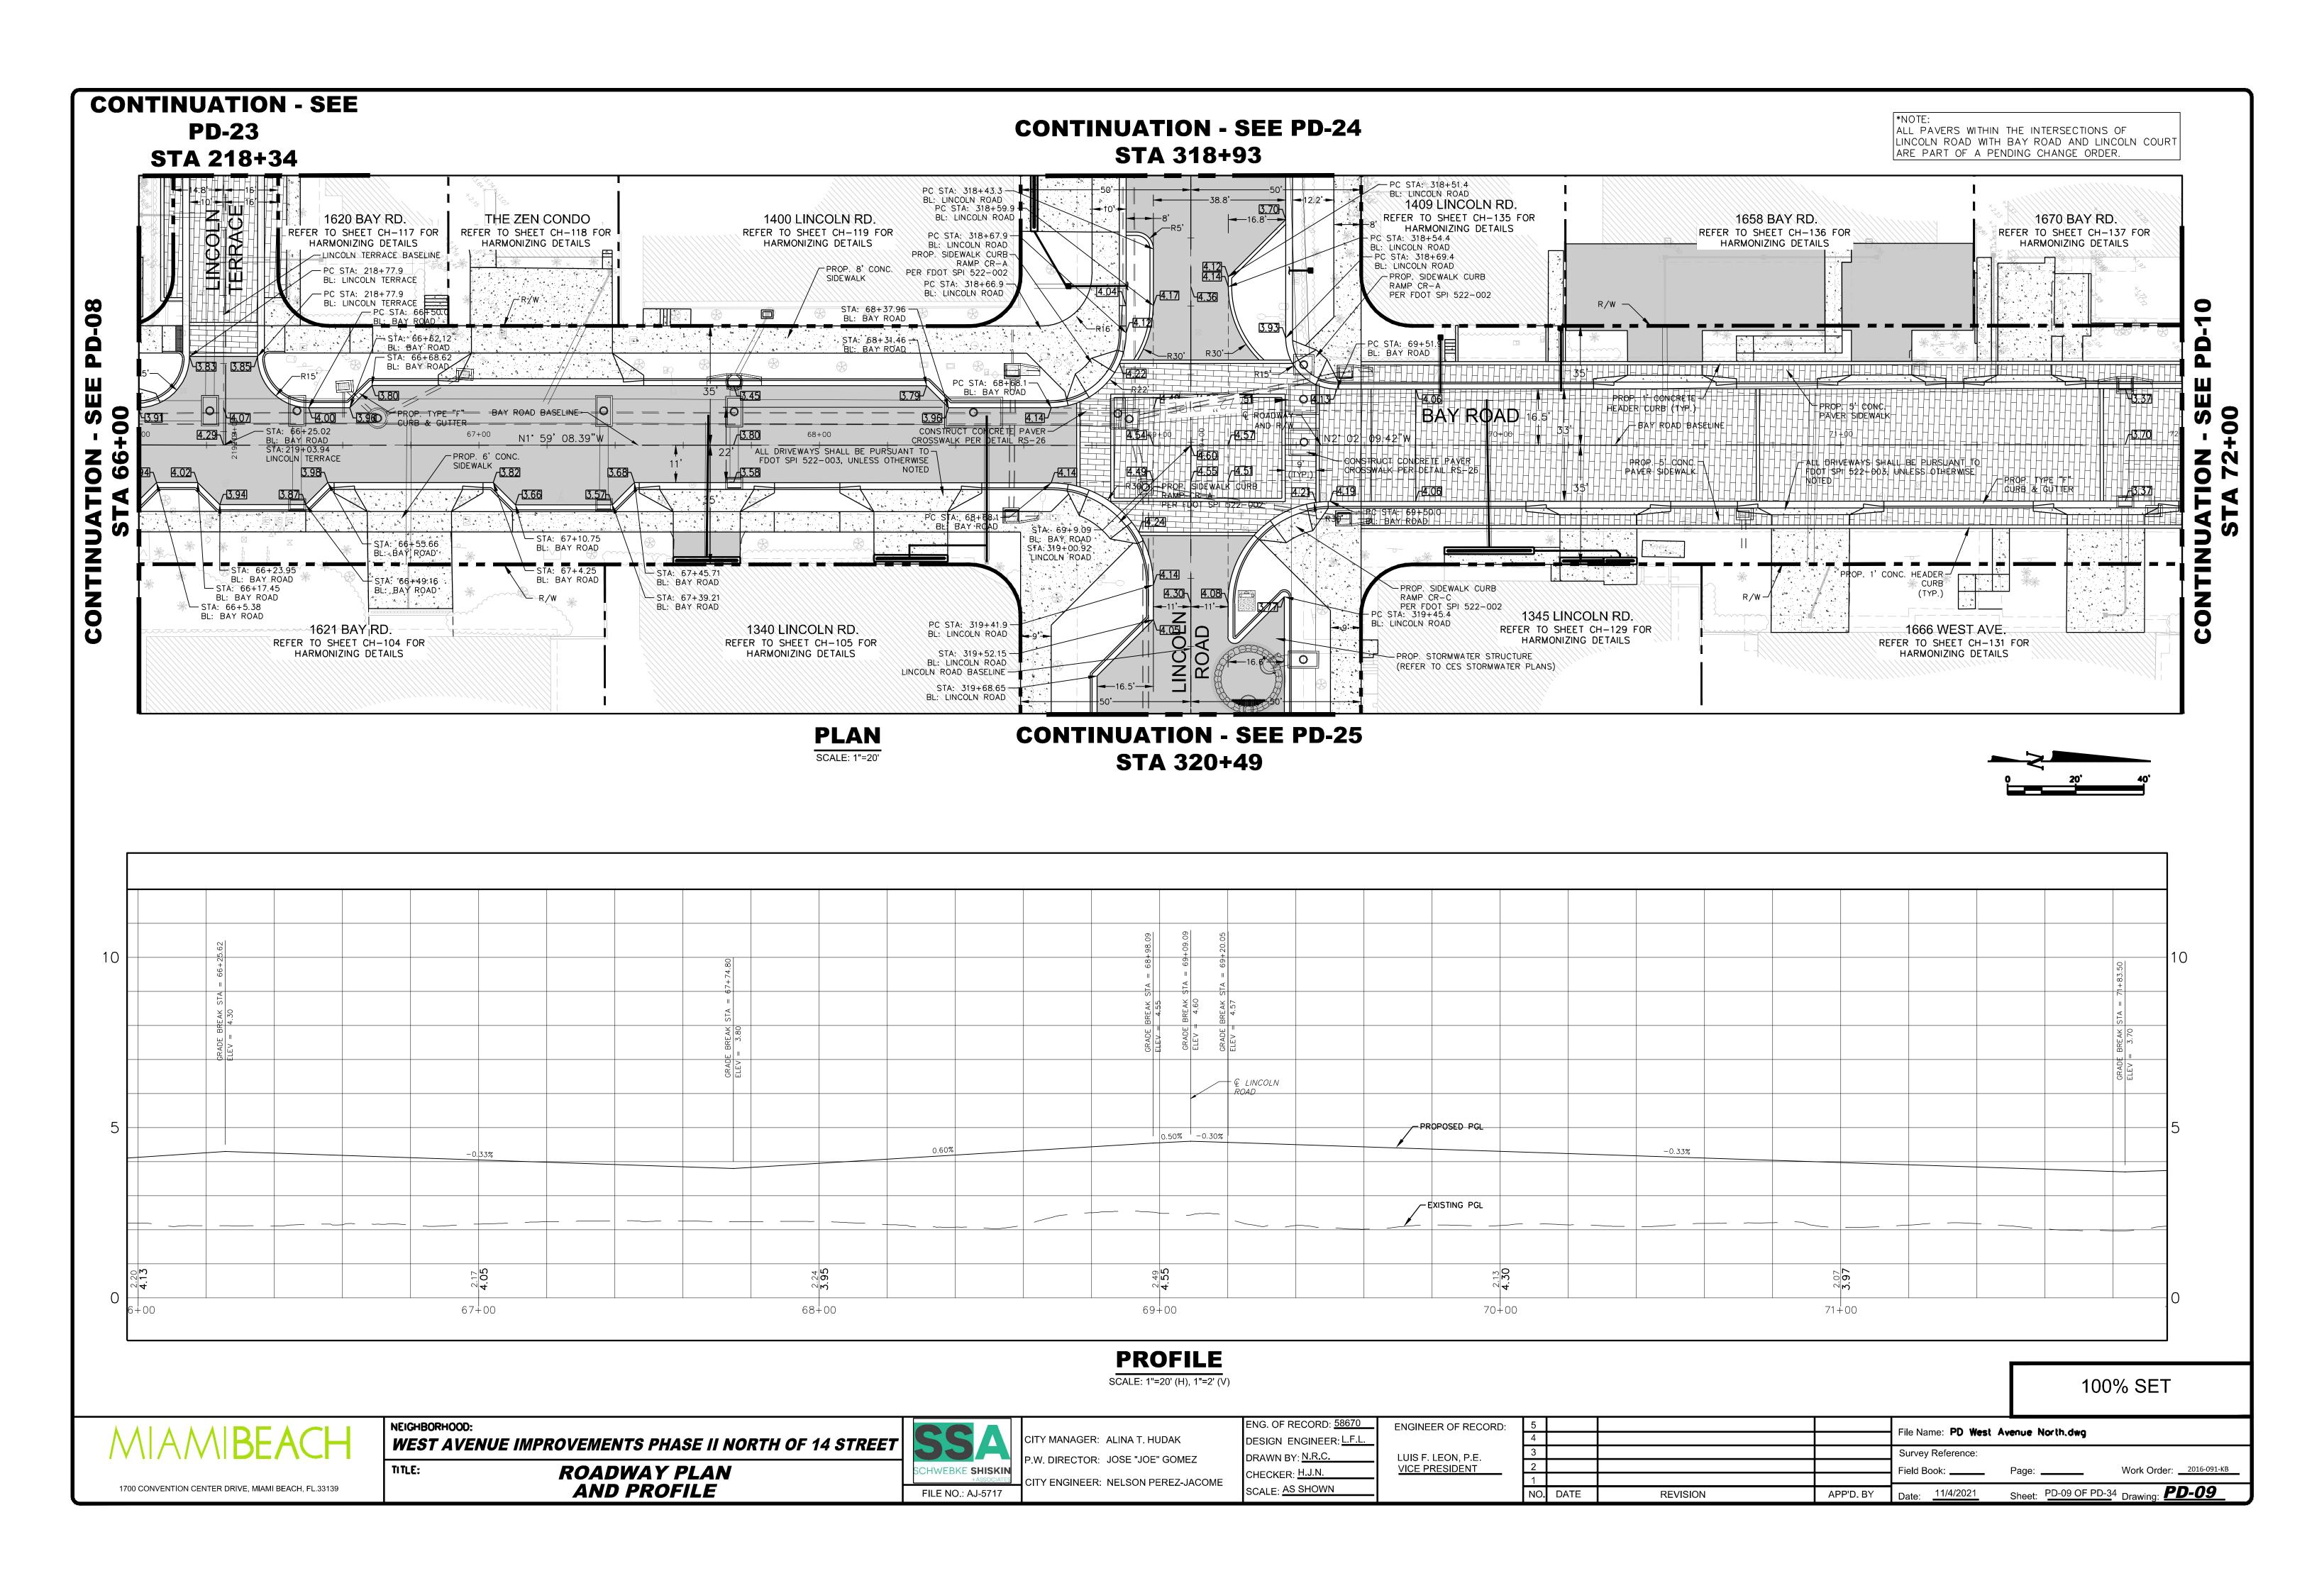
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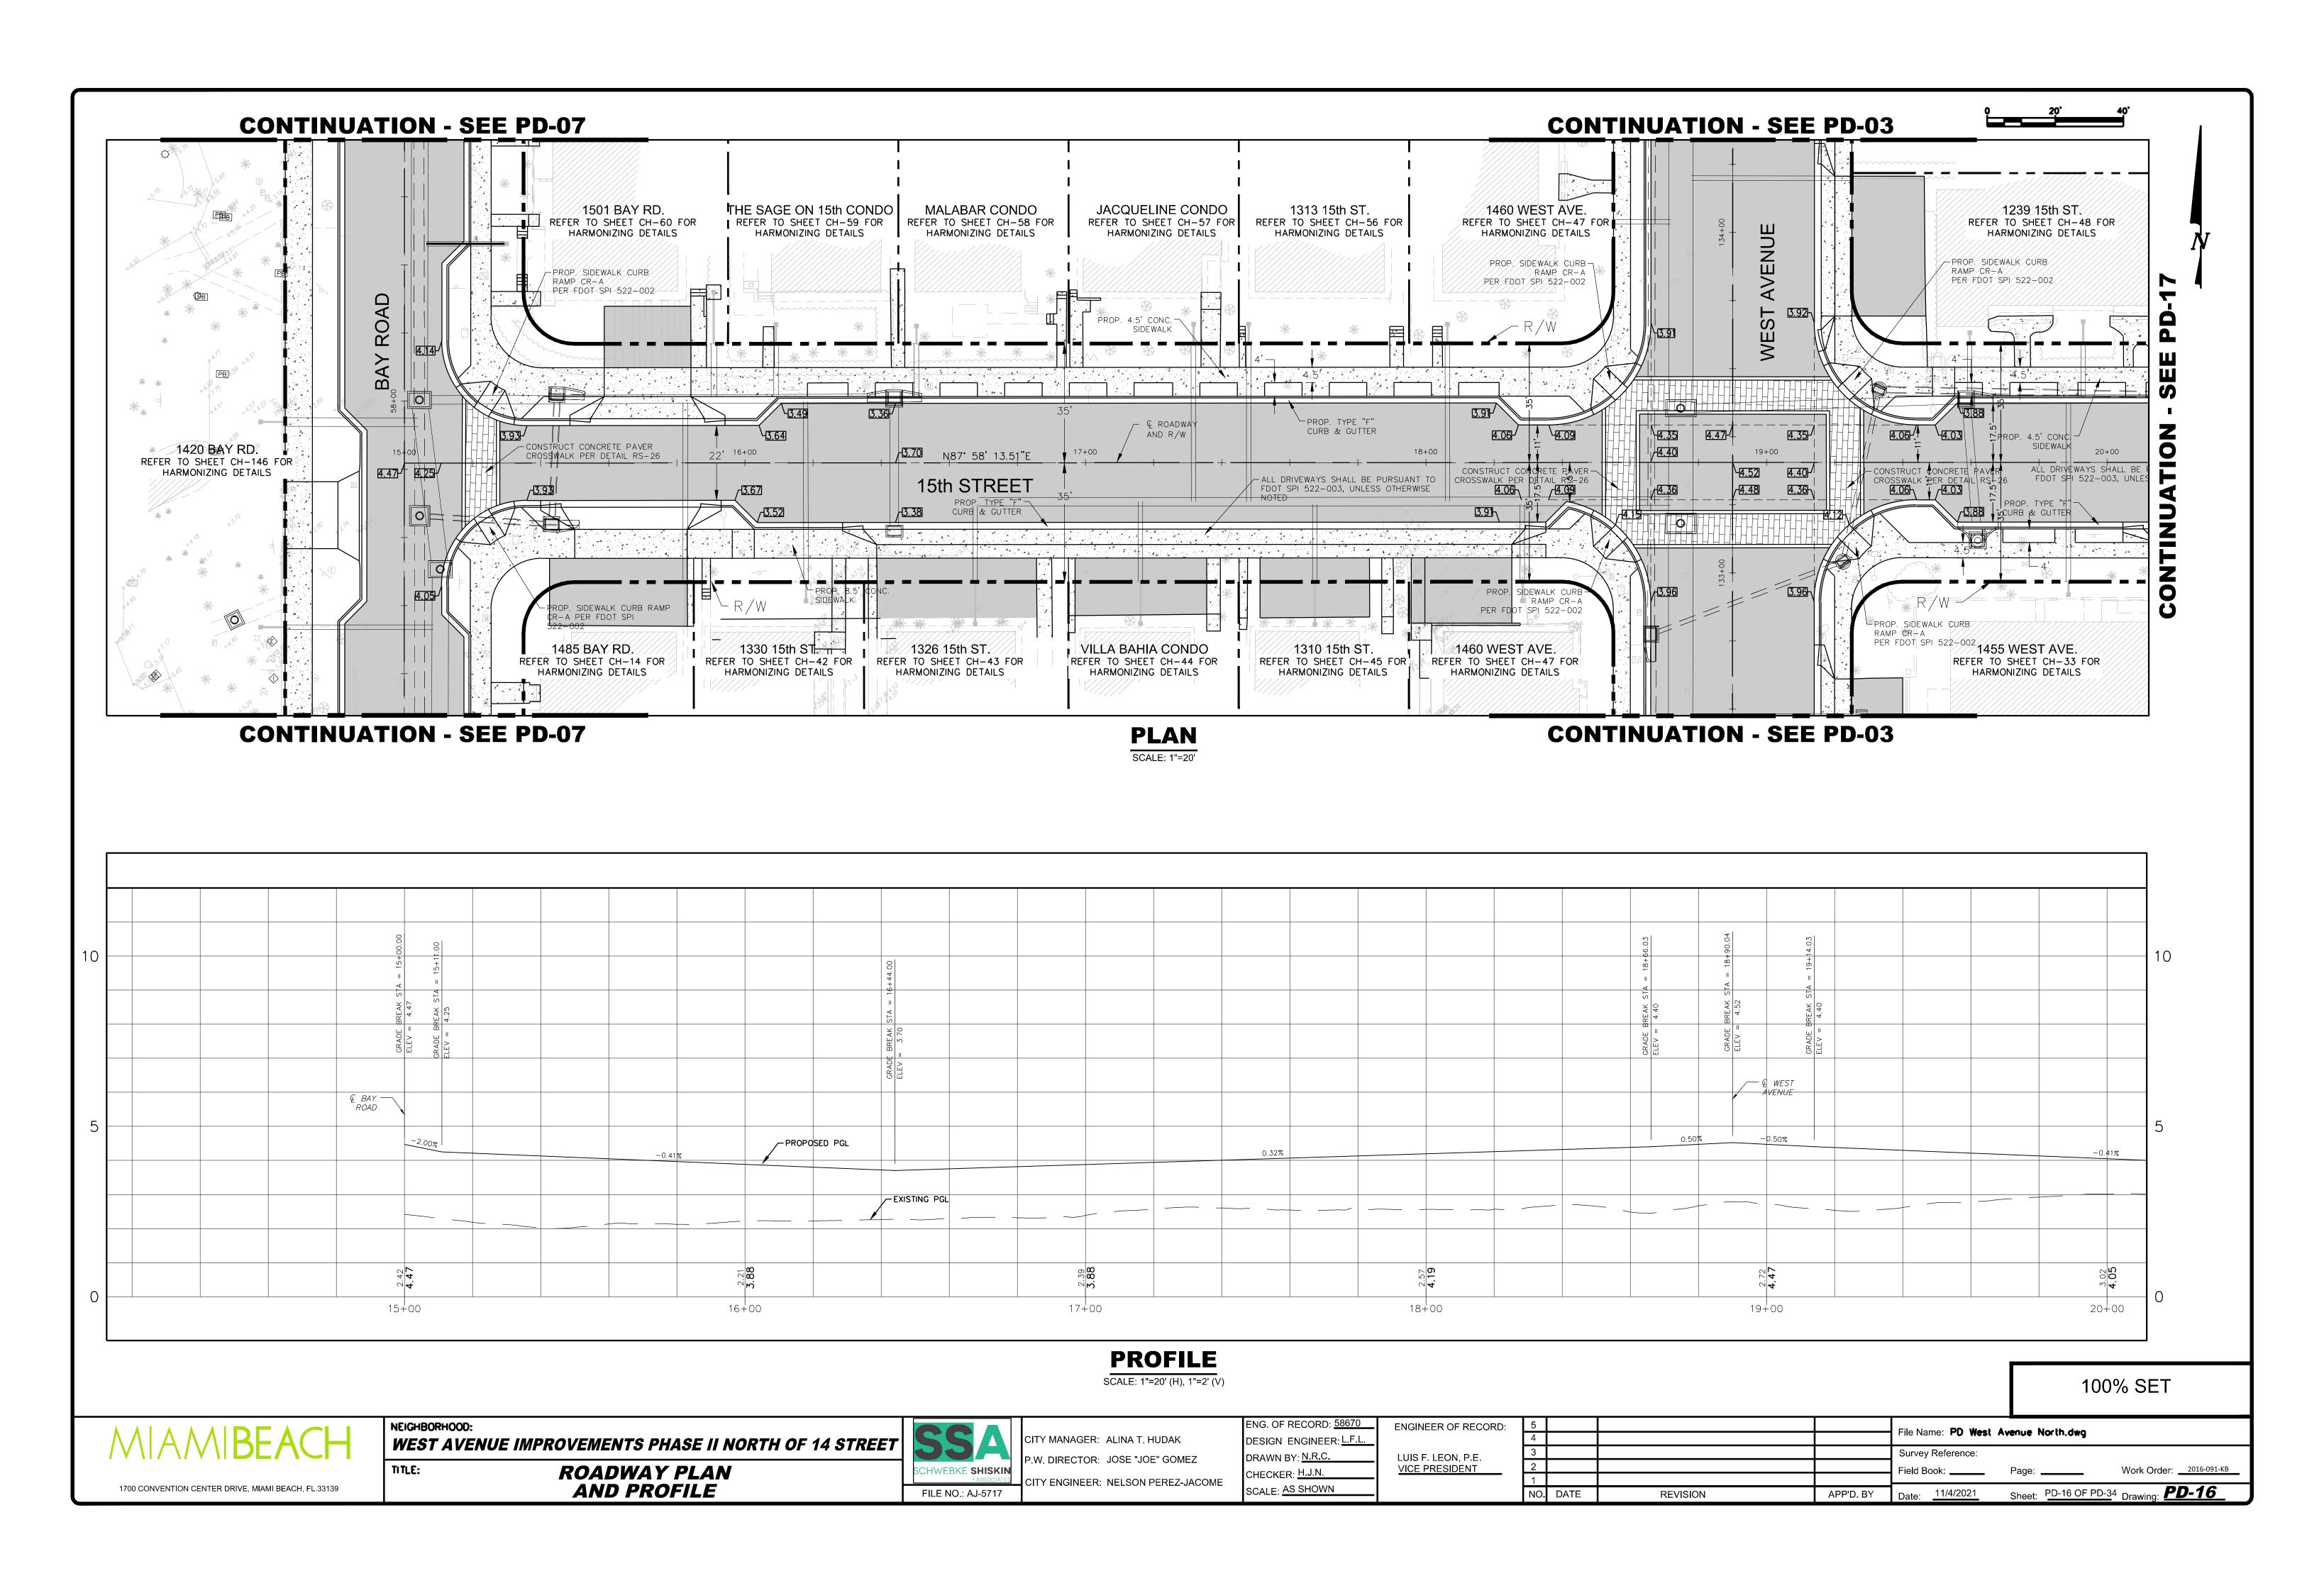





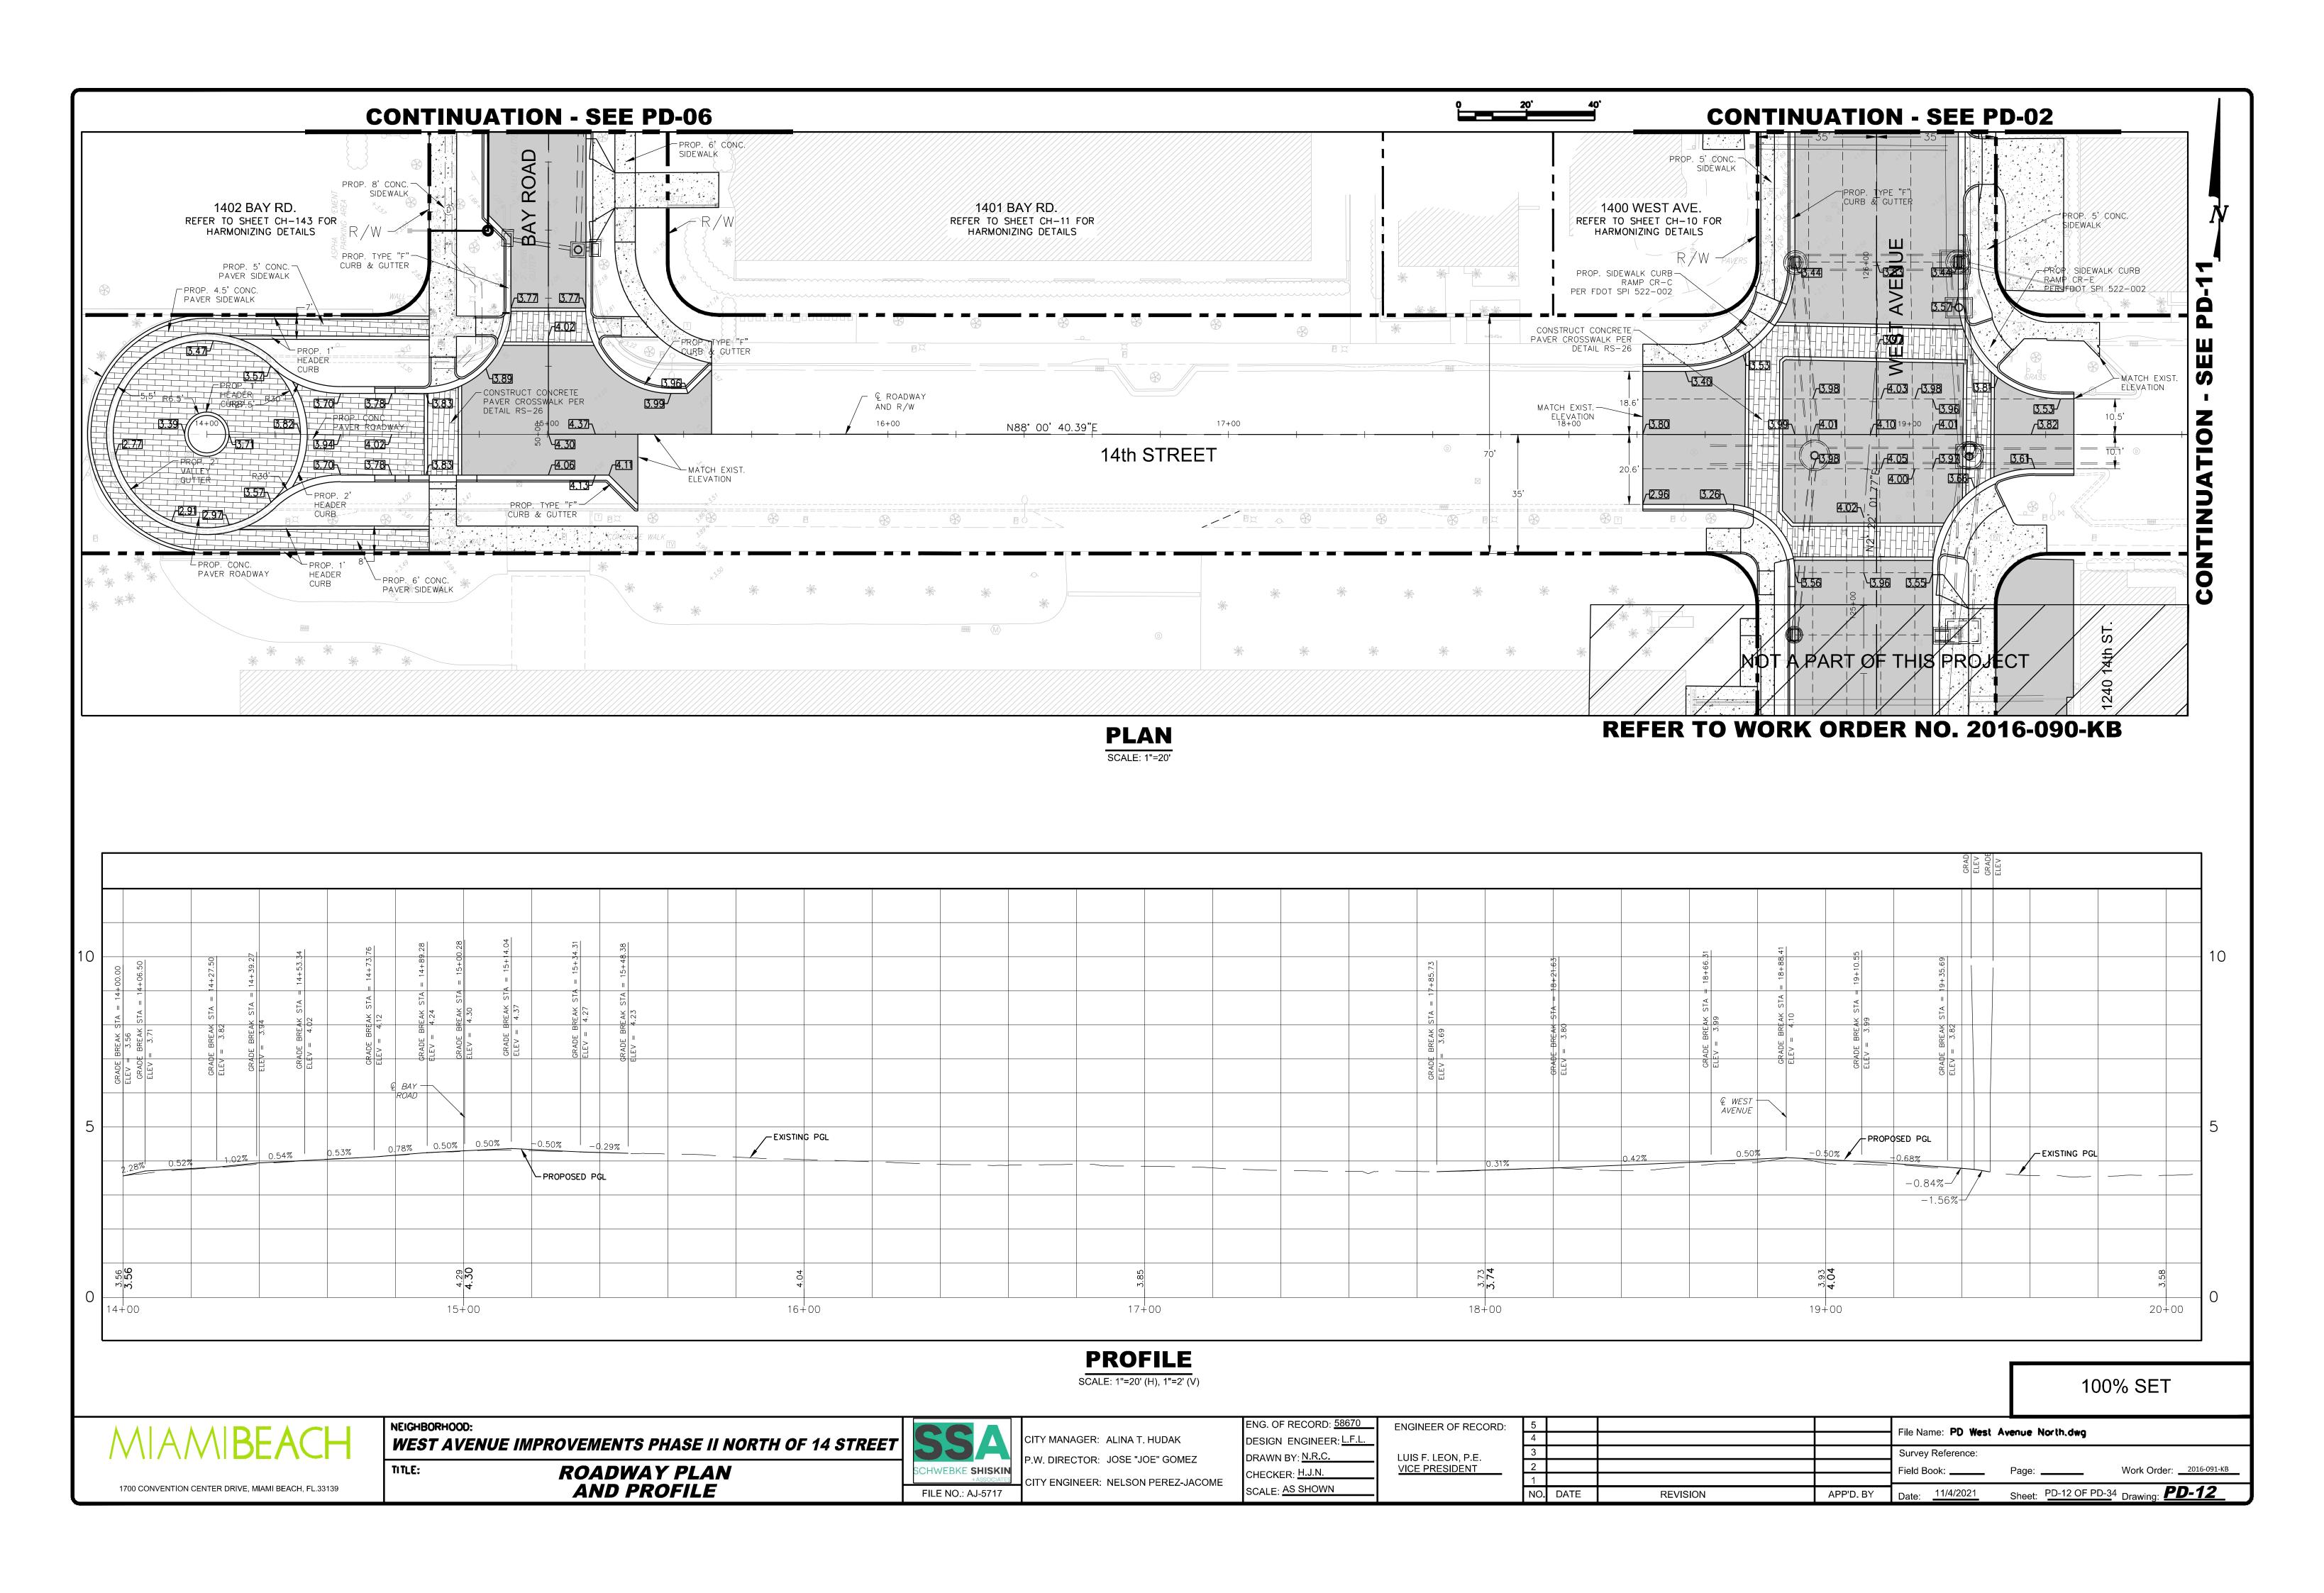


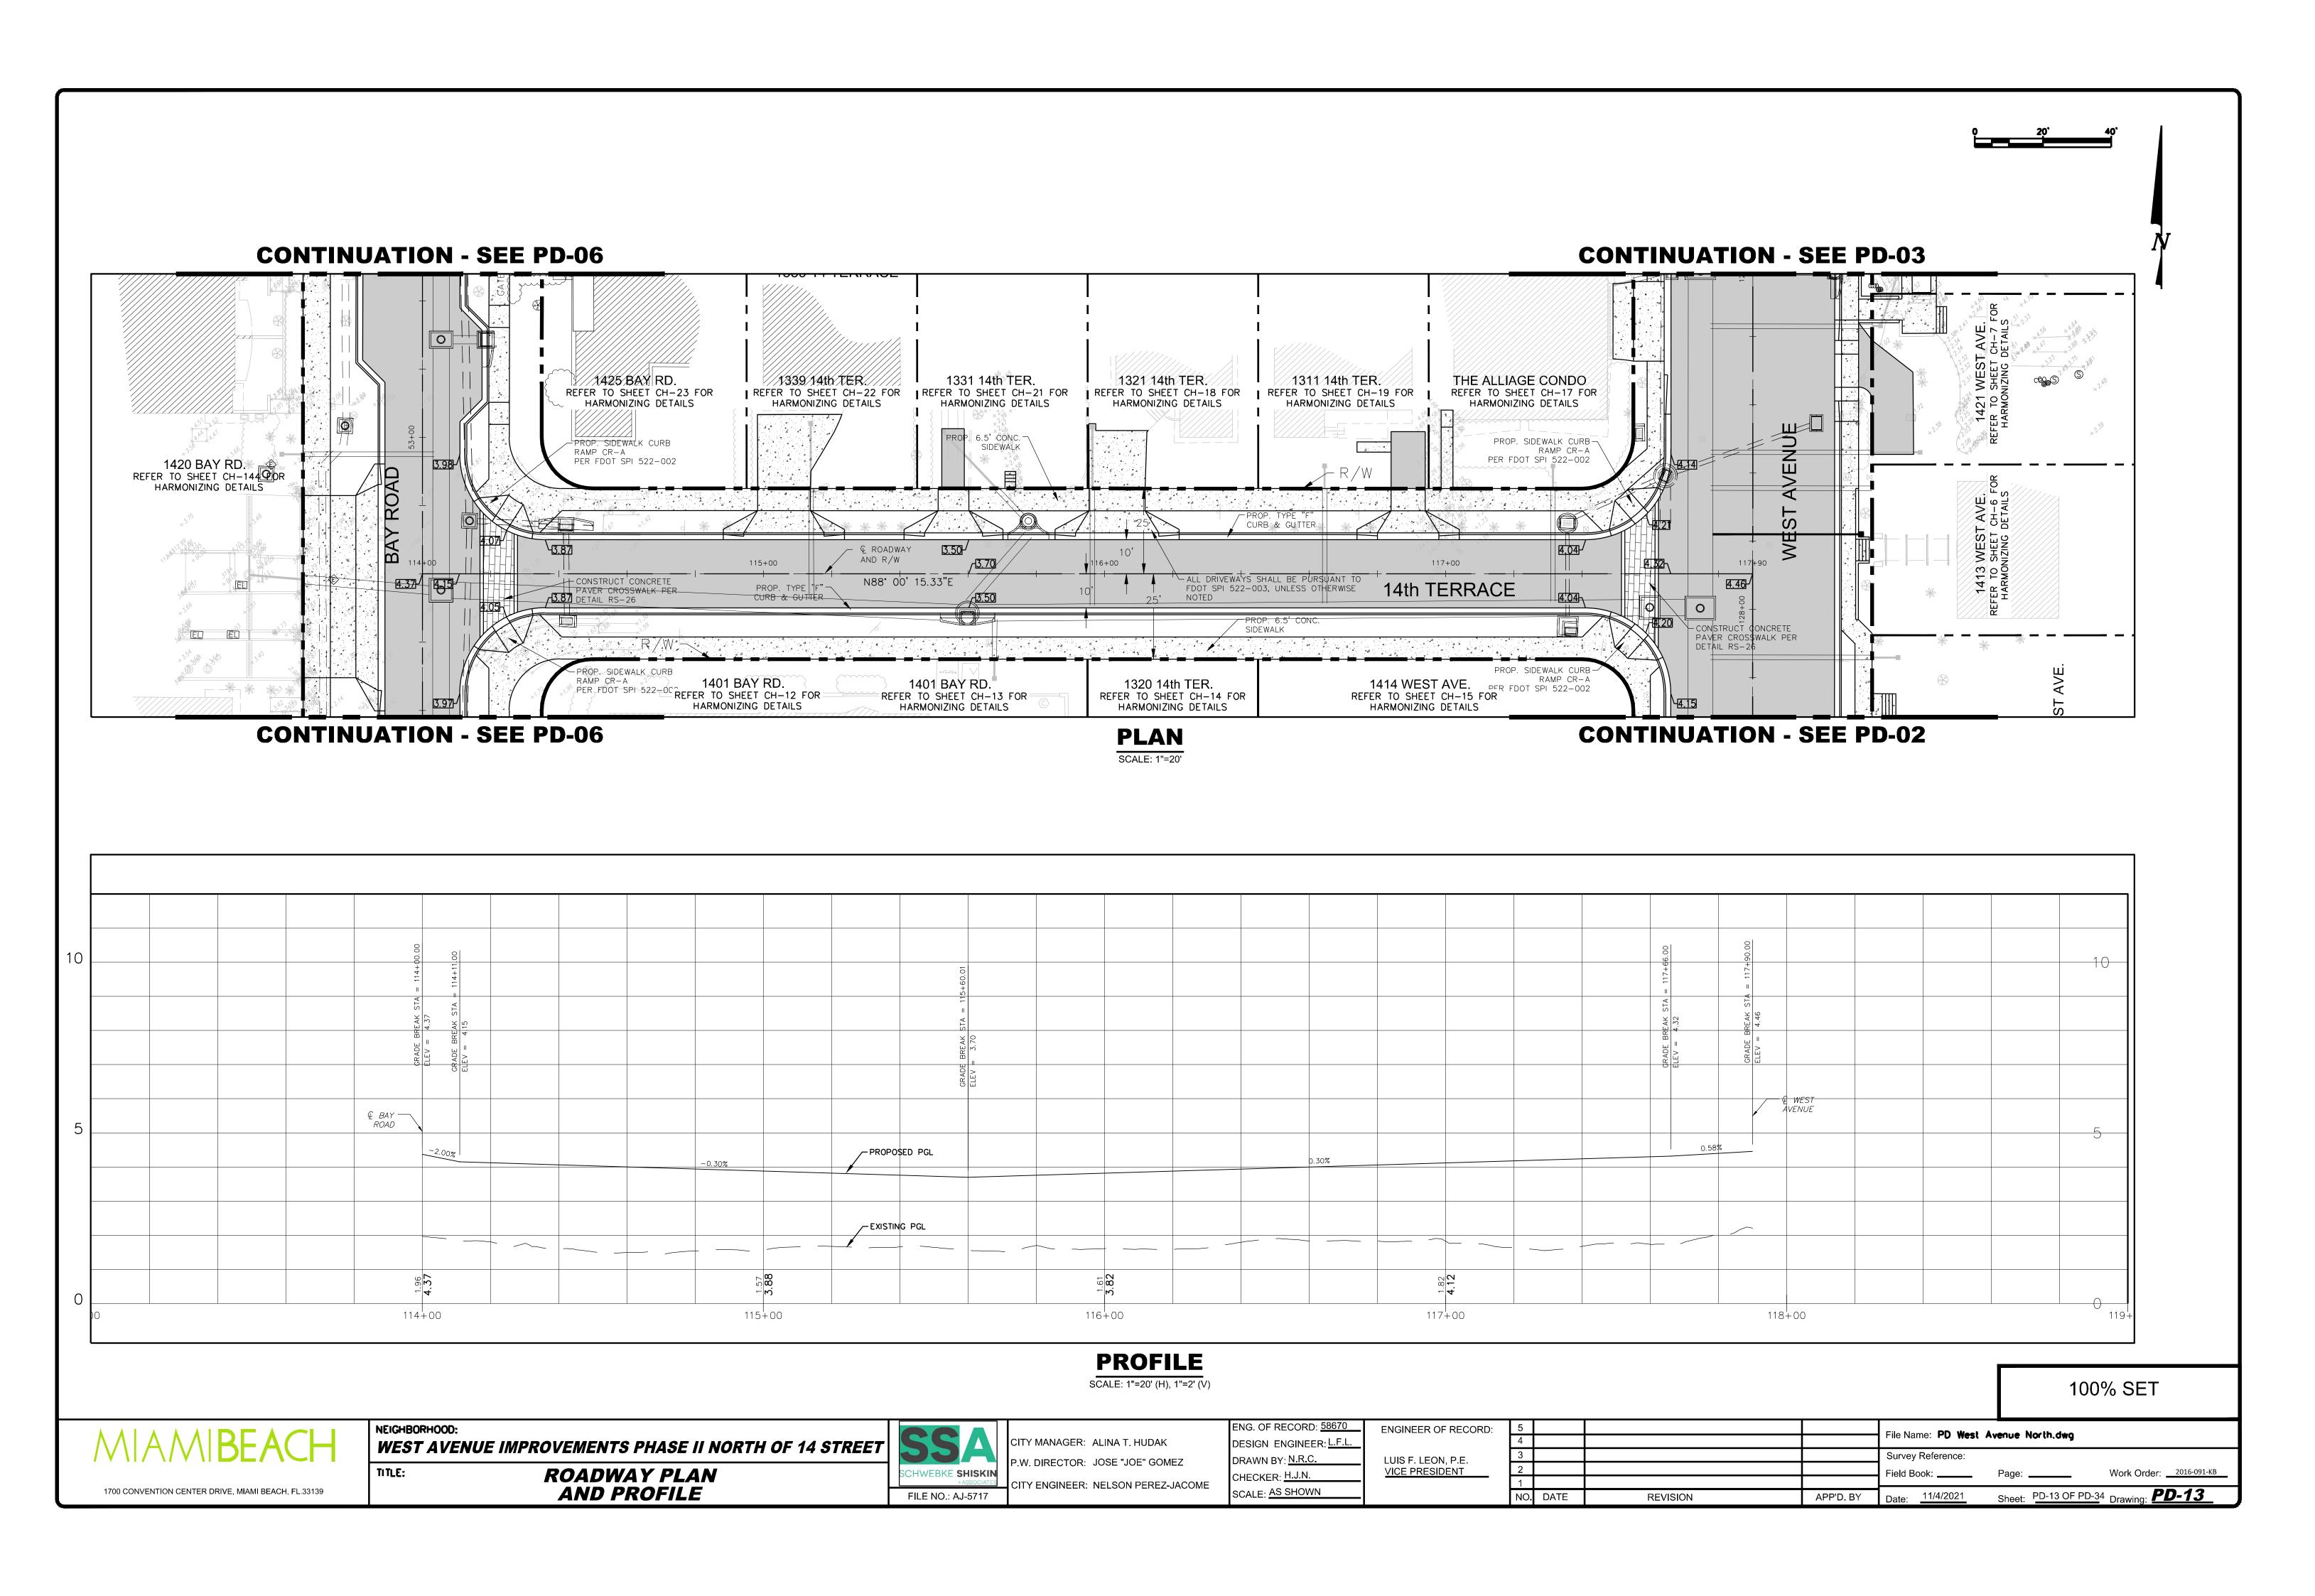


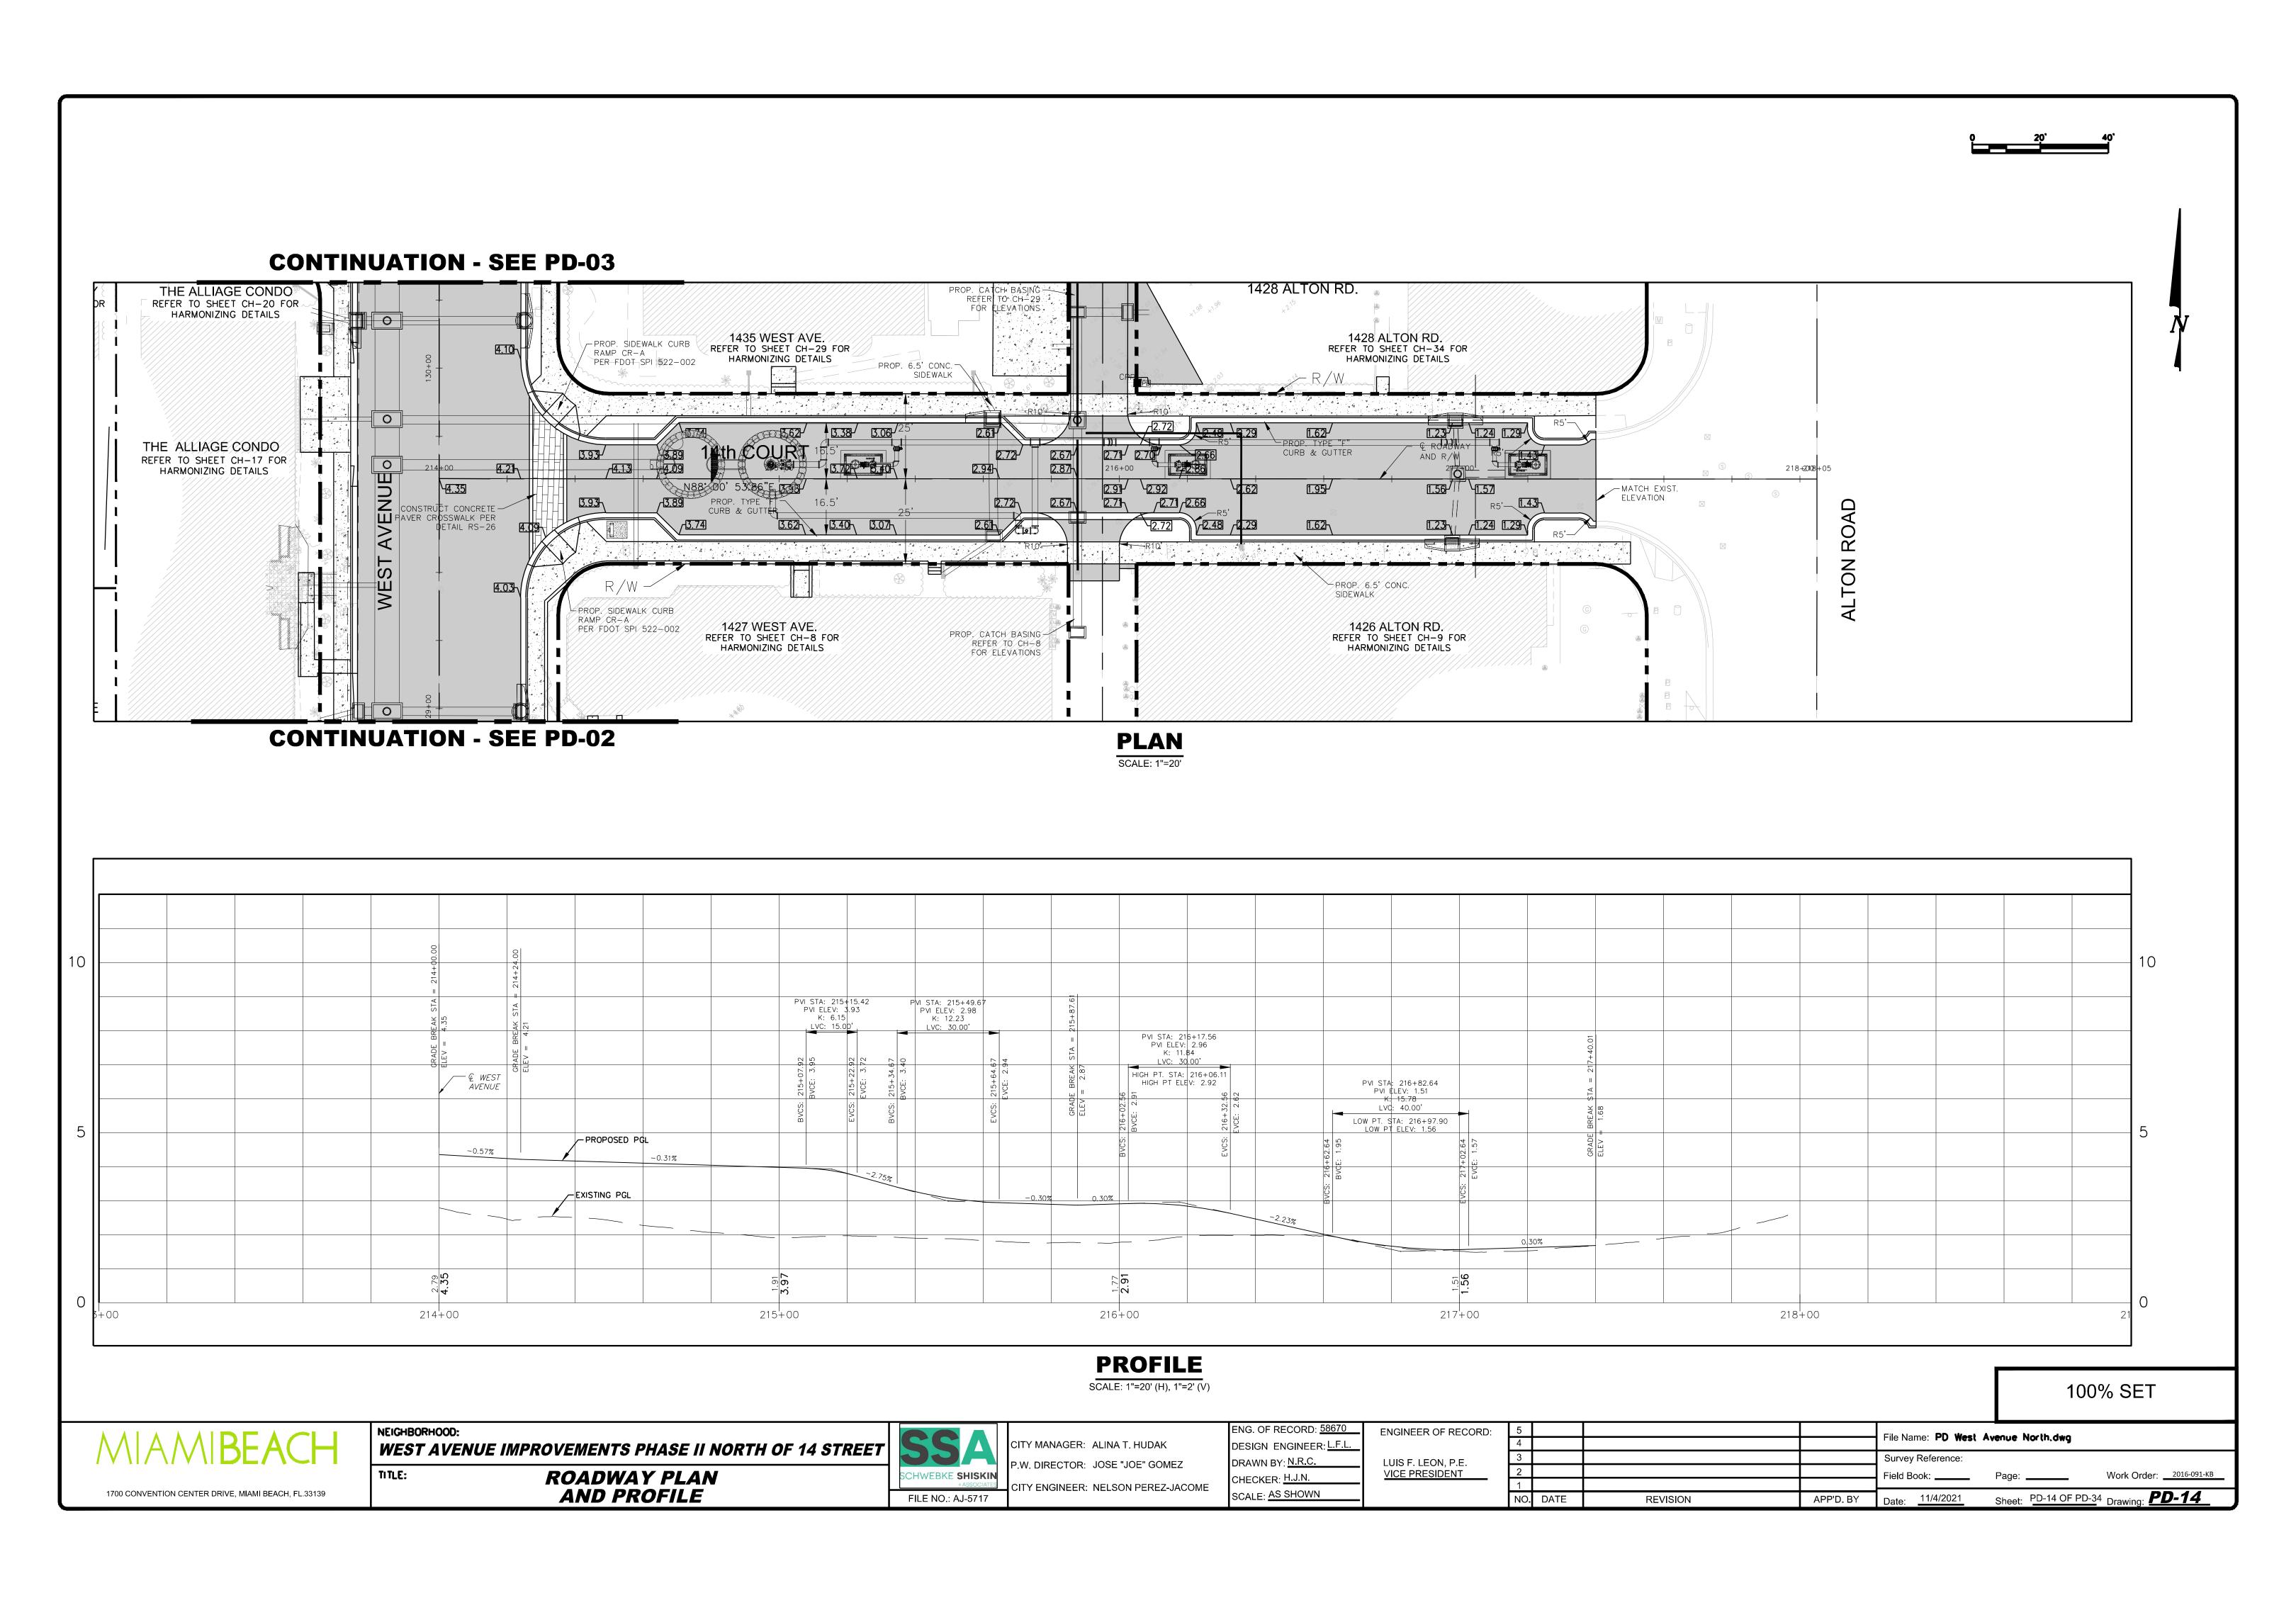


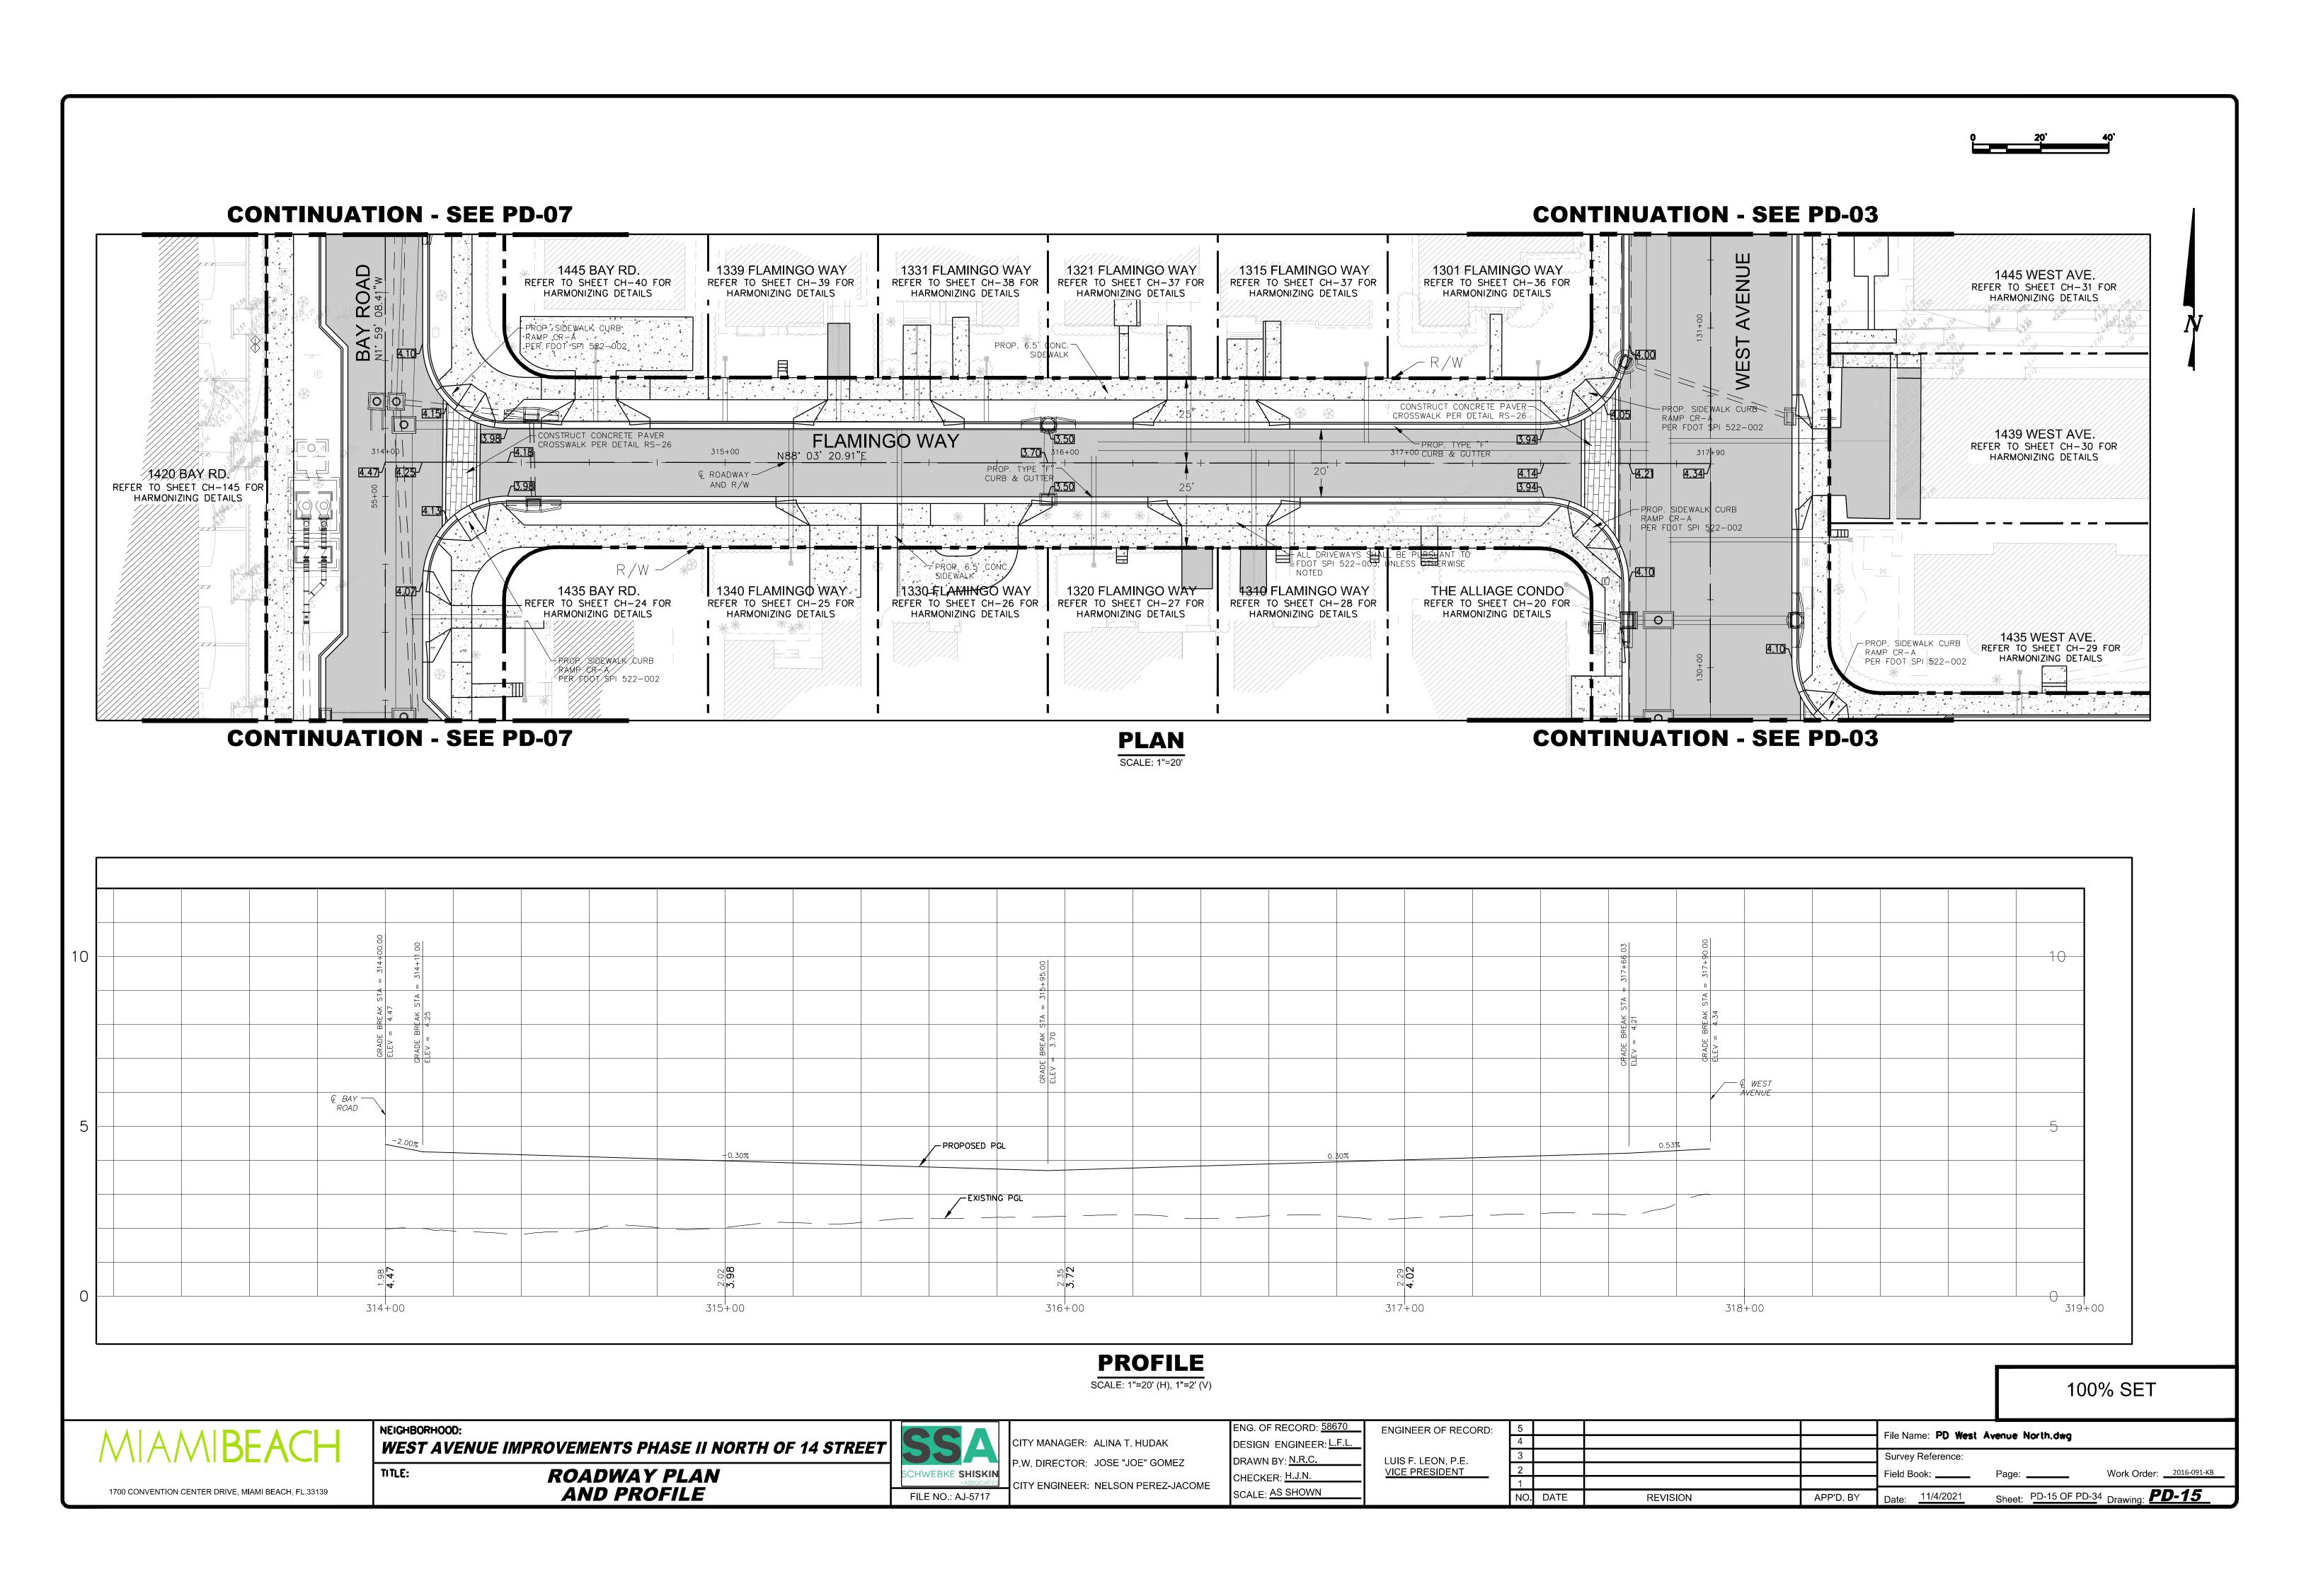


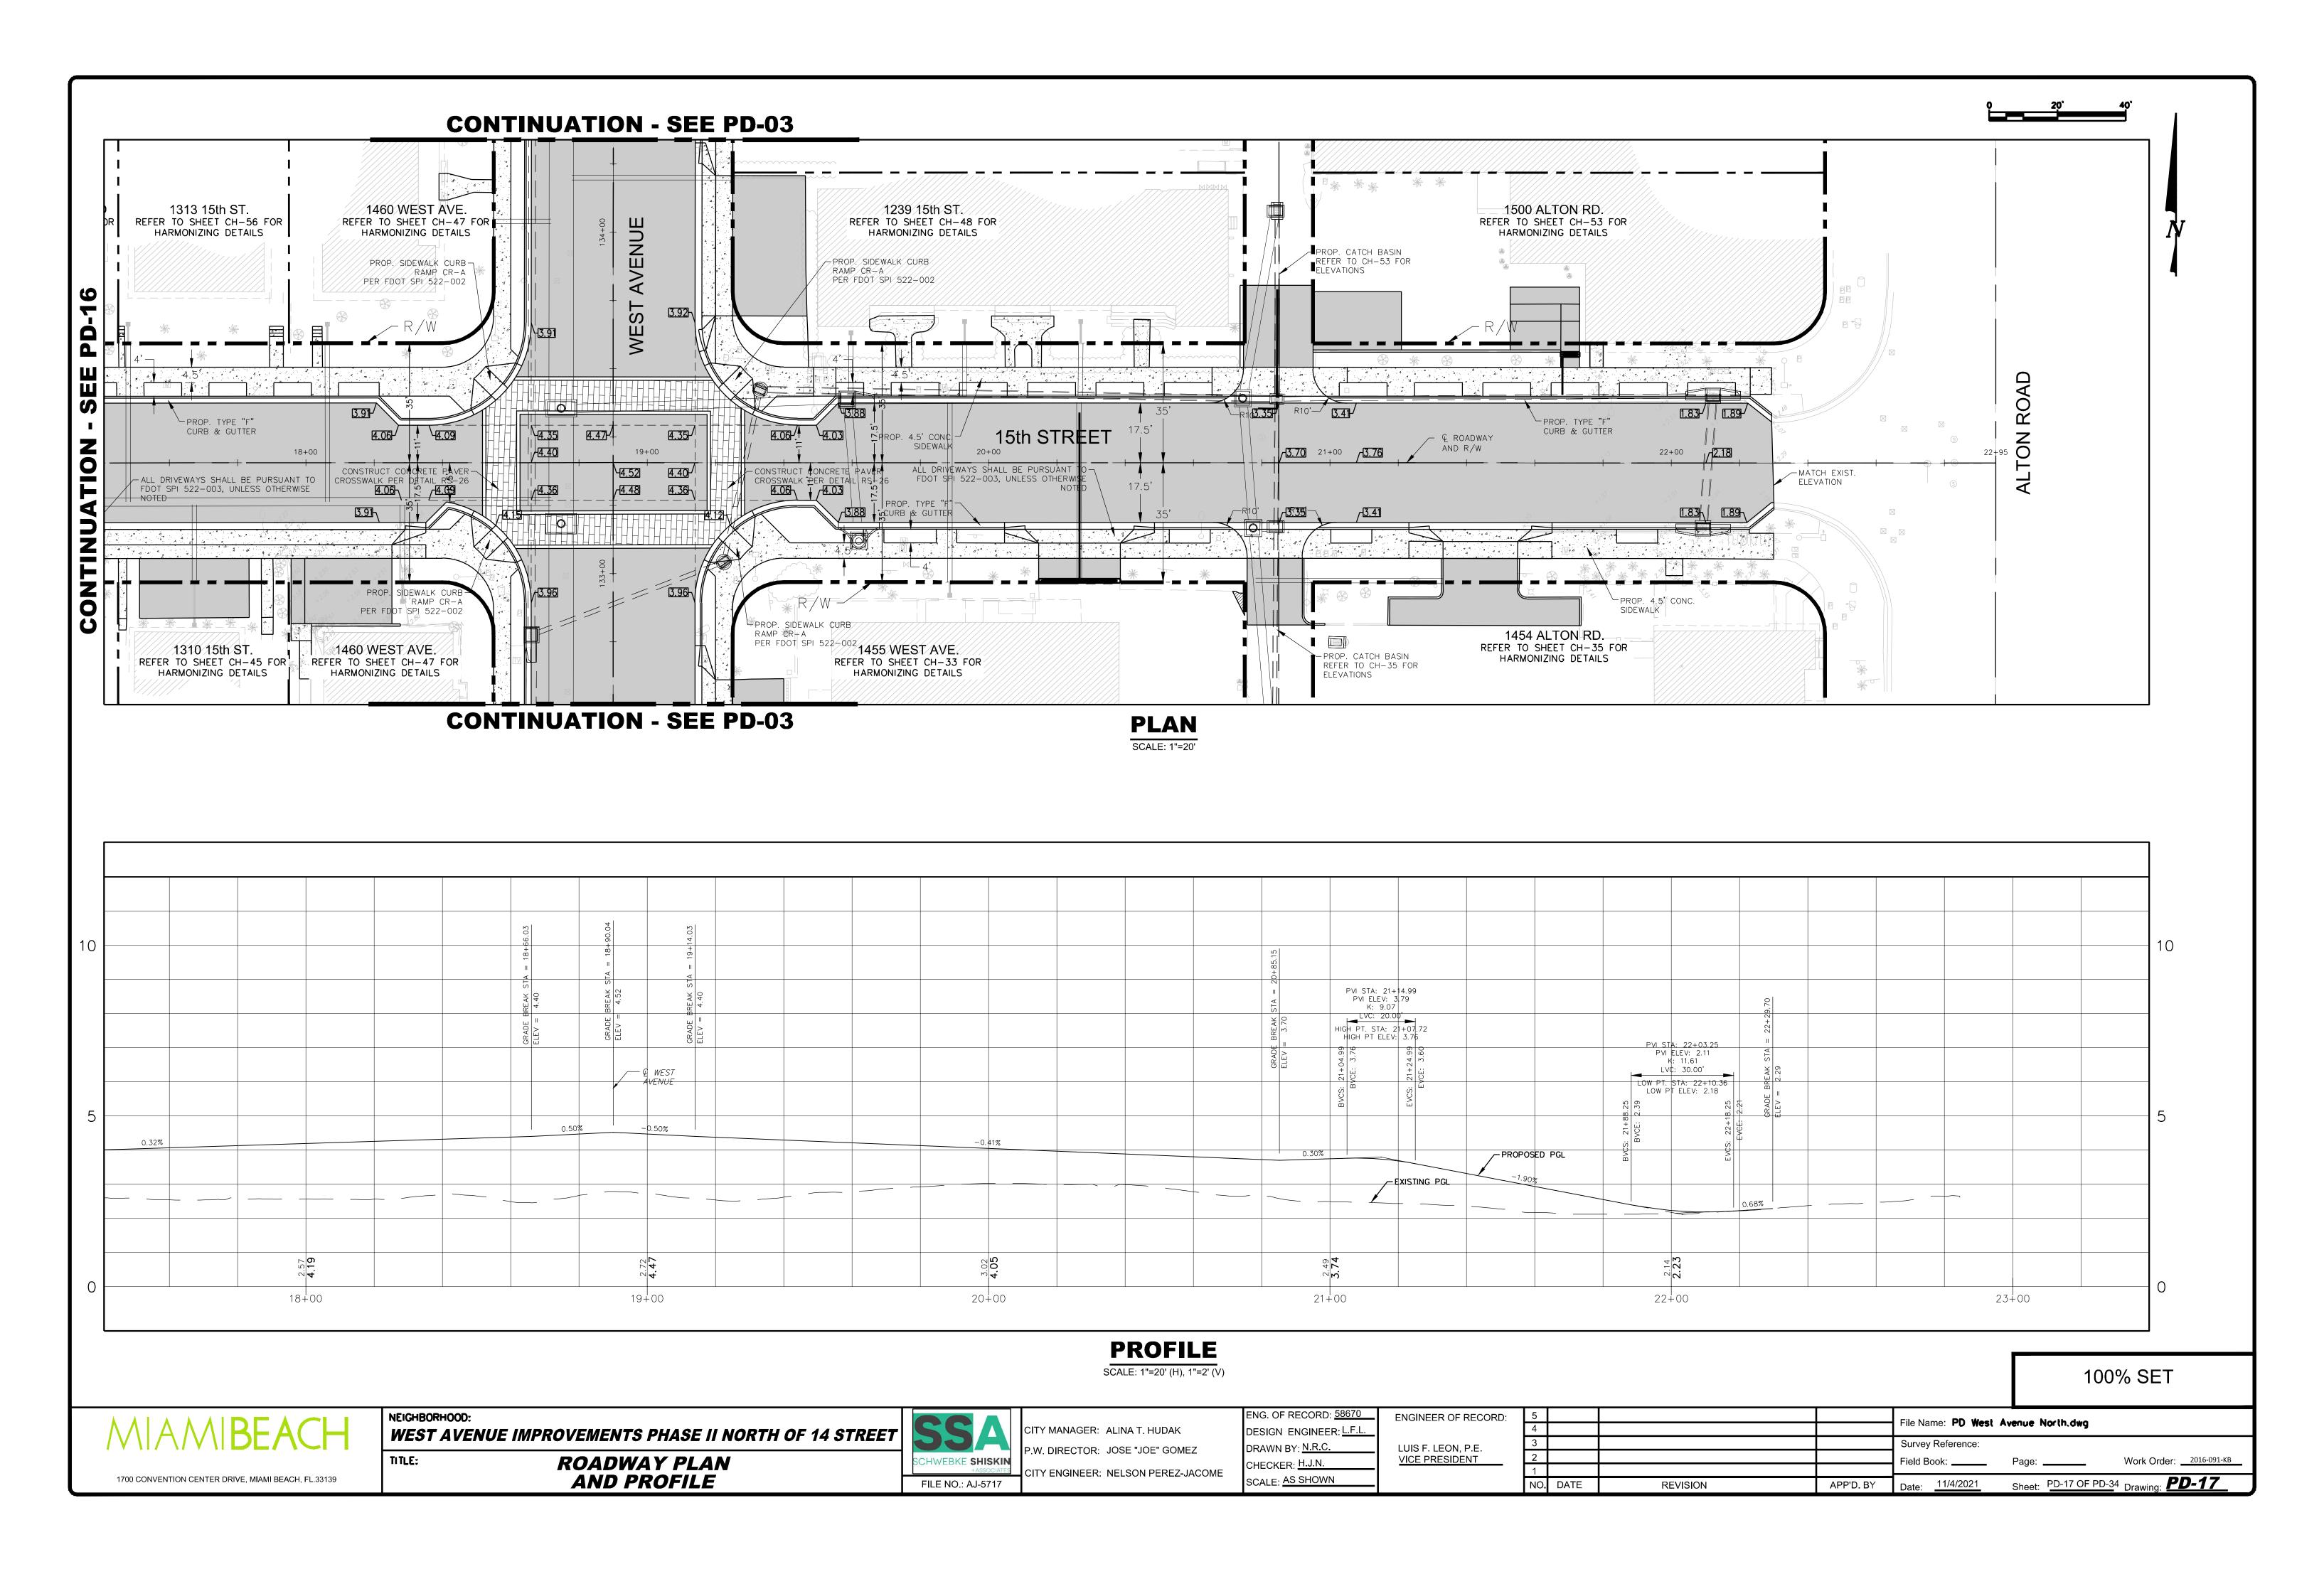


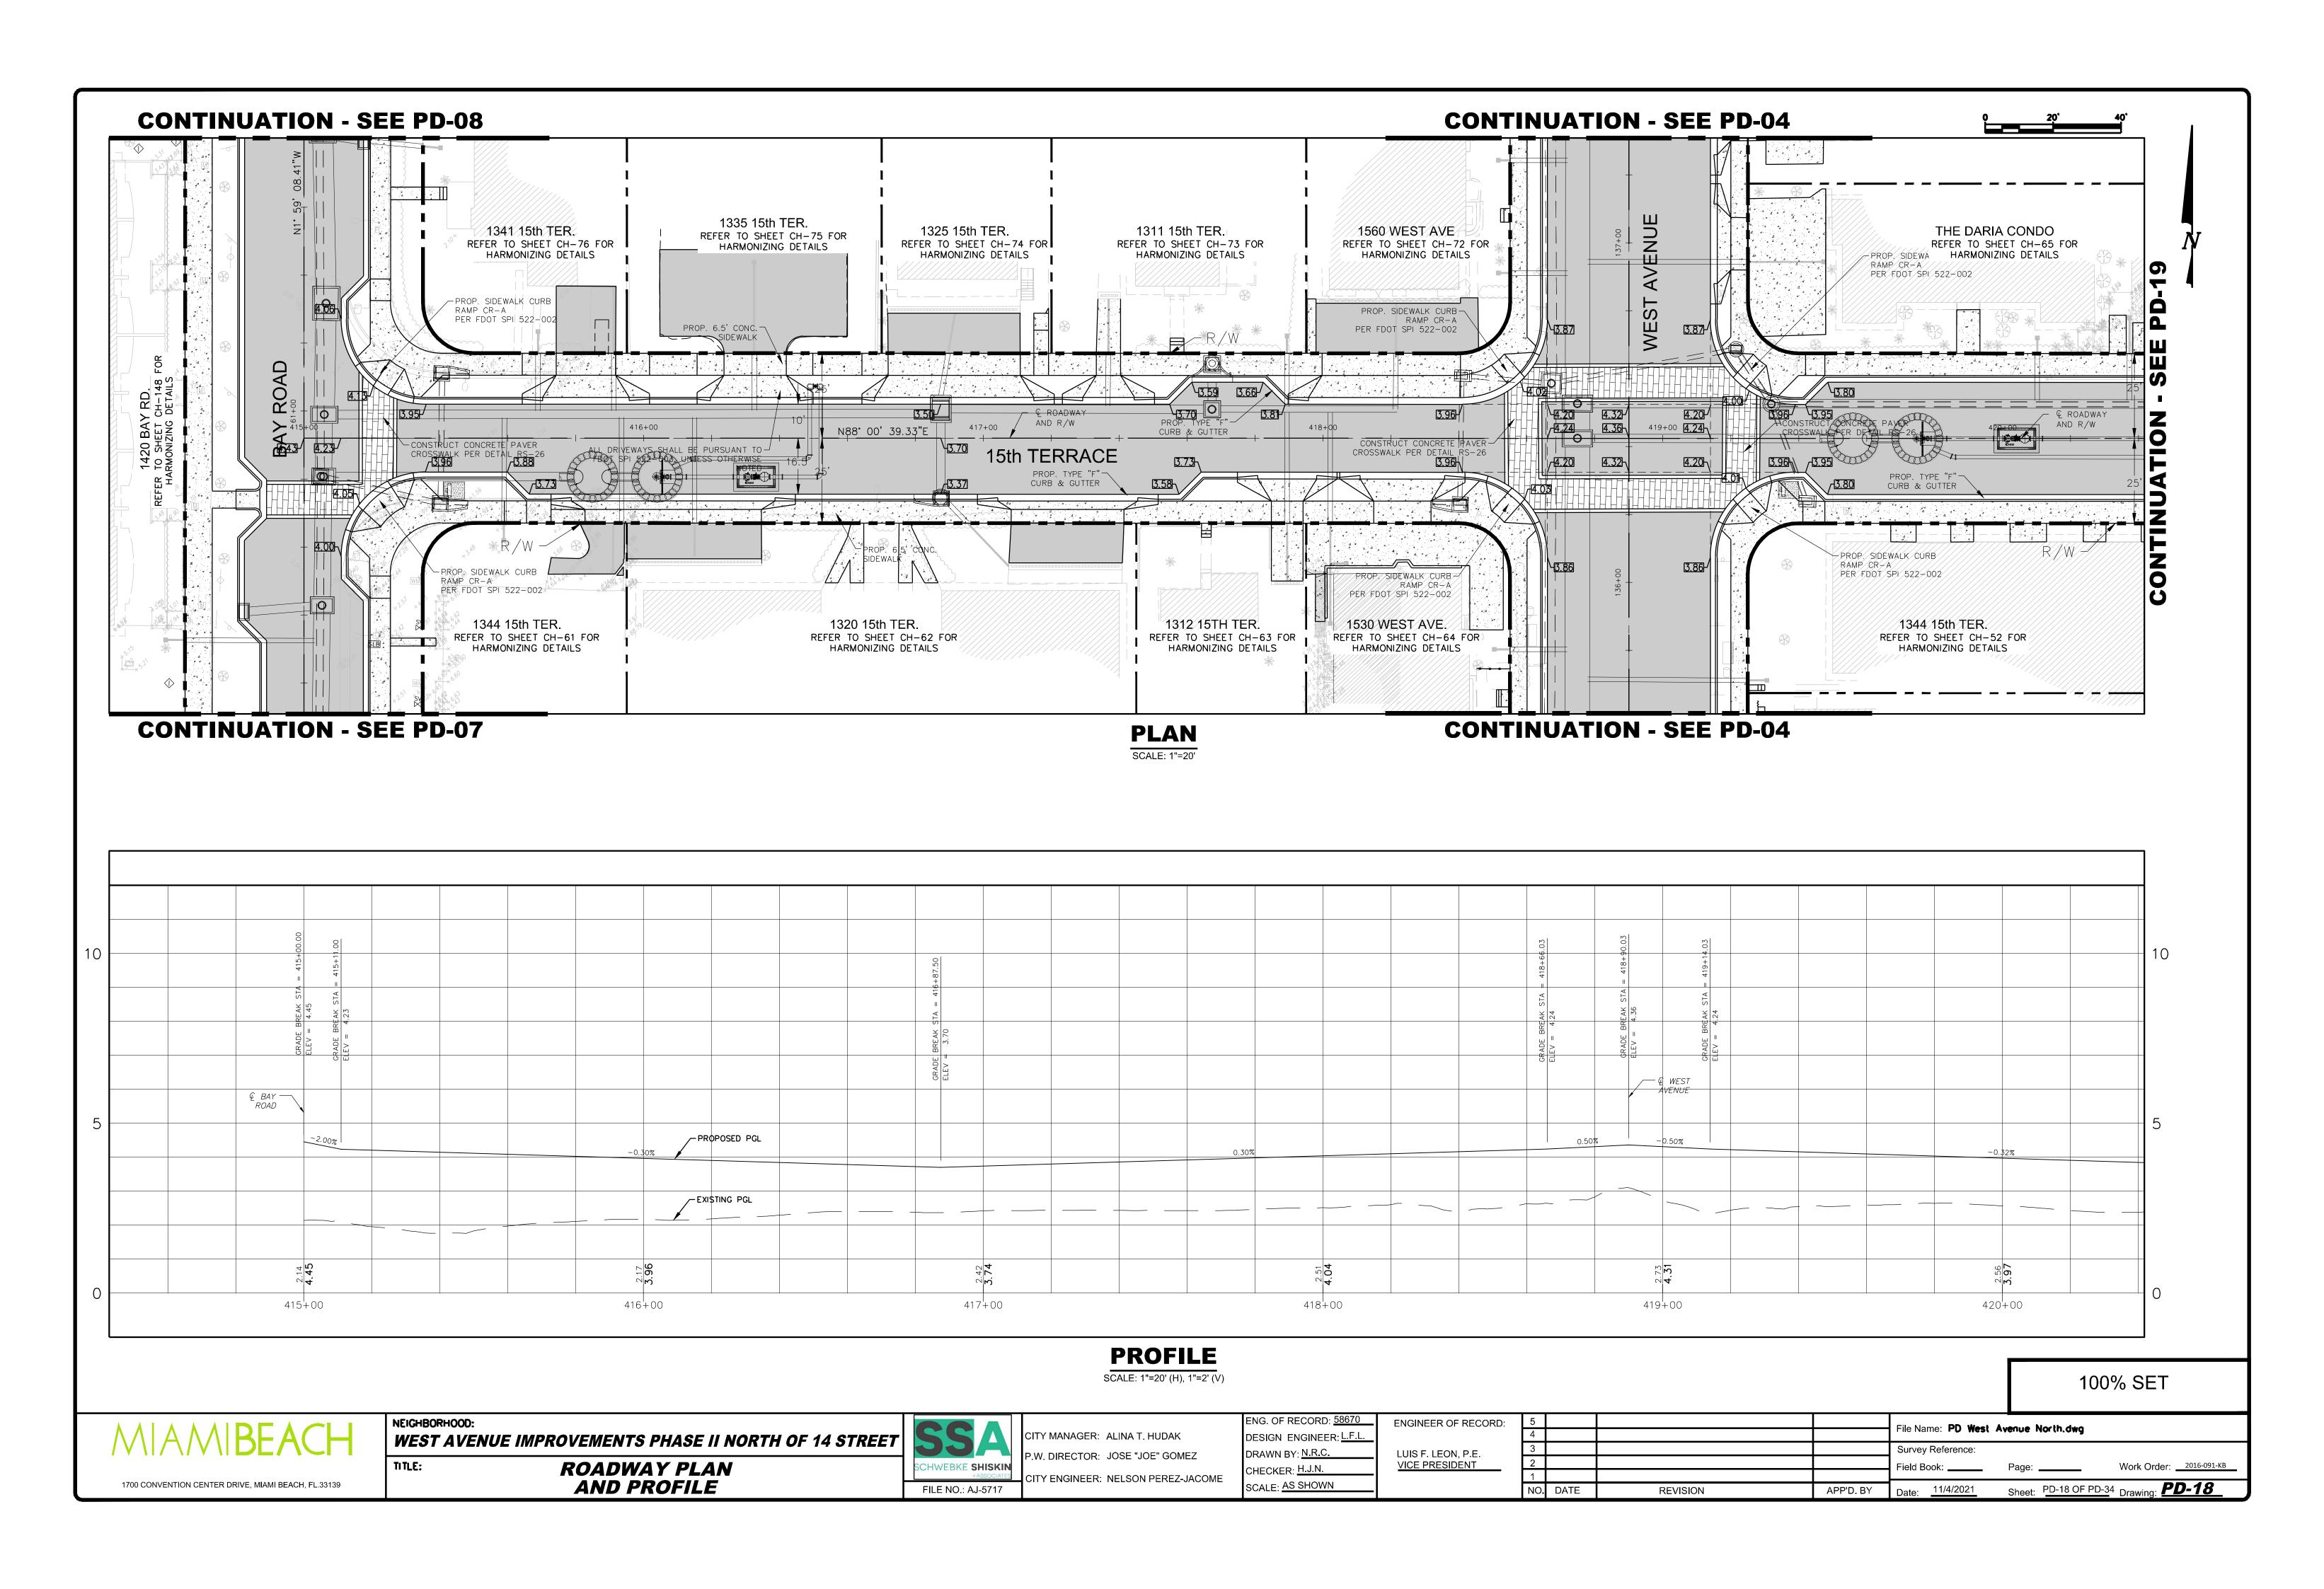


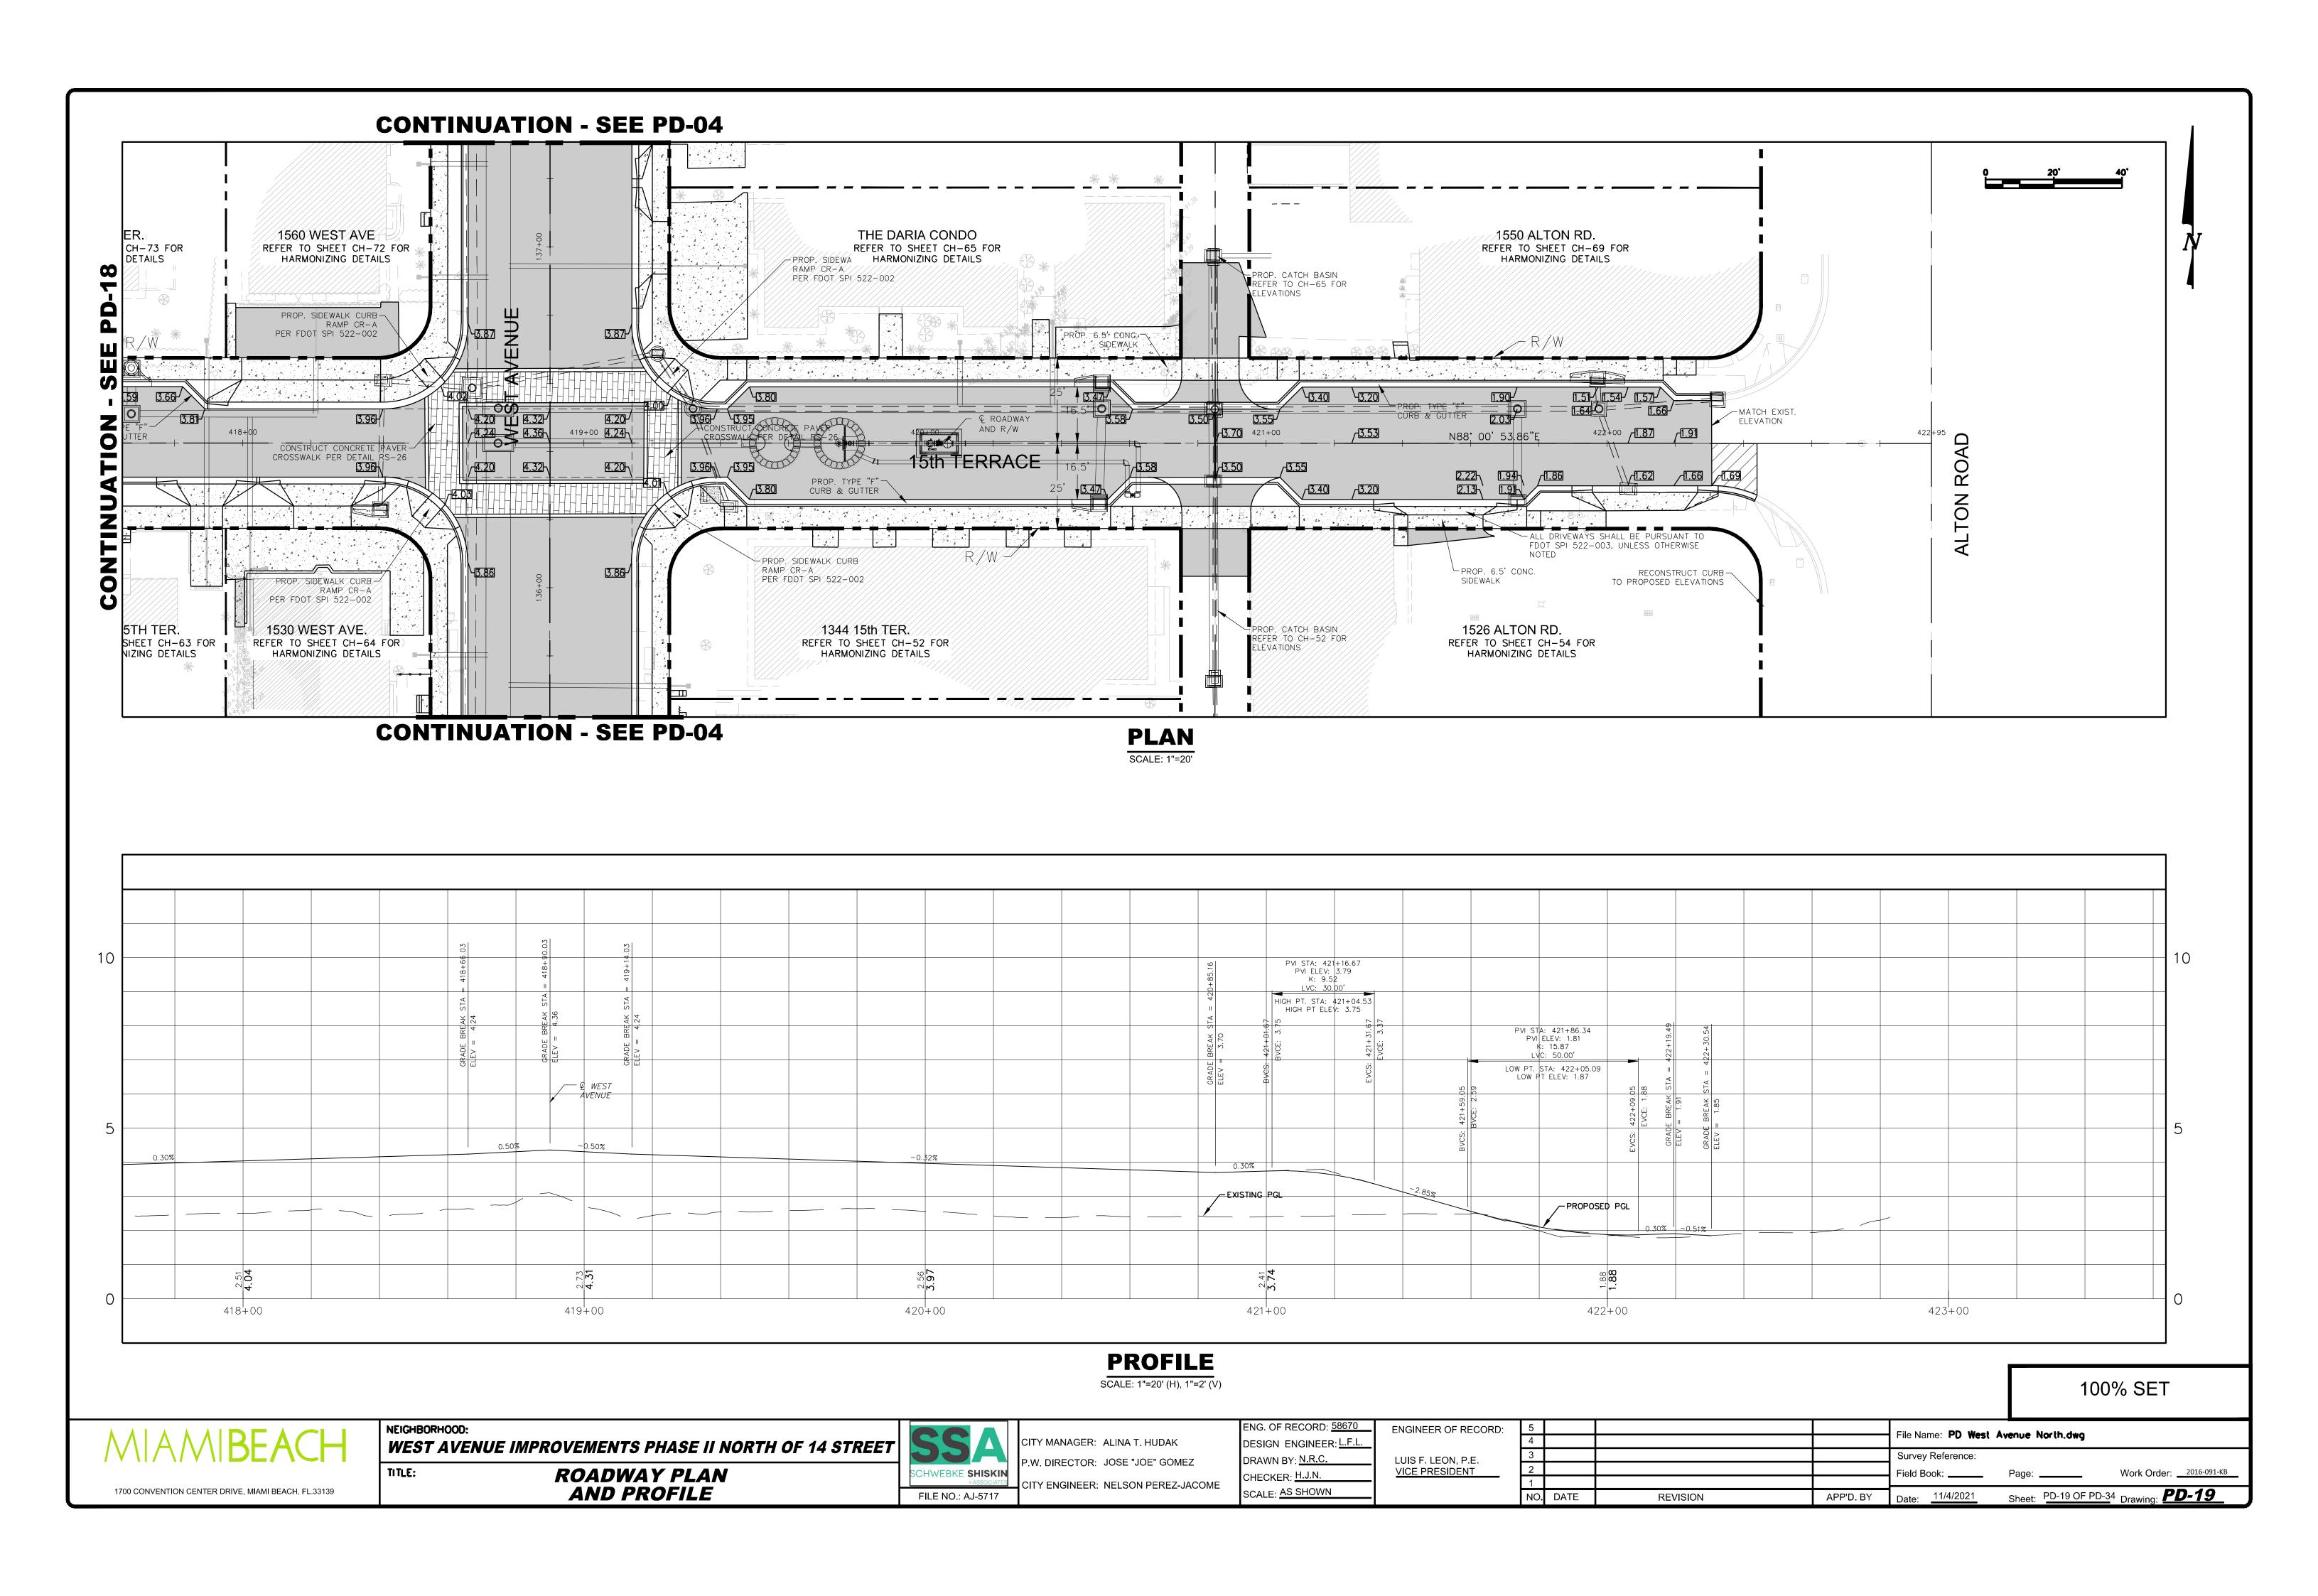


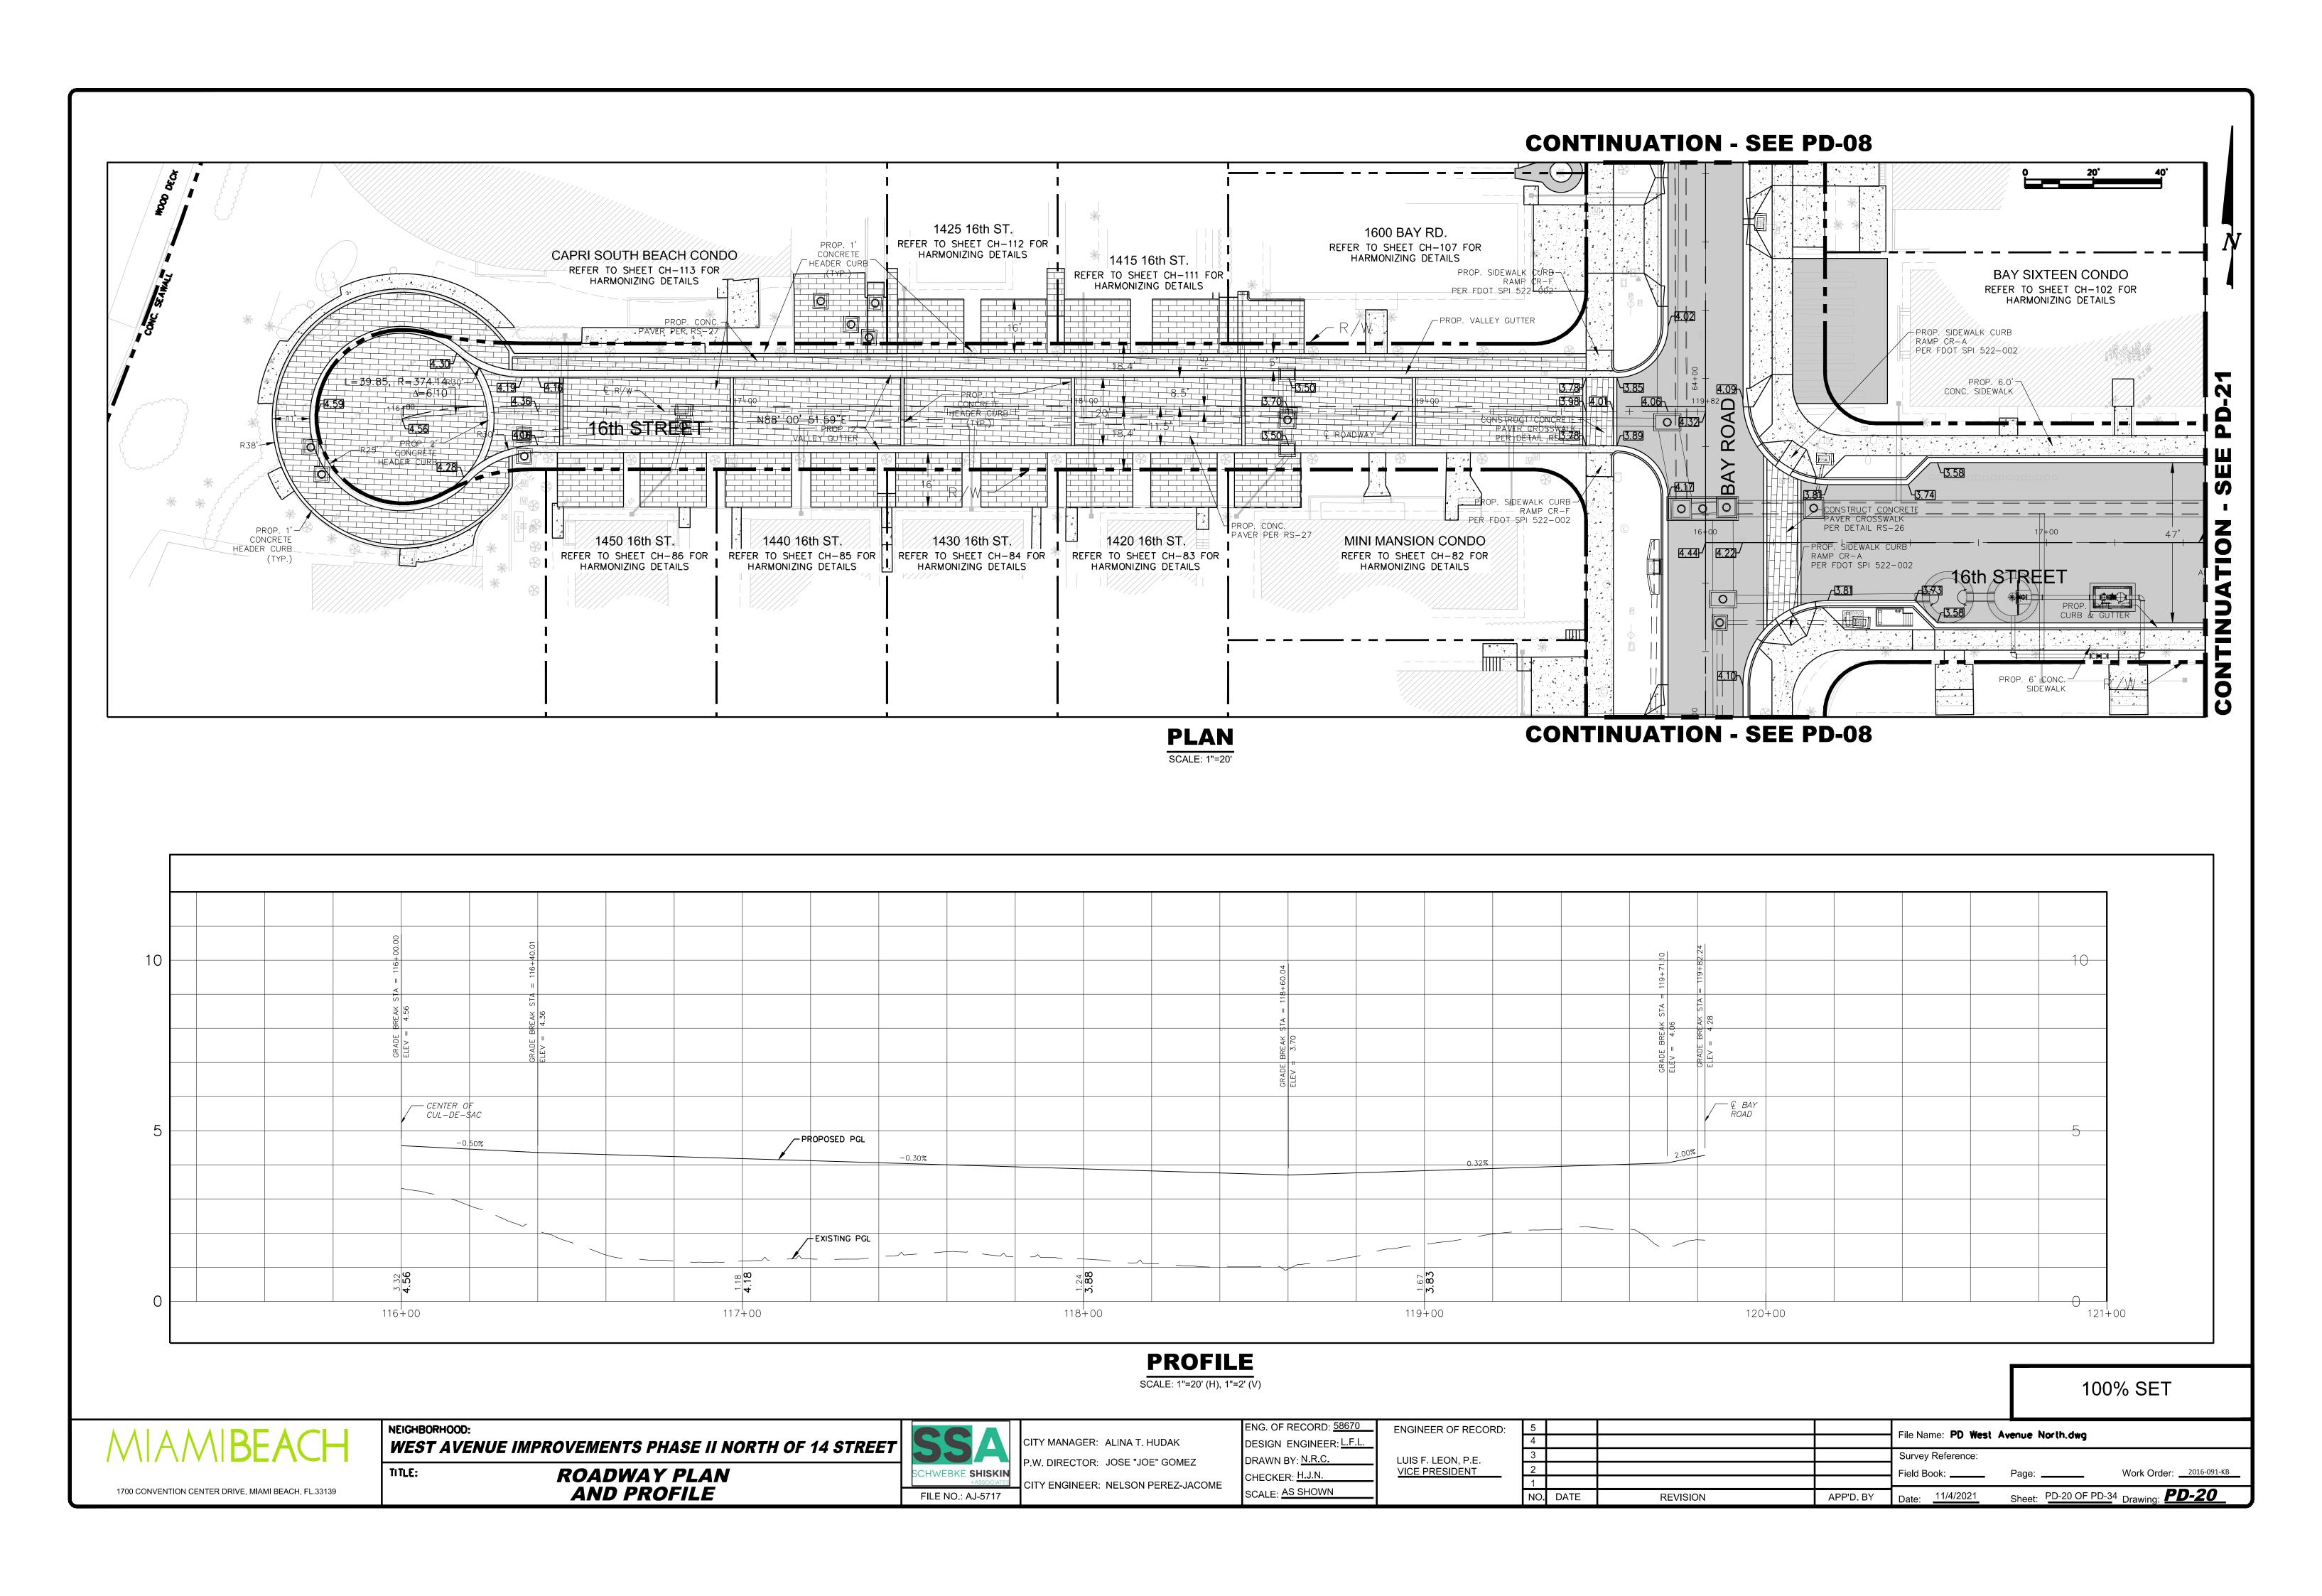


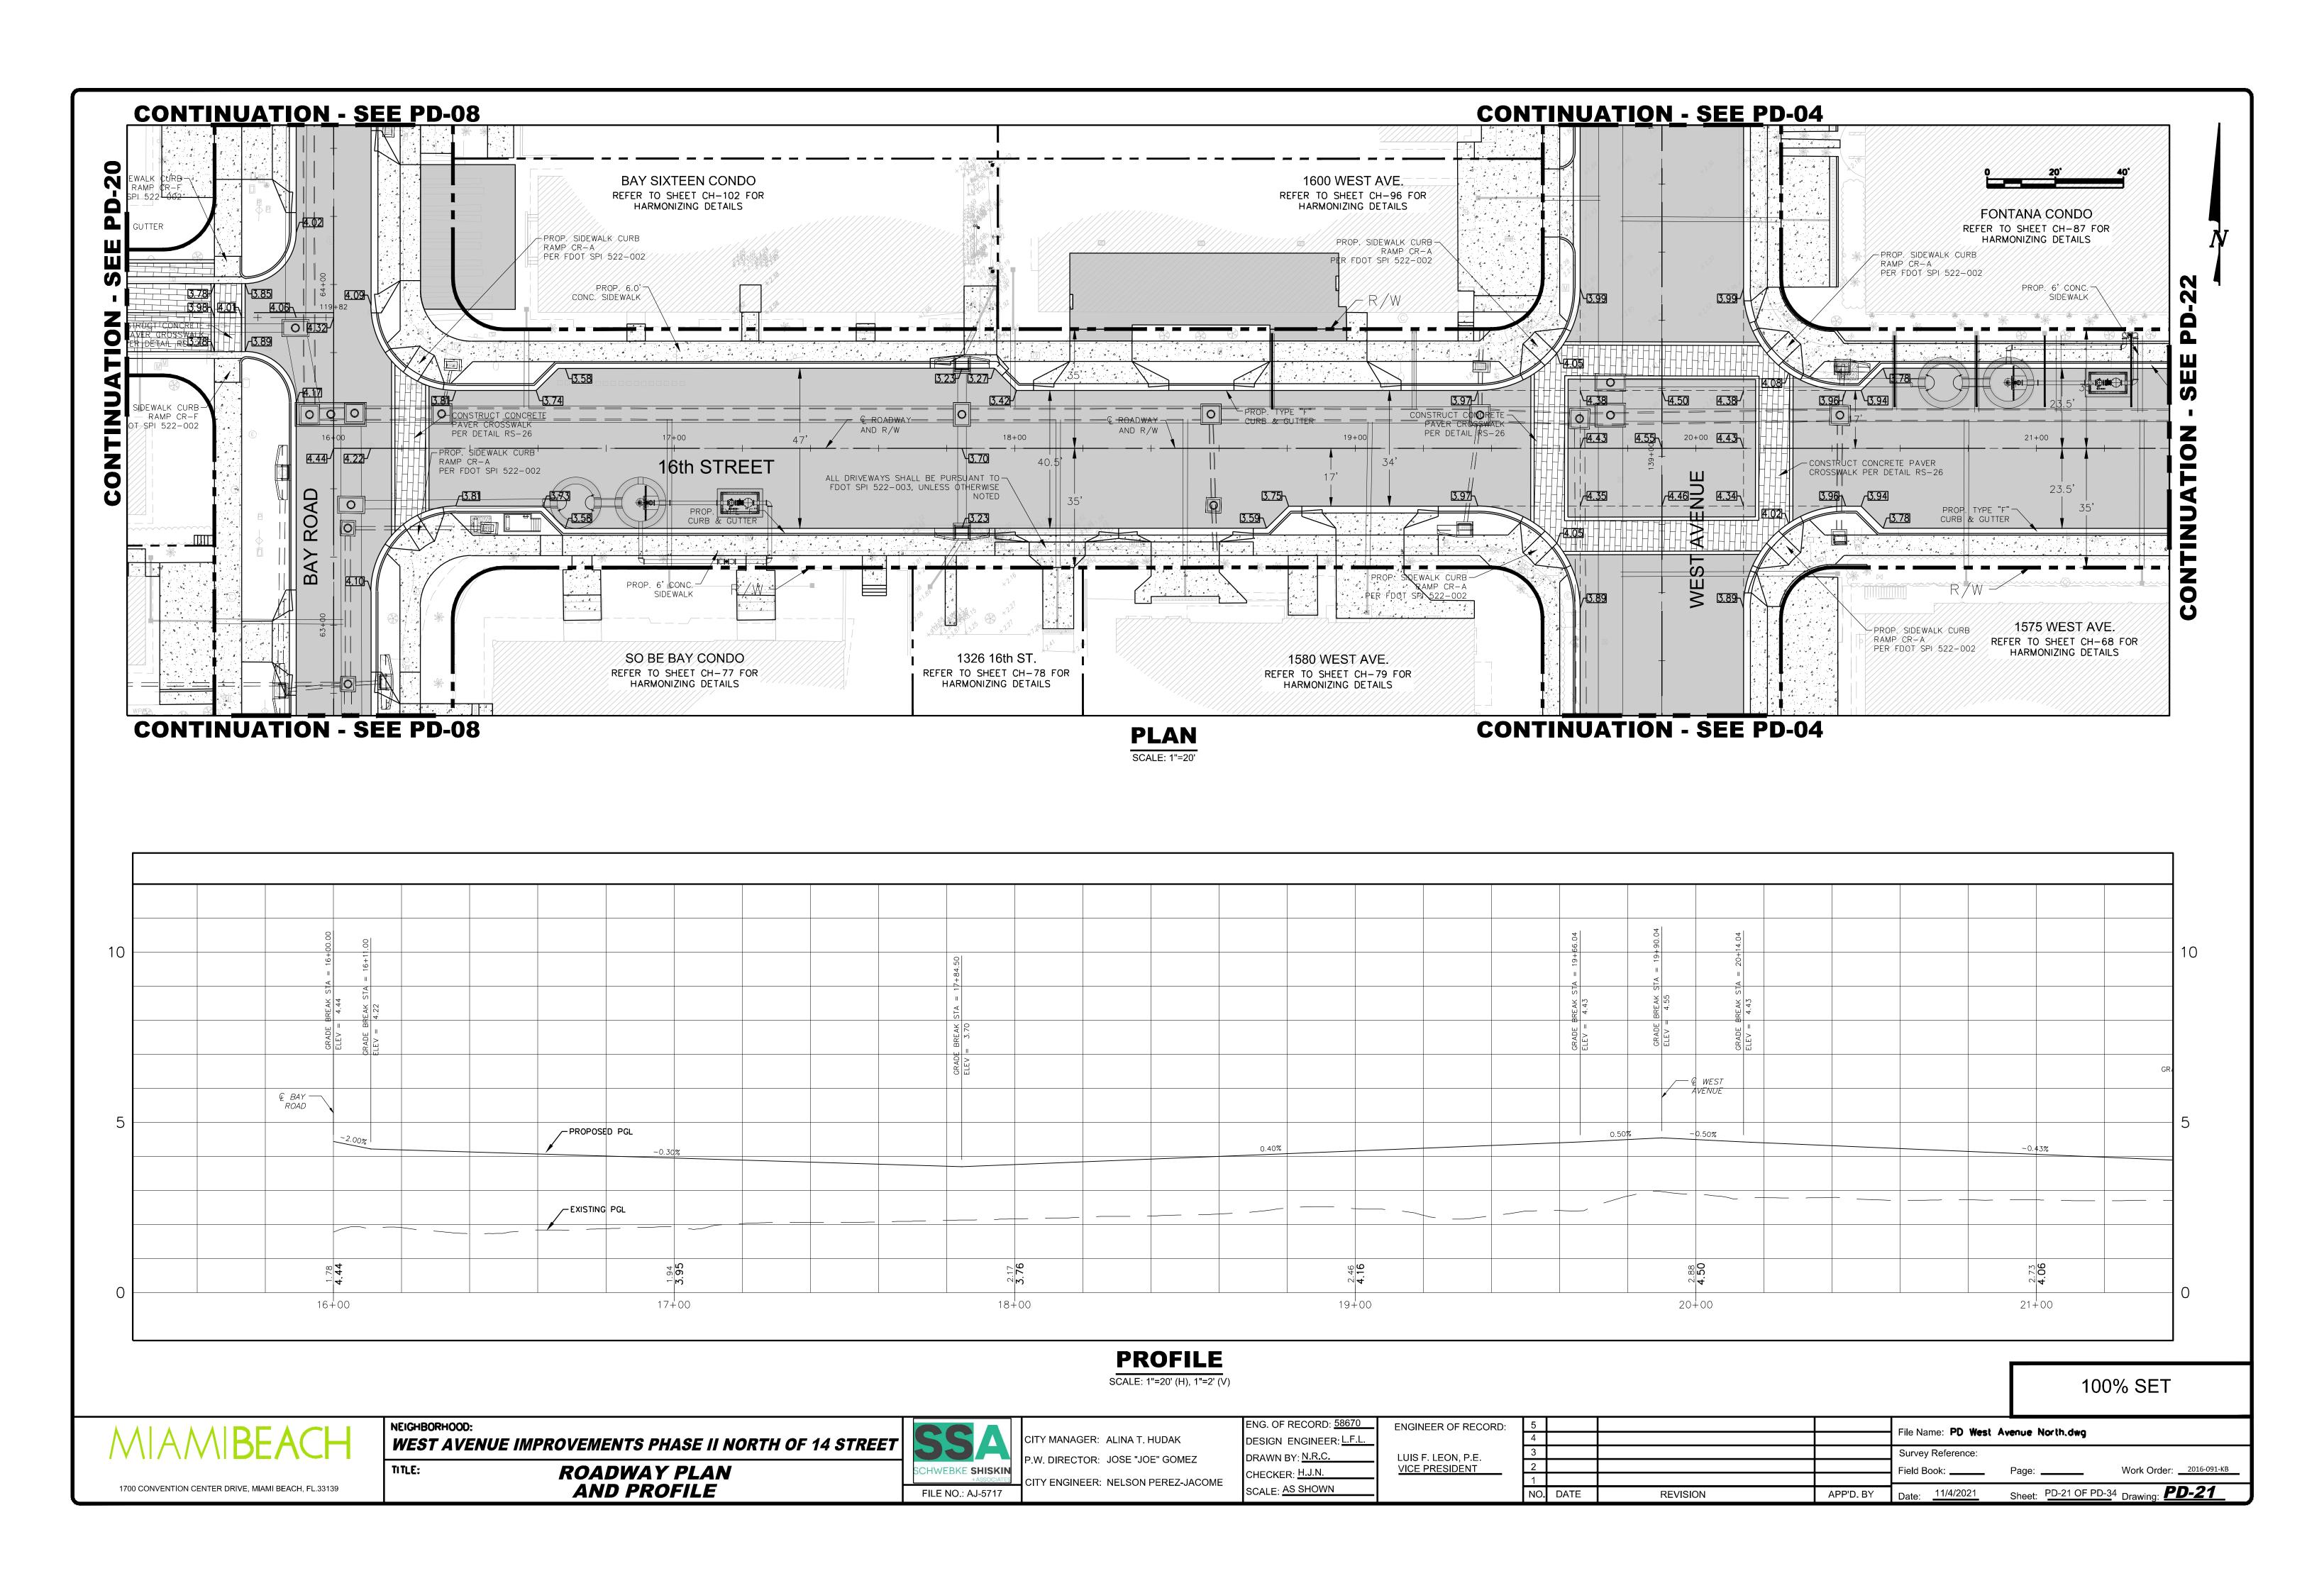


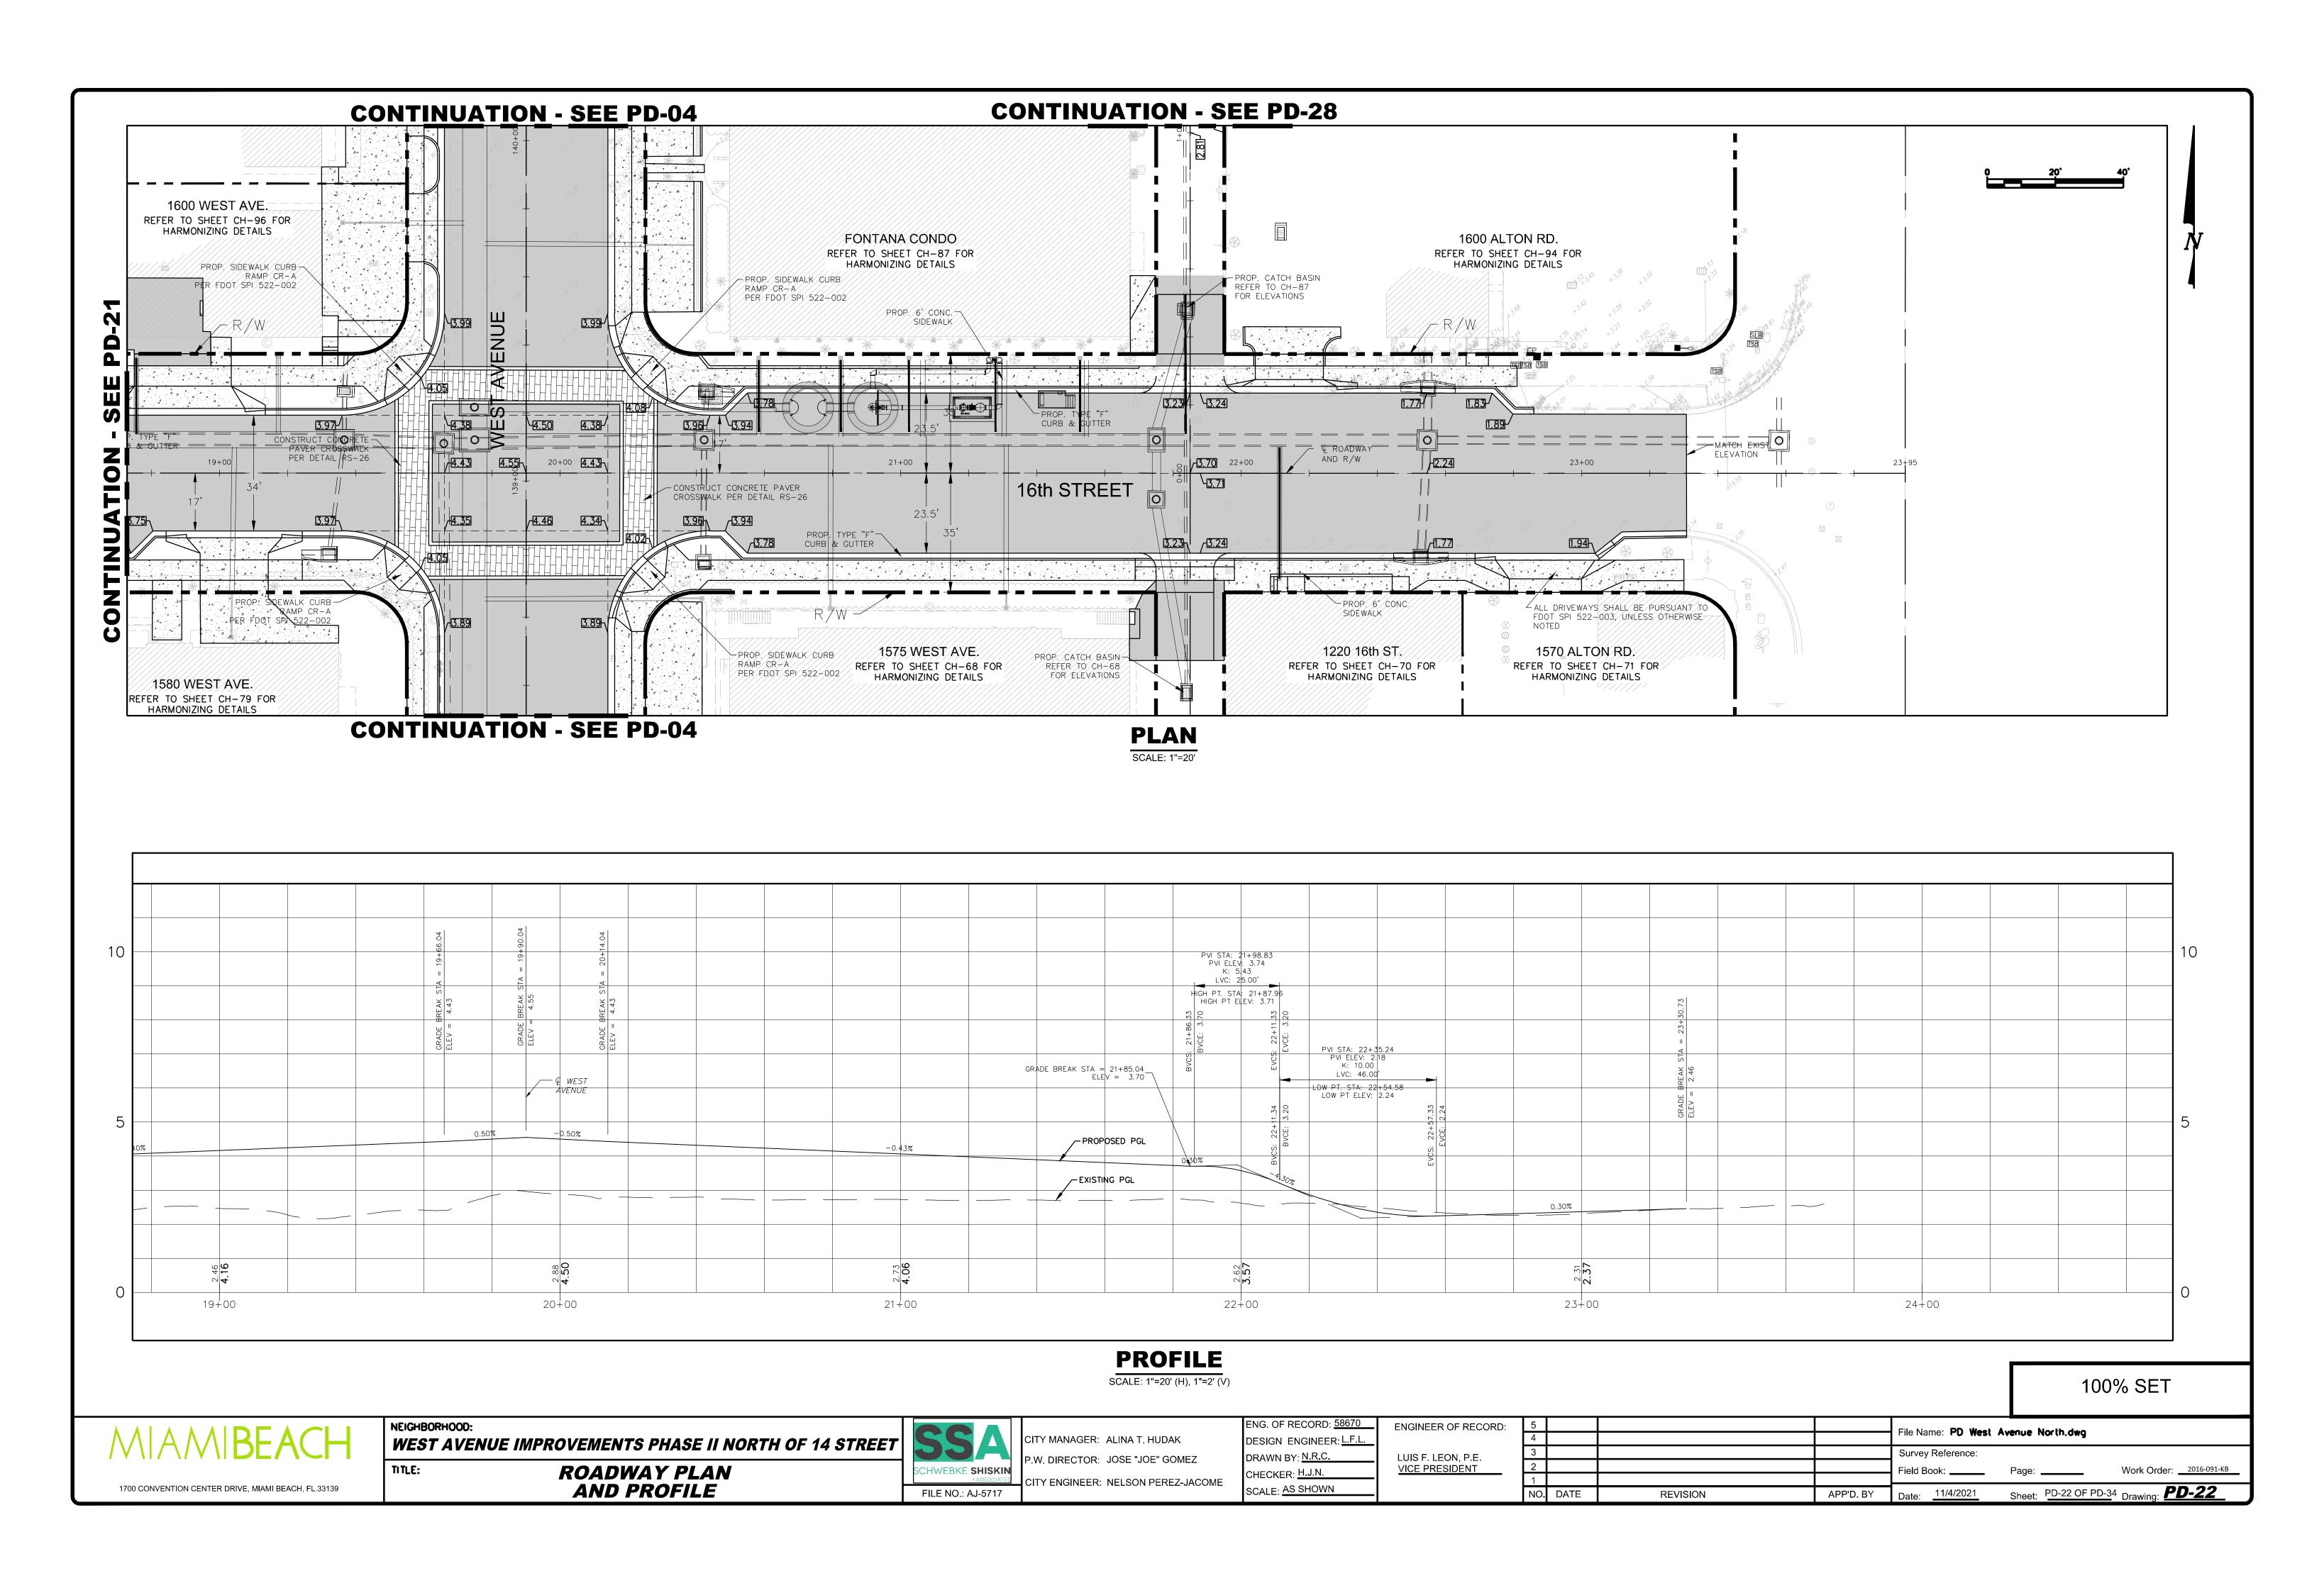


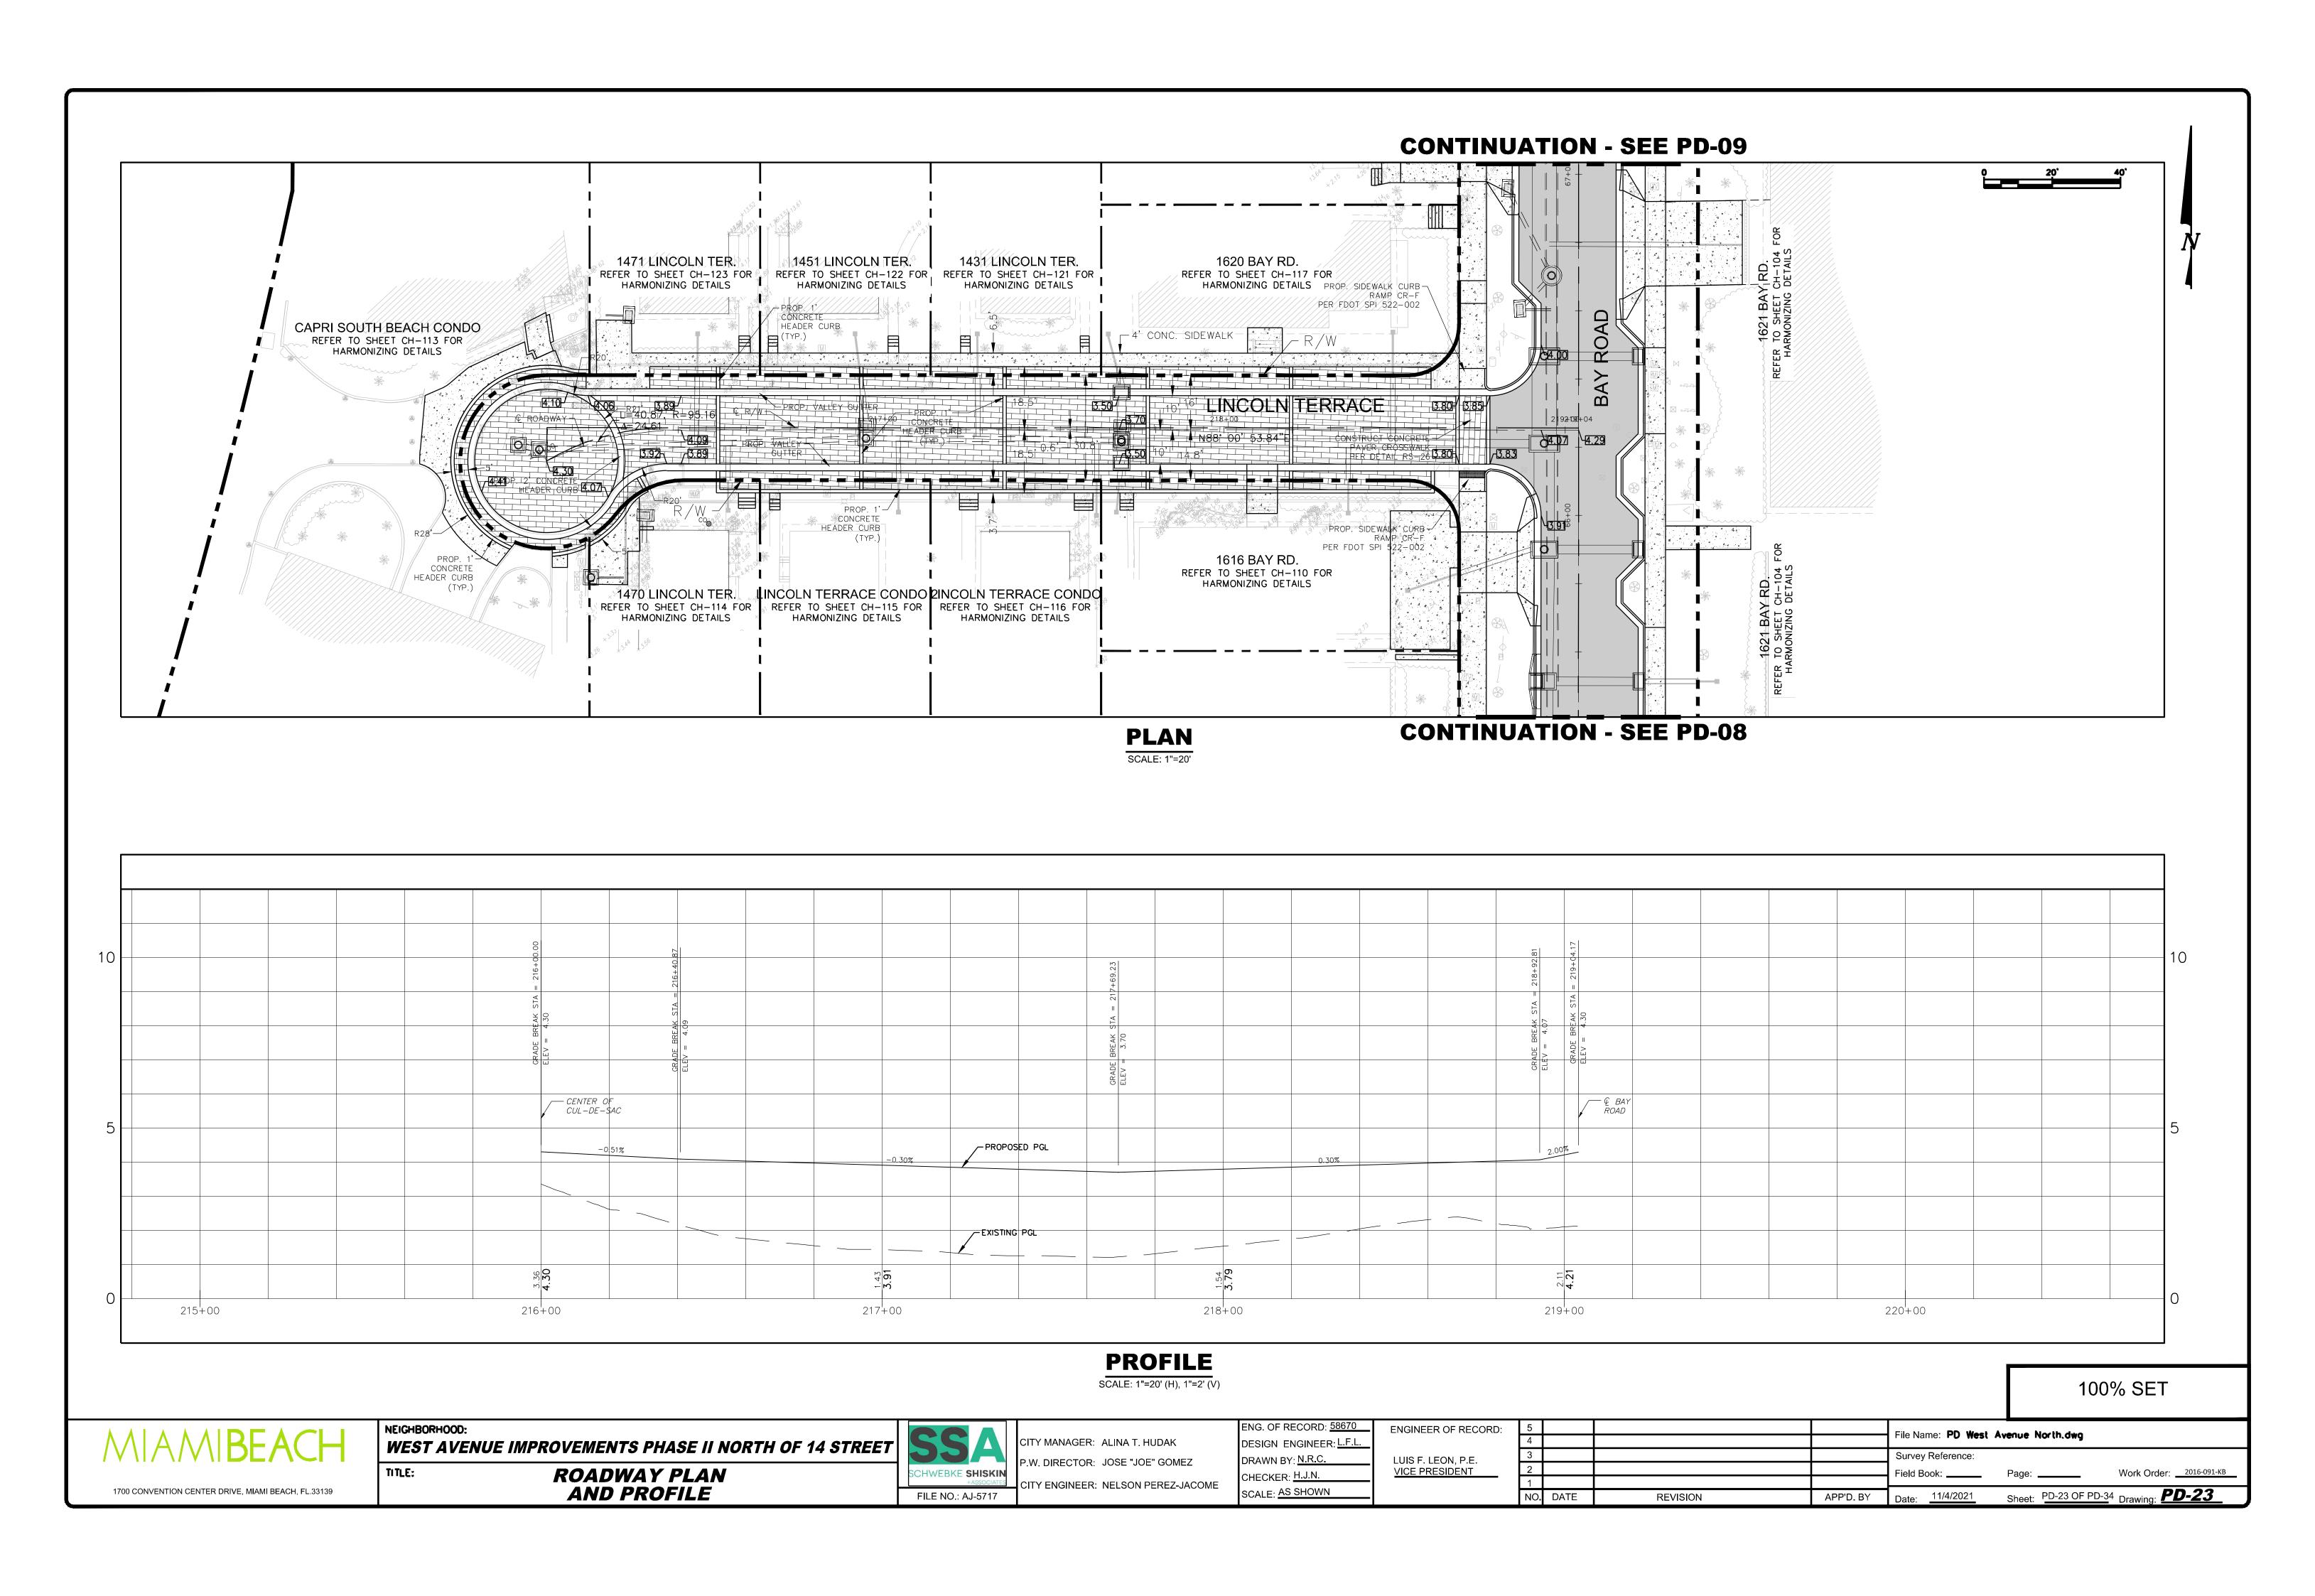


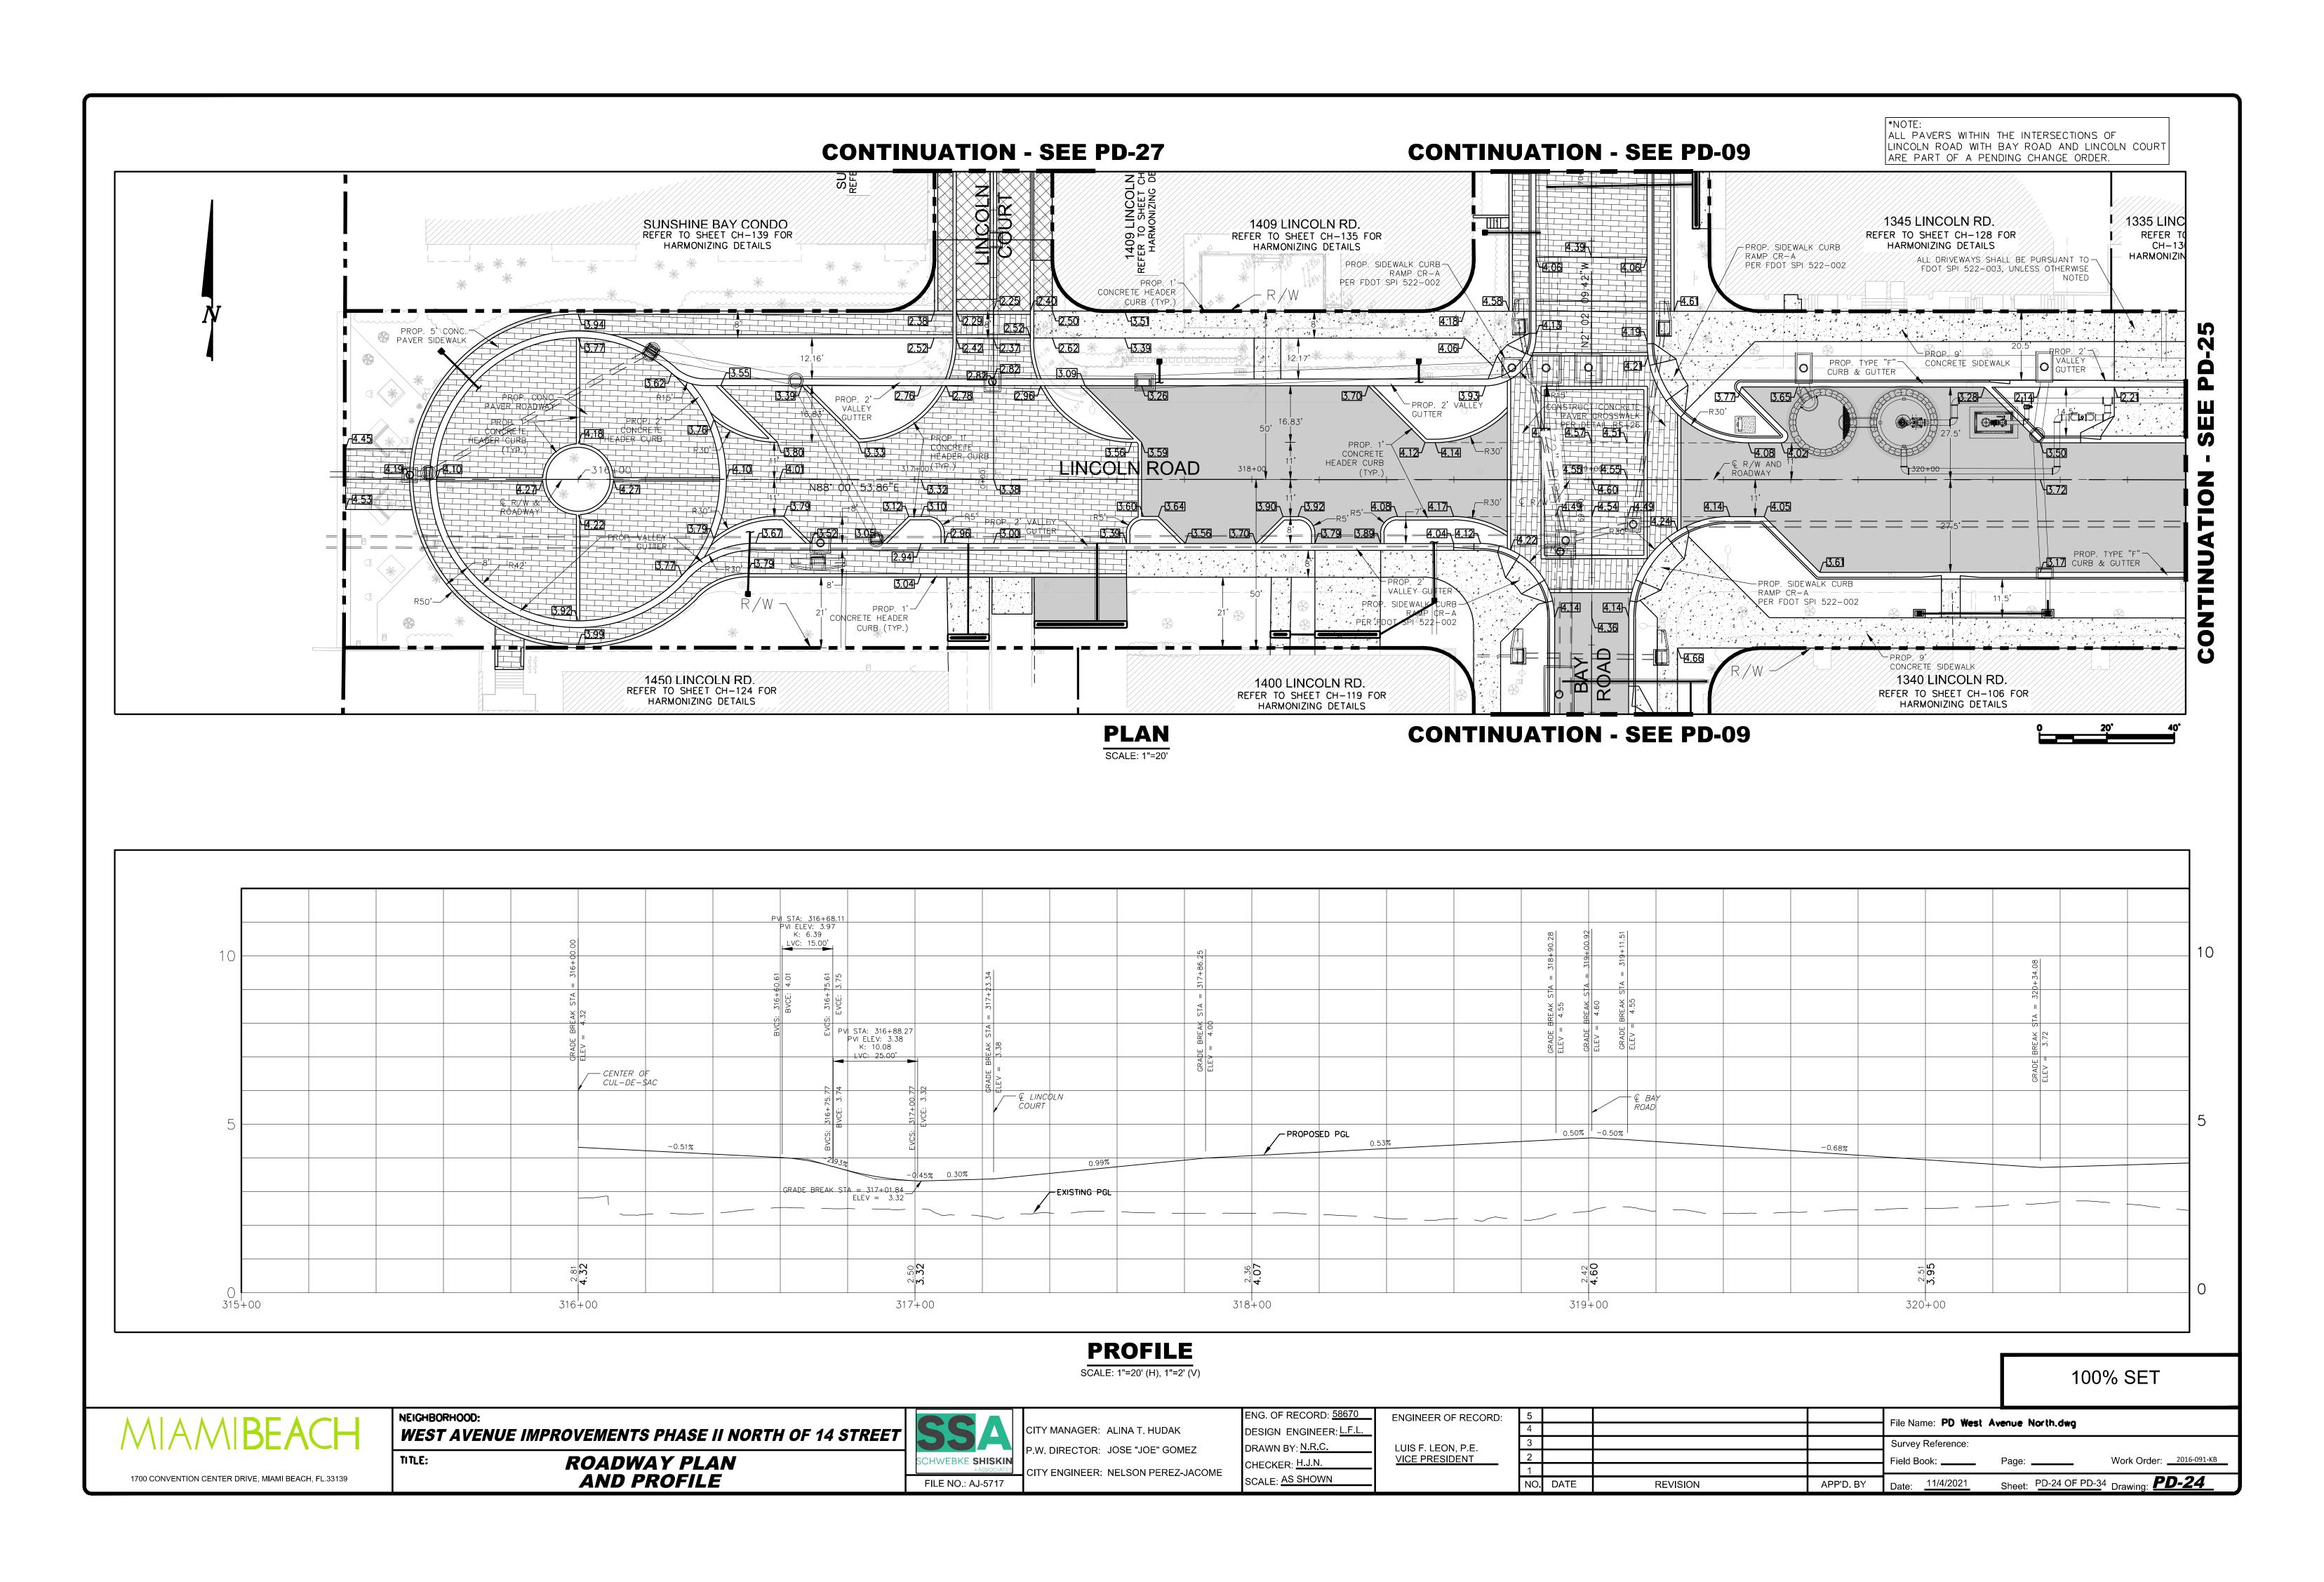


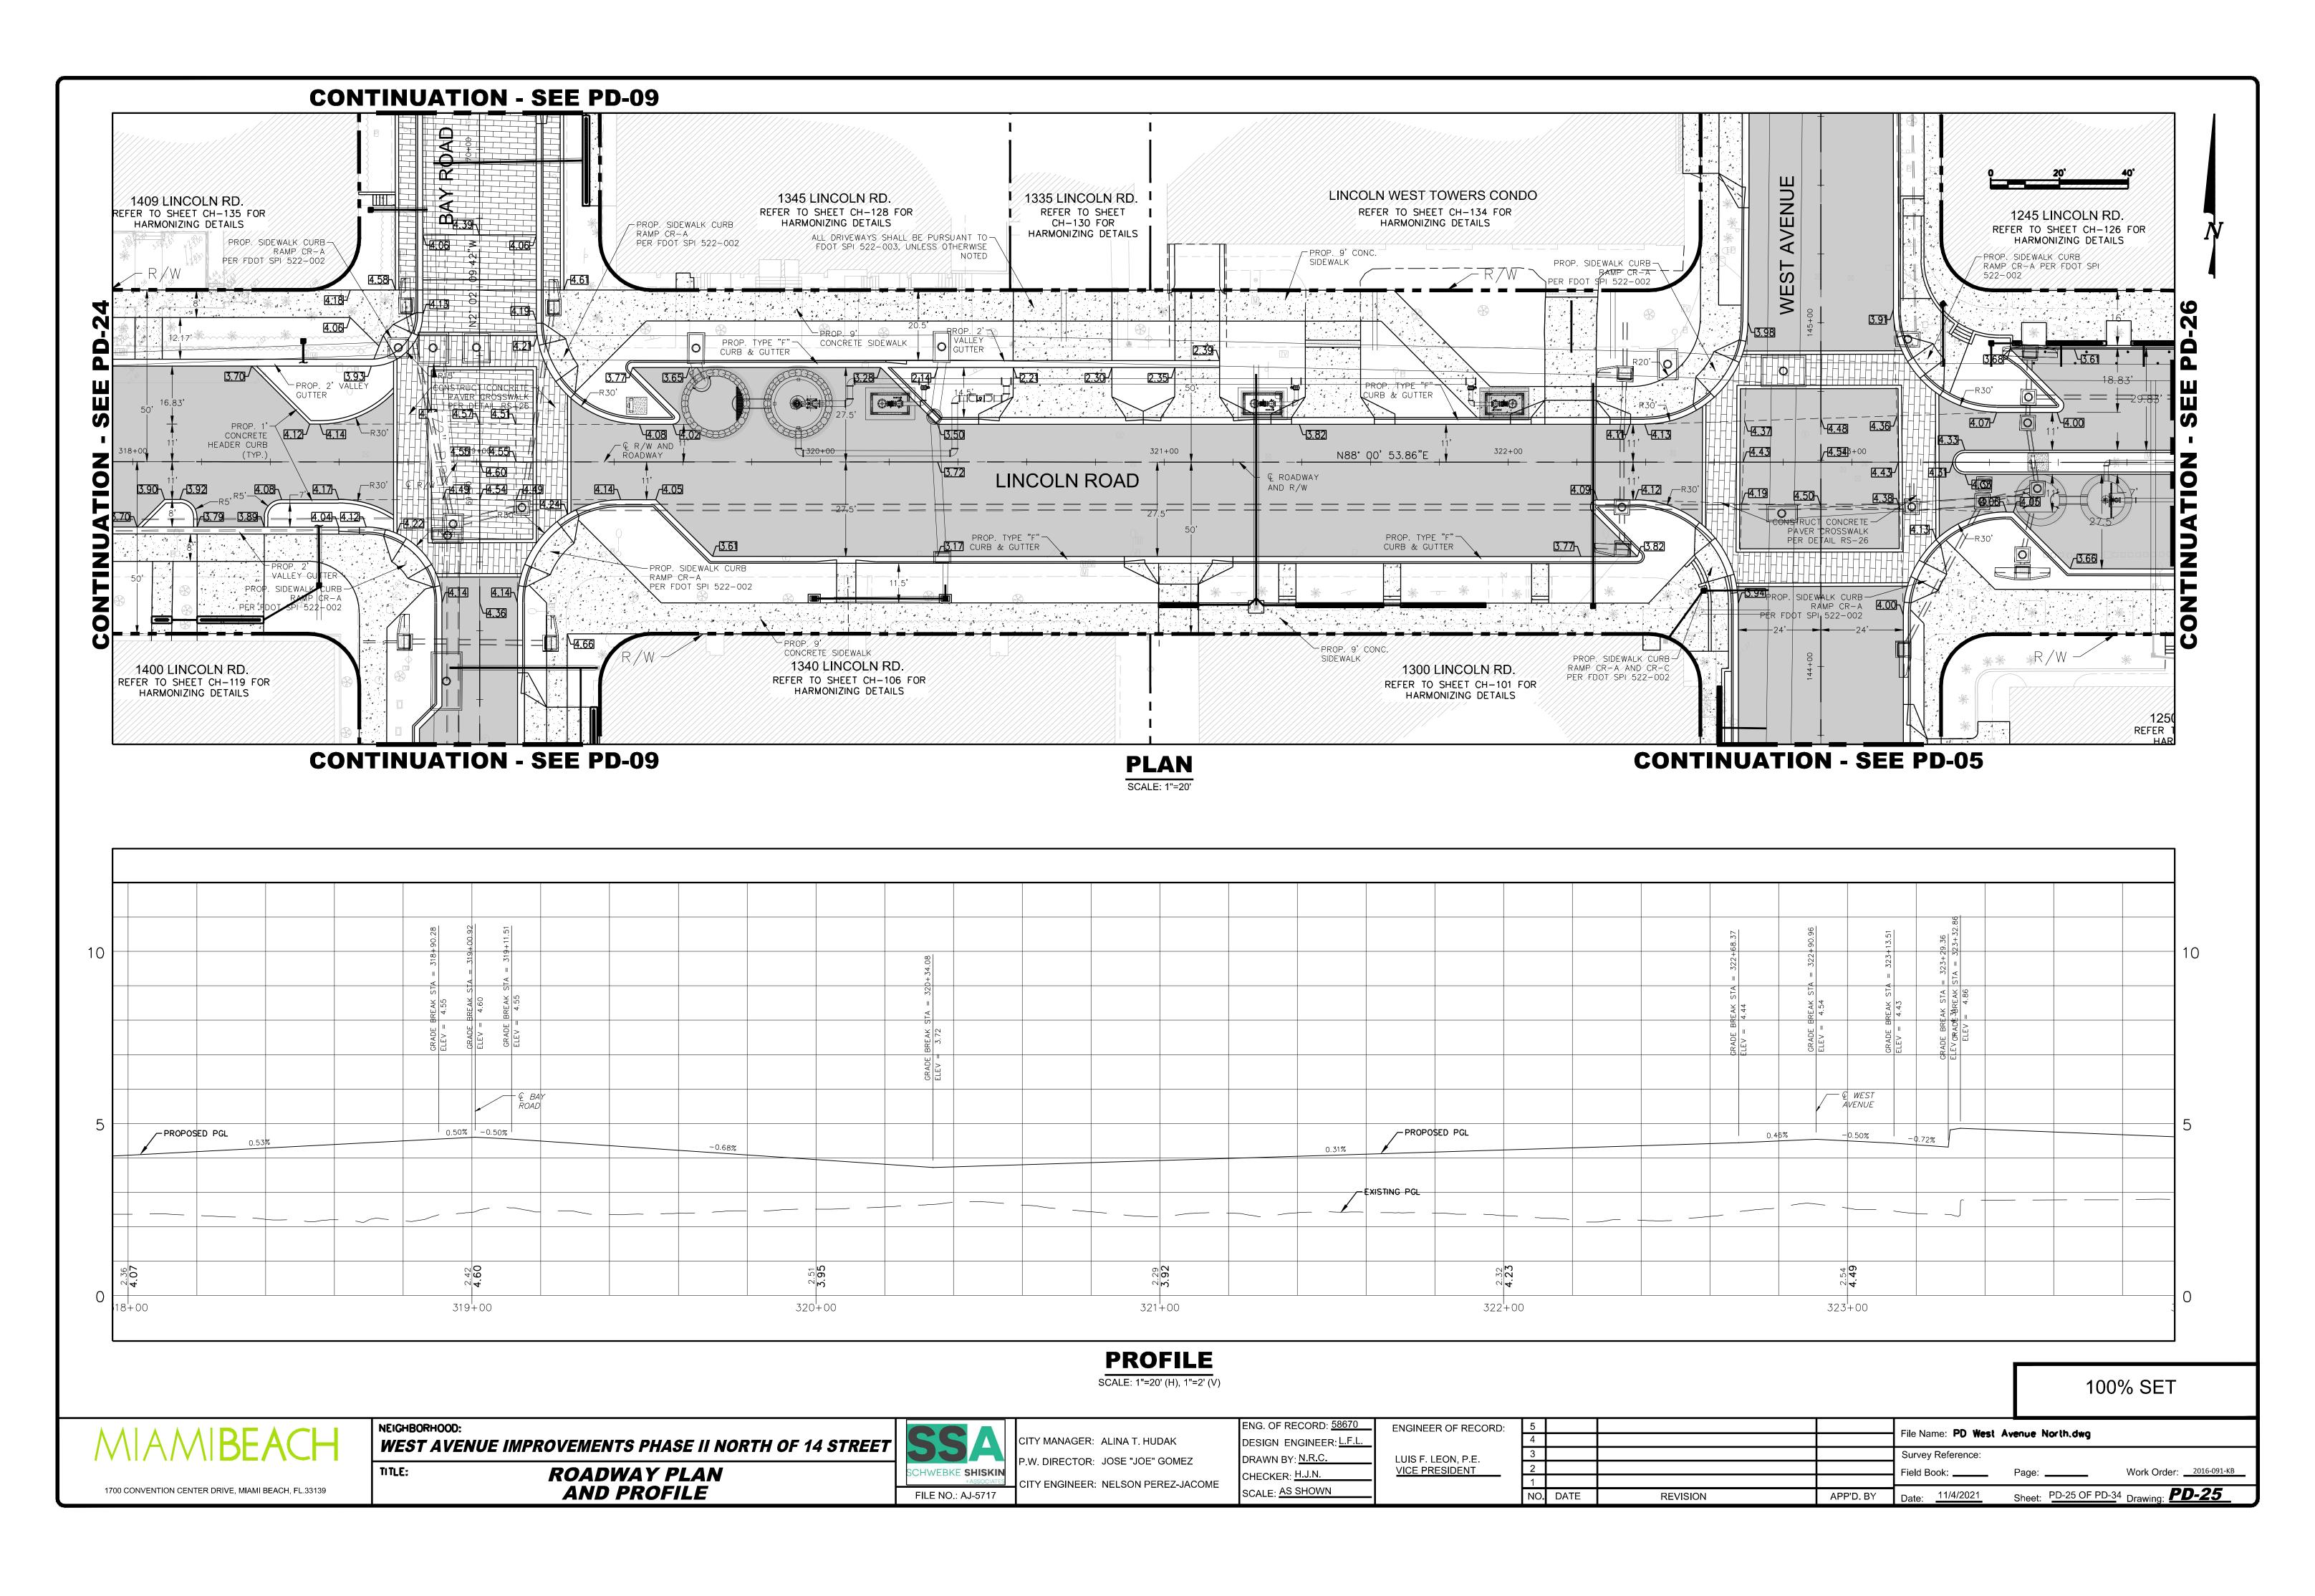


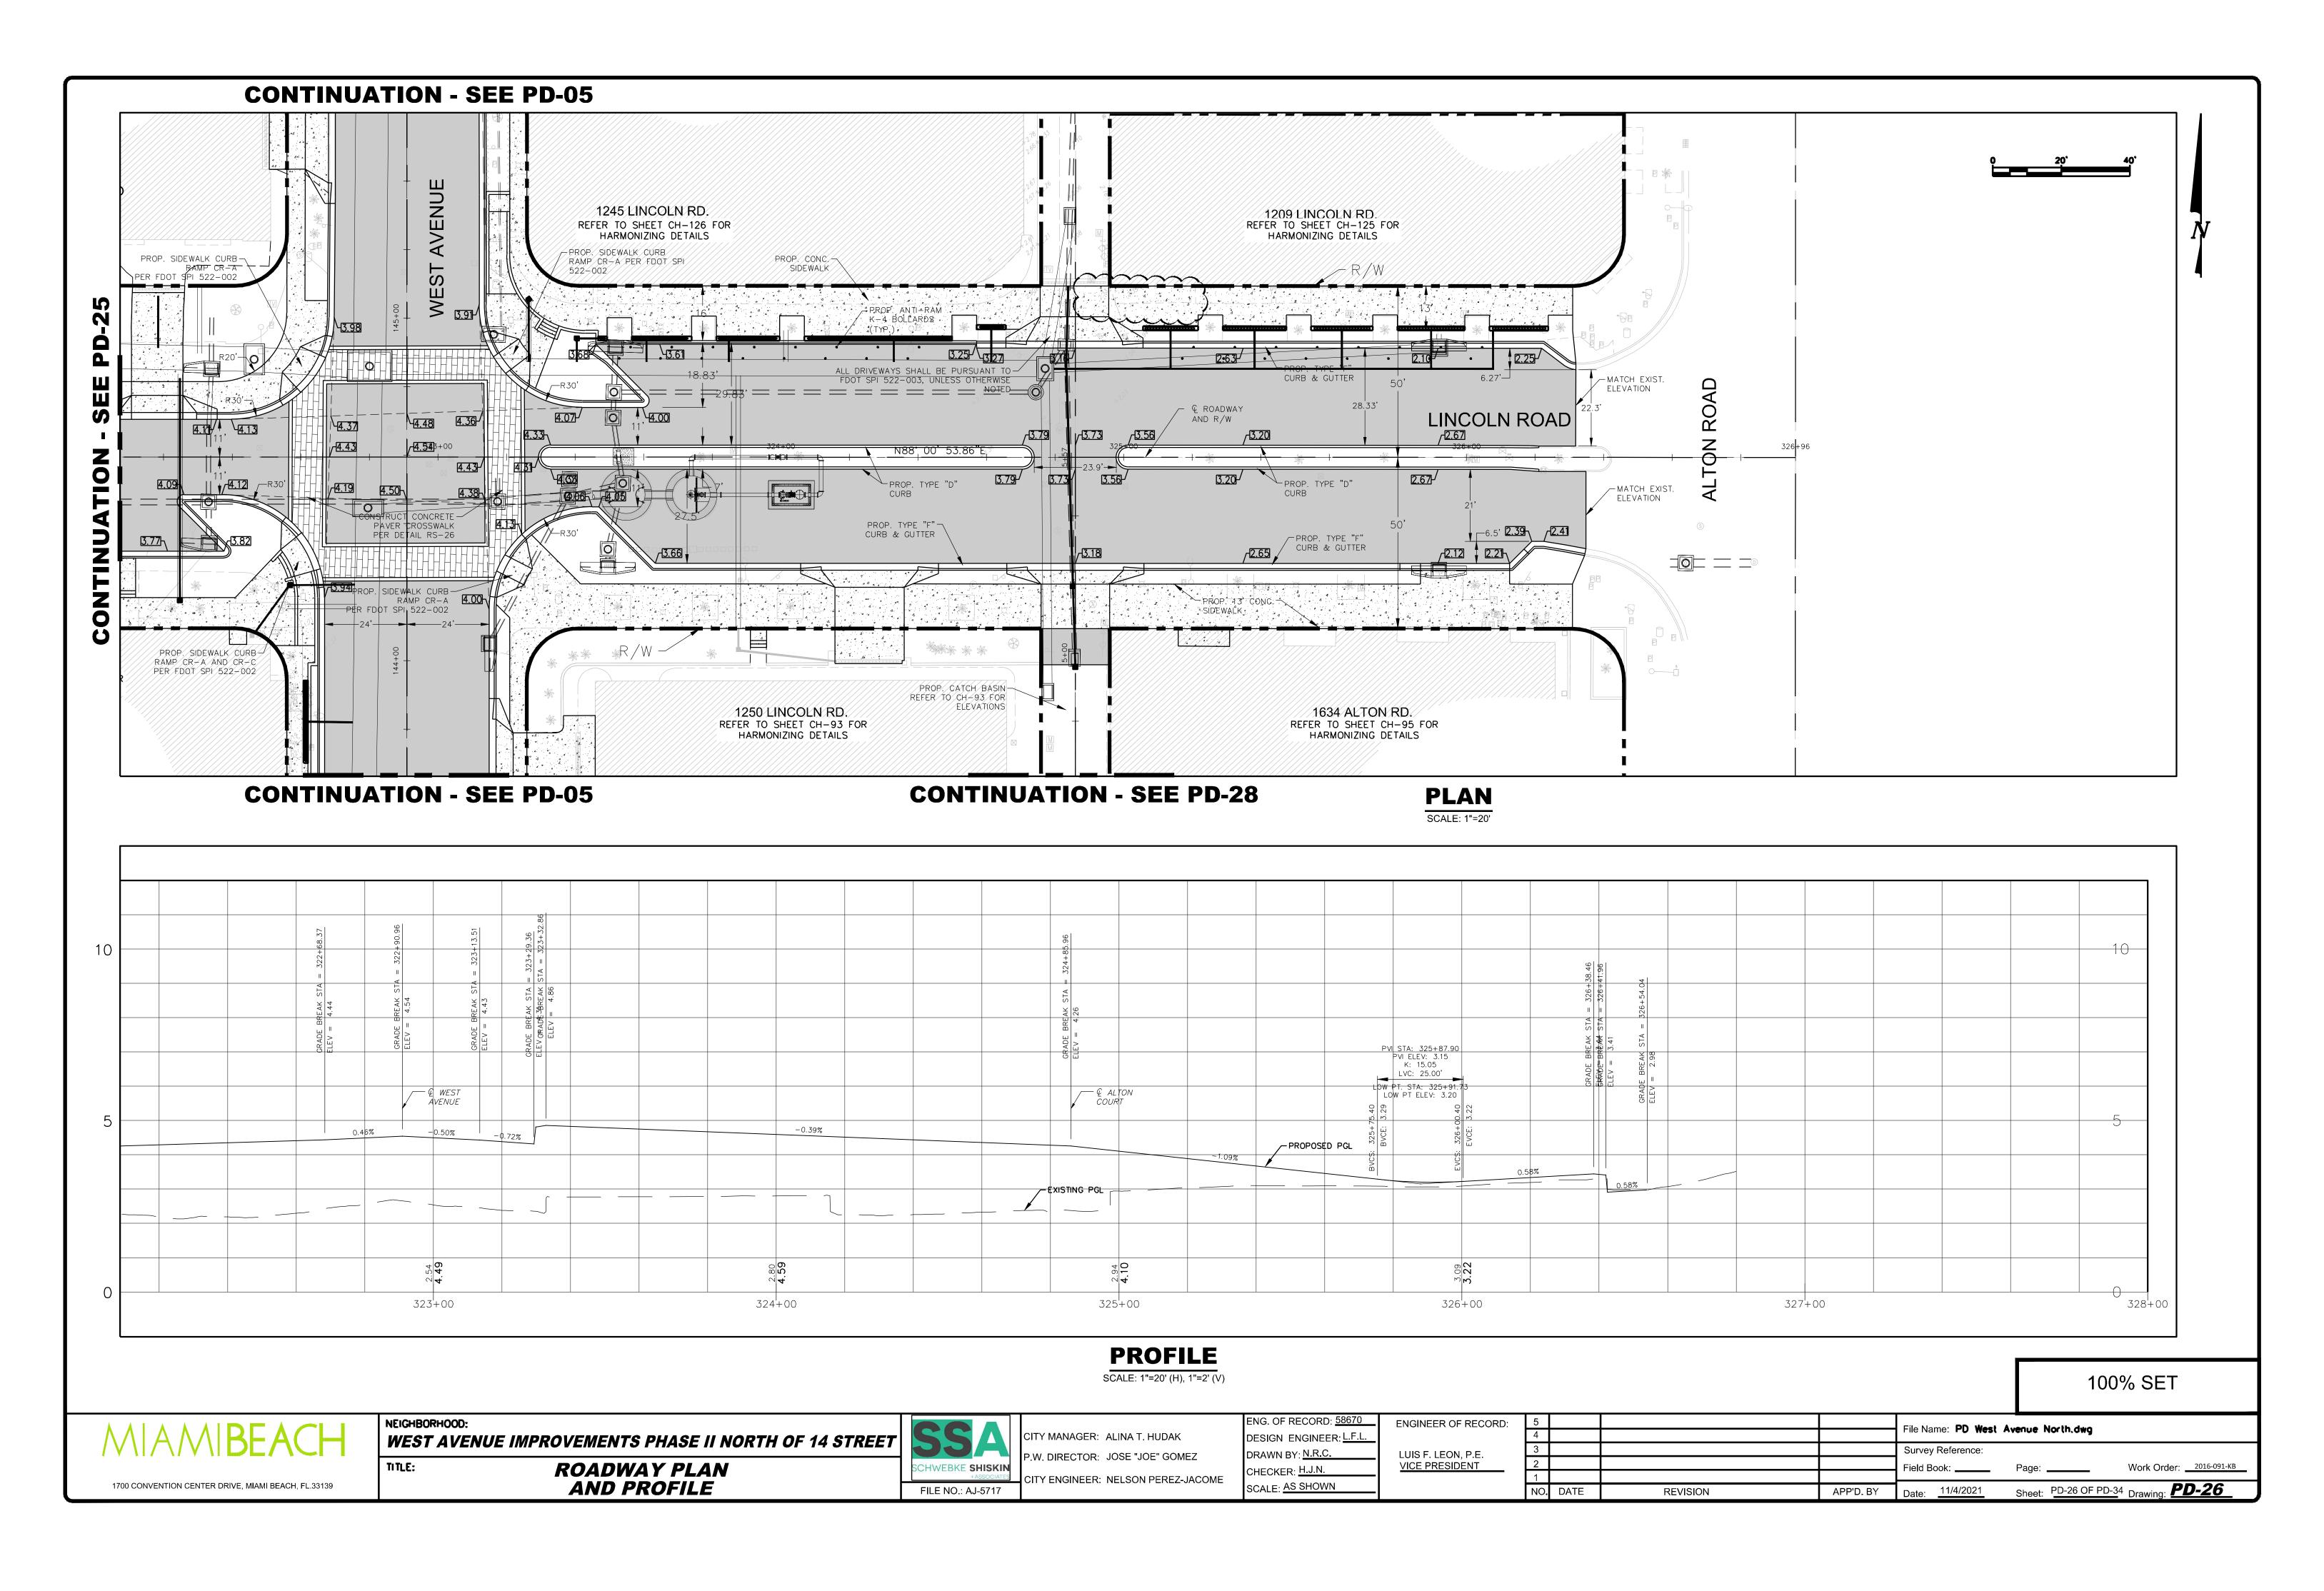


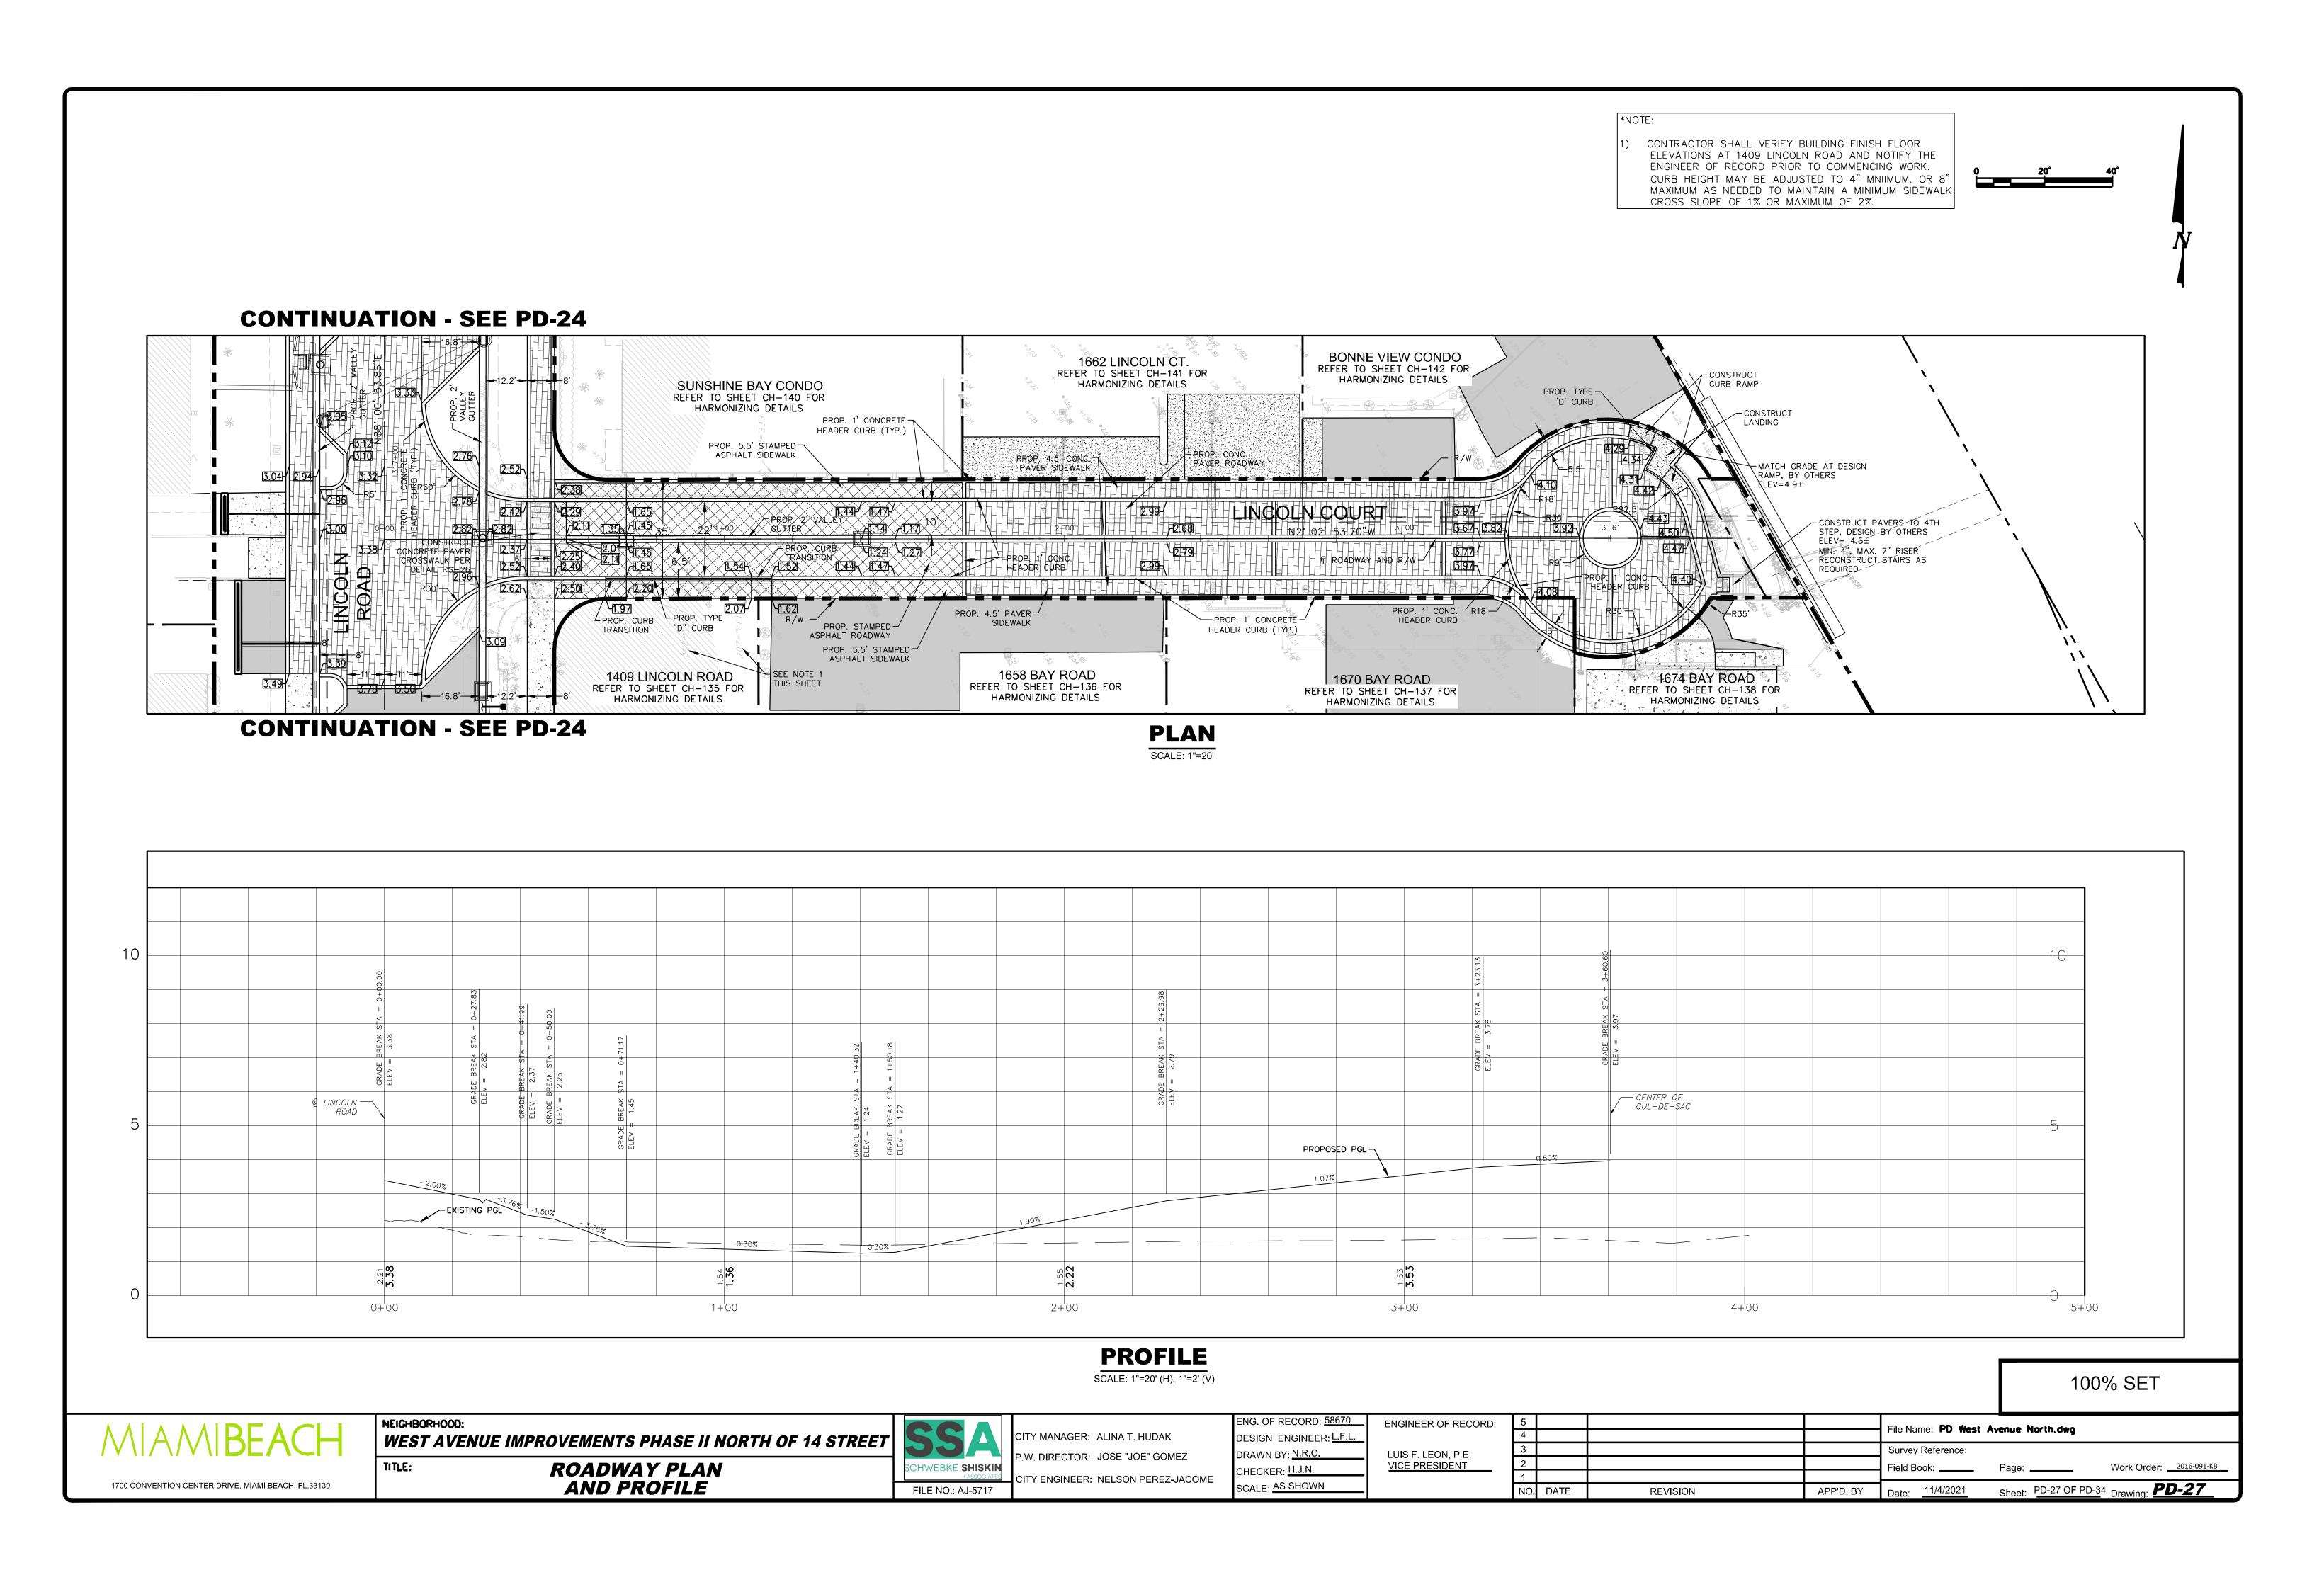


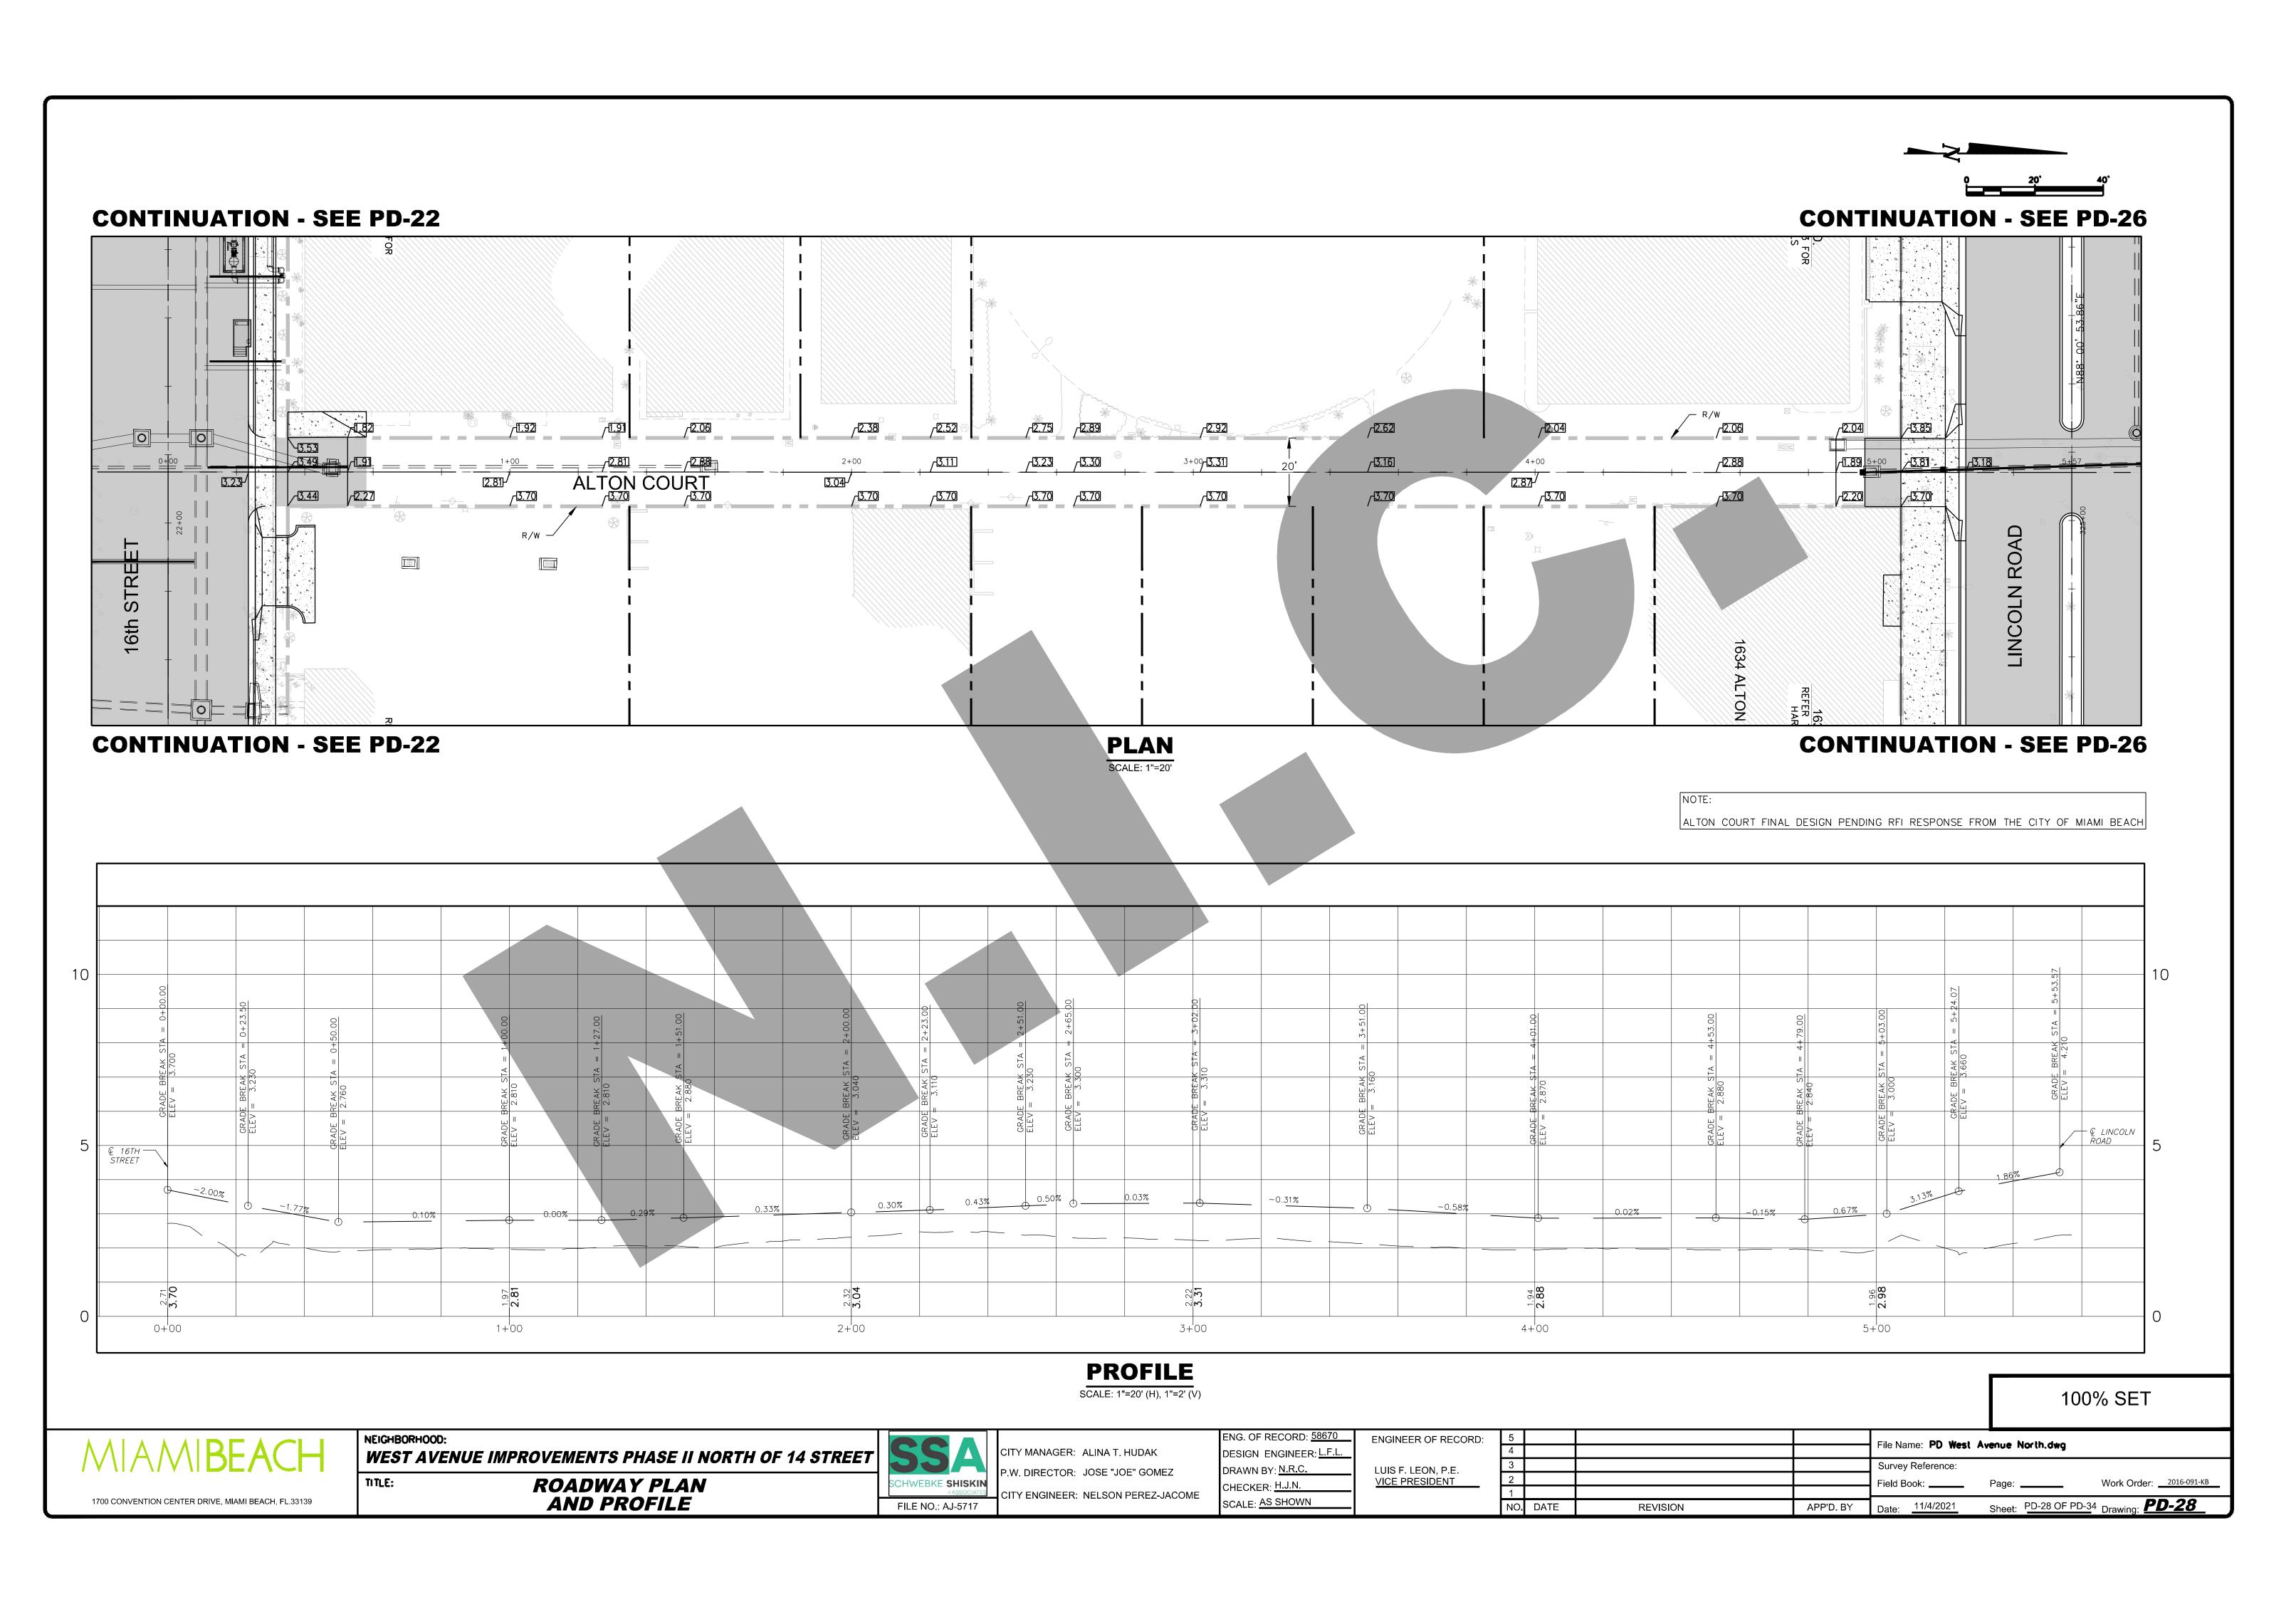


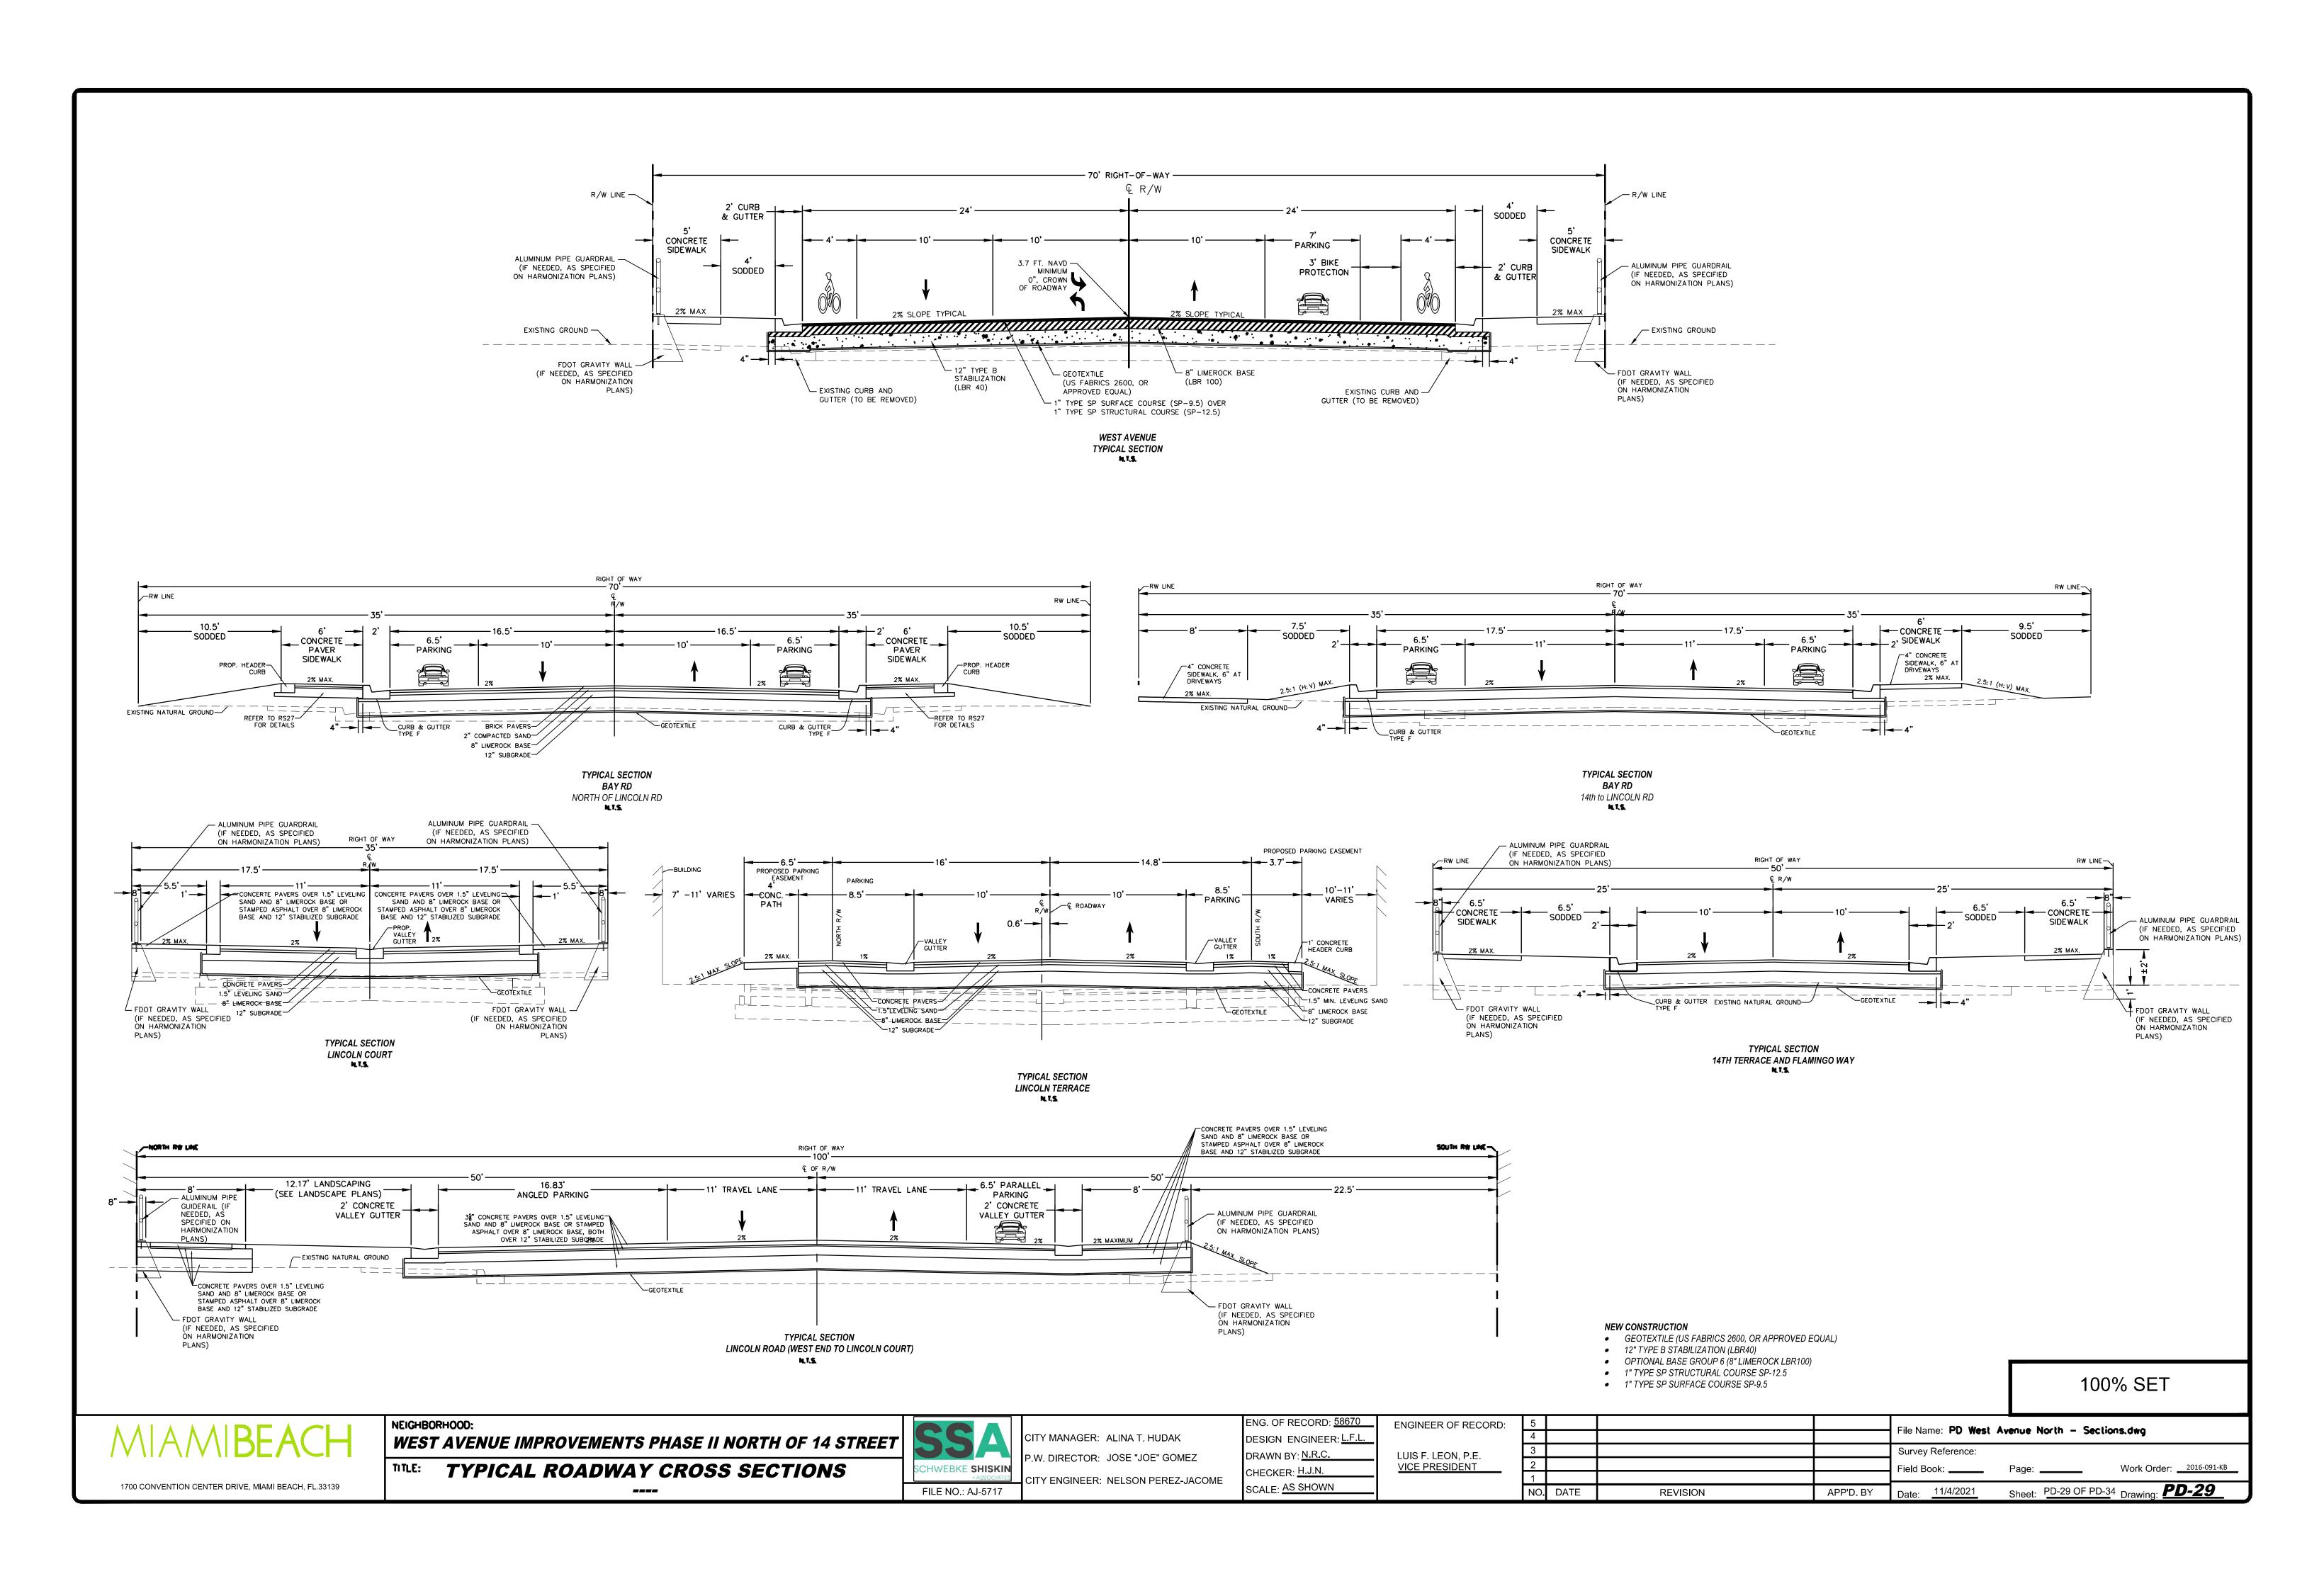

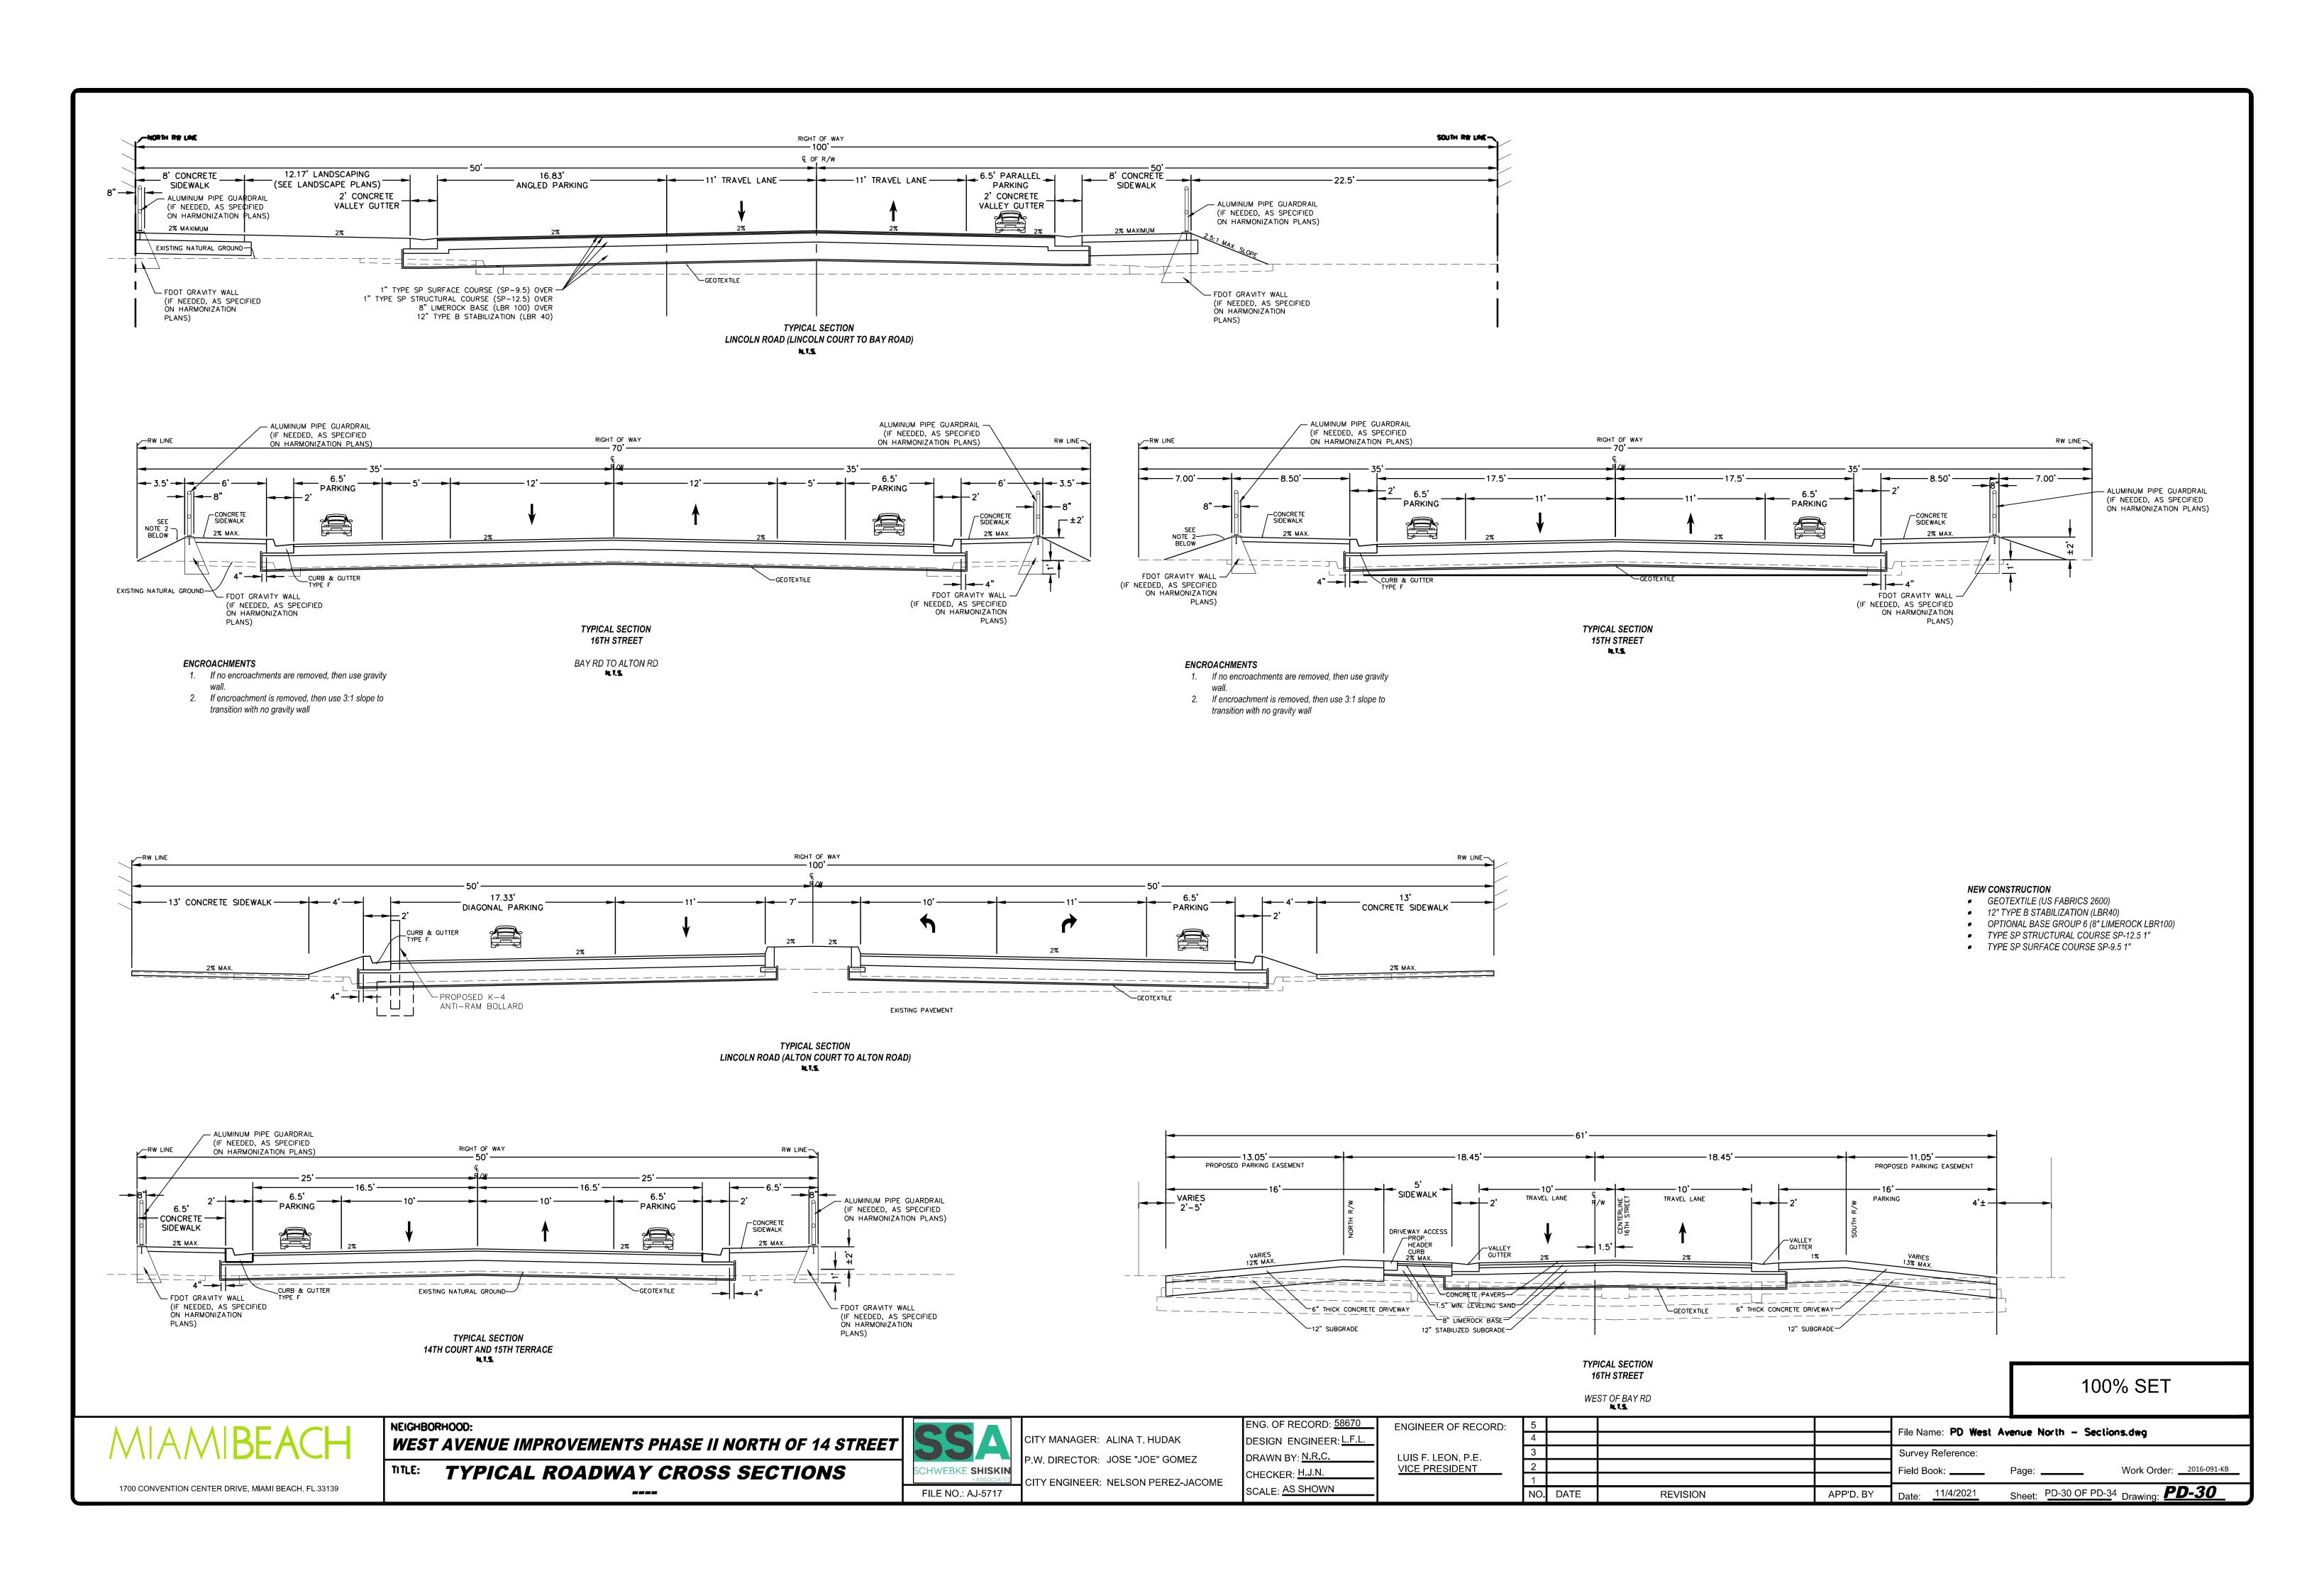


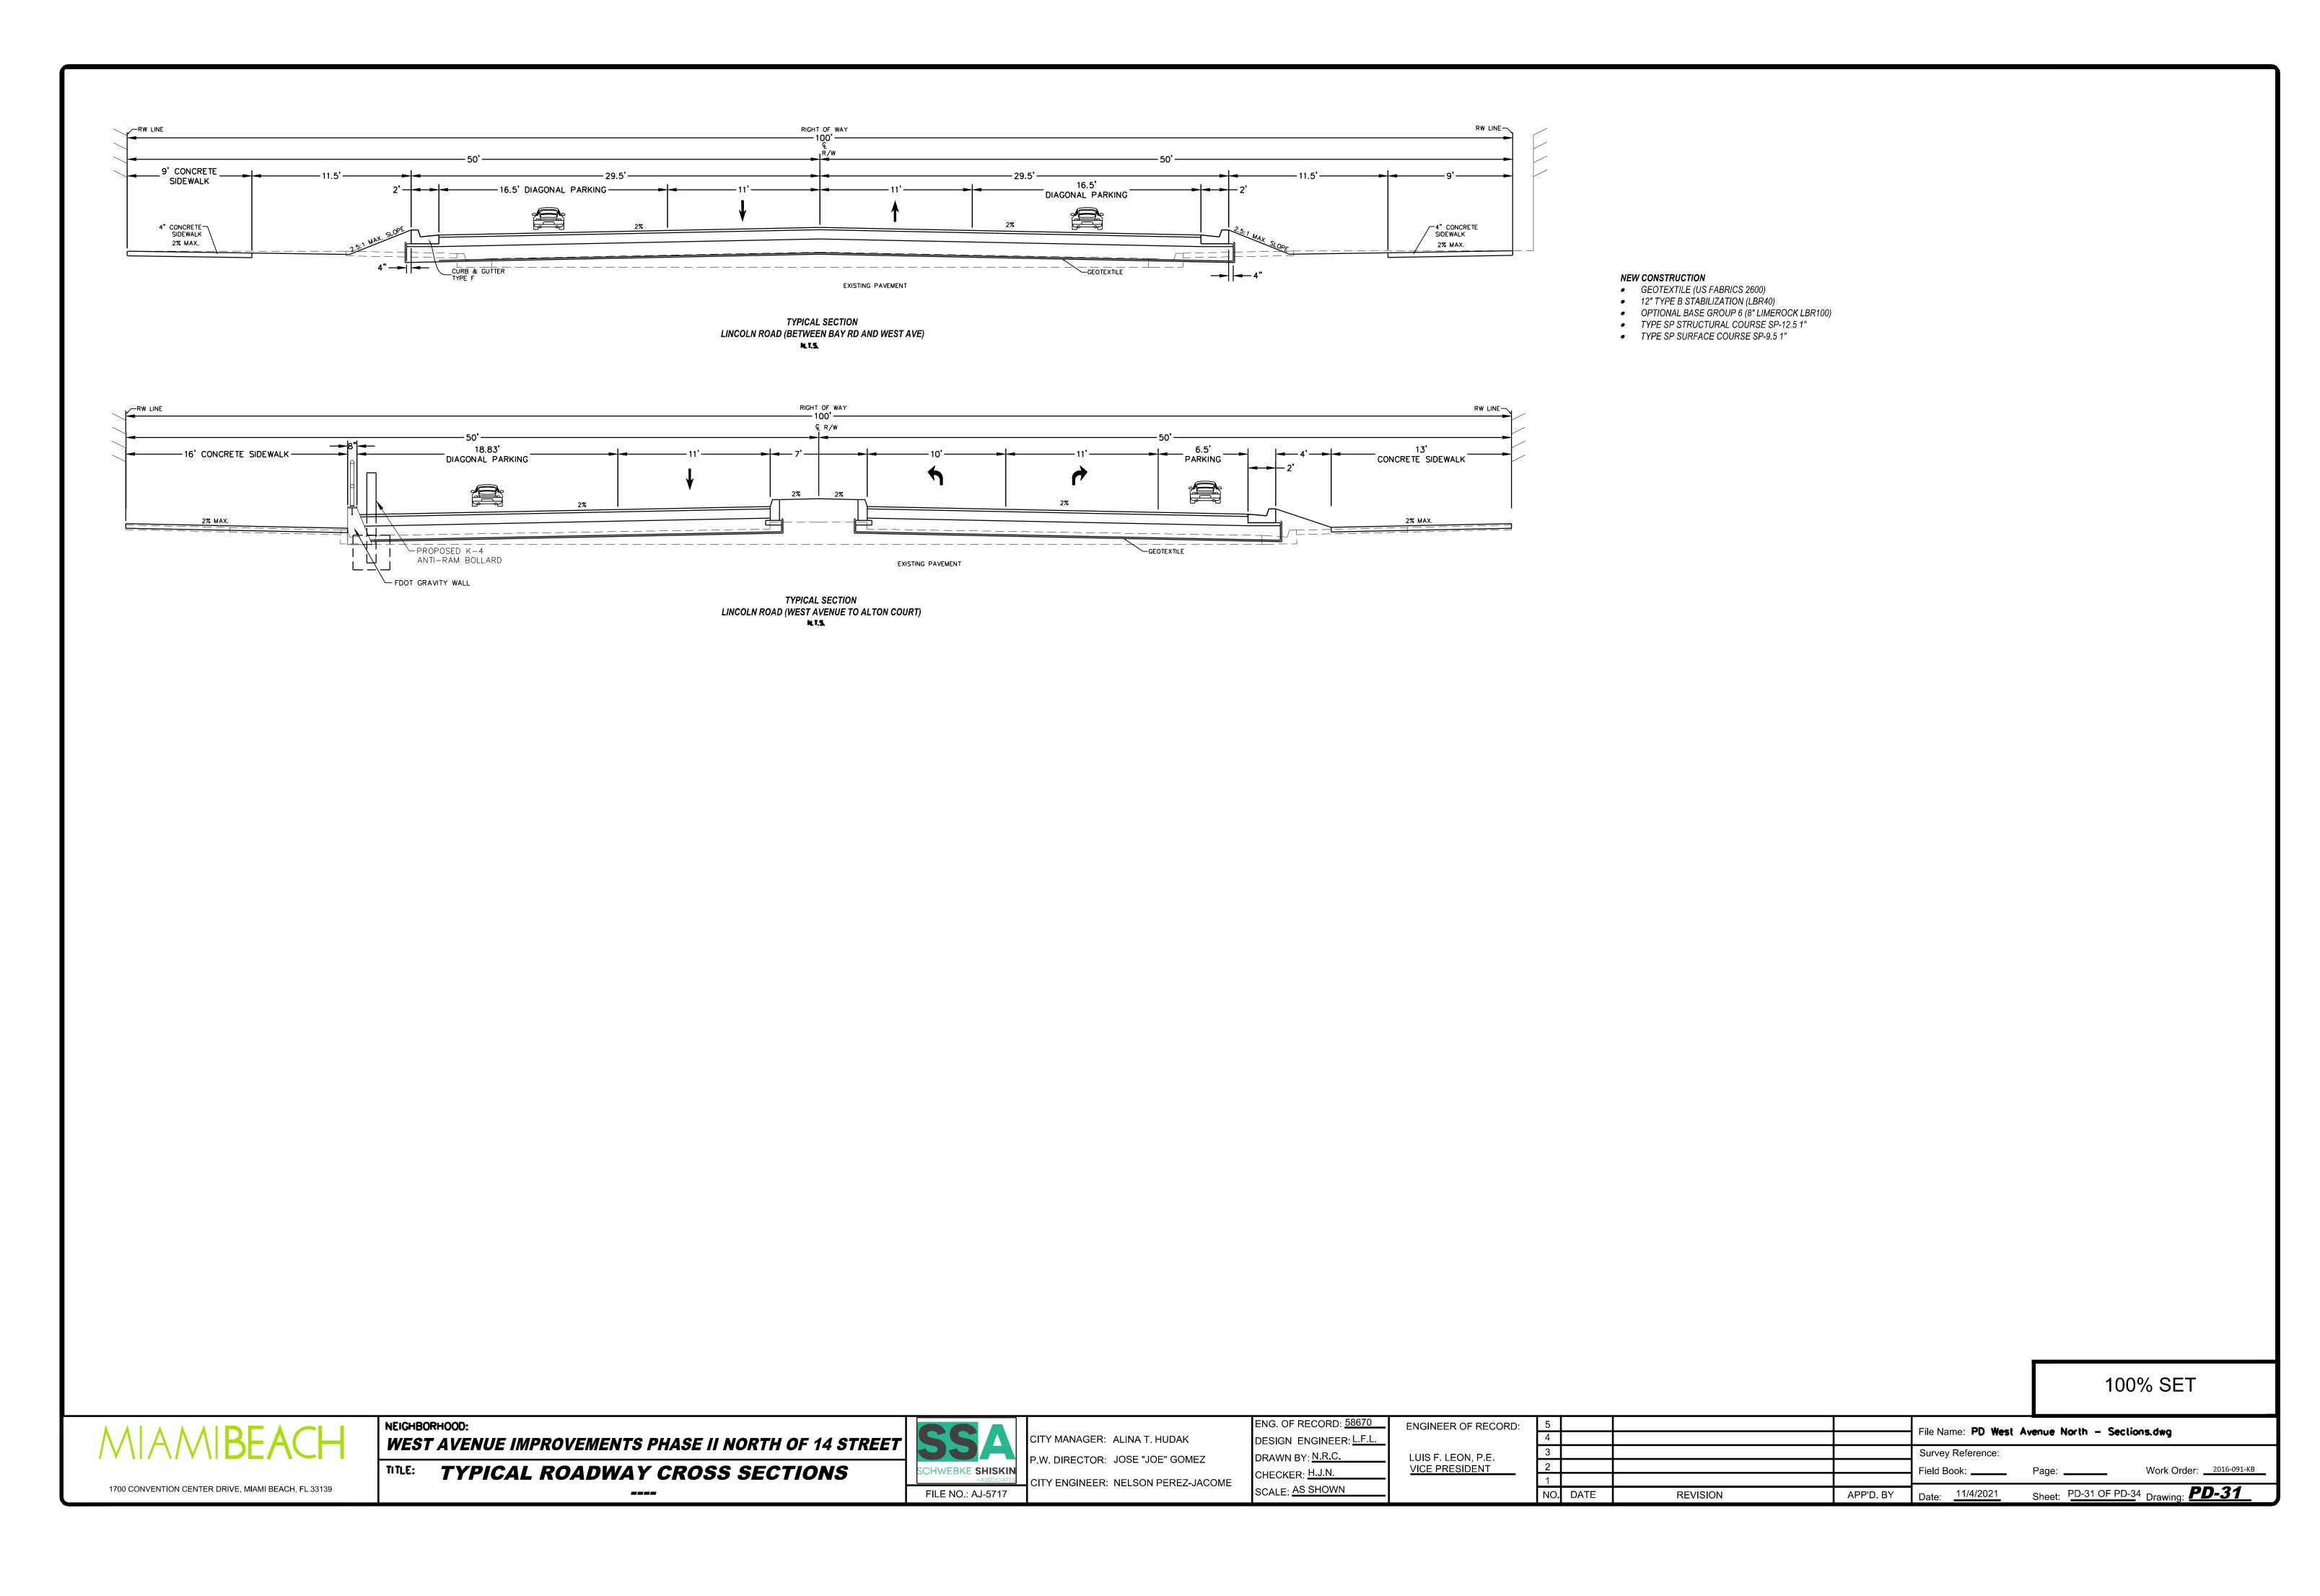


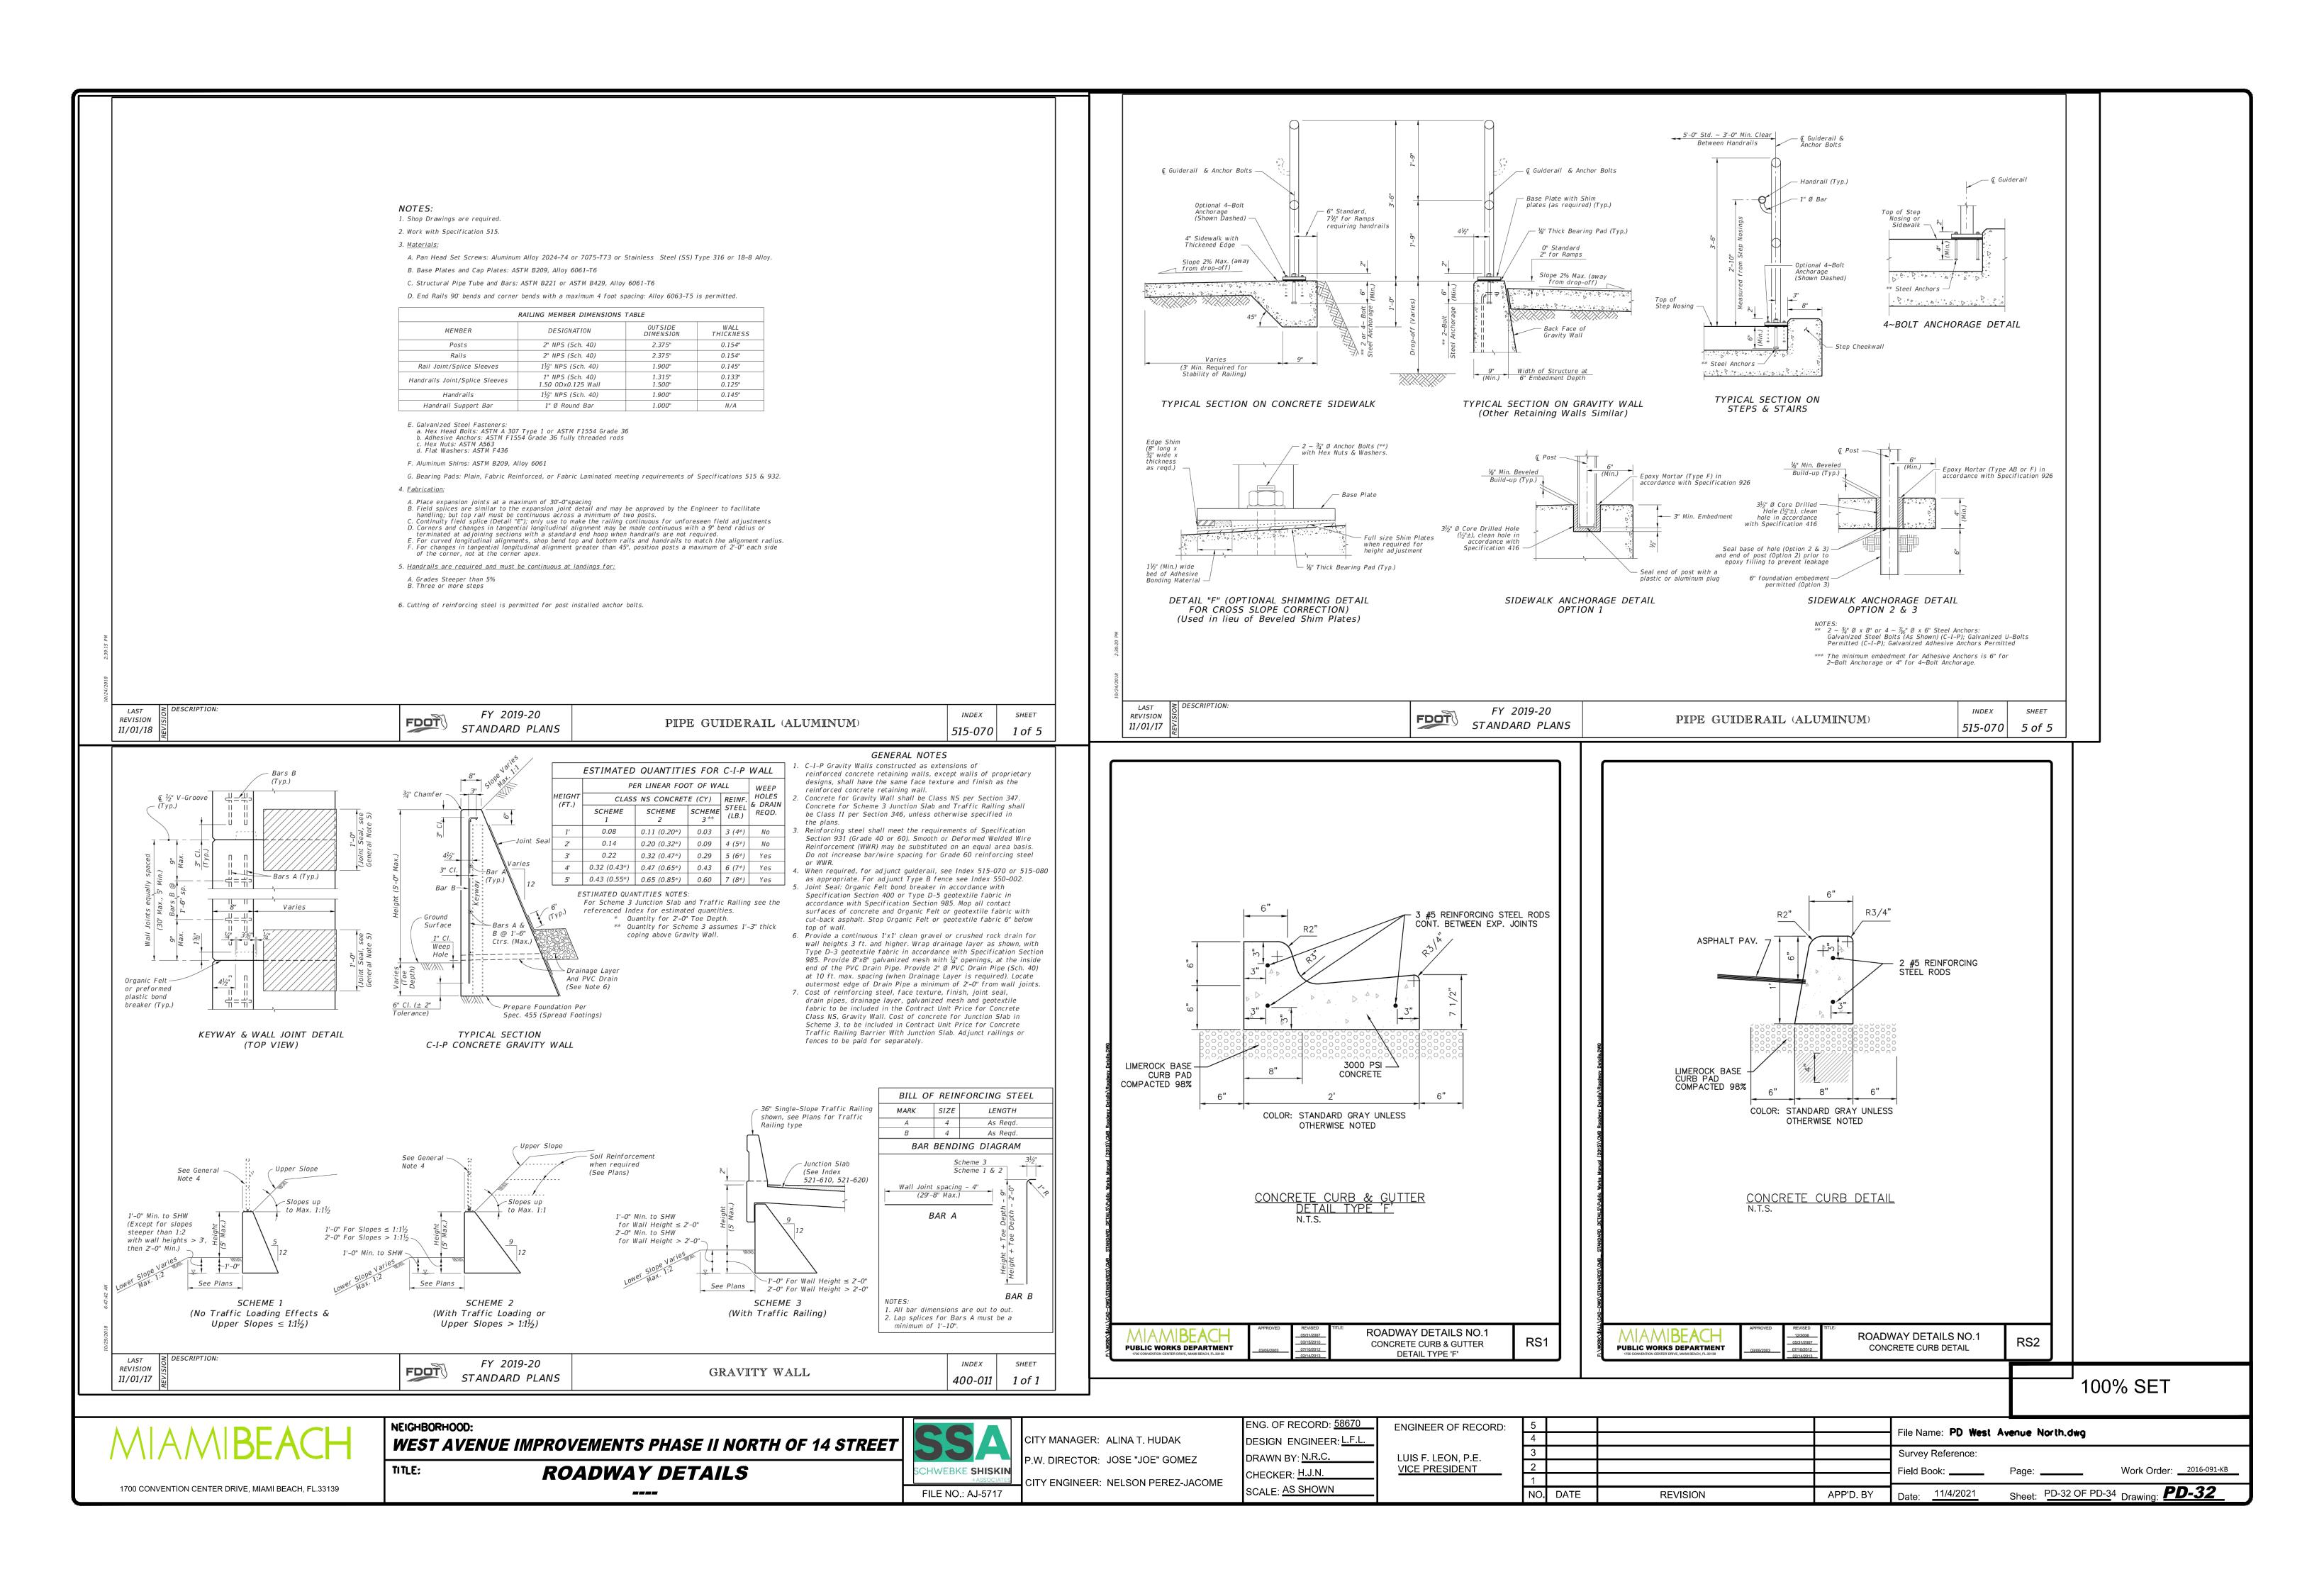

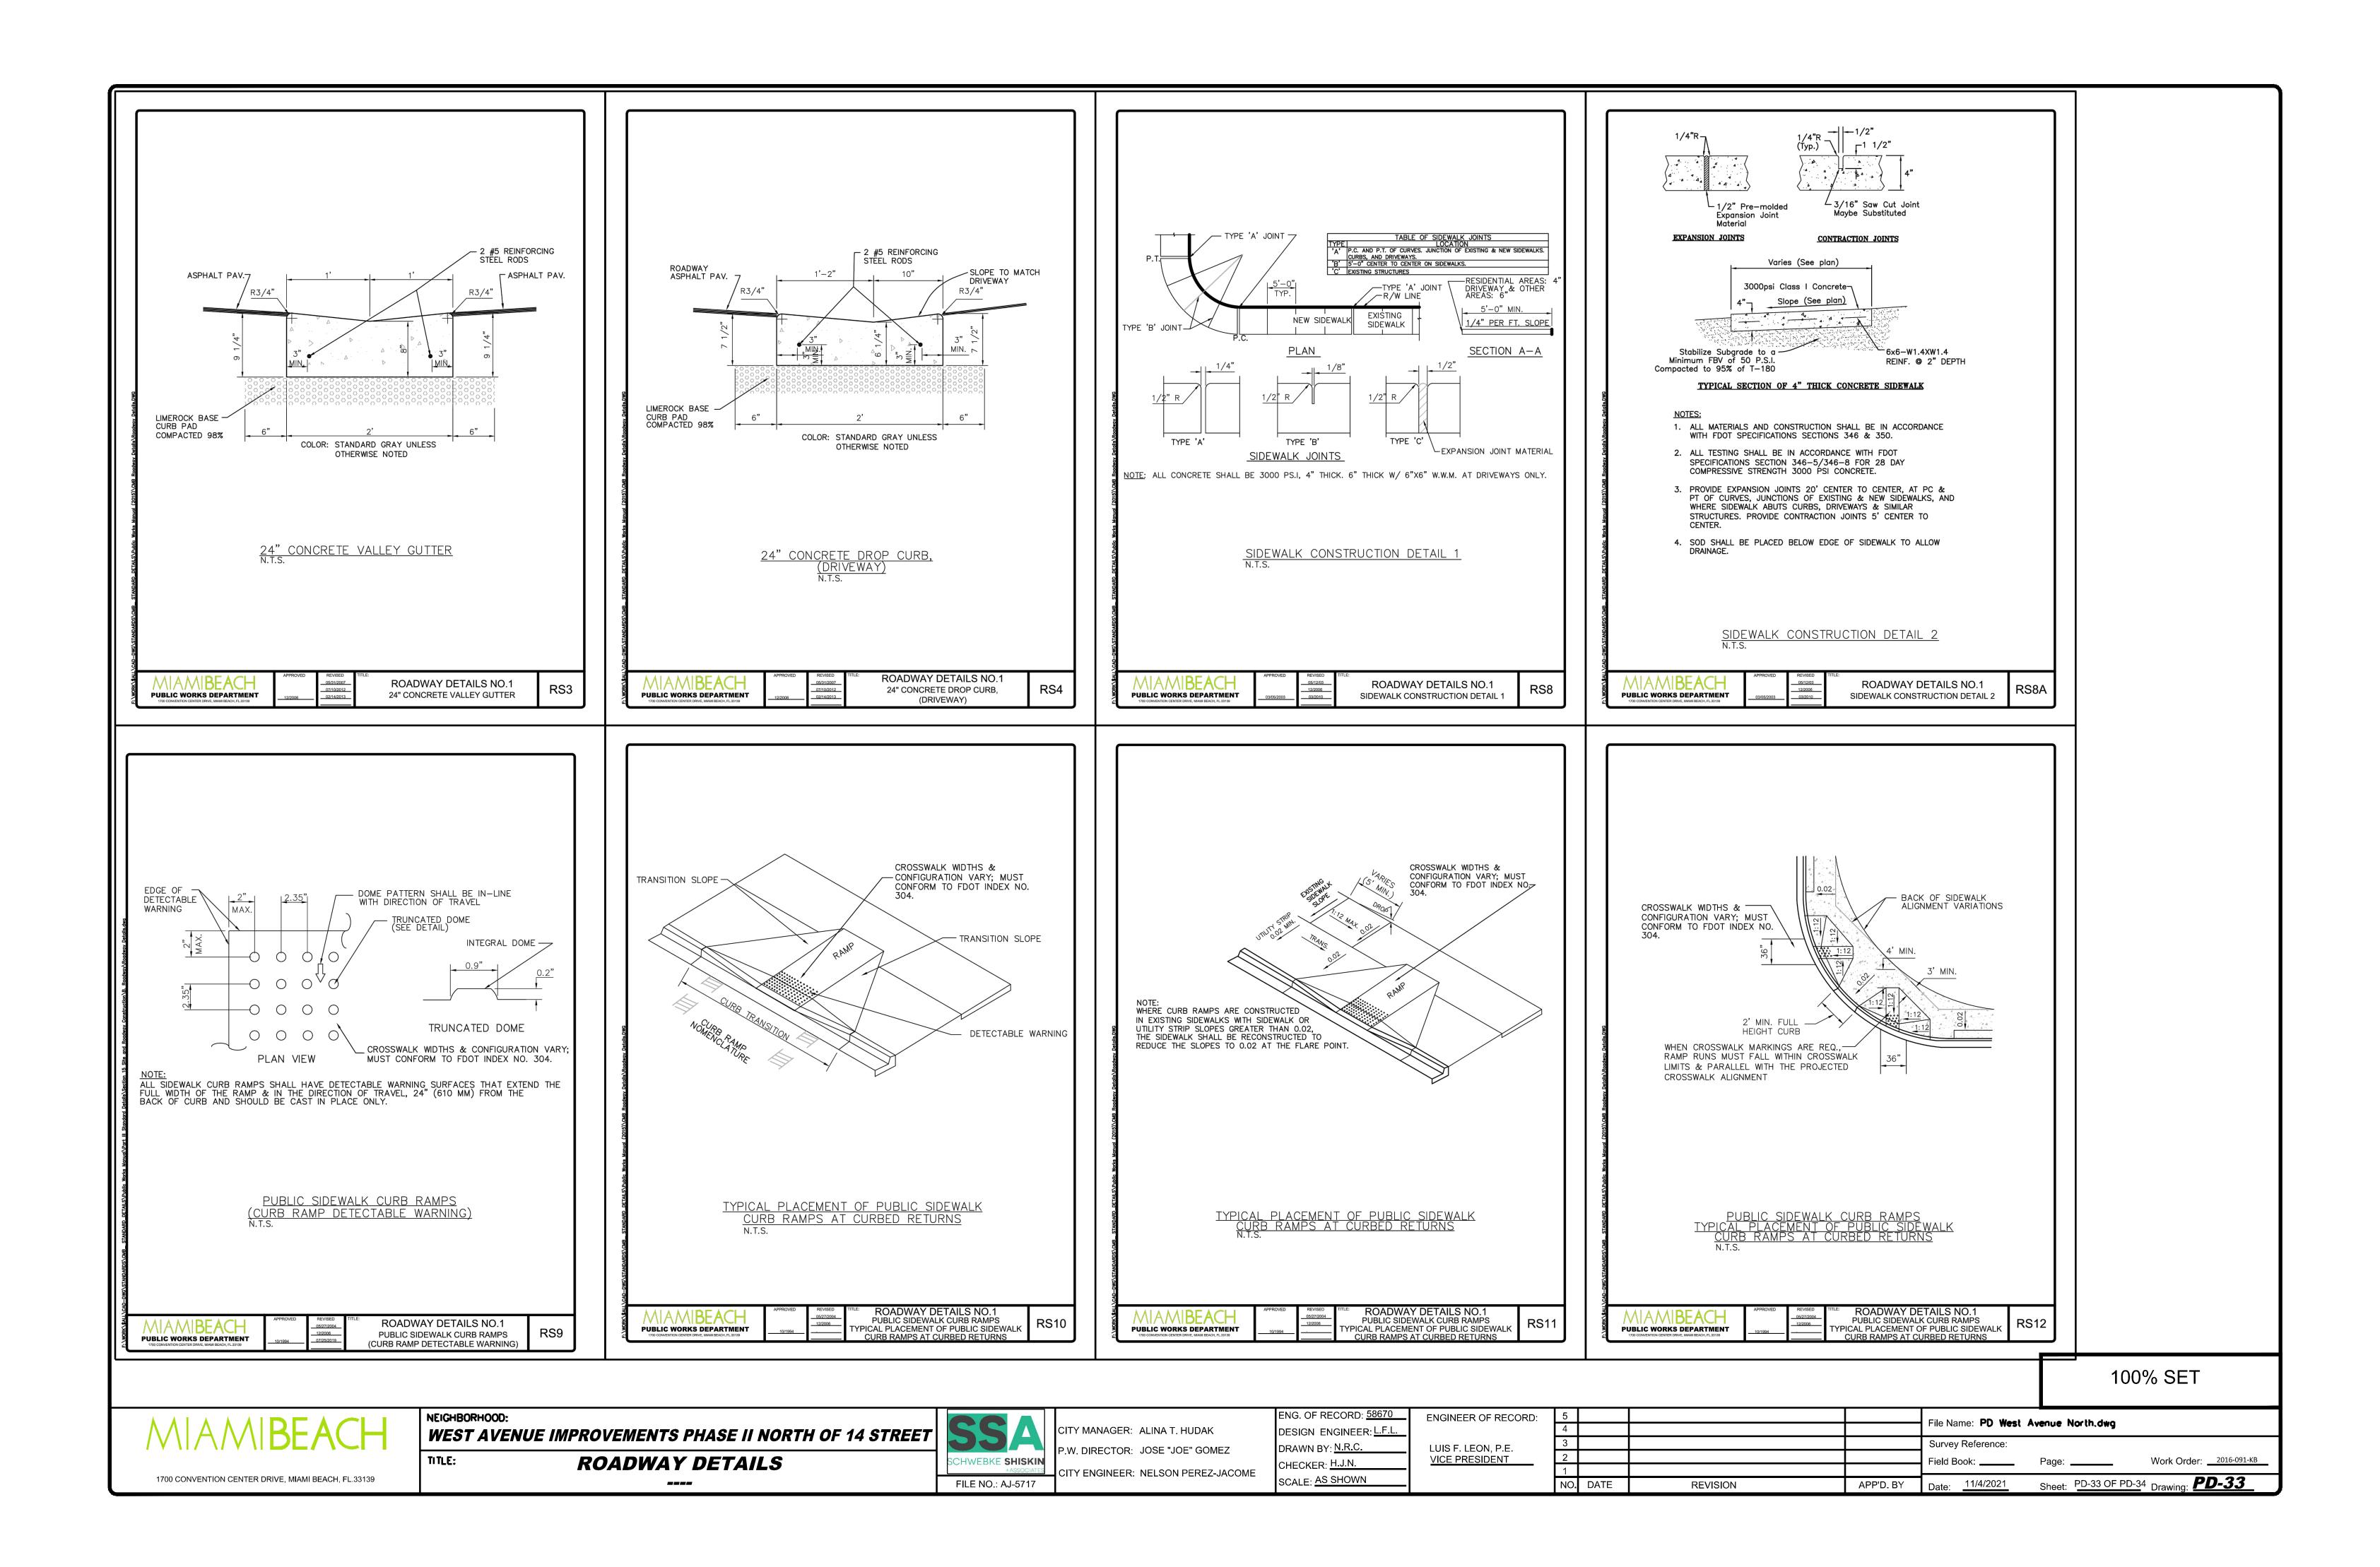



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## **GENERAL NOTES** PUBLIC SIDEWALK CURB RAMPS SHALL BE CONSTRUCTED IN THE PUBLIC RIGHT OF WAY AT LOCATIONS THAT WILL PROVIDE CONTINUOUS UNOBSTRUCTED PEDESTRIAN CIRCULATION PATHS TO PEDESTRIAN AREAS, ELEMENTS AND FACILITIES IN THE PUBLIC RIGHT OF WAY AND TO ACCESSIBLE PEDESTRIANS ROUTES ON ADJACENT SITES. CURBED FACILITIES WITH SIDEWALKS AND THOSE WITHOUT SIDEWALKS ARE TO HAVE CURB RAMPS CONSTRUCTED AT ALL STREET INTERSECTIONS AND AT TURNOUTS THAT HAVE CURBED RETURNS. PARTIAL CURB RETURNS SHALL EXTEND TO THE LIMIT PRESCRIBED BY INDEX NO. 515 TO ACCOMMODATE CURB RAMPS. RAMPS CONSTRUCTED AT LOCATIONS WITHOUT SIDEWALKS SHALL HAVE A LANDING CONSTRUCTED AT THE TOP OF EACH RAMP. CURB RAMP RUNNING SLOPES AT UNRESTRAINED SITES SHALL NOT BE STEEPER THAN 1:12 AND CROSS SLOPE SHALL BE 0.02 OR FLATTER. TRANSITION SLOPES SHALL NOT BE STEEPER THAN 1:12. WHEN ALTERING EXISTING PEDESTRIAN FACILITIES WHERE EXISTING SITE DEVELOPMENT PRECLUDES THE ACCOMMODATION OF A RAMP SLOPE OF 1:12, A RUNNING SLOPE BETWEEN 1:12 AND 1:10 IS PERMITTED FOR A RISE OF 6" MAXIMUM AND A RUNNING SLOPE OF BETWEEN 1:10 AND 1:8 IS PERMITTED FOR A RISE OF 3" MAXIMUM. WHERE COMPLIANCE WITH THE REQUIREMENTS FOR CROSS SLOPE CANNOT BE FULLY MET, THE MINIMUM FEASIBLE CROSS SLOPE SHALL BE PROVIDED. RAMP RUNNING SLOPE IS NOT REQUIRED TO EXCEED 8' IN LENGTH, EXCEPT AT SITES WHERE THE PLANS SPECIFY A GREATER LENGTH. IF A CURB RAMP IS LOCATED WHERE PEDESTRIANS MUST WALK ACROSS THE RAMP, THEN THE WALK SHALL HAVE TRANSITION SLOPES TO THE RAMP; THE MAXIMUM SLOPE OF THE TRANSITIONS SHALL BE 1:12. RAMPS WITH CURB RETURNS MAY BE USED AT LOCATIONS WHERE OTHER IMPROVEMENTS PROVIDE GUIDANCE AWAY FROM THAT PORTION OF THE CURB PERPENDICULAR TO THE SIDEWALK; IMPROVEMENTS FOR GUIDANCE ARE NOT REQUIRED AT CURB RAMPS FOR LINEAR PEDESTRIAN TRAFFIC. CURB RAMP DETECTABLE WARNING SURFACES SHALL EXTEND THE FULL WIDTH OF THE RAMP AND IN THE DIRECTION OF TRAVEL 24" FROM THE BACK OF CURB. DETECTABLE WARNING SURFACES SHALL BE CONSTRUCTED BY TEXTURING A TRUNCATED DOME PATTERN IN CONFORMANCE WITH U.S. DEPARTMENT OF JUSTICE A.D.A. STANDARDS FOR ACCESSIBLE DESIGN, A.D.A. ACCESSIBILITY GUIDELINES, SECTION 4.29.2, (DETAIL SHOWN TO THE LEFT). TRANSITION SLOPES ARE NOT TO HAVE DETECTABLE WARNINGS. WHERE A CURB RAMP IS CONSTRUCTED WITHIN EXISTING CURB, CURB AND GUTTER AND / OR SIDEWALK THE EXISTING CURB OR CURB AND GUTTER SHALL BE REMOVED TO THE NEAREST JOINT BEYOND THE CURB TRANSITIONS OR TO THE EXTENT THAT NO REMAINING SECTION OF THE CURB OR CURB AND GUTTER IS LESS THAN 5' LONG. THE EXISTING SIDEWALK SHALL BE REMOVED TO THE NEAREST JOINT BEYOND THE TRANSITION SLOPE OR WALK AROUND OR TO THE EXTENT THAT NO REMAINING SECTION OF SIDEWALK IS LESS THAN 5' LONG. THE RAMP DETECTABLE WARNING SURFACE COLOR REQUIREMENT SHALL BE TO PROVIDE A DARK-ON-LIGHT VISUAL CONTRAST BETWEEN THE DETECTABLE WARNING SURFACE AND THE ADJACENT WALKING SURFACE. WHERE ADJACENT WALKING SURFACES ARE COLORED OR ARE CONSTRUCTED WITH MATERIALS OTHER THAN STANDARD CLASS I PORTLAND CEMENT CONCRETE IN ACCORDANCE WITH SECTION 522 OF THE STANDARD SPECIFICATIONS, THE PLANS MUST PROVIDE FOR DETECTABLE WARNING SURFACE COLORS OR MATERIALS THAT PROVIDE THE NECESSARY CONTRAST, EITHER DARK-ON-LIGHT OR LIGHT-ON-DARK. PUBLIC SIDEWALK CURB RAMPS (GENERAL AND DESIGN NOTES) **ROADWAY DETAILS NO.2** PUBLIC SIDEWALK CURB RAMPS **PUBLIC WORKS DEPARTMENT** (GENERAL AND DESIGN NOTES)

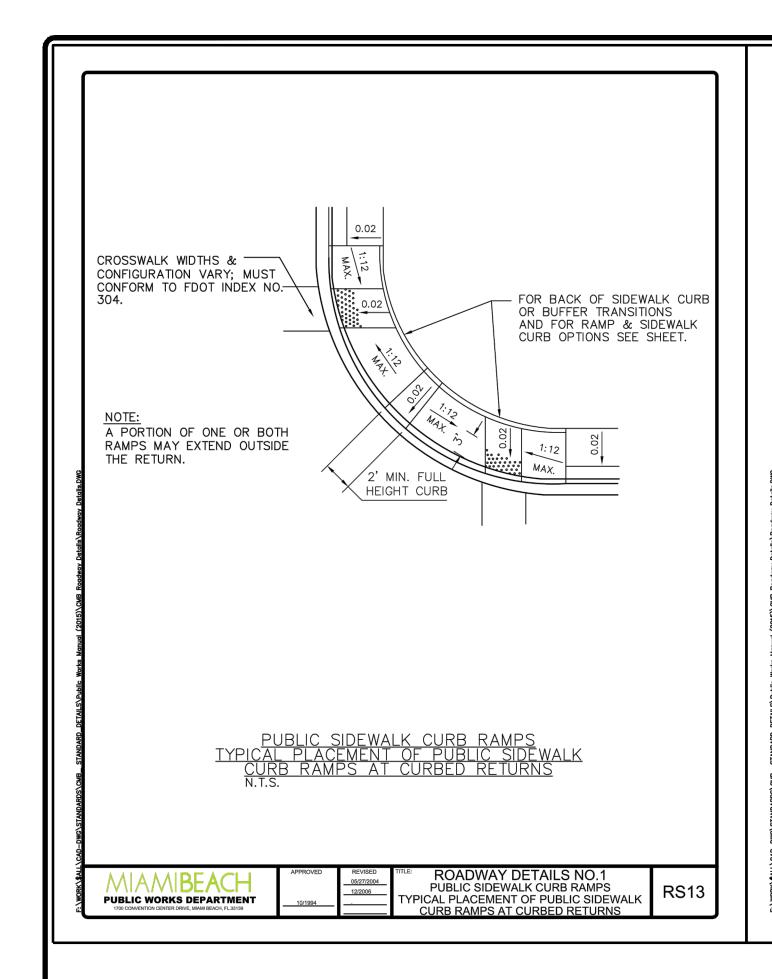

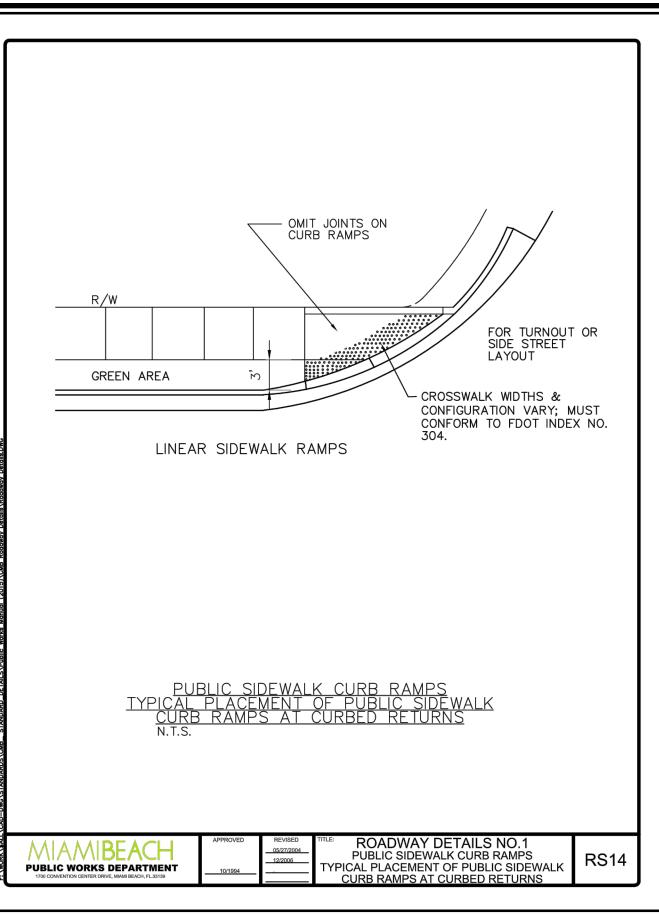

100% SET

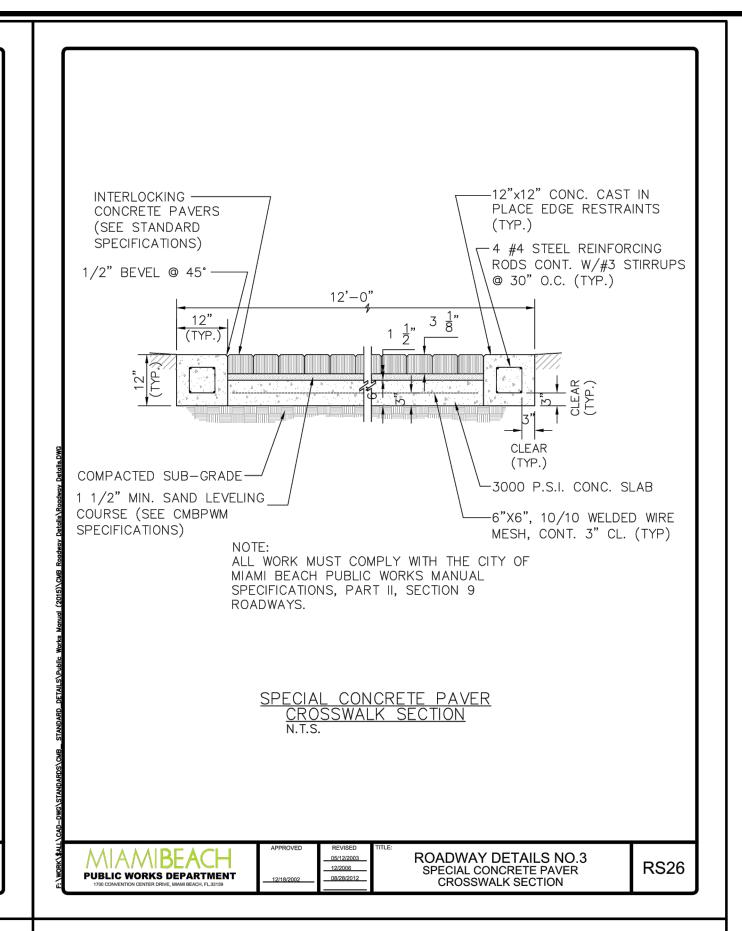Work Order: 2016-091-KB

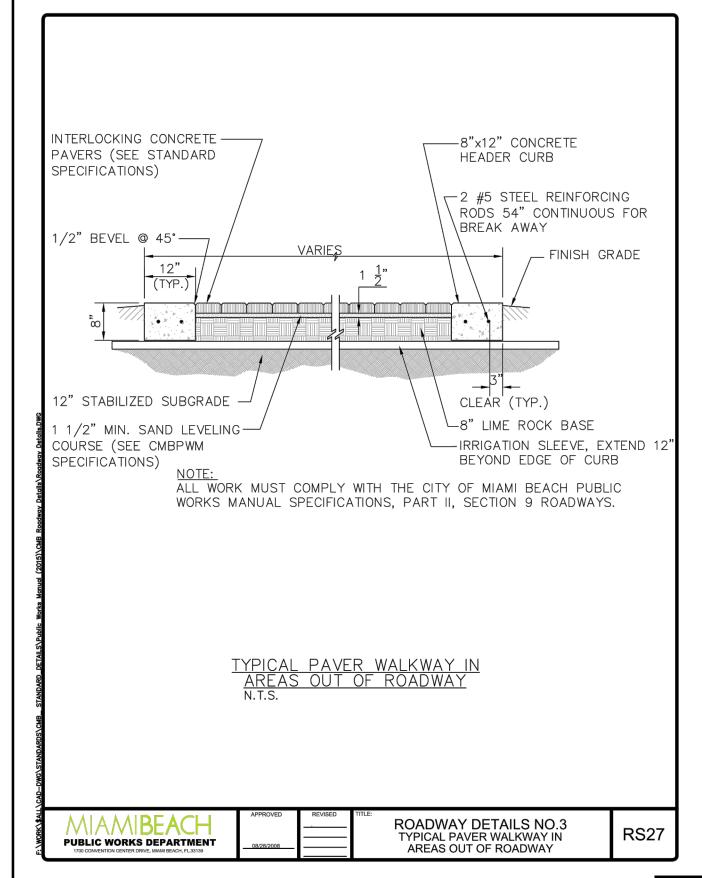1700 CONVENTION CENTER DRIVE, MIAMI BEACH, FL.33139

**NEIGHBORHOOD:** 

WEST AVENUE IMPROVEMENTS PHASE II NORTH OF 14 STREET

TITLE:

ROADWAY DETAILS



CITY MANAGER: ALINA T. HUDAK P.W. DIRECTOR: JOSE "JOE" GOMEZ CITY ENGINEER: NELSON PEREZ-JACOME

ENG. OF RECORD: <u>58670</u> ENGINEER OF RECORD: DESIGN ENGINEER: L.F.L. DRAWN BY: N.R.C. CHECKER: H.J.N. SCALE: AS SHOWN

LUIS F. LEON, P.E. VICE PRESIDENT

File Name: **PD West Avenue North.dwg** Survey Reference: Sheet: PD-34 OF PD-34 Drawing: **PD-34** NO. DATE REVISION APP'D. BY