


DRB FINAL SUBMITTAL

NE ISLAND PARK, MIAMI BEACH, FLORIDA


PVISIONS: 3 First Submittal RB First Submittal B Final Submittal RB Final Submittal	Date: 11.05.2021 11.15.2021 11.29.2021 12.06.2021	By: EWS EWS EWS
<u> </u>		

Seal:	
Seal.	
Lic. # LA0000889	
Member: A.S.L.A.	

Drawing: GROUND LEVEL LANDSCAPE PLAN  Date: 11/05/2021  Scale: See Left  Drawn by: EWS  Sheet No.:  Cad Id.: 2020-020	L	
I ANDSCAPE PLAN	-	
Date: 11/05/2021  Scale: See Left  Drawn by: EWS  Sheet No.:	202.1	
Scale: See Left  Drawn by: EWS  Sheet No.:	wg Dec 06, 2	Date: 11/05/2021
Drawn by: EWS  Sheet No.:	ITTAL\L-1.dv	Scale: See Left
Sheet No.:	4 PB SUBM	Drawn by: EWS
Cad Id : 2020-0200	ta/2021.11.2	Sheet No.:
	Island 2020-20\Site Plan Submitt	Cad ld : 2020-020

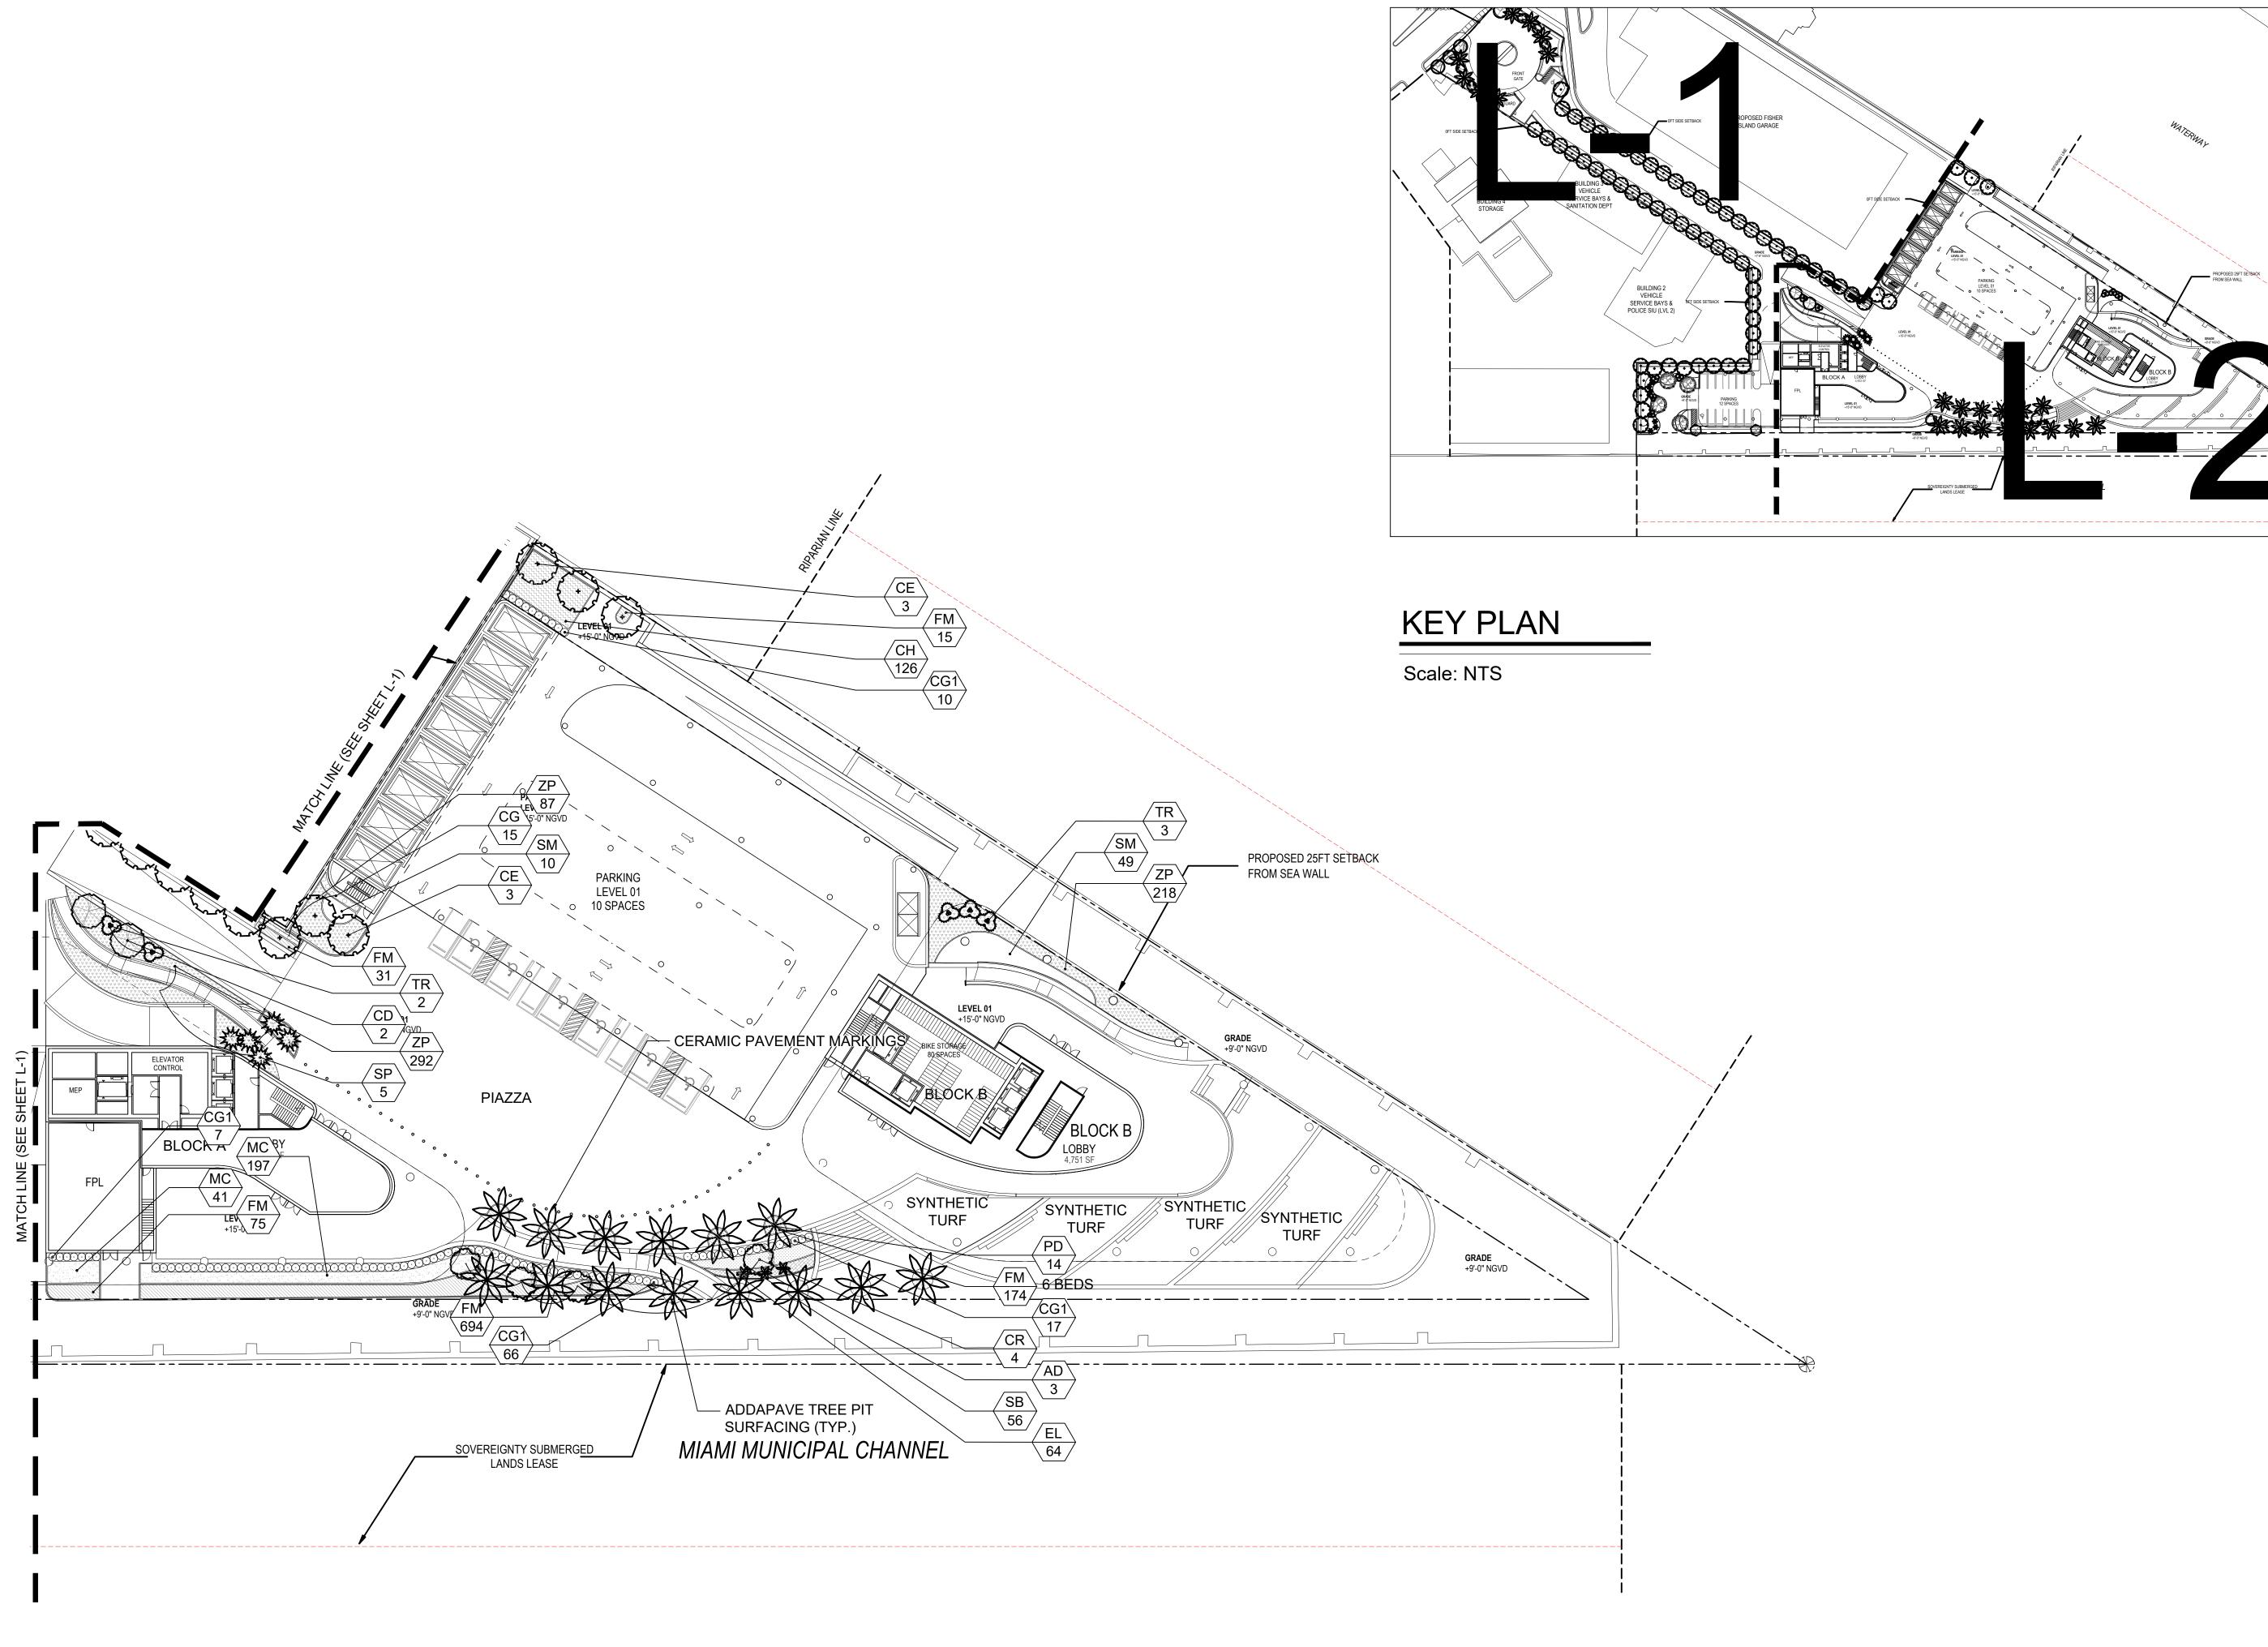



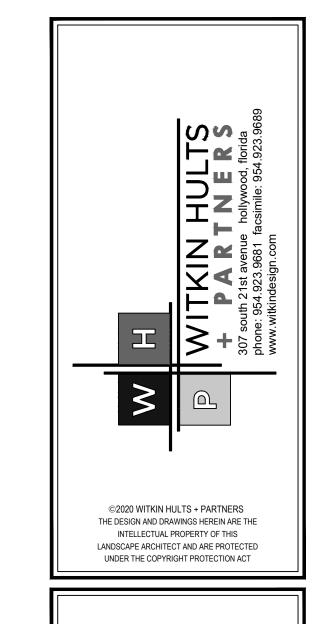


DRB FINAL SUBMITTAL


ONE ISLAND PARK, MIAMI BEACH, FLORIDA

Revisions:  1)PB First Submittal 2) DRB First Submittal 3) PB Final Submittal 3) DRB Final Submittal 11.29.2021 EWS 11.29.2021 EWS 12.06.2021 EWS	<u> </u>		
1)PB First Submittal       11.05.2021       EWS         2) DRB First Submittal       11.15.2021       EWS         3) PB Final Submittal       11.29.2021       EWS			
	1)PB First Submittal 2) DRB First Submittal 3) PB Final Submittal	11.05.2021 11.15.2021 11.29.2021	EWS EWS

Seal:	
Lic. # LA0000889 Member: A.S.L.A.	

Drawing:	GROUND LEVEL LANDSCAPE PLAN
Date: 11/	05/2021
Scale: Se	ee Left
Drawn by	: EWS
Sheet No	.:
	L-2
Cad Id.: 2	2020-020

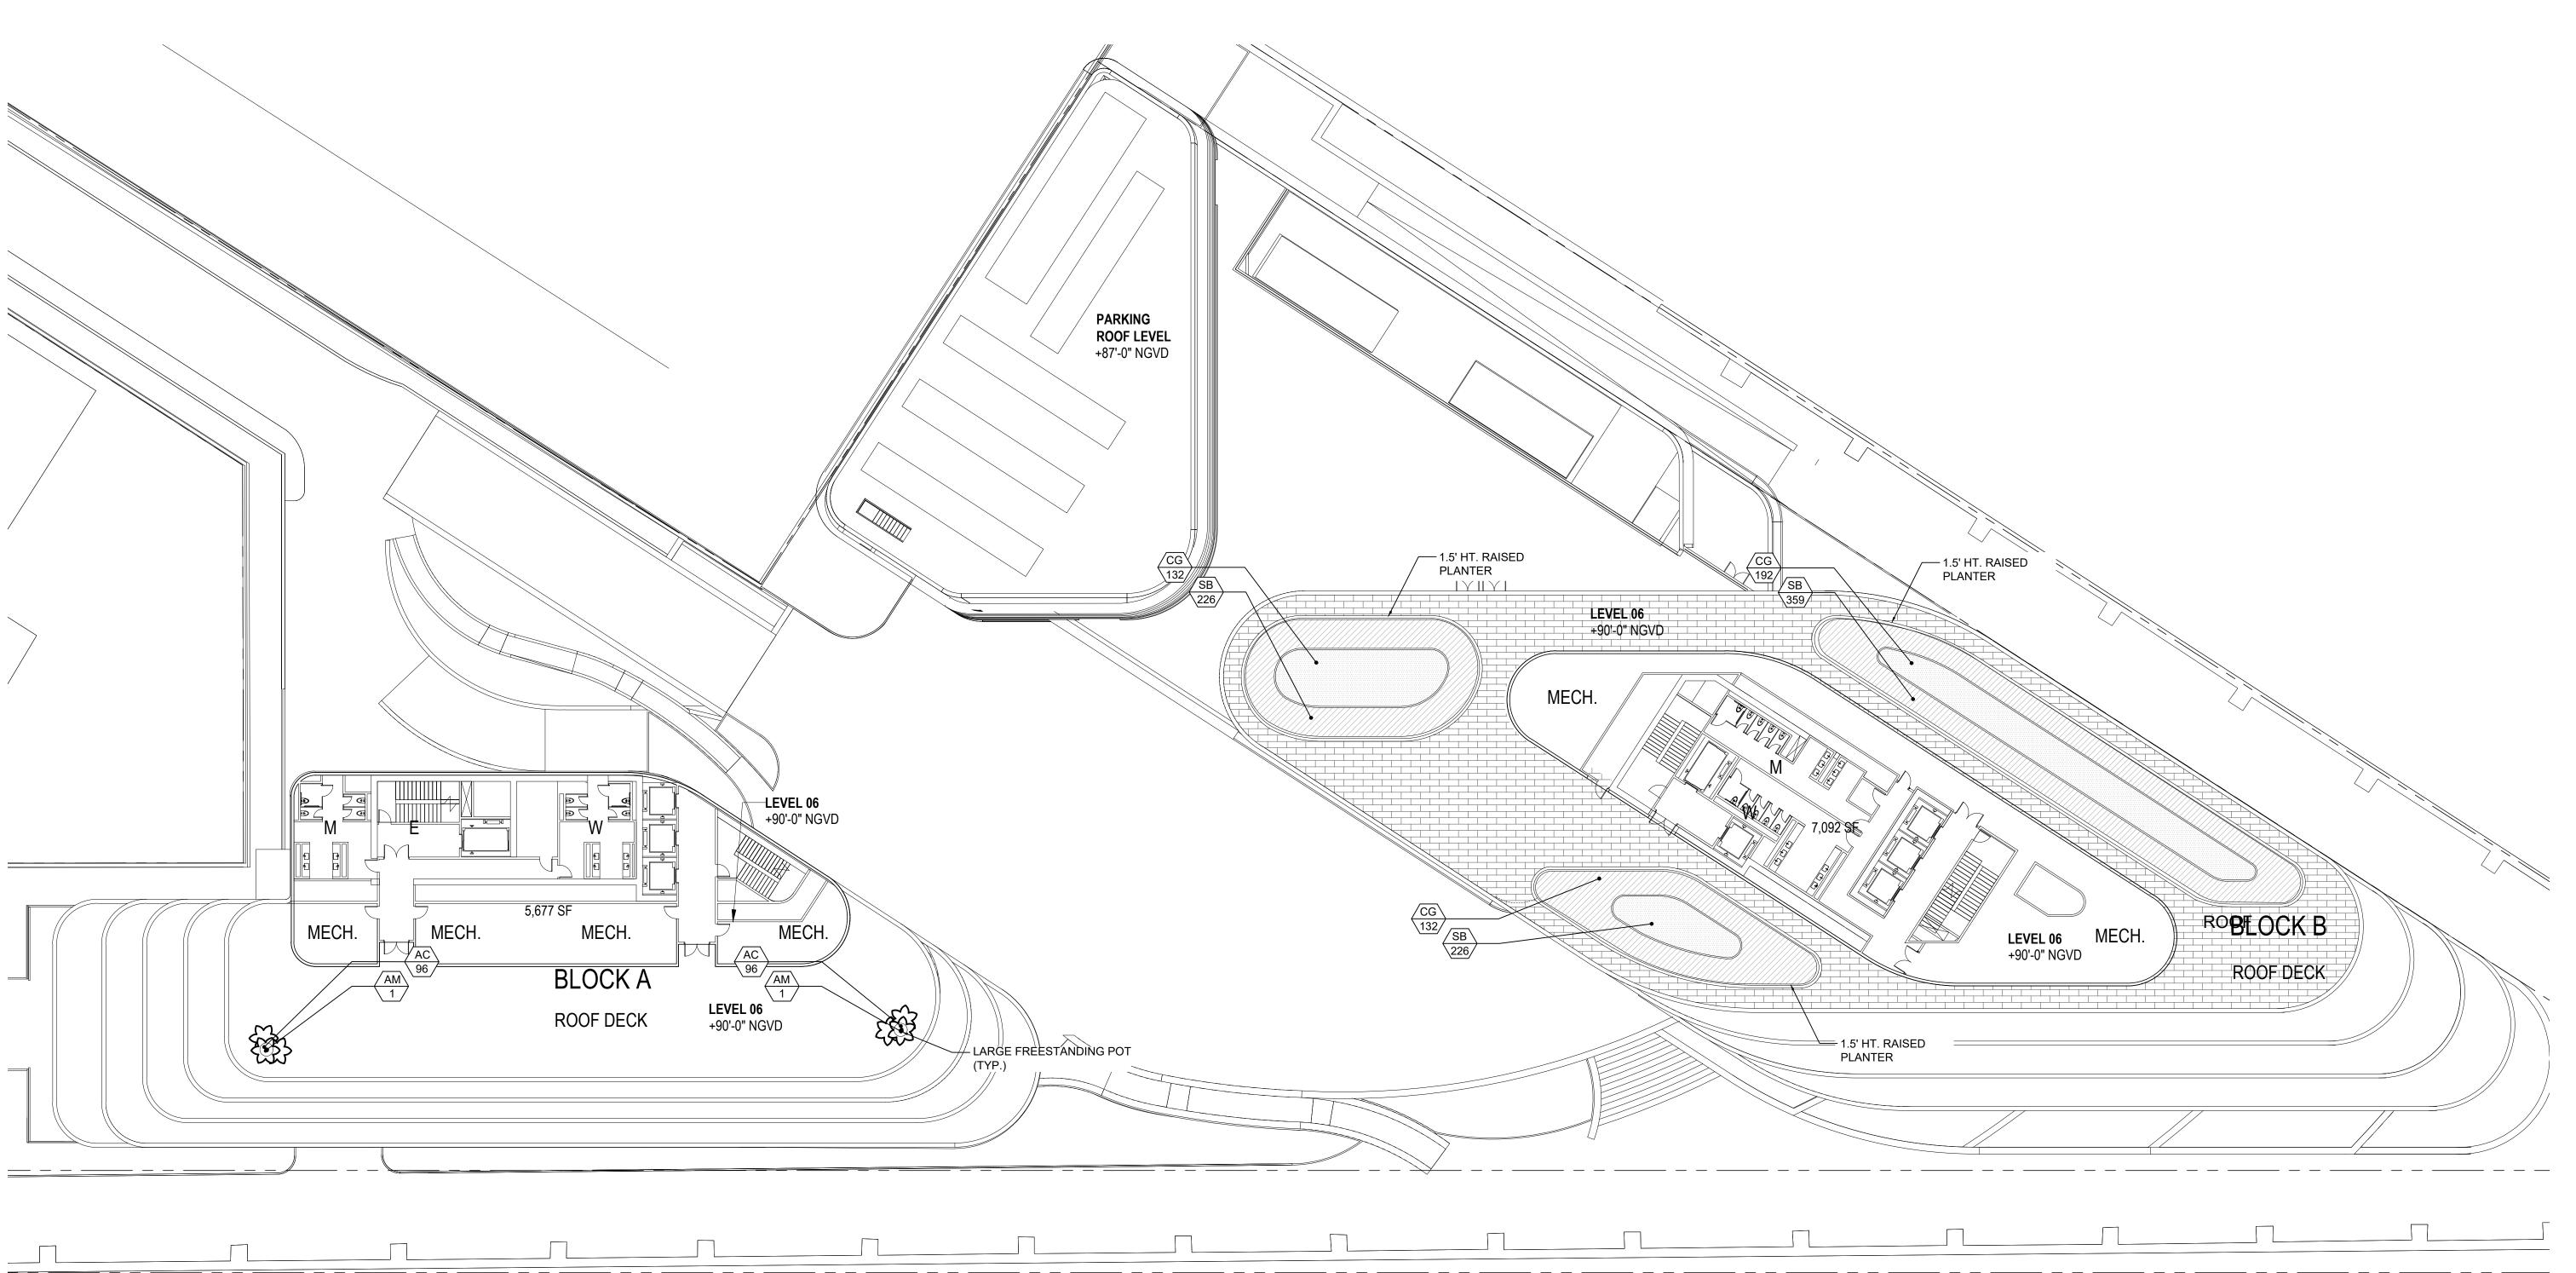


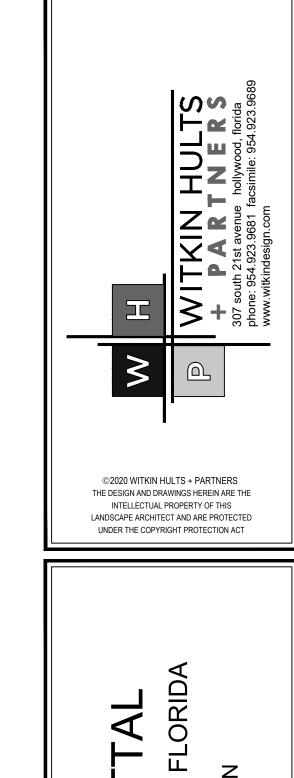

DRB FINAL SUBMITTAL

ONE ISLAND PARK, MIAMI BEACH, FLORIDA

ROOF LEVEL LANDSCAPE PLAN

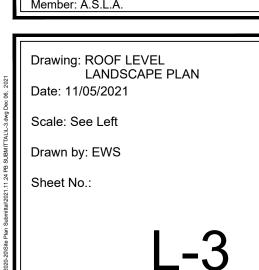


Cad Id.: 2020-020


NORTH

ROOF LEVEL LANDSCAPE PLAN


Scale: 1" = 20'-0"

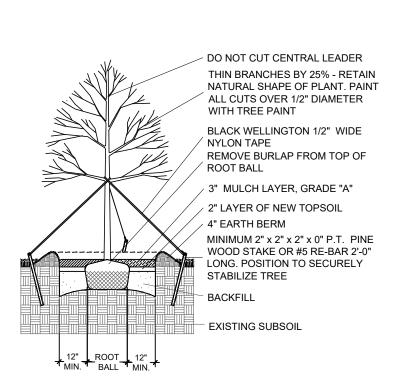

LARGE TREE PLANTING DETAIL

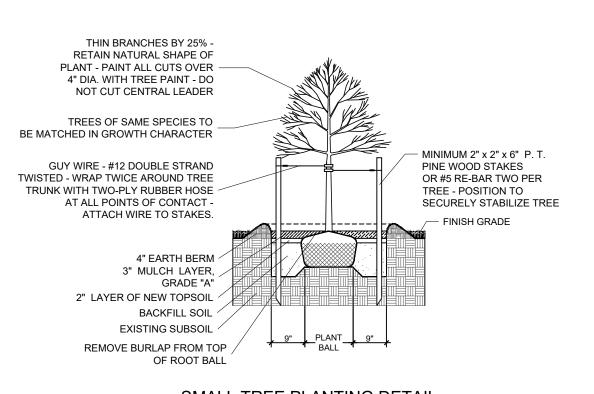


SMALL TREE PLANTING DETAIL T

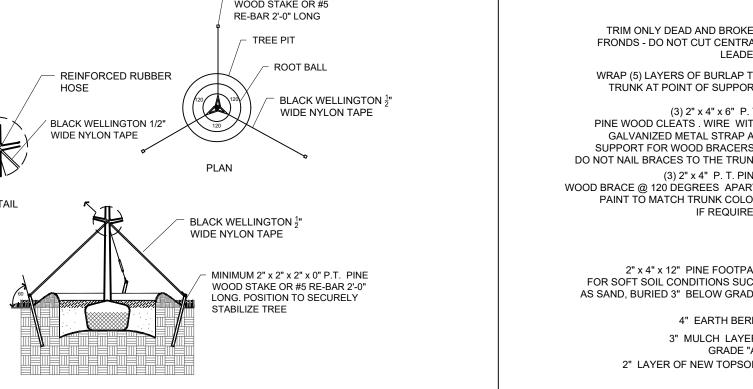


- 2"x2"x 2'-0" P.T. PINE


TYPICAL TREE GUYING DETAIL

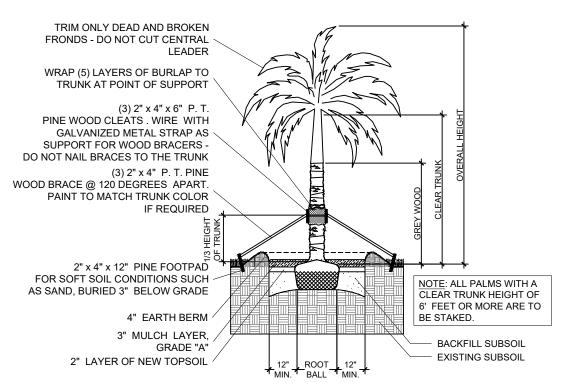


STRAIGHT TRUNK PALM PLANTING DETAIL

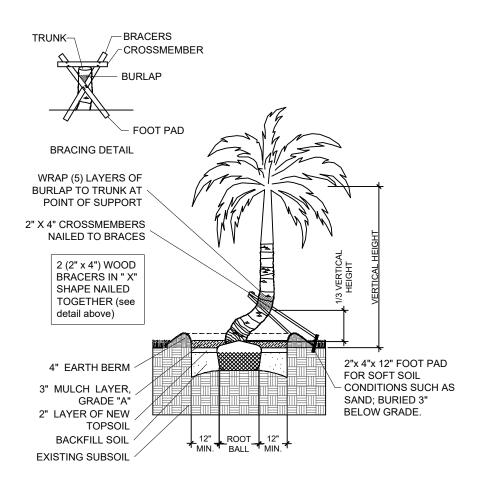


CURVED TRUNK PALM PLANTING DETAIL

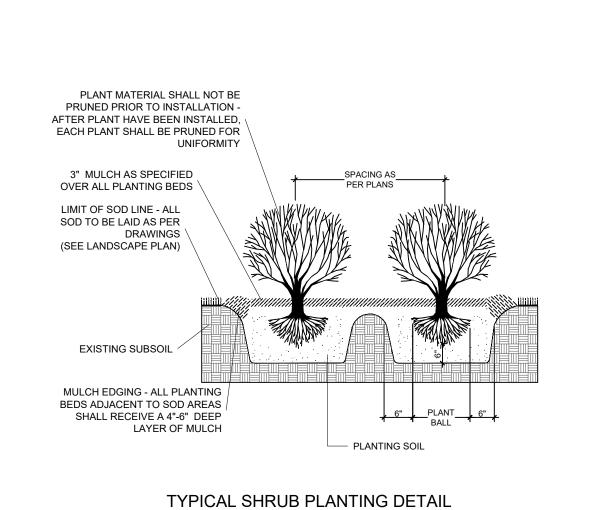

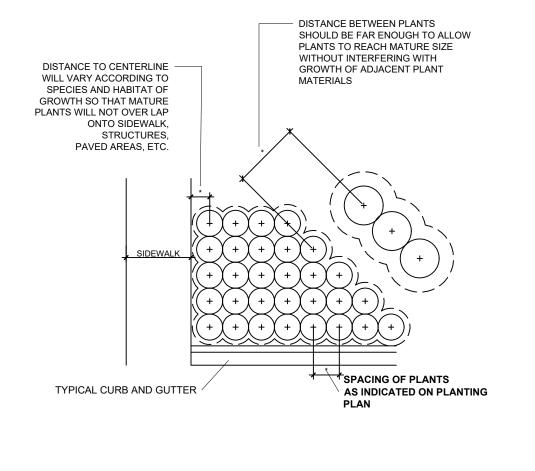



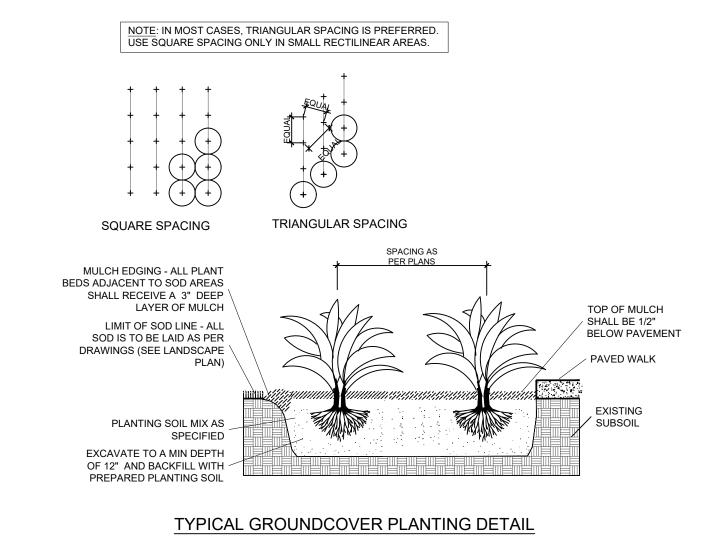

## **PLANTING NOTES:**

- -All plant material is to be Florida Number 1 or better pursuant to the Florida Department of Agriculture's Grades and Standards for Nursery Plants.
- -All plants are to be top dressed with a minimum 3" layer of Melaleuca mulch, Eucalyptus mulch or equal.
- -Planting plans shall take precedence over plant list in case of discrepancies.
- -No changes are to be made without the prior consent of the Landscape Architect and Owner. Additions and or deletions to the plant material must be approved by the project engineer.
- -Landscape Contractor is responsible for providing their own square footage takeoffs and field verification for 100% sod coverage for all areas specified.
- All landscape areas are to be provided with automatic sprinkler system which provide 100% coverage, and 50% overlap.
- All trees in lawn areas are to receive a 24" diameter mulched saucer at the base of the trunk.
- Trees are to be planted within parking islands after soil is brought up to grade. Deeply set root balls are not acceptable.
- Planting soil for topsoil and backfill shall be 50/50 mix, nematode free. Planting soil for annual beds to be comprised of 50% Canadian peat moss, 25% salt free coarse sand and 25% Aerolite.
- Tree and shrub pits will be supplemented with "Agriform Pells", 21 gram size with a 20-10-5 analysis, or substitute application accepted by Landscape Architect. Deliver in manufacturer's standard containers showing weight, analysis and name of manufacturer.

## **SOD NOTES:**

-Sod is to be grade "A" weed free.

-All areas marked "LAWN" shall be solid sodded with St. Augustine 'Floratam' solid sod. See limit on plan. All areas marked 'Bahia Grass' shall be solid sodded with Paspalum.

-Provide a 2" deep blanket of planting soil as described in planting notes this sheet. Prior to planting, remove stones, sticks, etc. from the sub soil surface. Excavate existing non-conforming soil as required so that the finish grade of sod is flush with adjacent pavement or top of curb as well as adjacent sod in the case of sod patching.

-Place sod on moistened soil, with edges tightly butted, in staggered rows at right angles to slopes.

-Keep edge of sod bed a minimum of 18" away from groundcover beds and 24" away from edge of shrub beds and 36" away from trees, measured from center of plant.

-Sod Shall be watered immediatley after installation to uniformily wet the soil to at least 2" below the bottom of the sod strips.

-Excavate and remove excess soil so top of sod is flush with top of curb or adjacent pavement or adjacent existing

## **GENERAL NOTES:**


-The Landscape Contractor is to locate and verify all underground and overhead utilities prior to beginning work. Contact proper utility companies and / or General Contractor prior to digging for field verification. The Owner and the Landscape Architect shall not be responsible for any damages to utility or irrigation lines (see Roadway Plans for more utility notes).

-Landscape Contractor is to verify all current drawings and check for discrepancies and bring to the attention of the Landscape Architect prior to commencing with the work.

-All unattended and unplanted tree pits are to be properly barricaded and flagged during installation.

-All planting plans are issued as directives for site layout. Any deviations, site changes, etcetera are to be brought to the attention of the Landscape Architect for clarification prior to installation.

-Contractor shall provide a one year guarantee on all trees and palms.

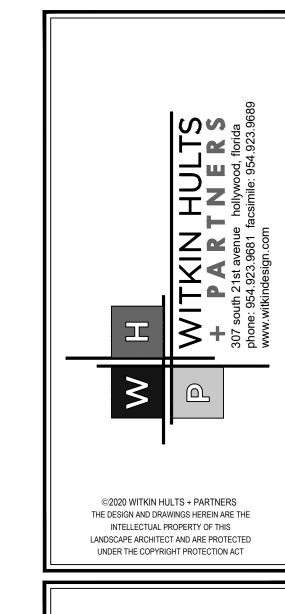

DRB FINAL SUBMITTAL ONE ISLAND PARK, MIAMI BEACH, FLORIDA

Revisions:	Date:	By:
1) PB First Submittal	11.05.2021	<u>EWS</u>
2) DRB First Submittal	11.15.2021	<b>EWS</b>
3) PB Final Submittal	11.29.2021	<u>EWS</u>
3) DRB Final Submittal	12.06.2021	<u>EWS</u>
-		
-		
-		
-		

Seal:	
Lic. # LA0000889 Member: A.S.L.A.	

ec 06, 2021	Drawing: LANDSCAPE NOTES AND DETAILS Date: 11/05/2021
L\L-1.dwg De	Scale: See Left
SUBMITTA	Drawn by: EWS
21.11.24 PB	Sheet No.:
strainal Island 2020-20/Site Plan Submittal2021.11.24 PB SUBMITTAL'L'-1.6wg Dec 06, 2021	L-4
erminal Islan	Cad Id.: 2020-020