## THE SAGAMORE HOTEL

## **Request for Conditional Use Permit for Special Events**

1671 Collins Avenue. Miami Beach, Florida, 33139

## City of Miami Beach Planning & Zoning Dept.

Design Review Board - August 30th, 2021

## **DRB - FINAL SUBMITTAL**

**ZONING DISTRICT RM-3 (Residential Multifamily, High Density)** 

#### APPLICABLE CODES

- CITY OF MIAMI BEACH ZONING CODE CURRENT
- FLORIDA BUILDING CODE 2020 7TH EDITION FLORIDA FIRE PREVENTION CODE 2020 7TH EDITION
- LIFE SAFETY CODE NFPA 101, 2018 EDITION









## SCOPE OF THE WORK - DRB FIRST SUBMITTAL

CONDITIONAL USE PERMIT FOR SPECIAL EVENTS AT PATIO AND POOL DECK

1. SPECIAL EVENTS AT PATIO AND POOL DECK AREA

	DRAWING INDEX			
SHEET No.	SHEET TITLE	REVISIO		
		Α	A	Δ
	ARCHITECTURAL			
0.00	FRONT COVER SHEET			
A-1	LOCATION MAP / SITE PLAN			
A-2	ZONING DATA CHARTS			
A-3	PHOTOGRAPHS - IMMEDIATE CONTEXT			
A-4	PHOTOGRAPHS - EXTERIOR IMAGES			
A-5	PHOTOGRAPHS - PATIO AND POOL DECK			
A-6	EXISTING SEATING COUNT AND OUTDOOR LIFE SAFETY			
A-7	PROPOSED PARTIAL OUTDOOR DECK SEAT COUNT			
A-8	PROPOSED PARTIAL OUTDOOR DECK SEAT COUNT			

-----

DRAWING INDEX					
SHEET No.	SHEET TITLE		REVISIONS		
		A	A	Δ	
			<u> </u>		
			$\vdash$		
			$\vdash$		
			_		
			_		
			<u> </u>		
			<u> </u>	_	
			<u> </u>	_	
			<u> </u>	_	
		_		_	
			-	_	
			$\vdash$	_	
		+		_	
		+	-	<u> </u>	
		_		-	
		+	-	-	
			$\bot$		

Victor H Rodriguez	Digitally signed by Victor H Rodriguez Date: 2021.08.28 - 16:40:38 - 04'00' Victor H. Rodriguez Registered Architect	OF FO
	Registered Architect	MOSS PED ARCHING

## PROJECT APPLICANT:

EBJ / Sagamore, LLC EBJ / Sagamore, LLC
c/o Ben Josef Group Holdings
104 West 40th Street, 14th Floor
New York, NY 10018
Contact: Jordan Gvill
Tel : 305. 510. 5375
email : J.gvili@sagamorehotel.com SAGAMORE

NEERS:	STRUCTURAL ENGIN

INTERIOR DESIGN:

### ARCHITECT OF RECORD:



#### R+N Architecture

ATM AFCHITECTUTE
420 E. Palmetto Park Road. Boca Raton, Florida 33432
0ffice: 786.762.2679 C: 305.282,0005
Email: vh.rodriguez@rna-archint.com
www.rda@rna-archint.com / AA26002510



DRB FINAL SUBMITAL POOL DECK C.U.P.

- Images of Building's Immediate Context

VIEW OF IMMEDIATE CONTEXT OF BUILDING - COLLINS AVENUE

### VIEW OF IMMEDIATE CONTEXT SOUTH OF BUILDING - COLLINS AVENUE

## **IMMEDIATE CONTEXT IMAGES**







VIEW OF IMMEDIATE CONTEXT ACCROSS COLLINS AVENUEW

VIEW OF IMMEDIATE CONTEXT NORTH OF BUILDING - COLLINS AVENUE

2 IMMEDIATE CONTEXT IMAGES SCALE: NTS

FOR NOT

August 30th.,

SET.

SUBMITTAL

DRB FINAL

CONSTRUCTION

Victor H Digitally signed by Victor H Rodriguez Date: 2021.08.28

Issue	Issue Date / For
①	08.09.2021 / DRB First Submittal
<u> </u>	08.30.2021 / DRB Final Submittal

- Building Context
DDCI Project #: 2021.050
Drawn by: VHR
Approved by: VHR

1671 Collins Avenue. Miami Beach. FL 33139

PROJECT OWNER:
EBJ / Sagamore, LLC
104 West 40th Street, 14th Floor
New York, NY 10018



ATM Architecture
420 E. Palmetto Park Raod. Boca Raton, Florida 33432
0ffice: 786.762.2679 C: 305.282,0005
Email: vh.rodriguez@rna-archint.com
www.rda@rna-archint.com / AA26002510

CONSTRUCTION

FOR NOT

August 30th.,

SUBMITTAL

DRB FINAL



Victor H

Digitally signed by Victor H Rodriguez Rodriguez Date: 2021.08.28

DRB FINAL SUBMITAL POOL DECK C.U.P.

- Exterior Images of Existing Building

A-4



VIEW OF MAIN BUILDING FRONT FACADE FROM COLLINS AVENUE

## BUILDING EXTERIOR IMAGES SCALE: NTS




VIEW OF BUNGALOWS AND INTERIOR COURTYARD FROM POOL DECK

BUILDING EXTERIOR IMAGES
SCALE: NTS



DETAIL OF MAIN BUILDING FRONT FACADE FROM COLLINS AVENUE

## **BUILDING EXTERIOR IMAGES**

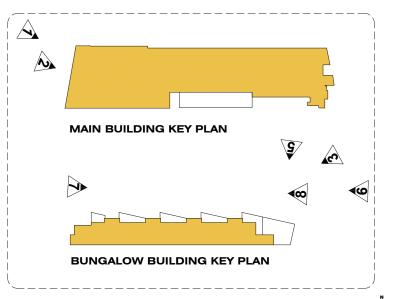

PHOTOGRAPHS KEY PLAN FOR SHEETS A1.08 & A1.09

1671 Collins Avenue. Miami Beach, FL 33139

PROJECT OWNER: EBJ / Sagamore, LLC 104 West 40th Street, 14th Floor New York, NY 10018



RTN Architecture
420 E. Palmetto Park Road. Boca Raton, Florida 33432
Office: 786.762.2679 C: 305.282.0005
Email: vh.rodriguez@rna-archint.com
www.rda@rna-archint.com / AA25002510



Victor H Digitally signed by Victor H Rodriguez Date: 2021.08.28

2021

August 30th.,

SUBMITTAL

DRB FINAL

POOL DECK C.U.P.

DDCI Project #: 2021.050 Drawn by: VHR Approved by: VHR

- Images of Patio Deck

A-5



**AERIAL VIEW OF POOL DECK** 

5 BUILDING EXTERIOR IMAGES
SCALE: NTS



VIEW OF PATIO DECK LOOKING EAST

7 BUILDING EXTERIOR IMAGES
SCALE: NTS



VIEW OF POOL DECK AND PATIO DECK

BUILDING EXTERIOR IMAGES SCALE: NTS 6





8 BUILDING EXTERIOR IMAGES
SCALE: NTS


DRB FINAL SUBMITAL

08.09.2021 / DRB First Submitta
08.30.2021 / DRB Final Submitta

and Pool Deck

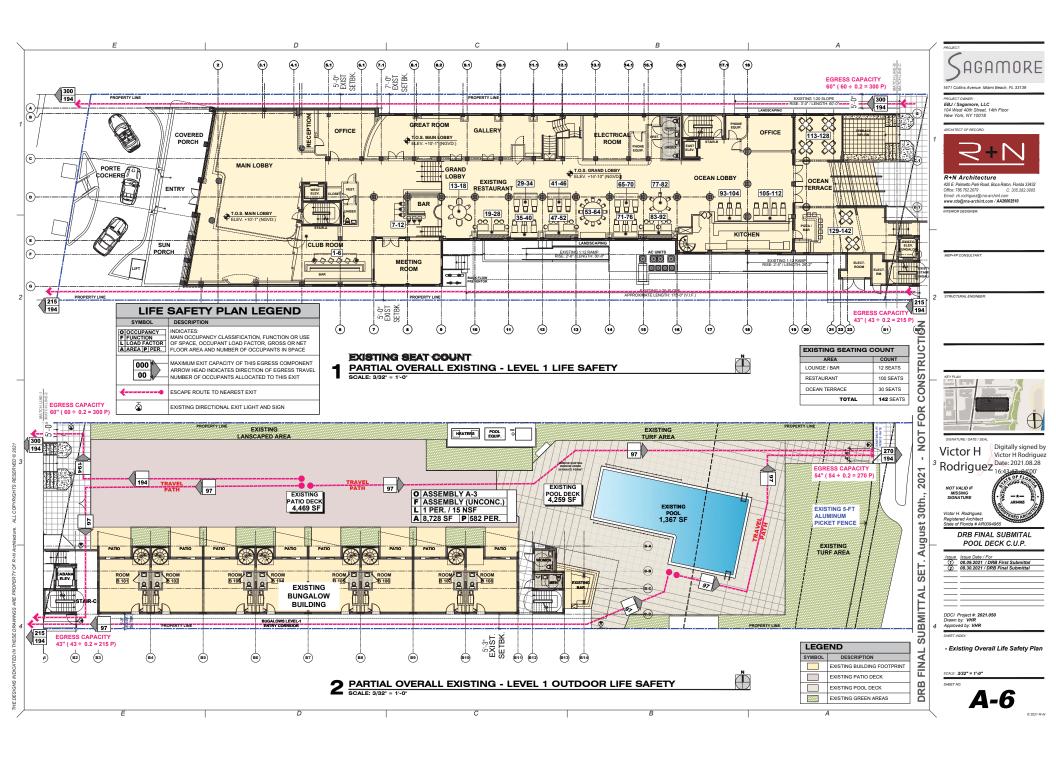

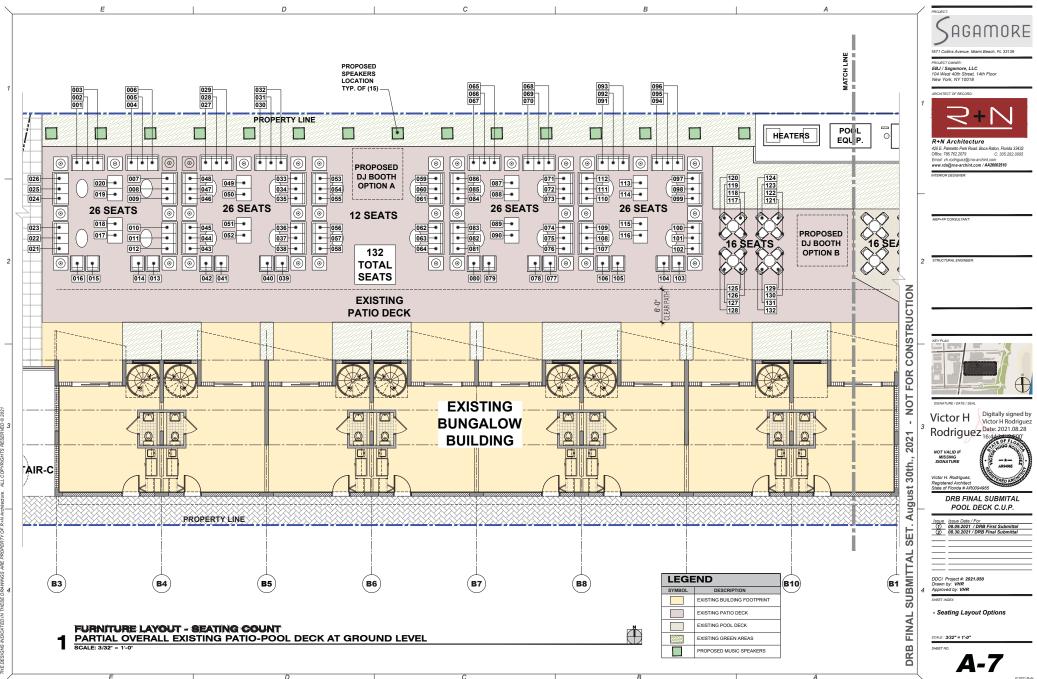


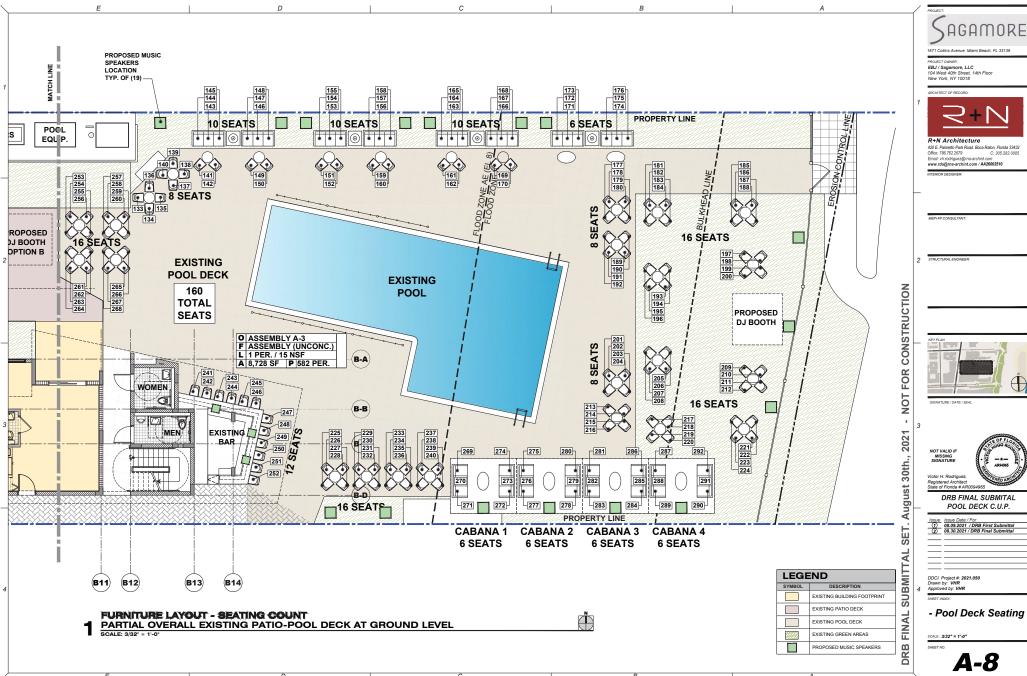




_	
Issue	Issue Date / For
(1)	08.09.2021 / DRB First Submittal
2	08.30.2021 / DRB Final Submittal

# Sagamore Hotel CUP

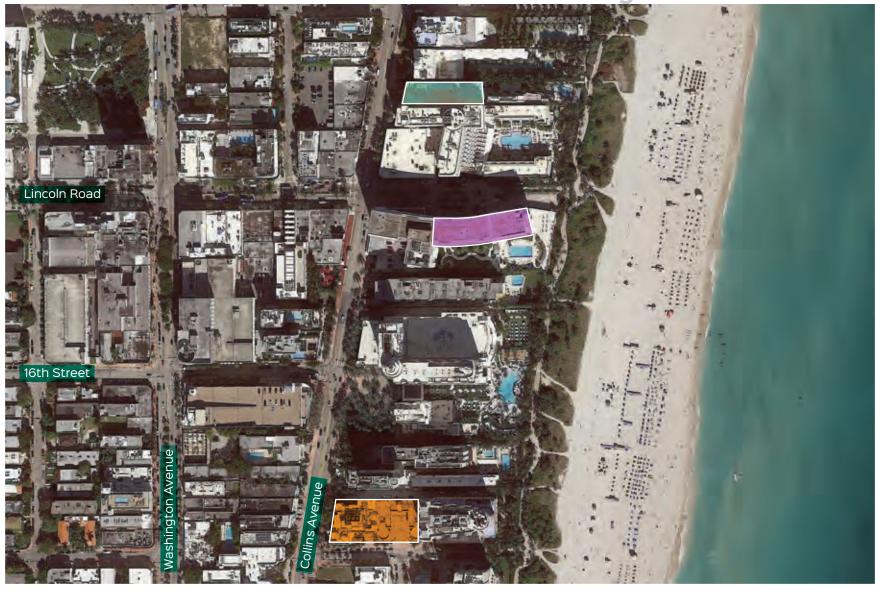

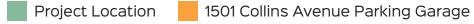

100 Lincoln Road Garage

# **Exhibit 1**

Location Map



**Exhibit 16: Existing Conditions Intersection Capacity Analysis** 

**Saturday Midday and Evening Peak Hour Conditions** 

T / /	Signalized/ Un-signalized	Direction	Midday Peak		Evening Peak	
Intersection			LOS	Delay	LOS	Delay
		NB	С	32.2	С	30.0
Collins Avenue /		SB	С	31.6	С	29.5
Lincoln Road	S	EB	F	121.0	F	154.1
Lincom Road		WB	E+19	95.1	E+2	81.5
		Overall	D	44.2	D	44.9

 $<sup>^1\</sup>mathrm{Based}$  on ITE internalization rates between the hotel and restaurant approved by Miami Beach

 $<sup>^2\</sup>mathrm{Based}$  on Information Provided by Miami Beach

## **Future with Maximum Occupancy Event Conditions Intersection Capacity Analysis**

The intersection of Collins Avenue and Lincoln Road was analyzed for future with maximum occupancy event conditions for the midday and evening peak hours of a typical Saturday. As the venue is seeking a conditional use permit for future unplanned events at the Sagamore Hotel, the intersection was analyzed as if the event began or ended during the midday and evening peak hours of a typical Saturday. Exhibit 23 shows the resulting LOS for the arrival (event start) and departure (event end) conditions for the midday and evening peak hours of a typical Saturday. The analysis shows that the intersection is projected to continue to operate at LOS D during the midday and evening peak hours during the event arrival and departure. Capacity worksheets are included in Attachment D.

Exhibit 23: Future with Maximum Occupancy Event Conditions Intersection Capacity Analysis Saturday Midday and Evening Peak Hour Conditions

T / /	Signalized/	Direction	Midday Peak		<b>Evening Peak</b>		LOS
Intersection	Un-signalized		LOS	Delay	LOS	Delay	Standard
		NB	С	35.0	С	33.4	E+50
Collins Avenue /		SB	С	33.3	С	31.9	E+50
Lincoln Road	S	EB	E+46	116.5	F	136.4	E+50
(Arrival)		WB	E+15	37.6	Е	72.5	E+50
		Overall	D	46.6	D	46.6	E+50
		NB	D	37.1	С	33.1	E+50
Collins Avenue /		SB	D	35.3	С	31.8	E+50
Lincoln Road	S	EB	E+36	108.9	F	140.5	E+50
(Departure)		WB	E+25	99.7	E+32	105.3	E+50
		Overall	D	47.3	D	47.2	E+50