

228+302 W Dilido Garden | Proposed Plant List

Miami Beach, Fl. 2-Aug-21

TY	SYM CPE	TREES Botanical Name Ceiba Pentandra	Common Name Kapok Tree	Native Yes	Tolerant	Credit	Total	Specifications 20'-25' HT. x 15'-20' SPR. 10" DBH, Character, Specimen
3	CRO	Clusia rosea	Autograph Tree	Yes		500	1,500	20'-25' HT. x 16'-18' SPR. Multi, Character, Collected, Specimen
<u>2</u> 3	CUV CER	Coccoloba uvifera Conocarpus erectus	Seagrape Green Buttonwood	Yes Yes	Yes Yes	500 500	1,000 1,500	20'-25' HT. x 12'-14' SPR. Multi, Character, Collected, Specimen 16'-20' HT. x 10'-12' SPR. Multi, Character, Field Grown, Specimen
L 9	CBS MUT	Cordia boissieri Miscellaneous Understory Trees	White Geiger Tree	Yes	Yes	500	500	12'-14' HT. Specimen
.5	MUT	coccoloba diversifolia	Pigeonplum	Yes				14' x 16' HT.
	MUT MUT	Caesalpinia granadillo Dipholis salicifolia	Bridal Veil Willow Bustic	No Yes				14' x 16' HT. 14' x 16' HT.
	MUT MUT	Guapira discolor Krugiodendron ferreum	Beeftree Black Ironwood	Yes Yes				14' x 16' HT. 14' x 16' HT.
	MUT	Plumeria sp.	Plumeria	Yes				14' x 16' HT.
5 1	MFR PAQ	Myrcianthes fragrans Pachira aquatica	Simpson's Stopper Water/Guiana Chestnut	Yes No	Yes			14'-16' HT. x 8'-10' SPR. 20'-25' HT. x 15'-20' SPR. 8" DBH, Specimen
7 5	PLO QVI	Polyalthia longifolia 'Upright' Quercus virginiana	Mast Tree Live Oak	No Yes	Yes	500	0 2,500	16'-20' HT. Field Grown 25'-30' HT. x 20'-25' SPR. 10"-12" DBH, Field Grown, Specimen
<i>ა</i>	QVI	Quercus virginiana	Live Oak	res	163	300	3,000	23-30 HT. X 20-23 SPN. 10 -12 DBH, FIEld Glown, Specimen
		PALMS						
TY 3	SYM CAL	Botanical Name Coccothrinax alta	Common Name Same	Native No	Tolerant Yes	Credit 300	Total 900	Specifications 14'-16' OA. Field Grown, Specimen
1	CAR	Coccothrinax sp.	Same	Yes	Yes	300	300	14'-16' OA. Field Grown, Specimen
7 2	CNU CFA	Cocos nucifera Copernicia fallaensis	Coconut Palm Same	Yes No		300 100	2,100 200	30'-35' OA. Character, Curved Trunks 12'-14' OA. Specimen
<u>1</u> 2	DPE PHO	Dypsis pembana Phoenix sp.	Pemba Palm Hybrid Phoenix	No No	Yes	100 300	100 600	16'-20' OA. Stagered HT., Multi-Trunk, Specimen Florida Hybrid,. Multi-trunk
6	PMA	Ptychosperma macarthurii	Macarthur Palm	No		100	600	16'-20' OA. Heavy
6 4	RMA RRE	Ravenala madagascariensis Roystonea regia	Traveler's Tree Royal Palm	No Yes	Yes	100 300	600 1,200	14'-16' HT. Field Grown 25'-30' OA. Field Grown
5 6	SDO SPA	Sabal domingensis Sabal palmetto	Dominican Sabal Palm Sabal Palm	No Yes	Yes	300 300	1,500 1,800	18'-24' OA. Staggered HT., Field Grown 30'-35' HT. Character, Curved Trunks
2	TRA	Thrinax sp.	Same	Yes	Yes	300	600	14'-16' OA. Field Grown, Specimen
							10,300	
TY	SYM	UNDERSTORY TREES / LARG	E SHRUBS Common Name	Native				Specifications
37	LNS	Large Native Shrubs			<u>'</u>		<u> </u>	
	LNS	Canella winterana Eugenia foetida	Cinnamon Bark Spanish Stopper	Yes Yes				10 HT. 2" DBH 10 HT. 2" DBH
	LNS LNS	Eugenia rhombea Gymnanthes lucida	Red Stopper Shiny Oysterwood	Yes Yes				10 HT. 2" DBH 10 HT. 2" DBH
	LIVS	1 /	Jimiy Oysterwood	103				2011.2 0011
ŢΥ	SYM	SHRUBS Botanical Name	Common Name	Native				Specifications
80	SH SH	Low Shrubs Argusia gnaphalodes	Sea Lavender	Yes				7 Gal
	SH	Chrysobalanus icaco 'horizontal'	Horizontal Cocoplum	Yes				7 Gal
	SH SH	Clusia fluminensis Gardenia taitensis 'Mini'	Same Dwarf Tahitian Gardenia	Yes Yes				7 Gal 7 Gal
	SH SH	Psychotria nervosa Zamia pumila	Wild Coffee Coontie	Yes Yes				7 Gal 7 Gal
			Josephine	1.00				1, 64.
TY	SYM	ACCENTS Botanical Name	Common Name	Native				Specifications
9 l1	AI AO	Alcantarea imperialis Alcantarea odorata	Giant Bromeliad Fragrant Alcantarea	No Yes				7 Gal. Full 8 Gal. Full
5	AP	Alocasia sp.	Elephant Ears	No				25 Gal. Full.
1 2	DS EF	Dioon spinulosum Encephalartos ferox	Gum Palm Zululand Cycad	No Yes				15 Gal. 3'-4' HT. 15 Gal. 3'-4' HT.
53 L7	MD PR	Monstera deliciosa Philodendron 'Rojo Congo'	Swiss Cheese Plant Same	Yes Yes				7 Gal. Mature Leaves 7 Gal. Full.
2	SR	Serenoa repens	Saw Palmetto	Yes				30 Gal. 3'× 3'
l1	ZP	Zamia pumila	Coontie	Yes				3 Gal. 18" HT. Full
TY	SYM	GROUNDCOVERS Botanical Name	Common Name	Native				Specifications
030	GCT6 GCT2	Bulbine frutescens Eragrostis elliottii	Peach' Bulbine Peach Silver Lovegrass	Yes				1 Gal @ 18" O.C. Full
58	GCT3	Ernodea littoralis	Golden Creeper	Yes				1 Gal @ 18" O.C. Full 3 Gal @ 24" O.C. Full
25 26	GCT1 GCT4	Glandularia maritima Microsorum scolopendrium	Beach Verbena Wart Fern	Yes Yes				1 Gal @ 18" O.C. Full 1 Gal @ 18" O.C. Full
04	GCT8	Nephrolepis exaltata	Boston Fern	No				3 Gal @ 24" O.C.
14 00	GCT9 GCT5	Peperomia obtusifolia Philodendron Burle Marx	Baby Rubber Plant Same	No No				3 Gal @ 24" O.C. 3 Gal @ 24" O.C. Full
16	GCT7	Turnera subulata	White Buttercup	No				1 Gal @ 18" O.C. Full
T'	63/2-	SOD Retanical Name	Commercia No.	B1				Production of
TY 5 S.F.	SYM ZC	Botanical Name Zoysia 'cashmere'	Common Name Cashmere Zoysia Grass	Native No				Specifications Solid Sod. Qtys shown in S.F.
CT E	LOOP							
J1 F	LOOR	TREES						
TY	SYM CSE	Botanical Name Cordia sebestena	Common Name White Geiger	Native Yes	Tolerant Yes	Credit 500	Total 500	Specifications 15'-20' HT. x 8'-10' SPR. Field Grown, Specimen
_	COL		Time Geiger	163	,	300	500	
		PALMS						
ΤΥ 4	SYM CAR/TRA	Botanical Name Coccothrinax sp. or Thrinax sp.	Common Name Same	Native Yes		Credit 100	Total 400	Specifications 14'-16' OA. Field Grown, Specimen
1	DPE	Dypsis pembana	Pemba Palm	No No		100		16'-20' OA. Stagered HT., Multi-Trunk, Specimen
	<u> </u>						400	<u> </u>
TY	SYM	ACCENTS Botanical Name	Common Name	Native		_		Specifications
2	Al	Alcantarea imperialis	Giant Bromeliad	No				7 Gal. Full
7 1	AO EF	Alcantarea odorata Encephalartos ferox	Fragrant Alcantarea Zululand Cycad	Yes Yes				8 Gal. Full 15 Gal. 3'-4' HT.
5 5	PJ ZP	Portea jungles Zamia pumila	Same Coontie	No Yes				7 Gal. Full. 3 Gal. 18" HT. Full
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ΤΥ	SYM	Botanical Name	Common Name	Native				Specifications
85 28	GCT6 GCT3	Bulbine frutescens Ernodea littoralis	Peach' Bulbine Golden Creeper	Yes Yes				1 Gal @ 18" O.C. Full 3 Gal @ 24" O.C. Full
20	GCT1	Glandularia maritima	Beach Verbena	Yes				1 Gal @ 18" O.C. Full
45 9	GCT4 GCT8	Microsorum scolopendrium Nephrolepis exaltata	Wart Fern Boston Fern	Yes No				1 Gal @ 18" O.C. Full 3 Gal @ 24" O.C.
'2	GCT5	Philodendron Burle Marx	Same	No				3 Gal @ 24" O.C. Full
ON	D FLOOR							
		ACCENTS	Commercia No.	B1				Success of
	SYM MD	Botanical Name Monstera deliciosa	Common Name Swiss Cheese Plant	Native Yes				Specifications 7 Gal. Mature Leaves
-	PJ	Portea jungles	Same	No				7 Gal. Full.
8 5		GROUNDCOVERS						
5	1	I Do A control Allows	Common Name	Native	1			Specifications
8	SYM GCT2	Botanical Name Eragrostis elliottii	Silver Lovegrass	Yes			L.	1 Gal @ 18" O.C. Full
8 5 TY	GCT2 GCT1	Eragrostis elliottii Glandularia maritima	Silver Lovegrass Beach Verbena	Yes Yes				1 Gal @ 18" O.C. Full
TY 47	GCT2	Eragrostis elliottii	Silver Lovegrass	Yes				

1. In addition to the above plant list and specifications there is to be an additional \$15,000.00 plant and install allowance - Landscape Architect to select accent specimens during nursery visits.

2. In addition to the above plant list and specifications there is to be an additional \$5,000.00 planted purchase plant and install allowance for aquatic plants.

3. Ladscape contractor to provide photographs of all trees & palms for Landscape Architect's approval with bid.

4. Landscape contractor to coordinate installation with Landscape Architect at least 1 month prior to installation date.

5. All plants to be laid out on site by Landscape Architect.

7. 50% of all required shrubs shall be low maintenance/ drought and salt tolerant.
8. 50% of all required shrubs shall be low maintenance/ drought and salt tolerant.

6. 30% of all shrubs shall be native.

	CITY OF MIAMI BEACH LANDSCAPE LEGEND INFORMATION REQUIRED TO BE PERMANENTLY AFFIXED TO PLANS		
	ZONING DISTRICT RS-3 LOT AREA 21,000 SF ACRES 0.50		
	OPEN SPACE	REQUIRED/ ALLOWED	PROVIDE
A.	SQUARE FEET OF REQUIRED OPEN SPACE AS INDICATED ON SITE PLAN: LOT AREA = 21,000 S.F. X 50% % = 10,500 S.F.	10,500 SF	11,870
В.	SQUARE FEET OF PARKING LOT OPEN SPACE REQUIRED AS INDICATED ON SITE PLAN:	N/A	N/A
	NUMBER OF PARKING SPACES X 10 S.F. PARKING SPACE	N/A	N/A
C.	TOTAL SQUARE FEET OF LANDSCAPED OPEN SPACE REQUIRED:	5,827	5,864 SF
	LAWN AREA CALCULATION		
A.	SQUARE FEET OF LANDSCAPED OPEN SPACE REQUIRED	5,827	
В.	MAXIMUM LAWN AREA (SOD) PERMITTED=50 % X 5,827 SF=2,914	2,914	1265 SF
	TREES		
A.	TREES REQUIRED PER NET LOT ACRE	N/A	N/A
	TREES ON FRONT YARD	4	22
	TREES ON BACK YARD	6	9
	TREES IN EXCESS OF 6,000 SF LOT (I TREE X 1,000 SF)	15	17
	TOTAL TREES ON LOT	25	48
В.	30% NATIVES REQUIRED: 25 X 30% = 8	8	19
C.	50% LOW MAINTENANCE / DROUGHT AND SALT TOLERANT REQUIRED: 25 X 50% = 13	13	17
D.	STREET TREES (MAXIMUM AVERAGE SPACING OF 20' O.C.) 120 LF / 20' = 6	6	6
E.	STREET TREE SPECIES ALLOWED DIRECTLY BENEATH POWER LINES: (MAXIMUM AVERAGE SPACING OF 20' O.C.): Myrcianthes Fragrans	6	6
	SHRUBS		
A.	NUMBER OF SHRUBS REQUIRED: SUM OF LOT AND STREET TREES REQUIRED 31 X 12 = 372	372	461
В.	50% NATIVE SHRUBS REQUIRED: 528 X 50% = 186	186	434
	LARGE SHRUBS OR SMALL TREES		
Α.	LARGE SHRUBS OR SMALL TREES (10% OF REQUIRED SHRUBS) 372 X 10% = 37	37	37
В.	50% NATIVE LARGE SHRUBS OR SMALL TREES REQUIRED: 37 X 50% = 19	19	37

JUNGLES INC
Landscape Architect FASLA

2964 Aviation Ave., Miami, FL 33133 PH 305.858.6777 www.raymondjungles.com PROJECT NO.: 21047

228+302 W. Dilido Drive Miami Beach, FL 33139

No.	Date	Description							
SEAL									
LANDSCAPE ARCHITECT: Raymond Jungles									
LAN	DSCAPE A	ARCHITECT: Raymond Jungles							
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REVISIONS:

1 11/08/2021 Revised DRB Final Submittal

SHEET TITLE:

PLANTING SCHEDULE

DRB FINAL SUBMITTAL
Drawn By: CB
Checked By: GCH
Date: 08-02-2021

SHEET NUMBER:

LP.300

GENERAL LANDSCAPE NOTES AND SPECIFICATIONS

- 1. LANDSCAPE CONTRACTOR SHALL BECOME FAMILIAR WITH THE SCOPE OF WORK AS WELL AS THE SITE, DIGGING CONDITIONS, AND ANY OBSTACLES PRIOR TO SUBMITTING A BID
- 2. LANDSCAPE CONTRACTOR SHALL PROVIDE AN INSTALLATION SCHEDULE TO THE GENERAL CONTRACTOR AND LANDSCAPE ARCHITECT FOR REVIEW AND APPROVAL
- 3. LANDSCAPE CONTRACTOR SHOULD VERIFY ALL ESTIMATED QUANTITIES OF MATERIAL SHOWN ON THE LANDSCAPE ARCHITECT'S DRAWINGS PRIOR TO SUBMITTING A BID.
- 4 PLANT LIST SHALL TAKE PRECEDENCE OVER PLANTING PLAN IN CASE OF DISCREPANCIES
- 5. ALL PLANT MATERIAL SYMBOLS SHOWN ON LANDSCAPE PLANS SHALL BE CONSIDERED DIAGRAMMATIC AND SHOULD BE ADJUSTED IN THE FIELD BY LANDSCAPE CONTRACTOR TO AVOID ALL UTILITIES AND ALL OTHER OBSTRUCTIONS, AFTER CONSULTING THE LANDSCAPE ARCHITECT.
- 6. ALL SIZES SPECIFIED FOR PLANT MATERIAL ON THE PLAN AND PLANT LIST SHALL BE CONSIDERED MINIMUM.
- 7. ALL PLANT MATERIAL MUST MEET OR EXCEED THE SPECIFIED MINIMUM REQUIREMENTS FOR BOTH HEIGHT AND SPREAD.
- 8. ANY SPECIFIC REQUIREMENTS SUCH AS SPECIFIC SHAPE, CHARACTER, NUMBER OF TREE TRUNKS, PLANT SOURCE, TRANSPORTING, AND OR SPECIAL BRACING NOTED ON THE PLAN OR PLANT LIST, WILL REQUIRE APPROVAL AND OR COORDINATION WITH THE LANDSCAPE ARCHITECT.
- 9. NO CHANGE OR SUBSTITUTION SHALL BE MADE WITHOUT PRIOR APPROVAL OF THE LANDSCAPE ARCHITECT. ANY REVISION OR MODIFICATIONS TO THE LANDSCAPE PLAN MUST HAVE PRIOR APPROVAL BY THE THE LANDSCAPE ARCHITECT & OWNER
- 10. ALL MATERIAL SHALL BE SUBJECT TO AVAILABILITY AT TIME OF INSTALLATION, SUBSTITUTIONS MAY BE MADE AFTER CONSULTATION WITH THE LANDSCAPE ARCHITECT.
- 11. ALL TREES, PALMS, SHRUBS AND GROUND COVERS SHALL BE GUARANTEED FOR A PERIOD OF 12 MONTHS FROM DATE OF FINAL ACCEPTANCE.
- 12. CHANGES MAY OCCUR DURING THE NORMAL COURSE OF IMPLEMENTATION. VERBAL CHANGE ORDERS WILL NOT BE HONORED. ANY CHANGES MUST BE SUBMITTED TO THE LANDSCAPE ARCHITECT IN WRITING AS A CHANGE ORDER TO BE REVIEWED AND APPROVED IN WRITING BY OWNER/CLIENT.
- 13. LANDSCAPE CONTRACTOR SHALL LOCATE AND VERIFY ALL UNDERGROUND UTILITIES OR STRUCTURES PRIOR TO DIGGING. LANDSCAPE CONTRACTOR SHALL REPAIR ALL DAMAGES TO UNDERGROUND UTILITIES, AND OR CONSTRUCTION CAUSED BY LANDSCAPE INSTALLATION, AT NO COST TO THE OWNER.
- 14. LANDSCAPE CONTRACTOR SHALL COORDINATE WITH THE GENERAL CONTRACTOR, THE REMOVAL OF ALL BUILDING CONSTRUCTION DEBRIS AND FOREIGN MATERIAL PRIOR TO INSTALLATION OF ANY PLANT MATERIAL.
- 15. SITE PREPARATION SHOULD INCLUDE THE ERADICATION AND REMOVAL OF ANY WEEDS OR GRASS, REMOVAL AND CLEAN UP OF ANY DEAD MATERIAL AND ROUGH AND FINISH GRADING PER SPECS AND OR LANDSCAPE PLANS.
- 16. FOR PLANT MATERIAL DESIGNATED TO BE REMOVED. THE ENTIRE ROOT SYSTEM SHALL BE DUG AND REMOVED FROM THE SITE.
- 17. ALL PLANTING AREAS SHALL BE EXCAVATED TO A MINIMUM OF 3' FOR GROUNDCOVER'S AND MORE THAN 3' FOR SHRUBS, TREES, AND PALMS, AND SHOULD RECEIVE A SPECIFIED PLANTING SOIL MIXTURE. PLANTING SOIL SHALL BE 70% COARSE SAND, 20% FLORIDA PEAT, AND 10% PINE BARK AS MANUFACTURED BY ATLAS PEAT & SOIL OR APPROVED EQUAL. CONTRACTOR TO SUBMIT PLANTING SOIL SAMPLE FOR LANDSCAPE ARCHITECT'S APPROVAL.
- 18. ALL PLANT MATERIAL SHALL BE FLORIDA NO. 1 OR BETTERAS SET FORTH IN THE FLORIDA DEPARTMENT OF AGRICULTURE 'GRADES AND STANDARDS FOR NURSERY PLANTS" SECOND EDITION FEB. 1998 INCLUDING REVISIONS AND WHICH MEET OR EXCEED THE SIZES INDICATED IN THE PLANTING SCHEDULE AND DETAILS.
- 19. ALL TREES SHALL BE STAKED IN A GOOD WORKMANLIKE MANNER. NO NAIL STAKING PERMITTED. (REFER TO BRACING NOTES AND PLANTING DETAILS)
- 20. AFTER REMOVAL OR RELOCATION OF EXISTING TREES AND PALMS, ALL REMAINING HOLES SHALL BE BACK FILLED AROUND AND UNDER ROOT BALL WITH WASHED BEACH SAND. SOD DISTURBED AREA, IF REQUIRED. ALL SHRUB BEDS TO BE INSTALLED WITH WASHED BEACH SAND. (SEE SPEC)
- 21. ALL TREES, PALMS, SHRUBS AND GROUND COVER PLANTS SHALL BE FERTILIZED AT INSTALLATION. WITH LONG LASTING FERTILIZER, ACCORDING TO MANUFACTURERS' RECOMMENDATIONS AND BASED ON SOIL TESTS OF EXISTING ON-SITE SOILS.
- 22. ALL EXISTING PLANT MATERIAL TO REMAIN, SHALL BE PROTECTED DURING ALL CONSTRUCTION PHASES. ANY PLANT MATERIAL SCARRED OR DESTROYED DESIGNATED TO REMAIN MUST BE REPLACED AT THE CONTRACTOR'S EXPENSE WITH SIMILAR SPECIES SIZE AND QUALITY.
- 23. ALL TREES ON SOD AREA SHALL RECEIVE A HARDWOOD / PINE NEEDLE MULCH MIX RING 2' IN DIAMETER TYPICAL. MULCH TO BE APPROVED BY LANDSCAPE ARCHITECT PRIOR TO PURCHASE AND/OR INSTALLATION.
- 24. ALL PLANTING AREAS SHALL BE MULCHED WITH SHREDDED ORGANIC MULCH TO A MINIMUM OF 3"; WITH THE EXCEPTION OF BEACH PLANTING. DO NOT USE CYPRESS OR RED MULCH
- 25. ALL TREES SHALL HAVE 2" CALIPER AT D.B.H. MINIMUM FOR A 10' HEIGHT TREE, UNLESS NOTED OTHERWISE.
- 26. ALL 1 GALLON MATERIAL SHALL HAVE 12" SPREAD MINIMUM, ALL 3 GALLON MATERIAL TO HAVE 20-24" SPREAD MINIMUM.
- 27. ALL PLANTING AREAS WITHIN THE LIMITS OF WORK SHALL RECEIVE 100% COVERAGE BY AUTOMATIC IRRIGATION SYSTEM (DRIP PREFERRED) UNLESS OTHERWISE DIRECTED BY OWNER. SEE

IRRIGATION PLANS FOR ADDITIONAL SPECIFICATIONS.

- 28. LANDSCAPE CONTRACTOR TO COORDINATE INSTALLATION OF IRRIGATION SYSTEM WITH IRRIGATION CONTRACTOR. IRRIGATION TIME CLOCK TO BE HARD WIRED ON COMPLETION - RESPONSIBILITY OF IRRIGATION CONTRACTOR. LANDSCAPE CONTRACTOR SHALL HAND WATER OR ARRANGE FOR WATERING DURING PLANTING UNTIL IRRIGATION SYSTEM IS 100% OPERABLE. THIS IS THE RESPONSIBILITY OF THE LANDSCAPE CONTRACTOR.
- 29. LANDSCAPE CONTRACTOR SHALL COORDINATE HIS WORK WITH ALL OTHER APPROPRIATE CONTRACTORS.
- 30. THE LANDSCAPE CONTRACTOR SHALL AT ALL TIMES KEEP THE JOB SITE CLEAN AND FREE FROM ACCUMULATION OF WASTE MATERIAL, DEBRIS, AND RUBBISH.
- 31. LANDSCAPE PLAN SHALL BE INSTALLED IN COMPLIANCE WITH ALL LOCAL CODES.
- 32. ON-SITE LAYOUT OF PLANT MATERIAL SHALL BE COORDINATED WITH LANDSCAPE ARCHITECT AT THE TIME OF INSTALLATION.
- 33. ALL PLANTS, MATERIALS, WORKMANSHIP, AND INVOICE APPROVAL ARE SUBJECT TO THE APPROVAL OF THE LANDSCAPE ARCHITECT.
- 34. CONTRACTOR TO FLAG ALL PROPOSED TREE AND PALM LOCATIONS FOR OWNER AND LANDSCAPE ARCHITECT'S APPROVAL PRIOR TO EXCAVATION OR INSTALLATION. PLAN LOCATIONS ARE SUBJECT TO FIELD ADJUSTMENTS BY THE LANDSCAPE ARCHITECT.
- 35. LANDSCAPE ARCHITECT TO APPROVE ALL SHRUB AND GROUNDCOVER PLANTING LOCATION AND LAYOUT PRIOR TO INSTALLATION
- 36. CONTRACTOR SHALL PROVIDE DIGITAL PHOTOGRAPHIC DOCUMENTATION DURING INSTALLATION FOR LANDSCAPE ARCHITECT'S REVIEW, DAILEY.
- 37. LANDSCAPE CONTRACTOR TO INSURE ALL PLANT MATERIAL IS INSTALLED AT THE CORRECT ELEVATION, REFER TO GRADING PLAN.
- 38. THE LANDSCAPE CONTRACTOR SHALL MAINTAIN OR COORDINATE WITH THE IRRIGATION CONTRACTOR AND LANDSCAPING MAINTENANCE SERVICES ALL PLANTING INCLUDING WATERING, MOWING, MULCHING, WEED, AND PEST CONTROL UNTIL FINAL ACCEPTANCE BY THE LANDSCAPE ARCHITECT AND OWNER.
- 39. THE AWARDED LANDSCAPE CONTRACTOR SHALL SUBMIT A PROPOSED BID / CONTRACT WITH PRICING FOR ALL PLANT MATERIAL INCLUDING (WARRANTY, LABOR, TRANSPORTATION, RELOCATION, SITE MAINTENANCE AND PREPARATION) AS PER THE LANDSCAPE ARCHITECT'S SPECIFICATIONS AND OR PLANTING PLANS.
- 40. THE LANDSCAPE CONTRACTOR'S CONTRACT SHALL ACKNOWLEDGE ALL TERMS AND CONDITIONS SET FORTH UNDER THESE GENERAL LANDSCAPE NOTES AND SPECIFICATIONS.
- 41. THESE DRAWINGS, DOCUMENTS, AND ALL CONTENTS ARE THE PROPERTY OF RAYMOND JUNGLES, INC. ALL RIGHTS ARE RESERVED. UNAUTHORIZED USE OR PRODUCTION. IN PART OR WHOLE. FOR ANY PURPOSE IS UNLAWFUL AND PROHIBITED EXCEPT BY EXPRESS WRITTEN CONSENT
- 42. THE CONTRACTOR IS RESPONSIBLE FOR OBTAINING ANY PERMITS OR APPROVALS FROM THE FEDERAL. STATE OR LOCAL GOVERNMENT REQUIRED FOR THE WORK INCLUDED IN THIS CONTRACT AND ON THESE DRAWINGS.
- 43. PLANT SHRUBS IN CIRCULAR PITS WITH A DIAMETER 16" GREATER THAN ROOTBALL OR CONTAINER PLANT TREES IN CIRCULAR PITS WITH A DIAMETER 36" GREATER THAN ROOTBALL OR CONTAINER. PLACE PLANTS WITH BEST "FACE" FORWARD.
- 44. BACKFILL ALL PLANTING PITS WITH THE FOLLOWING MIXTURE; $\frac{1}{2}$ ONSITE SOIL, $\frac{1}{2}$ CLEAN FRIABLE TOPSOIL. SUBMIT TOPSOIL SAMPLE AND SOIL TEST ANALYSIS FOR APPROVAL BY LANDSCAPE ARCHITECT, (SEE PLANTING DETAILS). REMOVE EXCESS SOIL EXCAVATED FROM PLANT PIT FROM THE SITE OR DISTRIBUTE ON-SITE AS DIRECTED BY L.A.
- 45. VERIFY ALL QUANTITIES IN THE PLANTING SCHEDULE AND INSTALL ALL PLANTS AND MATERIALS AS INDICATED IN THE PLAN. PROVIDE COMPOSITE UNIT PRICES FOR EACH PLANT, WHICH INCLUDE ALL OTHER INCIDENTAL MATERIALS, (I.E. MULCH, FERTILIZER, TOPSOIL, LABOR, ETC.)
- 46. NOTIFY THE OWNER AND LANDSCAPE ARCHITECT OF ANY UNFORESEEN CONDITIONS, I.E. COMPACTED SOIL / SUBGRADE, POOR DRAINAGE, UNCONSOLIDATED SOIL, EROSION, UTILITY CONFLICTS, EXCESSIVE SUN OR SHADE, ETC., PRIOR TO PROCEEDING WITH LANDSCAPE INSTALLATION.
- 47. ALL PLANTS, MATERIALS AND WORKMANSHIP ARE SUBJECT TO THE APPROVAL OF THE LANDSCAPE ARCHITECT AND OWNER.

GENERAL TREE BRACING NOTES AND SPECIFICATIONS:

TREES AND PALMS GREATER THAN 6" DBH TO BE BRACED WITH PROPS:

- 1. CHOOSE THE CORRECT SIZE, LENGTH, AND NUMBER OF PROPS TO BE USED (PRESSURE TREATED (PT), TIMBER BAMBOO (GUADUA ANGUSTIFOLIA) 3" DIA.).
- 2. ALL (PRESSURE TREATED (PT) 2"X4", 4"X4"). STAKES SHALL BE PAINTED AS SPECIFIED BY THE LANDSCAPE ARCHITECT. WRAP AT LEAST 5 LAYERS OF BURLAP AROUND TRUNK OF THE PALM AT LEAST 4 INCHES WIDER THAN THE BATTENS BEING USED. BATTENS SHOULD BE MOUNTED AT A POINT 1/3 OF THE DISTANCE FROM GROUND TO THE CLEAR TRUNK OF THE TREE OR PALM, BUT NOT LESS THAN 4 FEET, WHICHEVER IS GREATER.
- 3. SELECT THE PROPER LENGTH AND SIZE OF BATTENS (PT 2"X4"X12"-16")
- USE THE SAME NUMBER OF BATTENS AS PROPS BEING USED.
- 5. PLACE THE BATTENS VERTICALLY AND EVENLY SPACED AGAINST THE BURLAP.
- 6. SECURE THE BATTENS IN PLACE WITH METAL OR PLASTIC BANDING STRAPS. DO NOT NAIL TREE
- 7. WEDGE LOWER END OF PROP INTO SOIL AND SECURE WITH A 2"X4"X30" STAKE. PROPS SHOULD BE INSTALLED AT A 30 TO 40 DEGREE ANGLE FROM THE BATTENS AND OF SUFFICIENT LENGTH TO REACH THE GROUND. NOTE: ON STRAIGHT TREES OR PALMS OR TREES. SPACE PROPS EQUAL DISTANCE AROUND TREE OR PALM ON CURVED (CHARACTER) PALMS OR TREES, SPACE PROPS AGAINST THE FRONT OF THE CURVE OF THE PALM.
- 8. CUT A SMOOTH ANGLE AT THE END OF THE PROPS. ALIGN WITH AND NAIL INTO BATTENS. DO NOT PENETRATE TREE OR PALM WITH NAILS.
- 9. IF IT APPEARS THAT ADDITIONAL CONSTRUCTION WORK WILL TAKE PLACE NEAR TO OR IN THE VICINITY OF THE NEWLY BRACED TREES OR PALMS, THEN PROPS ARE TO BE CLEARLY LABELED WITH THE STATEMENT, "DO NOT REMOVE."
- 10. PROPS ARE NOT TO BE REMOVED UNTIL APPROVED BY THE LANDSCAPE CONTRACTOR.

TREES AND PALMS LESS THAN 6" DBH TO BE BRACED BY GUYING:

- CHOOSE THE CORRECT SIZE AND NUMBER OF STAKES AND SIZE OF SLEEVE AND WIRE. GUYING SHALL BE COMPLETED WITHIN 48 HOURS OF PLANTING THE TREE.
- 2. CUT LENGTHS OF STAKING SLEEVE TO EXTEND 2 INCHES PAST TREE TRUNK WHEN WRAPPING AROUND.
- 3. SPACE STAKES EVENLY ON OUTSIDE OF WATER RING AND DRIVE EACH FIRMLY INTO THE GROUND. STAKES SHOULD BE DRIVEN AT A 30 DEGREE ANGLE WITH THE POINT OF THE STAKE TOWARD THE TREE UNTIL 4 TO 5 INCHES ARE LEFT SHOWING.
- 4. PLACE THE SLEEVE AROUND THE TRUNK JUST ABOVE THE LOWEST BRANCH
- 5. THREAD THE WIRE THROUGH THE SLEEVE AND PAST THE STAKE, ALLOWING APPROXIMATELY 2 FEET OF EACH OF THE TWO ENDS BEYOND THE STAKE BEFORE **CUTTING THE WIRE**
- 6. TWIST WIRE AT RUBBER SLEEVE TO KEEP IT IN PLACE
- 7. PULL WIRE DOWN AND WIND BOTH ENDS AROUND STAKE TWICE. TWIST WIRE BACK ONTO ITSELF TO SECURE IT BEFORE CUTTING OFF THE EXCESS.
- 8. THE ABOVE PROCEDURES ARE TO BE FOLLOWED FOR EACH STAKE. KEEPING THE TREE STRAIGHT AT ALL TIMES.
- 9. THERE SHOULD BE A 1 TO 3 INCH SWAY IN THE TREE (THE WIRES SHOULD NOT BE PULLED TIGHT) FOR BEST ESTABLISHMENT.
- 10. FLAG THE GUY WIRES WITH SURVEYOR'S FLAGGING OR APPROVED EQUAL FOR SAFETY.
- ANY WIRES ARE NOT TO BE REMOVED UNTIL APPROVED BY LANDSCAPE ARCHITECT.

RAYMOND JUNGLES INC

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PROJECT NO.: 21047

Landscape Architect FASLA

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1 11/08/2021 Revised DRB Final Submittal No. Date Description

LANDSCAPE ARCHITECT: Raymond Jungle



PLANTING NOTES

SHEET TITLE:


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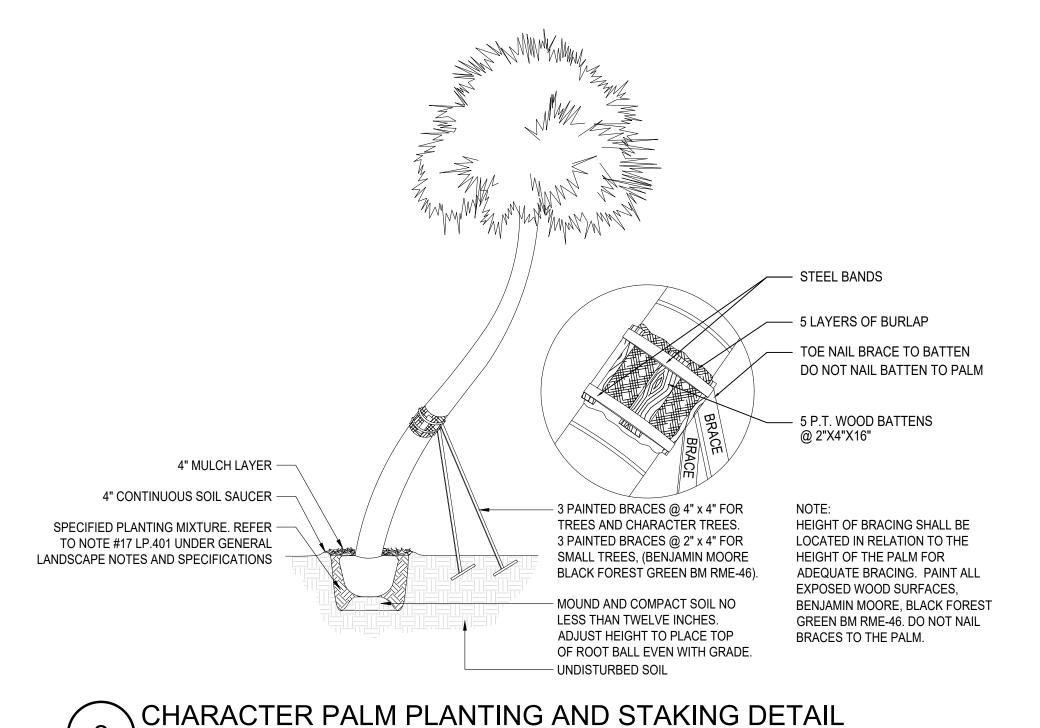
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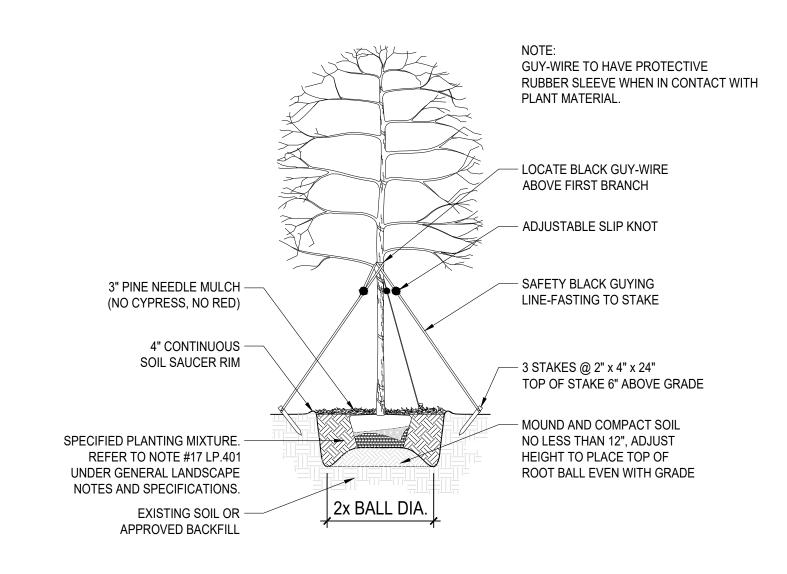
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Date: 08-02-2021

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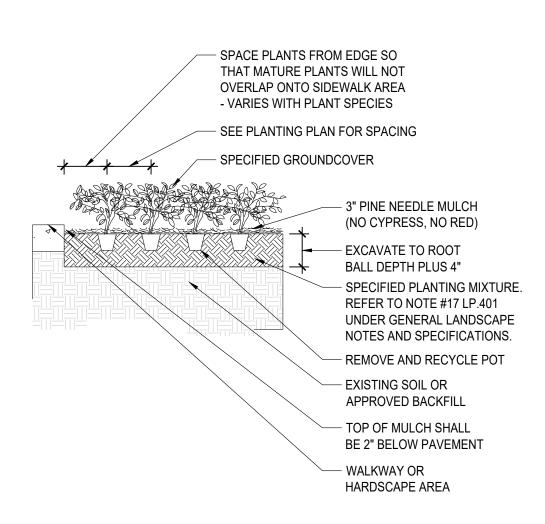


3 UNDERSTORY TREE PLANTING AND STAKING DETAIL SCALE: NTS

LOOSEN & SCORE BOUND ROOTS REMOVE POT AND RECYCLE - 3" PINE NEEDLE MULCH (NO CYPRESS, NO RED) 3" CONTINUOUS SOIL SAUCER RIM EXISTING SOIL OR APPROVED BACKFILI SPECIFIED PLANTING MIXTURE. REFER TO NOTE #17 LP.401 UNDER GENERAL LANDSCAPE NOTES AND SPECIFICATIONS. MOUND AND COMPACT SOIL 2x BALL DIA. NO LESS THAN 6", ADJUST HEIGHT TO PLACE TOP OF ROOT BALL EVEN WITH GRADE

6 SHRUB PLANTING DETAIL

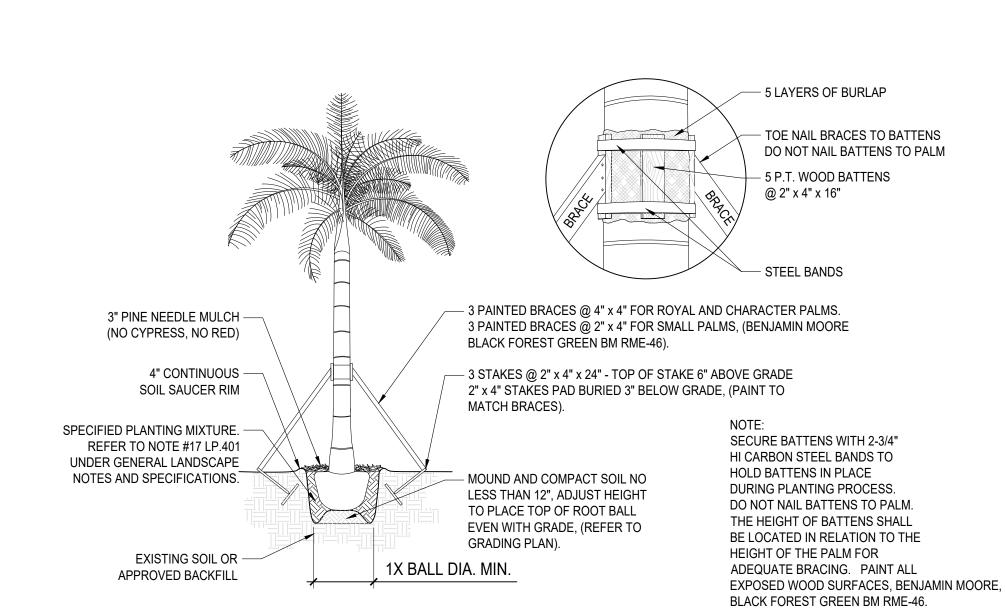
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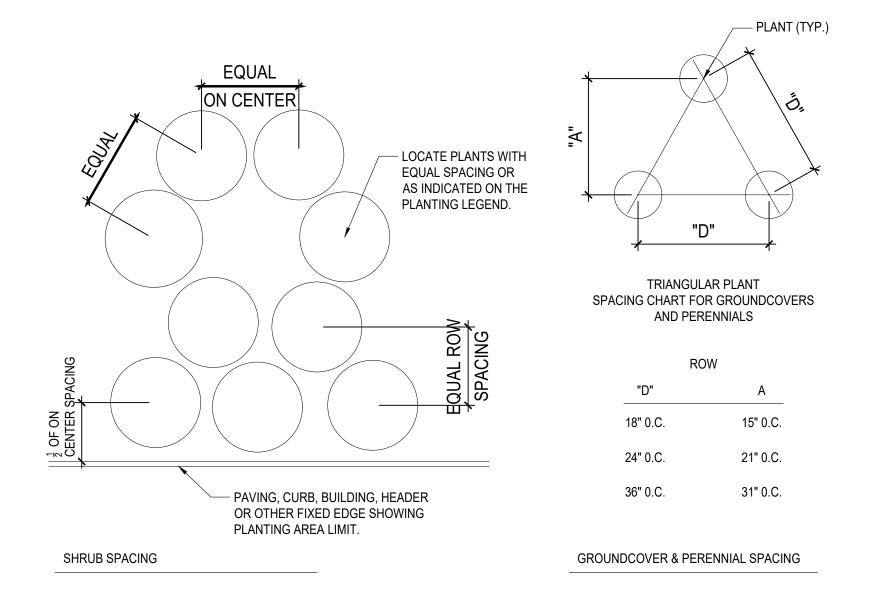
7 GROUND COVER PLANTING DETAIL

SCALE: NTS







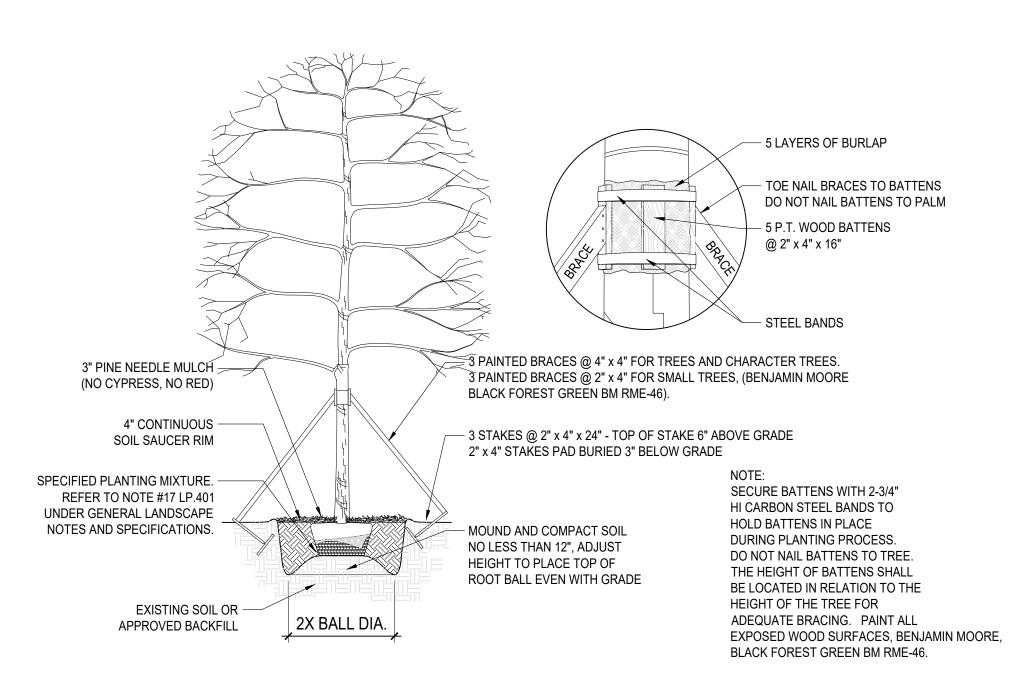

5 PLANT & SHRUB SPACING DETAIL
SCALE: NTS

SCALE: NTS



No. Date Description

SHEET TITLE:

Drawn By: CB

Checked By: GCH Date: 08-02-2021

SHEET NUMBER:

LANDSCAPE ARCHITECT: Raymond Jungles

PLANTING DETAILS

AND SPECIFICATIONS

LP.401

DRABEFINAL SUBMITTAL

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