- 1649 W 22ND STREET - MIAMI BEACH, FL

FINAL DRB SUBMITTAL

SHEET INDEX

	PRICE RESIDENCE SHEET INDEX	X = SHEET	X = SHEET SUBMITTED			• = SHEET REVISED		
SHEET#		1ST SUE	BMITTAL SUI		DRB FINAL SUBMITTAL 09/03/2021			
L-0	COVER SHEET AND SHEET INDEX	Х		X				
L-1	TREE DISPOSITION PLAN	X		X				
L-1.1	TREE DISPOSITION AND MITIGATION SCHEDULE	X		X				
L-1.2	TREE MITIGATION PLANTING PLAN	Х		X				
L-2	OVERALL SITE PLAN	Х		X				
L-5	CANOPY PLANTING PLAN	Х		Х				
L-5.1	UNDERSTORY PLANTING PLAN	х		X				
L-5.2	PLANTING SCHEDULES, LEGEND + OPEN SPACE DIAGRAM	х		X				
L-5.3	PLANTING DETAILS	х		X				
L-5.4	GENERAL LANDSCAPE NOTES	Х		Х				



PRICE RESIDENCE MIAMI BEACH, FL

SITE ADDRESS:

1649 W 22ND STREET MIAMI BEACH, FL 33140

LANDSCAPE ARCHITECT:

8020 NE 4TH AVE, STUDIO 113 MIAMI, FL 33138 (786) 536-6076 INFO@CLADLANDSCAPE.COM

SEAL:

Carolina
Digitally signed
by Carolina
Monteiro
Date: 2021.09.03
09:43:44 -04'00'

CAROLINA MONTEIRO DA SILVA REGISTERED LANDSCAPE ARCHITECT LA6667311

DRAWING TITLE:

COVER SHEET
+
INDEX

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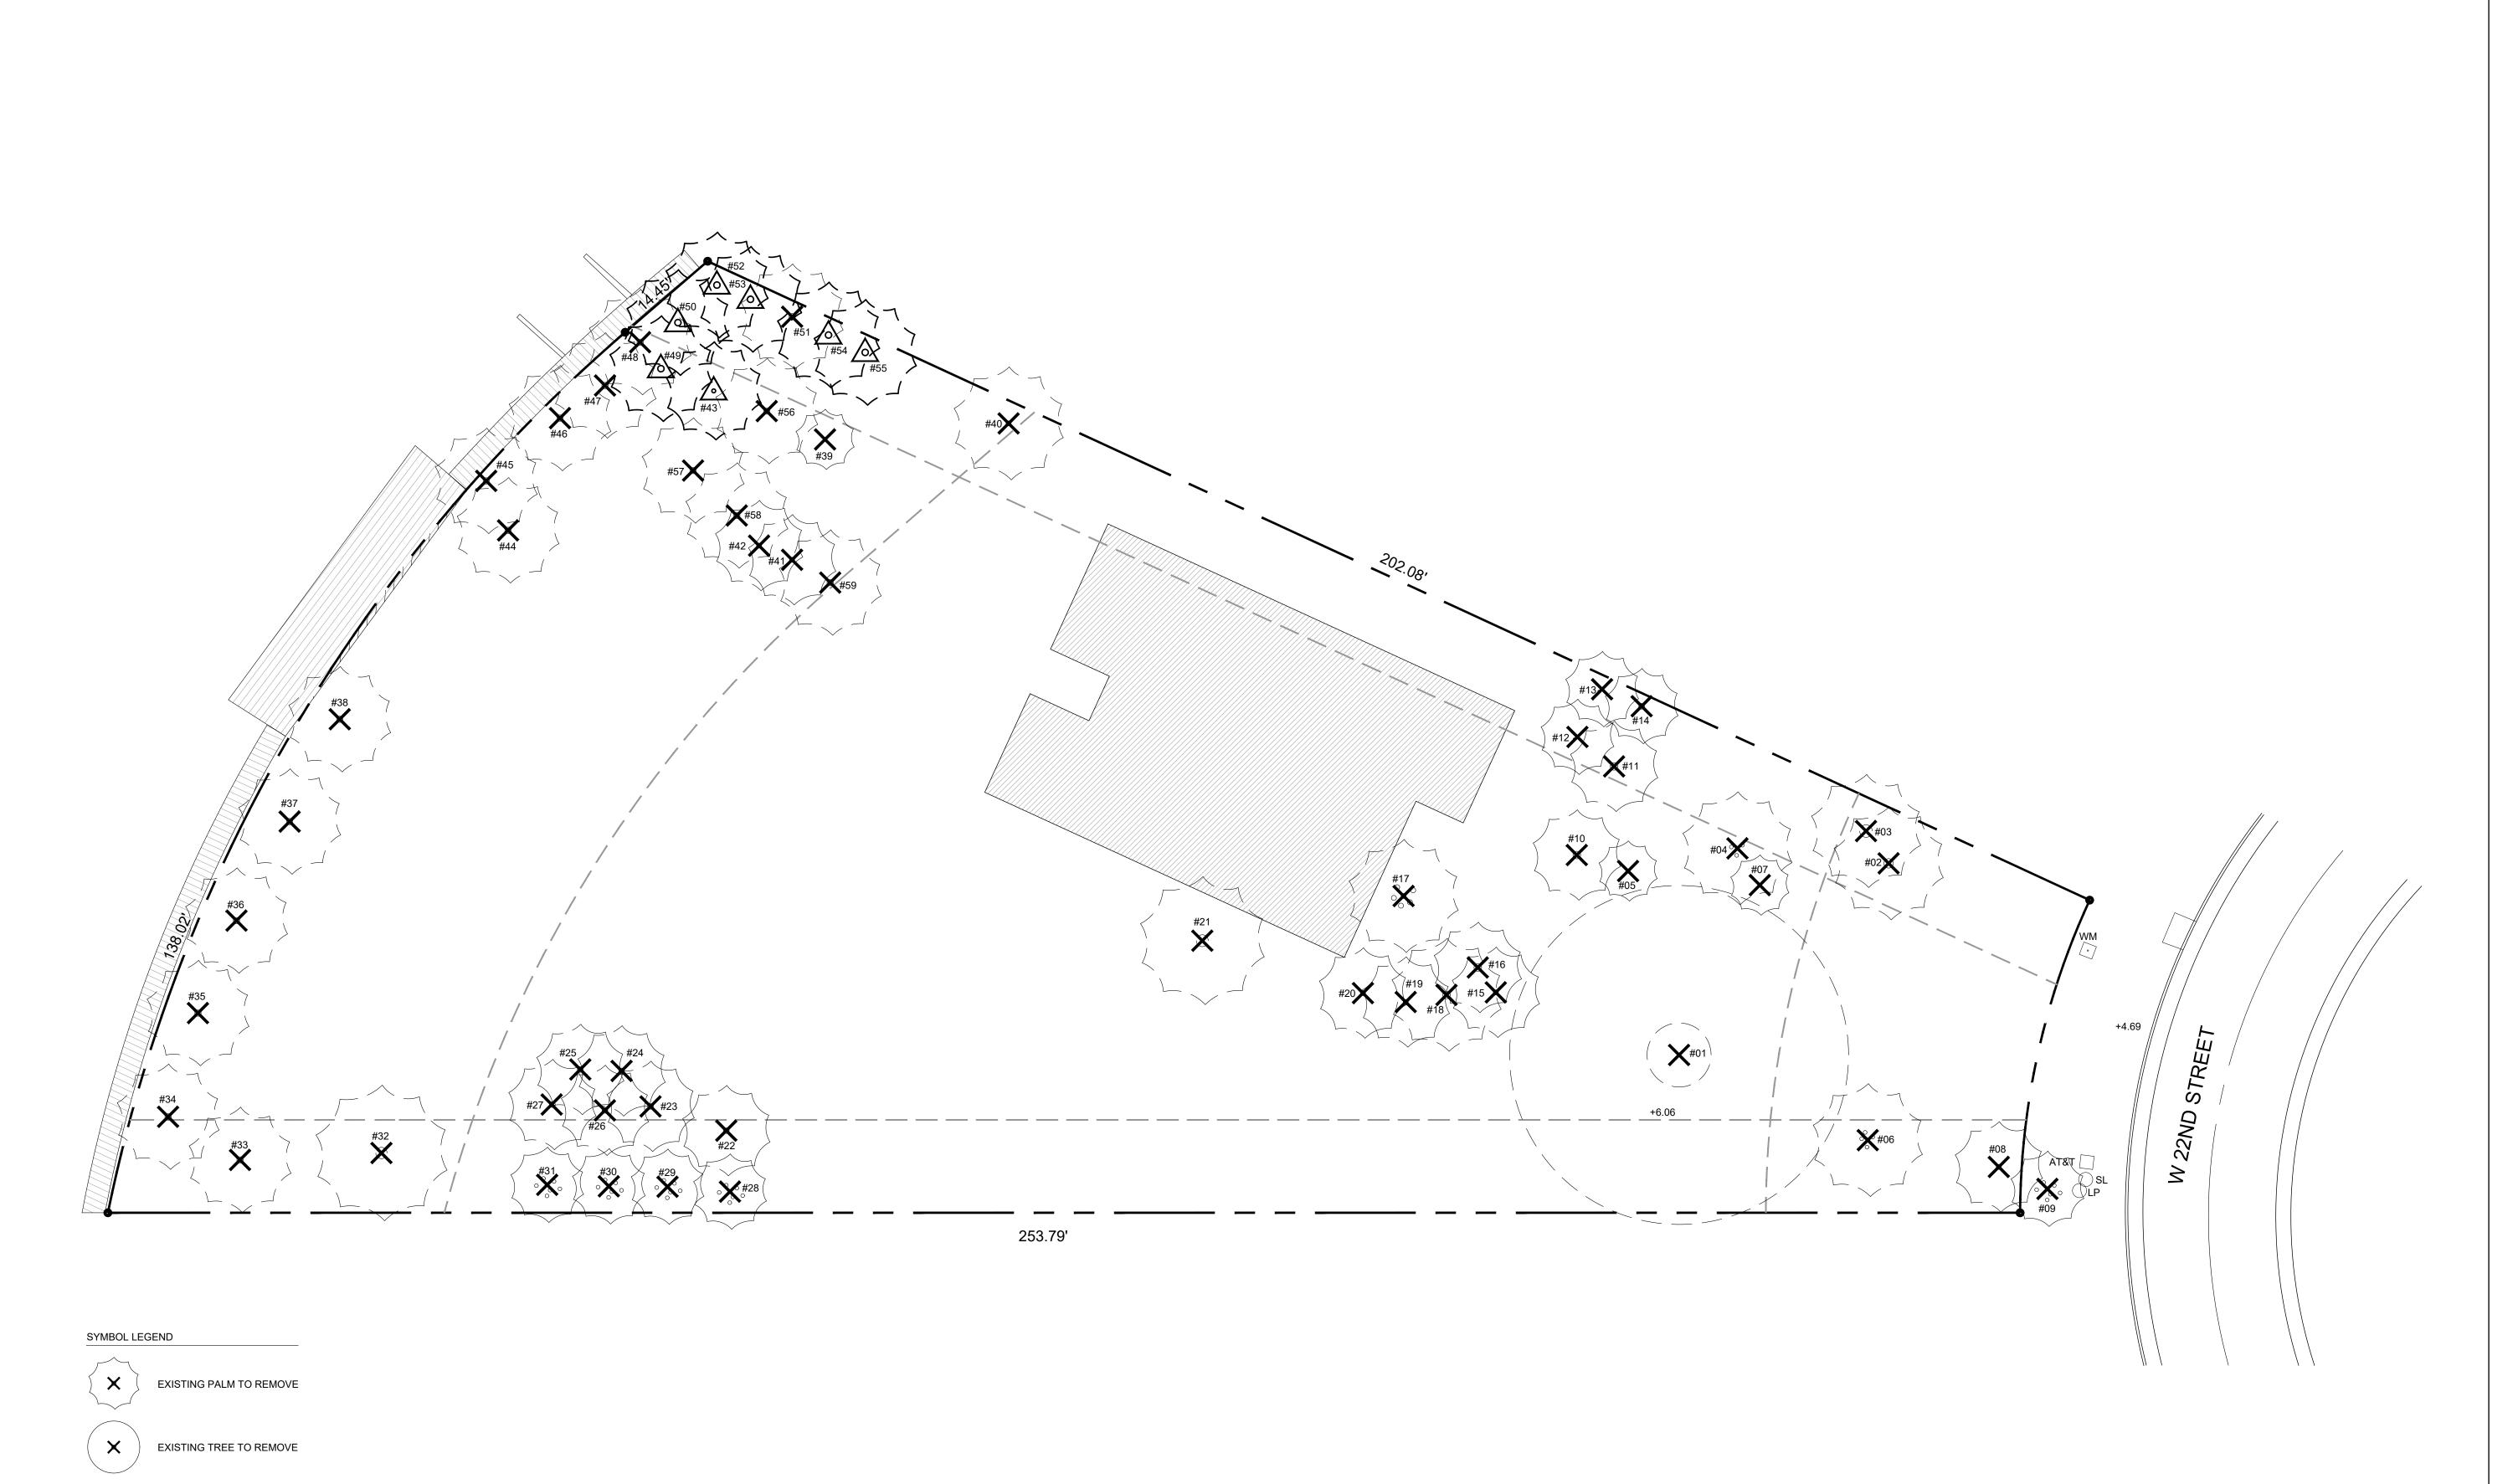
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DRB 1ST SUBMITTAL

FINAL DRB SUBMITTAL 09/03/21

SCALE

PROJ. N°: 2114 SHEET N°:





SITE ADDRESS:

1649 W 22ND STREET MIAMI BEACH, FL 33140

LANDSCAPE ARCHITECT:

CLAD 8020 NE 4TH AVE, STUDIO 113 MIAMI, FL 33138 (786) 536-6076 INFO@CLADLANDSCAPE.COM

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Carolina Digitally signed by Carolina Monteiro Date: 2021.09.03 09:45:18 -04'00'

CAROLINA MONTEIRO DA SILVA REGISTERED LANDSCAPE ARCHITECT LA6667311

DRAWING TITLE:

TREE DISPOSITION PLAN

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DRB 1ST SUBMITTAL 08/16/21

FINAL DRB SUBMITTAL 09/03/21

DATE

SCALE: 3/32" = 1'-0"

PROJ. N°: 2114 SHEET N°: **L-1**

22" = 1'-0"

			PRICE RESID	ENCE - IREE	DISPOSITION	SCHEDULE				
NEW #	SCIENTIFIC NAME	COMMON NAME	DBH (IN)	HEIGHT (FT)	SPREAD (FT)	CONDITION	DISPOSITION	NOTES	PALMS REMOVED	DBH (IN
1	Pithecellobium dulce	MANILA TAMARIND	51	50	45	FAIR	REMOVE	SPECIMEN		51
2	Roystonea regia	ROYAL PALM	15	40	15	FAIR	REMOVE		1	
3	Roystonea regia	ROYAL PALM	20	40	15	GOOD	REMOVE		1	
4	Adonidia merrillii	CHRISTMAS PALMS (4)	6 EACH	25	15	GOOD	REMOVE		1	
5	Adonidia merrillii	CHRISTMAS PALM	6	25	8	GOOD	REMOVE		1	
6	Adonidia merrillii	CHRISTMAS PALMS (5)	6 EACH	25	15	GOOD	REMOVE		1	
7	Ptychosperma elegans	ALEXANDER PALM	3	28	8	FAIR	REMOVE		1	
8	Livistona chinensis	CHINESE FAN PALM	8	25	12	GOOD	REMOVE	WAIVED**		
9	Dypsis lutescens	ARECA PALM	CLUSTER	24	10	GOOD	REMOVE	NOT REGULATED*		
10	Livistona chinensis	CHINESE FAN PALM	12	14	12	GOOD	REMOVE	WAIVED**		
11	Livistona chinensis	CHINESE FAN PALM	12	15	12	GOOD	REMOVE	WAIVED**		
12	Ptychosperma elegans	ALEXANDER PALM (TRIPLE)	3 EACH	20	10	GOOD	REMOVE		1	
13	Ptychosperma elegans	ALEXANDER PALM (DOUBLE)	3 EACH	25	10	GOOD	REMOVE		1	
14	Ravenala madagascariensis	TRAVELER'S PALM	10	25	10	POOR	REMOVE	NOT REGULATED*		
	Livistona chinensis	CHINESE FAN PALM	8	25	12	GOOD	REMOVE	WAIVED**		
16	Livistona chinensis	CHINESE FAN PALM	12	17	12	GOOD	REMOVE	WAIVED**		+
	Phoenix reclinata	SENEGAL DATE PALM	CLUSTER	25	15	POOR	REMOVE	NOT REGULATED*		+
	Livistona chinensis	CHINESE FAN PALM	12	14	15	GOOD	REMOVE	WAIVED**		+
10011001	Livistona chinensis	CHINESE FAN PALM	8	24	12	GOOD	REMOVE	WAIVED**	<u> </u>	+
	Livistona chinensis	CHINESE FAN PALM	8	24	12	FAIR	REMOVE	WAIVED**		
	Phoenix canariensis	CANARY ISLAND DATE PALM	19	20	17	FAIR	REMOVE	VVAIVED	1	+
	Livistona chinensis	CHINESE FAN PALM	9	23	12	GOOD	REMOVE	WAIVED**		+
	Livistona chinensis	CHINESE FAN PALM	9	23	12	GOOD	REMOVE	WAIVED**		+
	Livistona chinensis	CHINESE FAN PALM	9	23	12	GOOD	REMOVE	WAIVED**	<u> </u>	+
	Livistona chinensis		9	23	12	GOOD	REMOVE	WAIVED**		+
	Livistona chinensis	CHINESE FAN PALM								+
		CHINESE FAN PALM	9	23	12	GOOD	REMOVE	WAIVED**	<u> </u>	
	Livistona chinensis	CHINESE FAN PALM	9	23	12	GOOD	REMOVE	WAIVED**		
	Dypsis lutescens	ARECA PALM	CLUSTER	23	10	GOOD	REMOVE	NOT REGULATED*		
	Dypsis lutescens	ARECA PALM	CLUSTER	23	10	GOOD	REMOVE	NOT REGULATED*		
	Dypsis lutescens	ARECA PALM	CLUSTER	23	10	GOOD	REMOVE	NOT REGULATED*		
	Dypsis lutescens	ARECA PALM	CLUSTER	23	10	GOOD	REMOVE	NOT REGULATED*		
	Roystonea regia	ROYAL PALM	18	40	18	FAIR	REMOVE		1	
33	Cocos nucifera	COCONUT PALM	10	30	14	FAIR	REMOVE		1	
34	Cocos nucifera	COCONUT PALM	10	30	14	FAIR	REMOVE		1	
	Cocos nucifera	COCONUT PALM	10	30	14	FAIR	REMOVE		1	
	Cocos nucifera	COCONUT PALM	10	30	14	FAIR	REMOVE		1	
	Cocos nucifera	COCONUT PALM	10	30	14	FAIR	REMOVE		1	
38	Cocos nucifera	COCONUT PALM	10	30	14	FAIR	REMOVE		1	
39	Adonidia merrillii	CHRISTMAS PALM	6	23	8	FAIR	REMOVE		1	
40	Livistona chinensis	CHINESE FAN PALM	8	20	15	GOOD	REMOVE	WAIVED**	Į.	
41	Livistona chinensis	CHINESE FAN PALM	8	23	12	GOOD	REMOVE	WAIVED**	1	
42	Livistona chinensis	CHINESE FAN PALM	8	23	12	GOOD	REMOVE	WAIVED**	1	
43	Thrinax radiata	FLORIDA THATCH PALM	6	13	13	GOOD	RELOCATE			
44	Cocos nucifera	COCONUT PALM	10	30	14	FAIR	REMOVE		1	
45	Cocos nucifera	COCONUT PALM	10	30	14	FAIR	REMOVE		1	
46	Cocos nucifera	COCONUT PALM	10	30	14	FAIR	REMOVE		1	
47	Cocos nucifera	COCONUT PALM	10	30	14	FAIR	REMOVE		1	
48	Cocos nucifera	COCONUT PALM	10	30	14	FAIR	REMOVE		1	1
49	Cocos nucifera	COCONUT PALM	10	20	14	GOOD	RELOCATE		_	
50	Cocos nucifera	COCONUT PALM	10	20	14	GOOD	RELOCATE			1
51	Cocos nucifera	COCONUT PALM	10	20	14	GOOD	REMOVE		1	1
	Cocos nucifera	COCONUT PALM	10	30	14	GOOD	RELOCATE			1
	Cocos nucifera	COCONUT PALM	10	30	14	GOOD	RELOCATE			†
	Cocos nucifera	COCONUT PALM	10	30	14	GOOD	RELOCATE			†
	Cocos nucifera	COCONUT PALM	10	30	14	GOOD	RELOCATE			+
	Cocos nucifera	COCONUT PALM	10	30	14	GOOD	REMOVE		1	+
	Cocos nucifera	COCONUT PALM	10	35	14	FAIR	REMOVE		1	+
	Cocos nucifera	COCONUT PALM	10	35	14	FAIR	REMOVE		1	+
	100 F 100 M 100 F	COCONUT PALM	10	35	14	FAIR	REMOVE		1	+
59	Cocos nucifera					1 (4)11)	I INICAL	·		

	TREES USED FOR MITIGATION							
SYM	QTY	SCIENTIFIC NAME	COMMON NAME	NATIVE	NOTES			
DD	1	Diospyrus discolor	VELVET APPLE	N	MIN. 16' HT, 8' SP, 2" CAL			
LL	7	Lysiloma latisliquum	WILD TAMARIND	Y	MIN. 16' HT, 8' SP, 2" CAL			
CR	2	Clusia rosea	PITCH APPLE	Υ	MIN. 16' HT, 8' SP, 2" CAL			
CD	6	Coccoloba diversifolia	PIGEON PLUM	Υ	MIN. 16' HT, 8' SP, 2" CAL			
CW	6	Canella winterana	WILD CINNAMON	Y	MIN. 16' HT, 8' SP, 2" CAL			
GL	6	Gymnanthes lucida	CRABWOOD	Y	MIN. 16' HT, 8' SP, 2" CAL			

TOTAL: 28 TREES USED FOR MITIGATION DIVIDED IN 6 SPECIES 27 NATIVE TREES

TREE MITIGATION:

REMOVAL OF 51" DBH OF TREES + 27 PALMS, EQUIVALENT TO:
47 REPLACEMENT TREES (MIN. 2" CALIPER, 6' CANOPY, 12' HT) REQUIRED, OR
24 REPLACEMENT TREES (MIN. 4" CALIPER, 8' CANOPY, 16' HT) REQUIRED
14 TREES MUST BE NATIVE (30% OF REQUIRED 12' HT TREES)

REQUIRED SPECIES DIVERSITY: 41 OR GREATER: 6 SPECIES

THE CODE IS BEING MET BY USING: 28 REPLACEMENT TREES (MIN. 4" CALIPER, 8' CANOPY, 16' HT)

TREE DISPOSITION SUMMARY							
	TOTAL		REMAIN	REMOVE	RELOCAT		
TREES	1		0	1	0		
PALMS	58		0	51	7		



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LANDSCAPE ARCHITECT:

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CAROLINA MONTEIRO DA SILVA REGISTERED LANDSCAPE ARCHITECT LA6667311

DRAWING TITLE:

TREE DISPOSITION SCHEDULE

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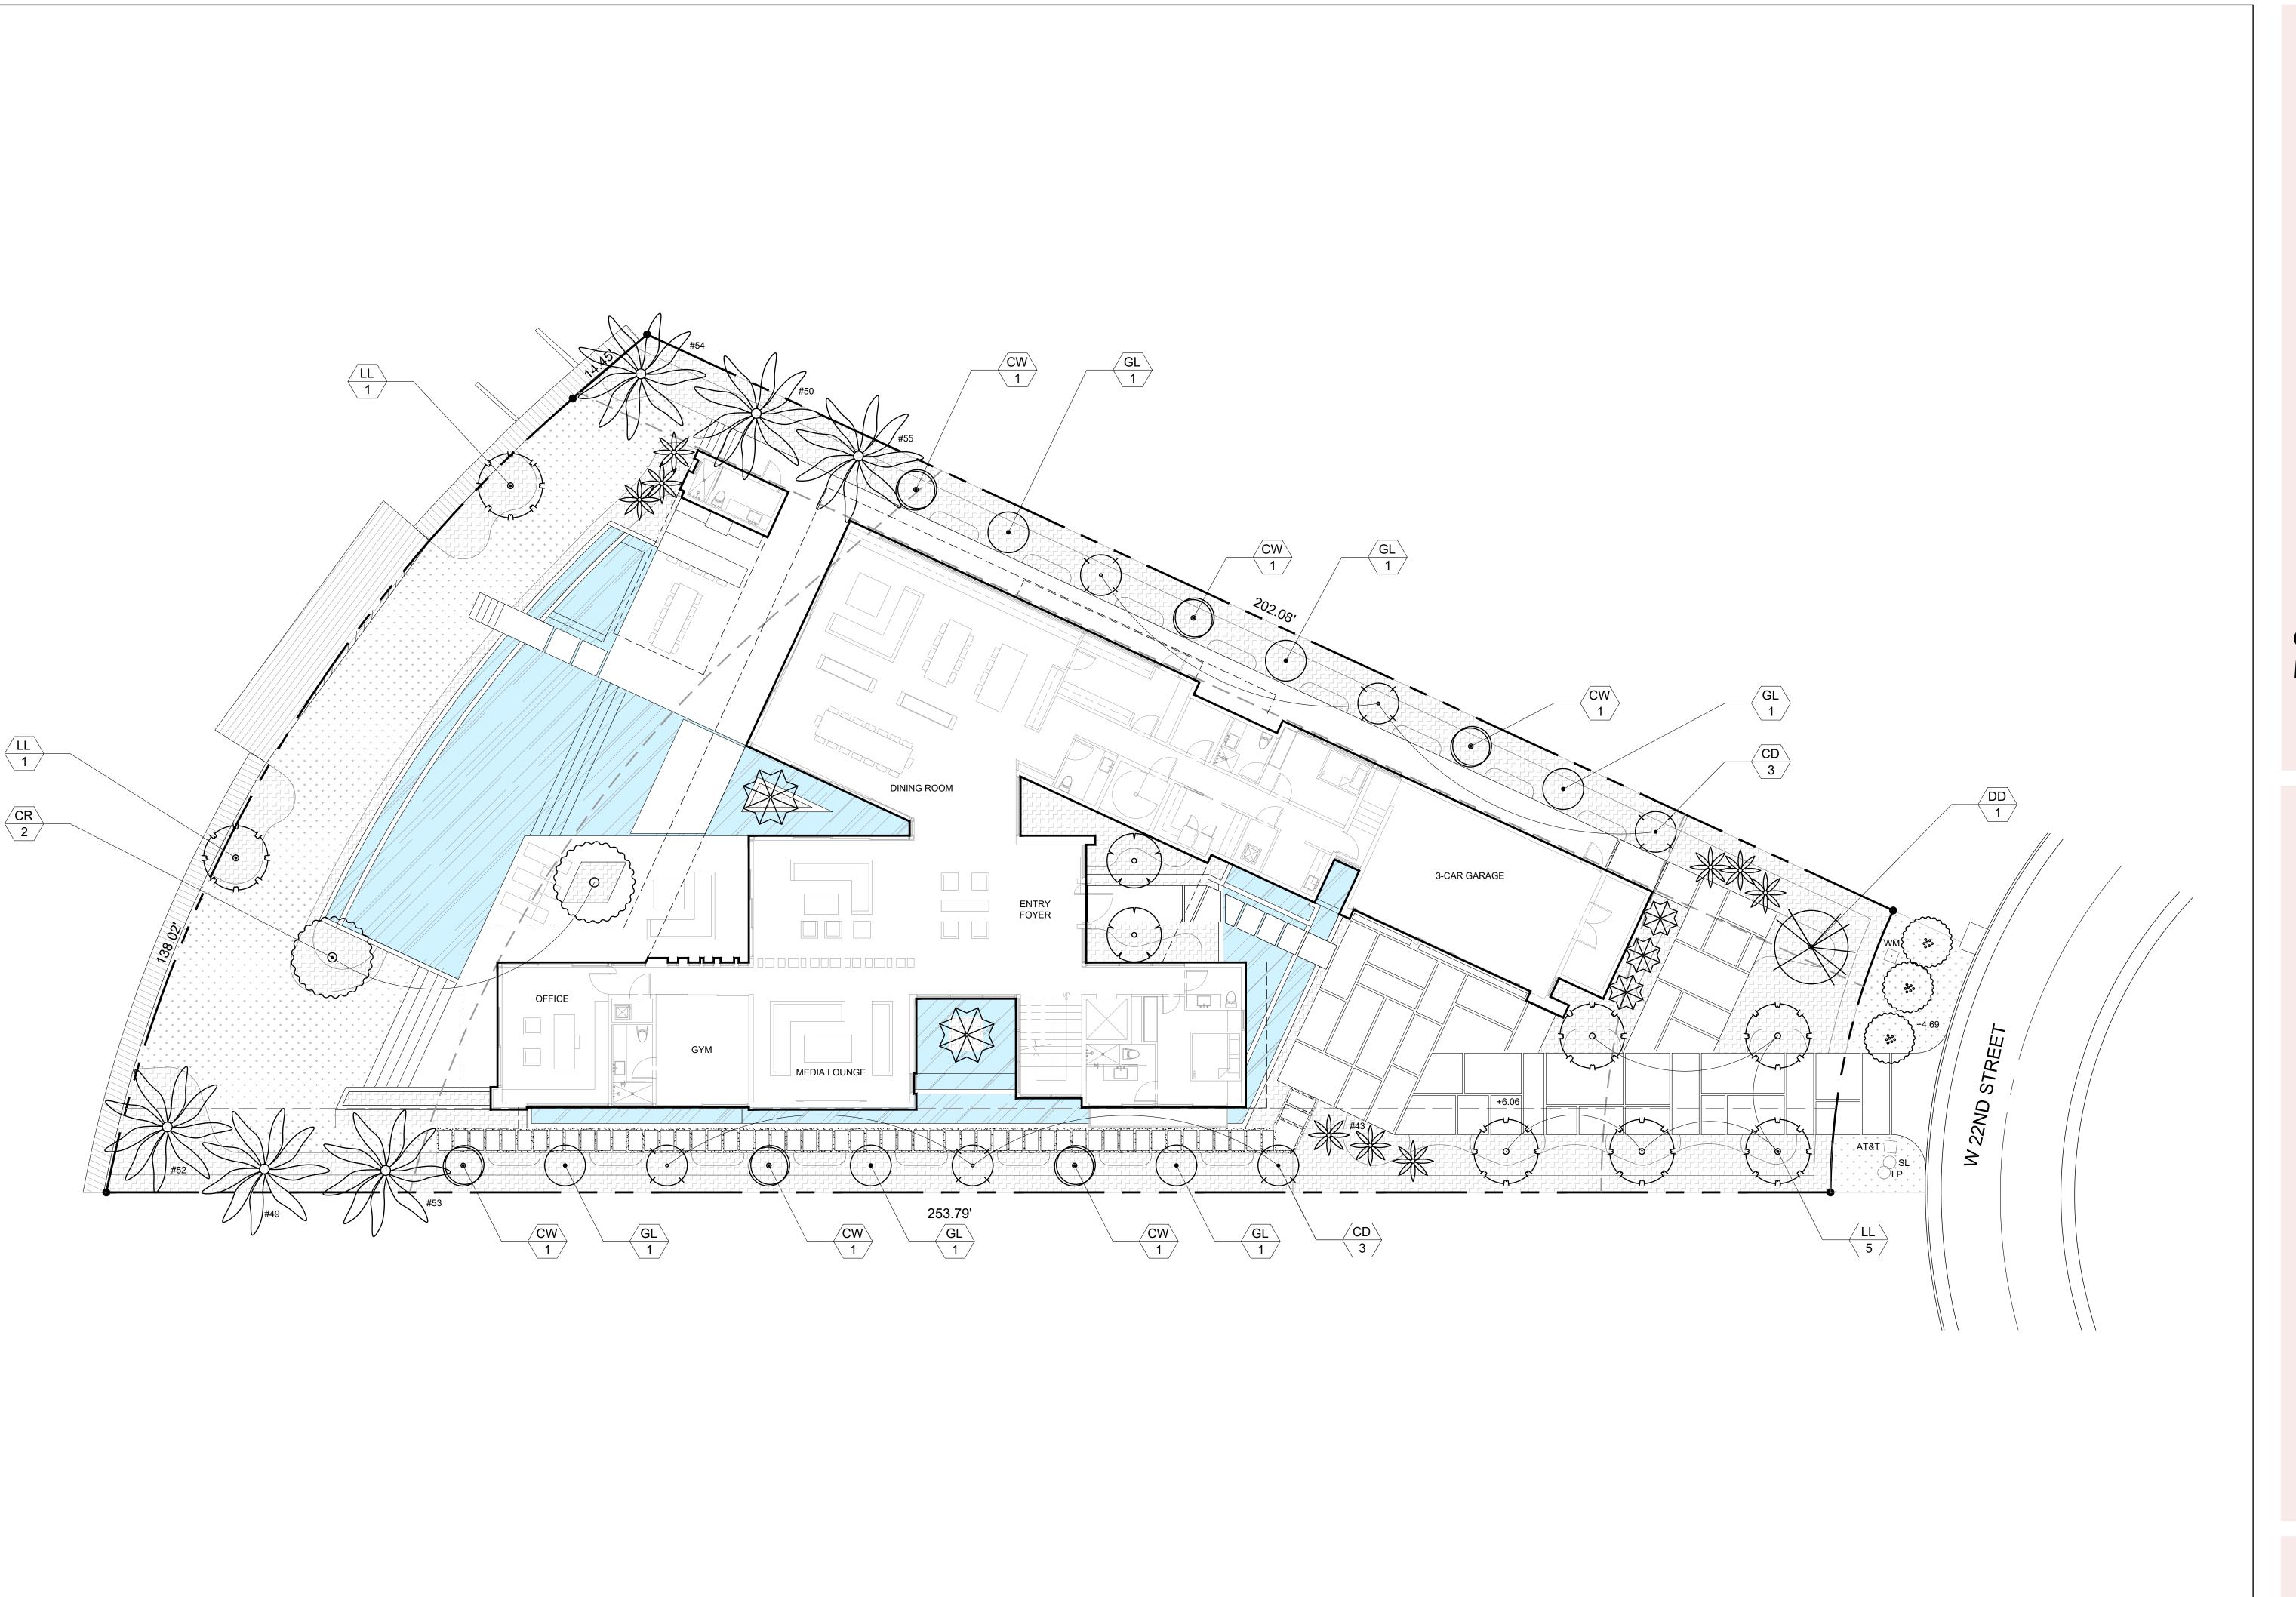
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FINAL DRB SUBMITTAL 09/03/21

DATE

SCALE: 3/32" = 1'-0"

PROJ. N°: 2114 SHEET N°:





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1649 W 22ND STREET MIAMI BEACH, FL 33140

LANDSCAPE ARCHITECT:

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DRAWING TITLE:

TREE MITIGATION PLAN

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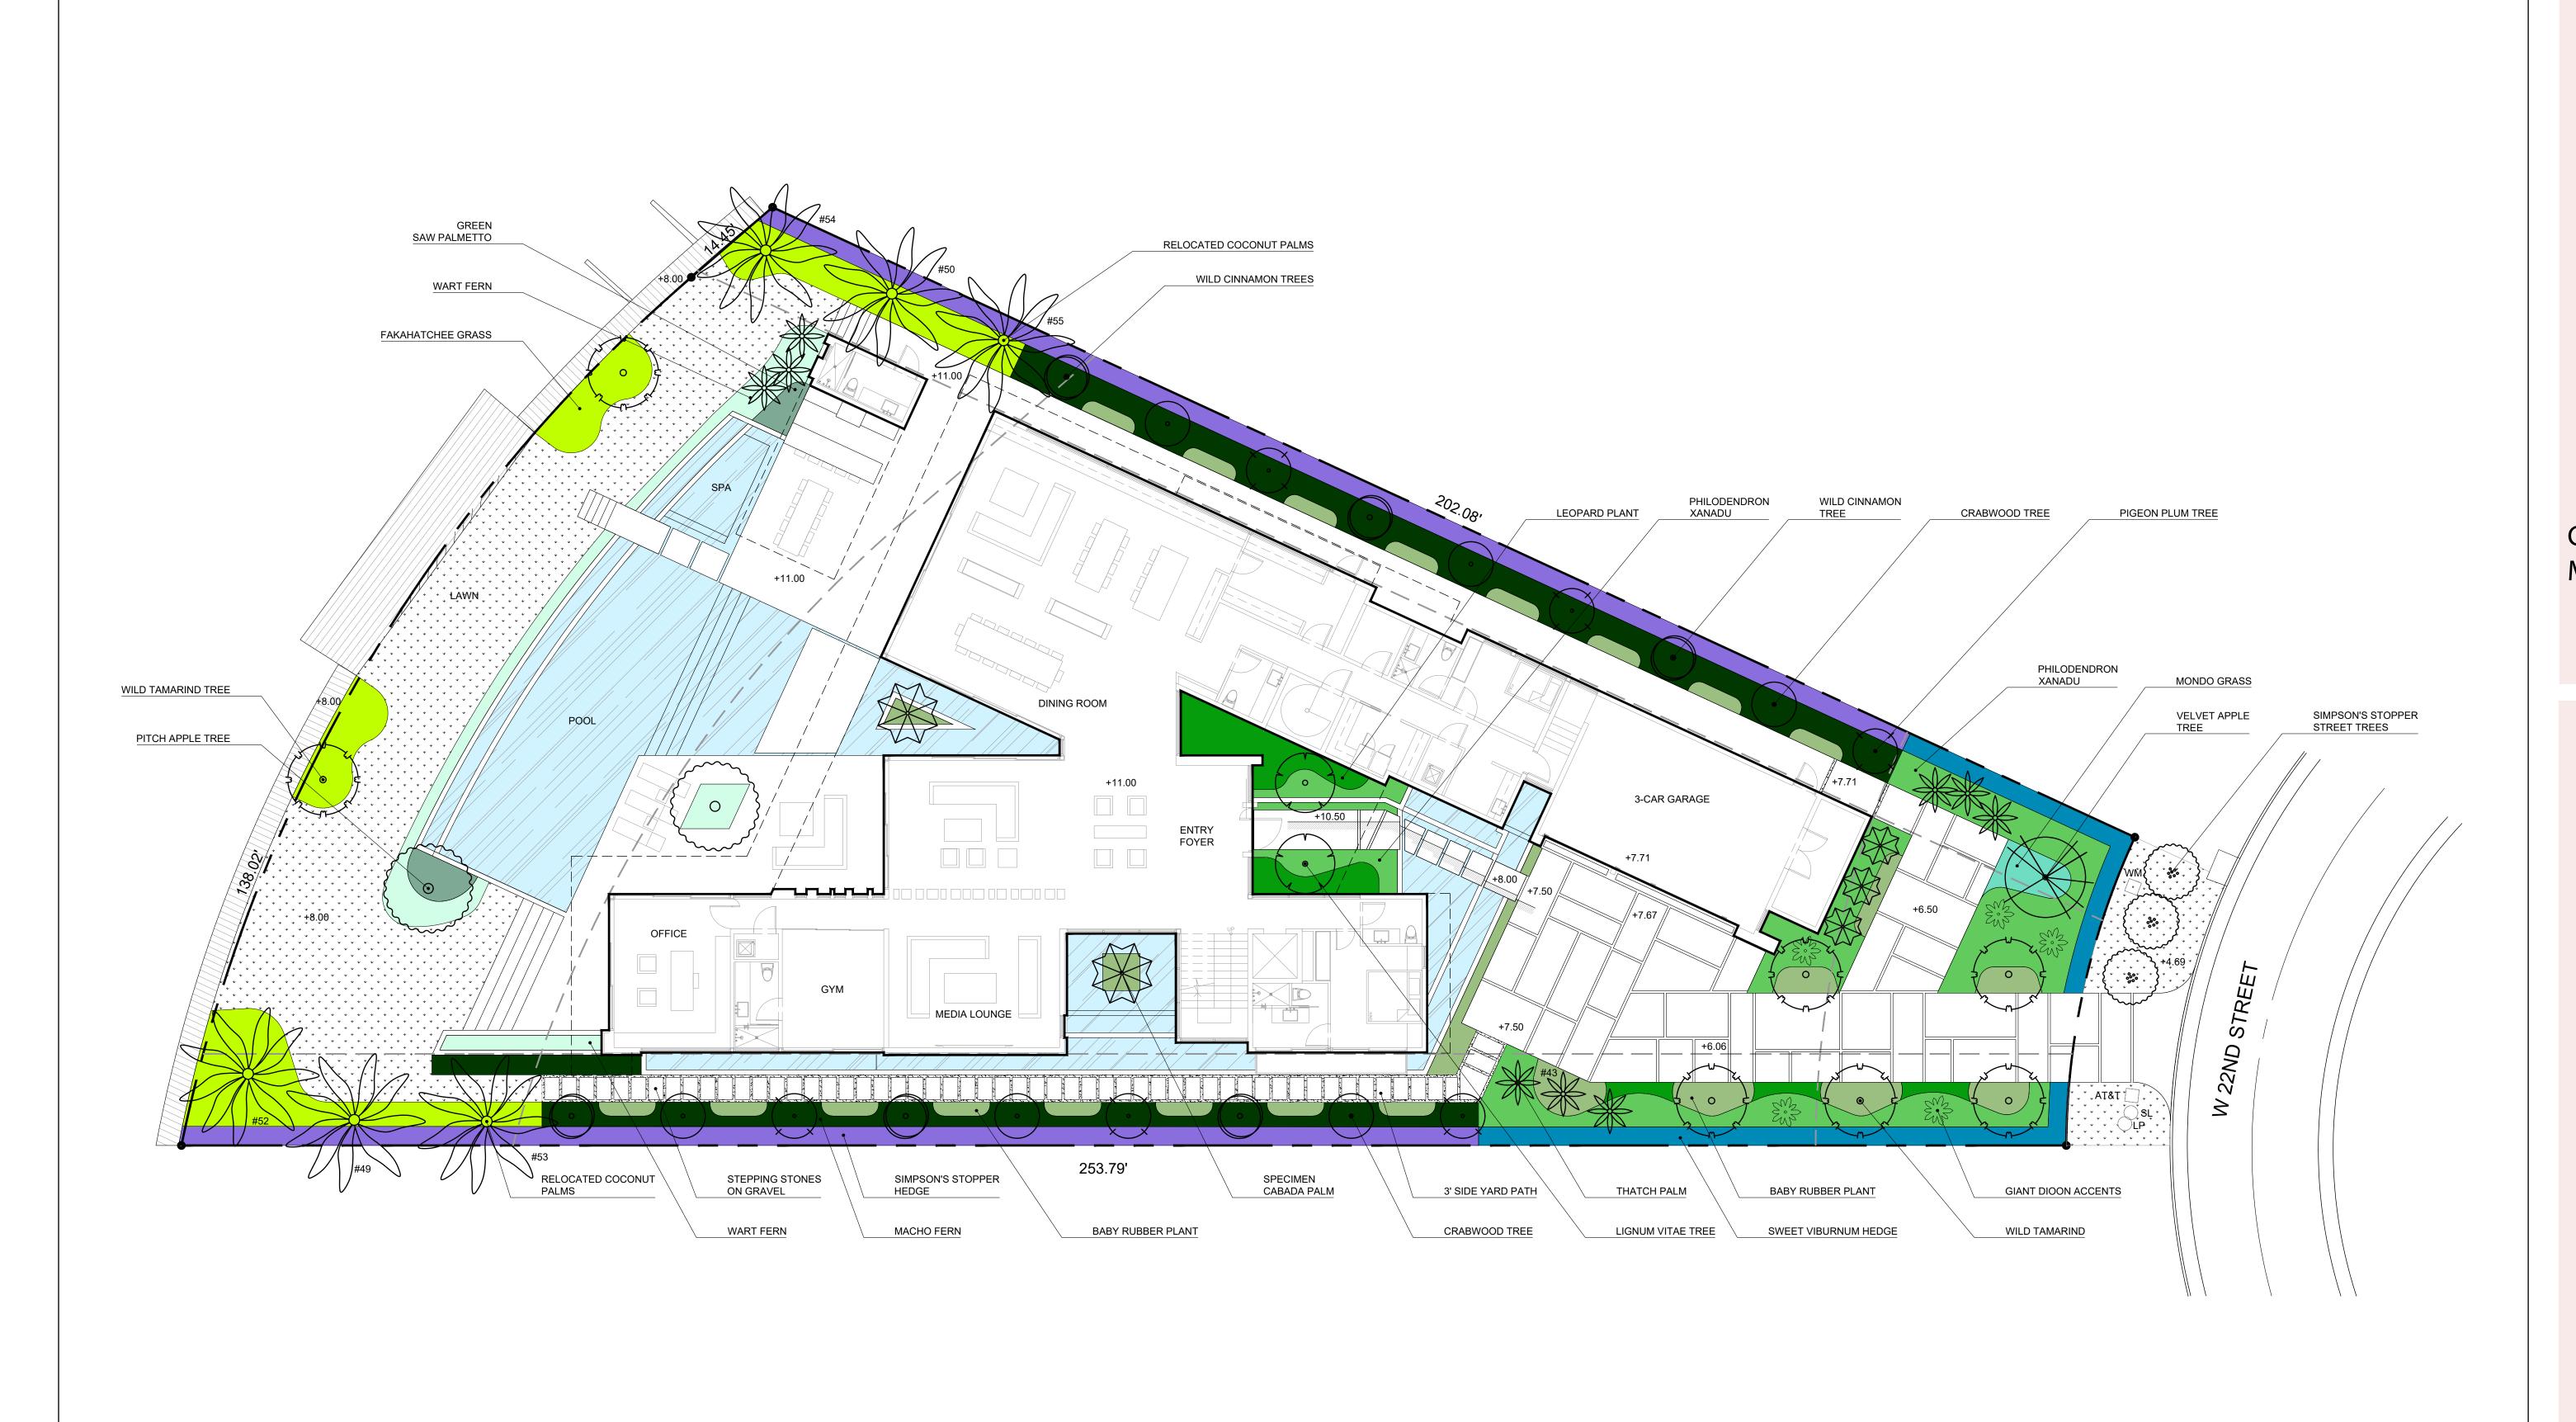
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L-1.2





SITE ADDRESS:

1649 W 22ND STREET MIAMI BEACH, FL 33140

LANDSCAPE ARCHITECT:

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AL:

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CAROLINA MONTEIRO DA SILVA REGISTERED LANDSCAPE ARCHITECT LA6667311

DRAWING TITLE:

OVERALL SITE PLAN

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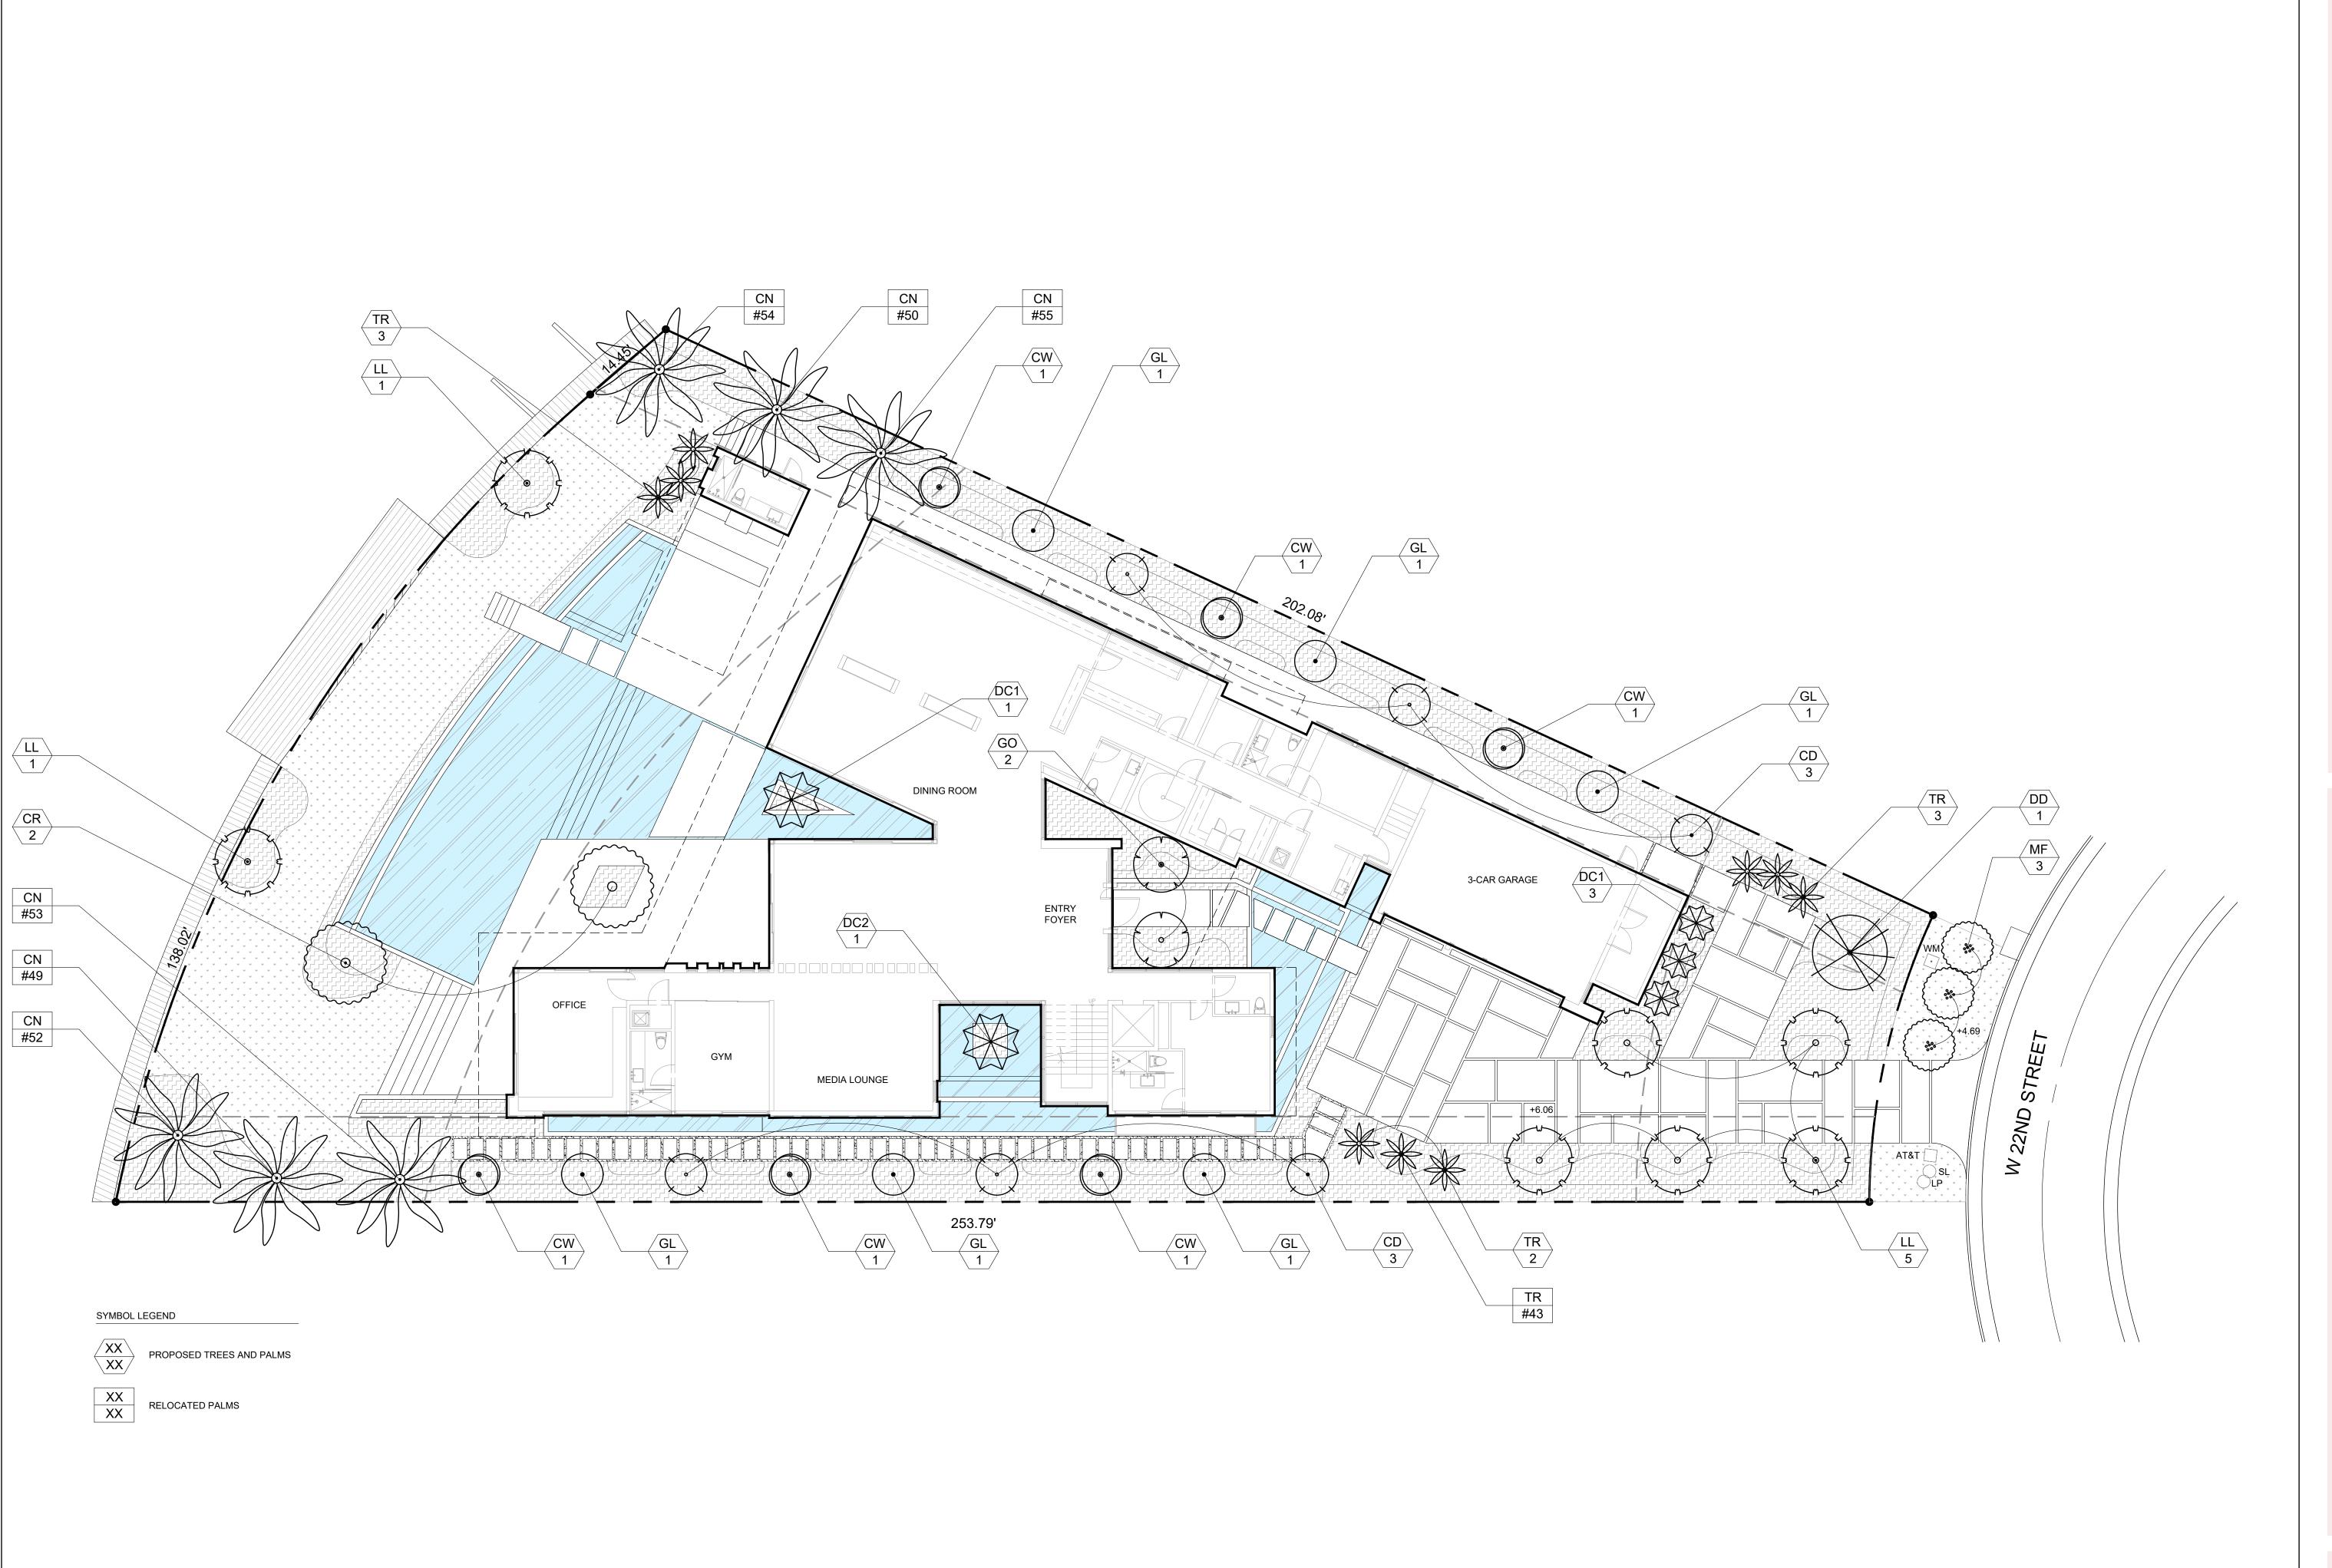
08/16/21

SCALE: 3/32" = 1'-0"

PROJ. N°:
2114
SHEET N°:

L-2

732 = 1-0





SITE ADDRESS:

1649 W 22ND STREET MIAMI BEACH, FL 33140

LANDSCAPE ARCHITECT:

8020 NE 4TH AVE, STUDIO 113 MIAMI, FL 33138 (786) 536-6076 INFO@CLADLANDSCAPE.COM

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Monteiro Date: 2021.09.03
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CAROLINA MONTEIRO DA SILVA REGISTERED LANDSCAPE ARCHITECT LA6667311

DRAWING TITLE:

CANOPY PLANTING PLAN

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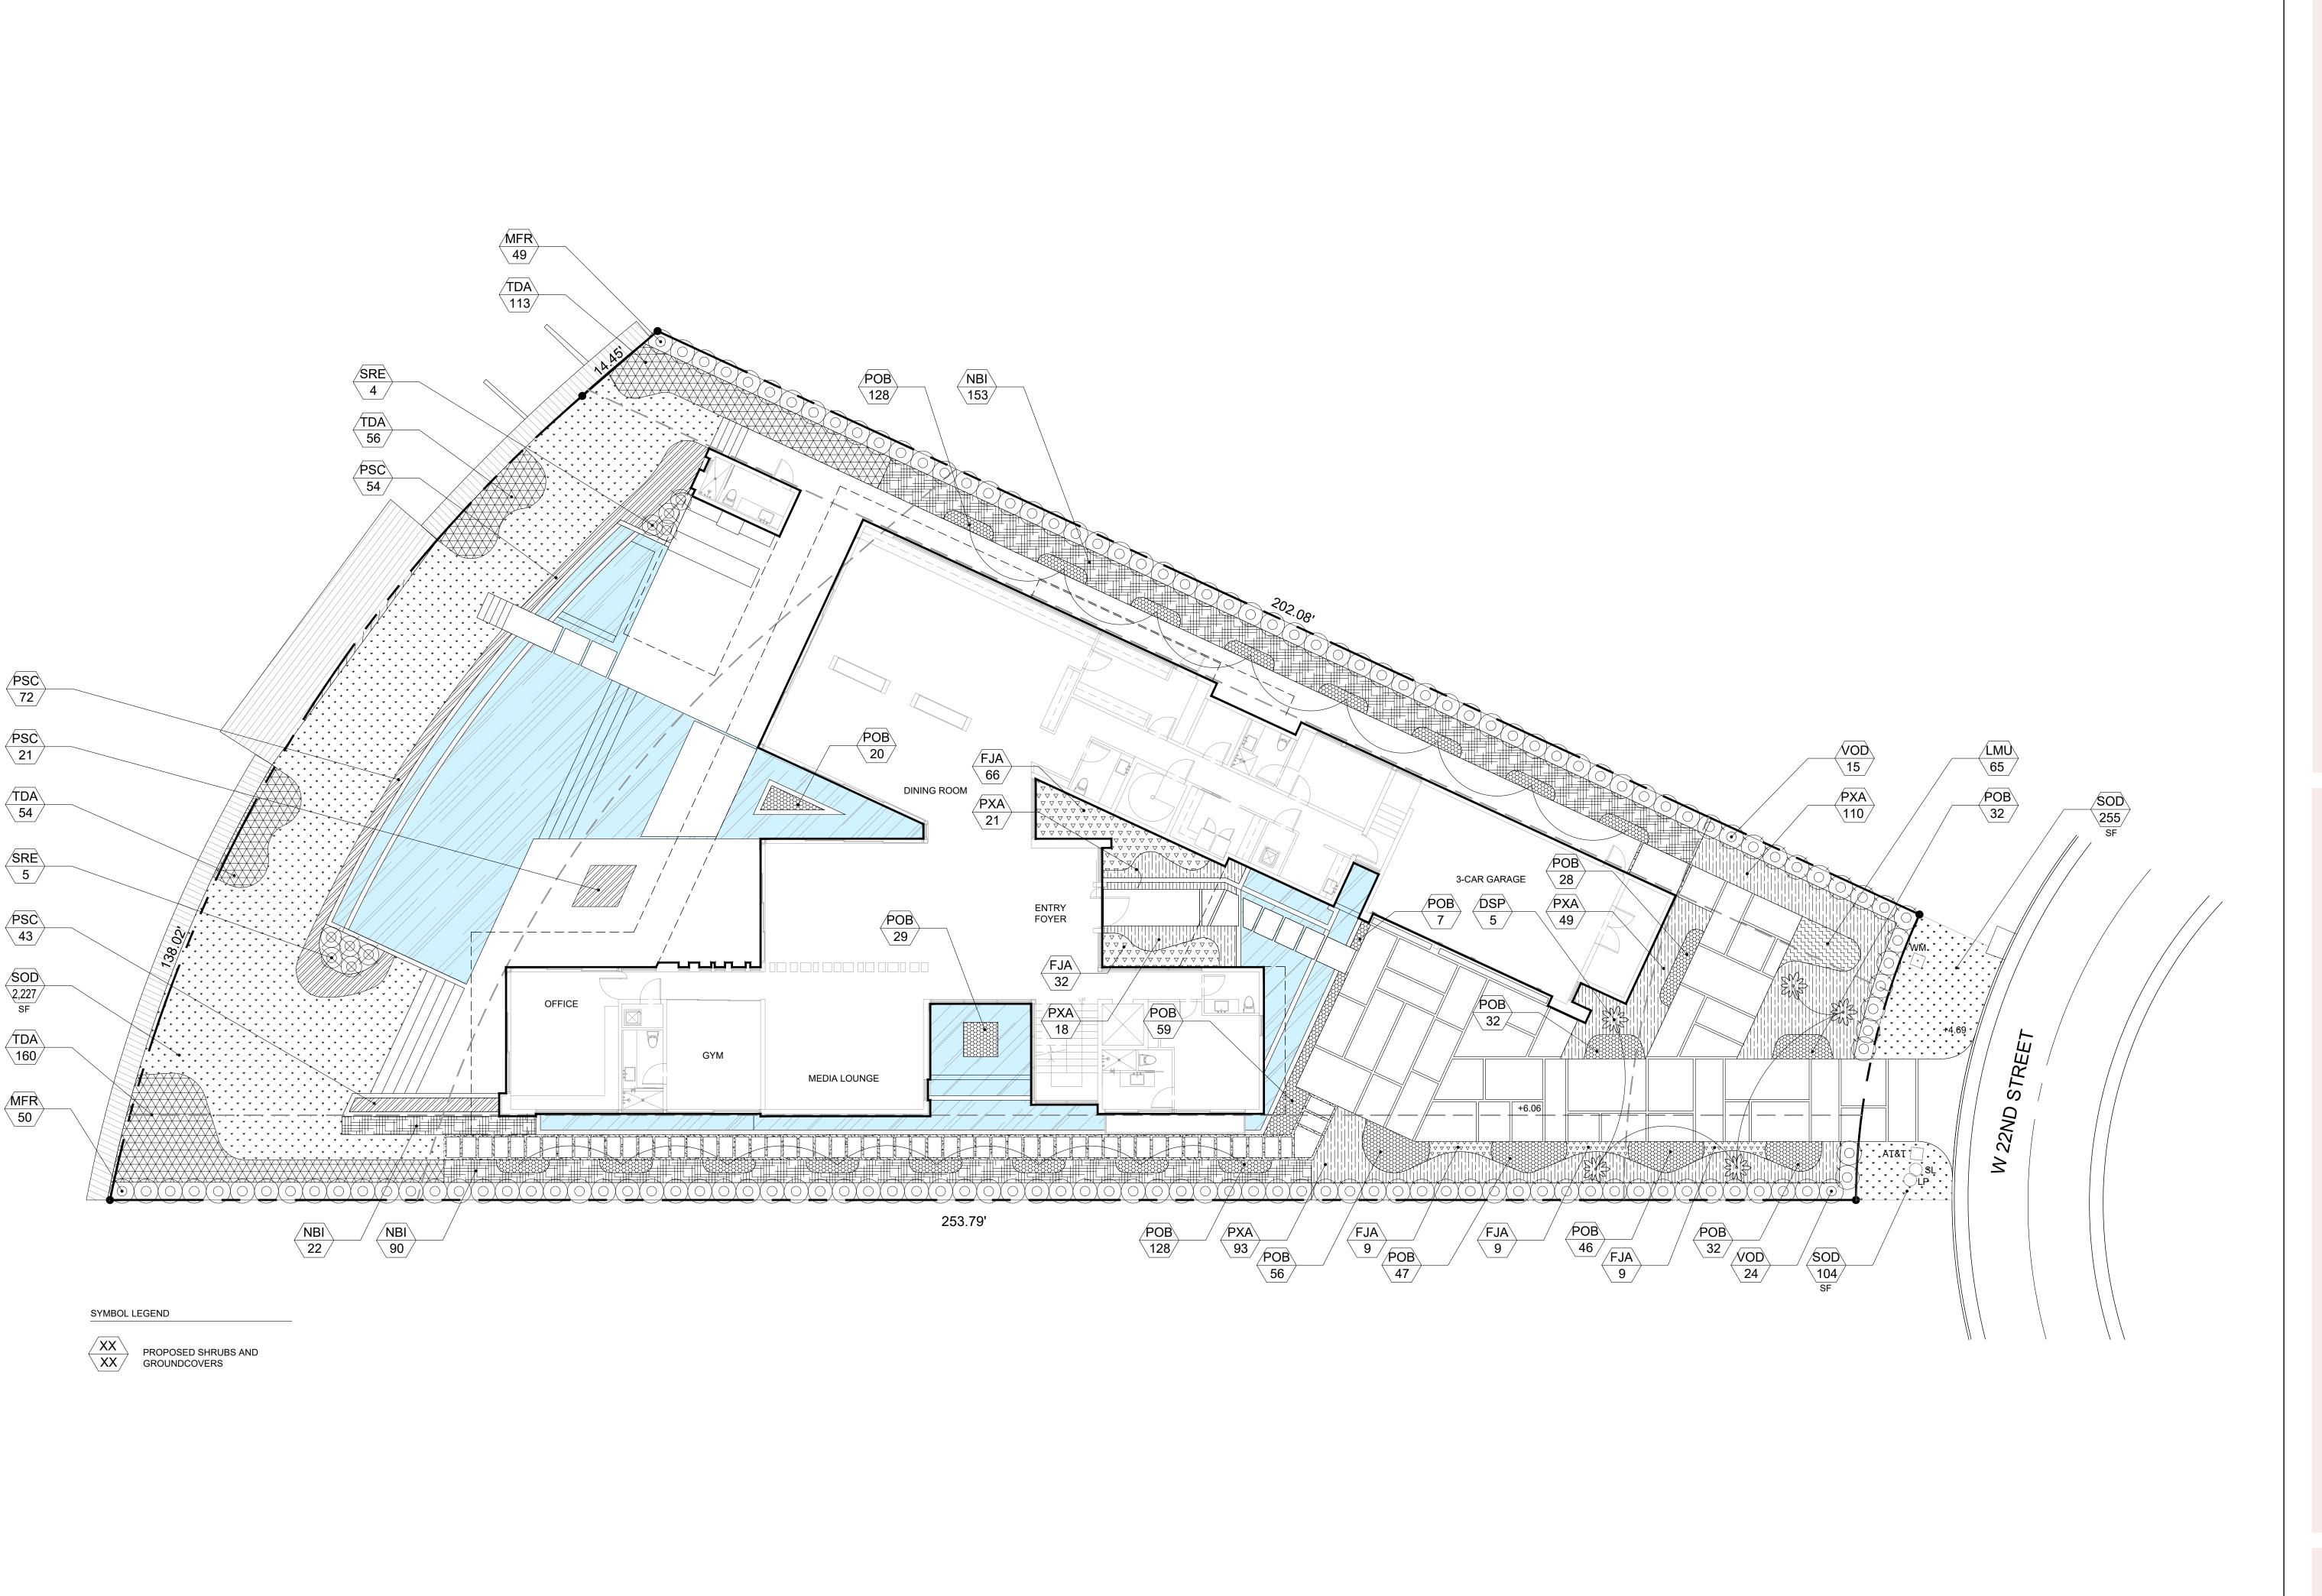
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SCALE: 3/32" = 1'-0"



L-5





SITE ADDRESS:

1649 W 22ND STREET MIAMI BEACH, FL 33140

LANDSCAPE ARCHITECT:

8020 NE 4TH AVE, STUDIO 113 MIAMI, FL 33138 (786) 536-6076 INFO@CLADLANDSCAPE.COM

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Monteiro

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CAROLINA MONTEIRO DA SILVA REGISTERED LANDSCAPE ARCHITECT

DRAWING TITLE:

UNDERSTORY PLANTING PLAN

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DATE

08/16/21

SCALE: 3/32" = 1'-0"

PROJ. N°: 2114 SHEET N°: L-5.1

LANDSCAPE SCHEDULE - CANOPY SITE							
SYMBOL	QTY	PROPOSED MATERIAL	DESCRIPTION AND NOTES	NATIVE			
PROPOSED STREET TREES							
MF	3	Myrcianthes fragrans	14' HT, MIN 3" DBH, 4' CT	Υ			
1411		SIMPSON'S STOPPER	MULTI-TRUNK	L '			
		PROPOSED	TREES				
DD	1	Diospyrus discolor	20' HT; 6" DBH; 14' SP, SPECIMEN	N			
DD	<u>'</u>	VELVET APPLE	FG				
LL	7	Lysiloma latisiliquum	16' HT; 4" DBH; 8' SP	Y			
LL	1	WILD TAMARIND	FG	1			
CR	2	Clusia rosea	16' HT; 4" DBH; 8' SP	Y			
CIX	2	PITCH APPLE	FG	'			
CD	6	Coccoloba diversifolia	12' HT, 6' SP, MIN 2" DBH	Υ			
CD 0		PIGEON PLUM	FG] '			
GL	6	Gymnanthes lucida	12' HT, 6' SP, MIN 2" DBH	Υ			
GL	0	CRABWOOD	FG]			
CW	6	Canella winterana	12' HT, 6' SP, MIN 2" DBH	Υ			
CVV	0	WILD CINNAMON	FG]			
00	2	Guaiacum officinale	10' HT	N			
GO 2		LIGNUM VITAE	FG	IN I			
•		PROPOSED	PALMS	,			
DC1	4	Dypsis cabadae	6'-8' HT	N			
DC1	4	CABADA PALM	25G, MIN. 3 TRUNKS	- N			
DC2	4	Dypsis cabadae	16'-18' HT	NI			
DC2	1	CABADA PALM	FG, MIN. 3 TRUNKS	N			
TD	0	Thrinax radiata	16'-18' HT	V			
TR	8	FLORIDA THATCH PALM	FG, MIN. 3 TRUNKS	Y			
,		RELOCATED	•				
		Cocos nucifera	#49, #50, #52, #53, #54, #55	N1			
CN	6	COCONUT PALM		- N			
TD		Thrinax radiata	#43	\ \ \ \ \ \ \ \ \ \ \ \ \ \ \ \ \ \ \			
TR	1	FLORIDA THATCH PALM		Y			

		LANDSCAPE SCHE	DULE - UNDERSTORY SITE			
		LARC	GE SHRUBS			
MFR	99	Myrcianthes fragrans	6' HT, SPACING AS SHOWN	N		
IVII IX	99	SIMPSON'S STOPPER	15G	IN		
SHRUBS						
FJA	125	Farfugium japonicum	18" HT, 18"O.C	N		
1 3/4	125	LEOPARD PLANT	3G	IN .		
PXA	291	Philodendron 'Xanadu'	24" HT, 20" O.C	N		
FXA	291	PHILODENDRON XANADU	3G	IN IN		
NBI	265	Nephrolepis biserrata	30" HT, 24" O.C	Υ Υ		
INDI	203	MACHO FERN	3G			
TDA	A 383	Tripsacum dactyloides	24" HT, 18" O.C	Y		
IDA	303	FAKAHATCHEE GRASS	3G	1		
SRE	9	Serenoa repens	3'-4' HT,	Y		
SIL	9	GREEN SAW PALMETTO	15G			
VOD	39	Viburnum odoratissum	5'-6' HT, FULL TO BASE	- N		
VOD	39	SWEET VIBURNUM	15G			
		<u>A</u>	CCENTS			
DSP	5	Dioon spinulosum	4' HT, 4' SP	N		
DOI	5	GIANT DIOON 15G		IN .		
		GROL	<u>INDCOVERS</u>			
PSC	190	Phymatosorus scolopendria	18" HT, 18" O.C	N		
1 00	130	WART FERN	3G	IN .		
LMU	65	Liriope muscari 'Super Blue'	12" HT , 12" O.C	N		
LIVIO	05	LILYTURF	1G	IN IN		
POB	644	Peperomia obtusifolia	12" HT, 12" O.C	Y		
ГОВ	044	BABY RUBBER PLANT	3G			
			SOD			
SOD	2586	Zoysia ssp.	STAGGERED AND BUTTED JOINTS	N		
300	2500	GEO ZOYSIA		IN		

CITY OF MIAMI BEACH LANDSCAPE LEGEND

INFORMATION REQUIRED TO BE PERMANENTLY AFFIXED TO PLANS Zoning District RS-3 Lot Area 21,497 SF Acres .49___

B. Maximum lawn area (sod) permitted= __50_ % x _10,749 s.f.

OPEN SPACE	ALLOWED	PROVIDED
A. Square feet of required Open Space as indicated on site plan:		
Lot Area =21,497 s.f.x50 % =10,749 s.f.	10,749	13,378
B. Square feet of parking lot open space required as indicated on site		
Number of parking spaces N/A x 10 s.f. parking space =	N/A	
C. Total square feet of landscaped open space required: A+B=	N/A	
LAWN AREA CALCULATION		
A. Square feet of landscaped open space required	10,749	12,793

5,375 2,227

	TREES		
A.	Number of trees required per lot or net lot acre, less existing number		
	of trees meeting minimum requirements=		
	19 trees x - (0) number of existing trees=	21	28
B.	% Natives required: Number of trees provided x 30% =	9	27
C.	% Low maintenance / drought and salt tolerant required:		
	Number of trees provided x 50%=	14	27
D.	Street Trees (maximum average spacing of 20' o.c.)		
	43'linear feet along street divided by 20'=	3	3
E.	Street tree species allowed directly beneath power lines:		
	(maximum average spacing of 20' o.c.):		
	linear feet along street divided by 20'=	N/A	N/A


B. % Native shrubs required: Number of shrubs provided x 50%=

LARGE SHRUBS OR SMALL TREES

A. Number of large shrubs or small trees required: Number of required B. % Native large shrubs or small trees required: Number of large shrubs or small trees provided x 50%=

SPECIES DIVERSITY

Required number of tree species (16-20 Required): 5 Provided proposed tree species: 6

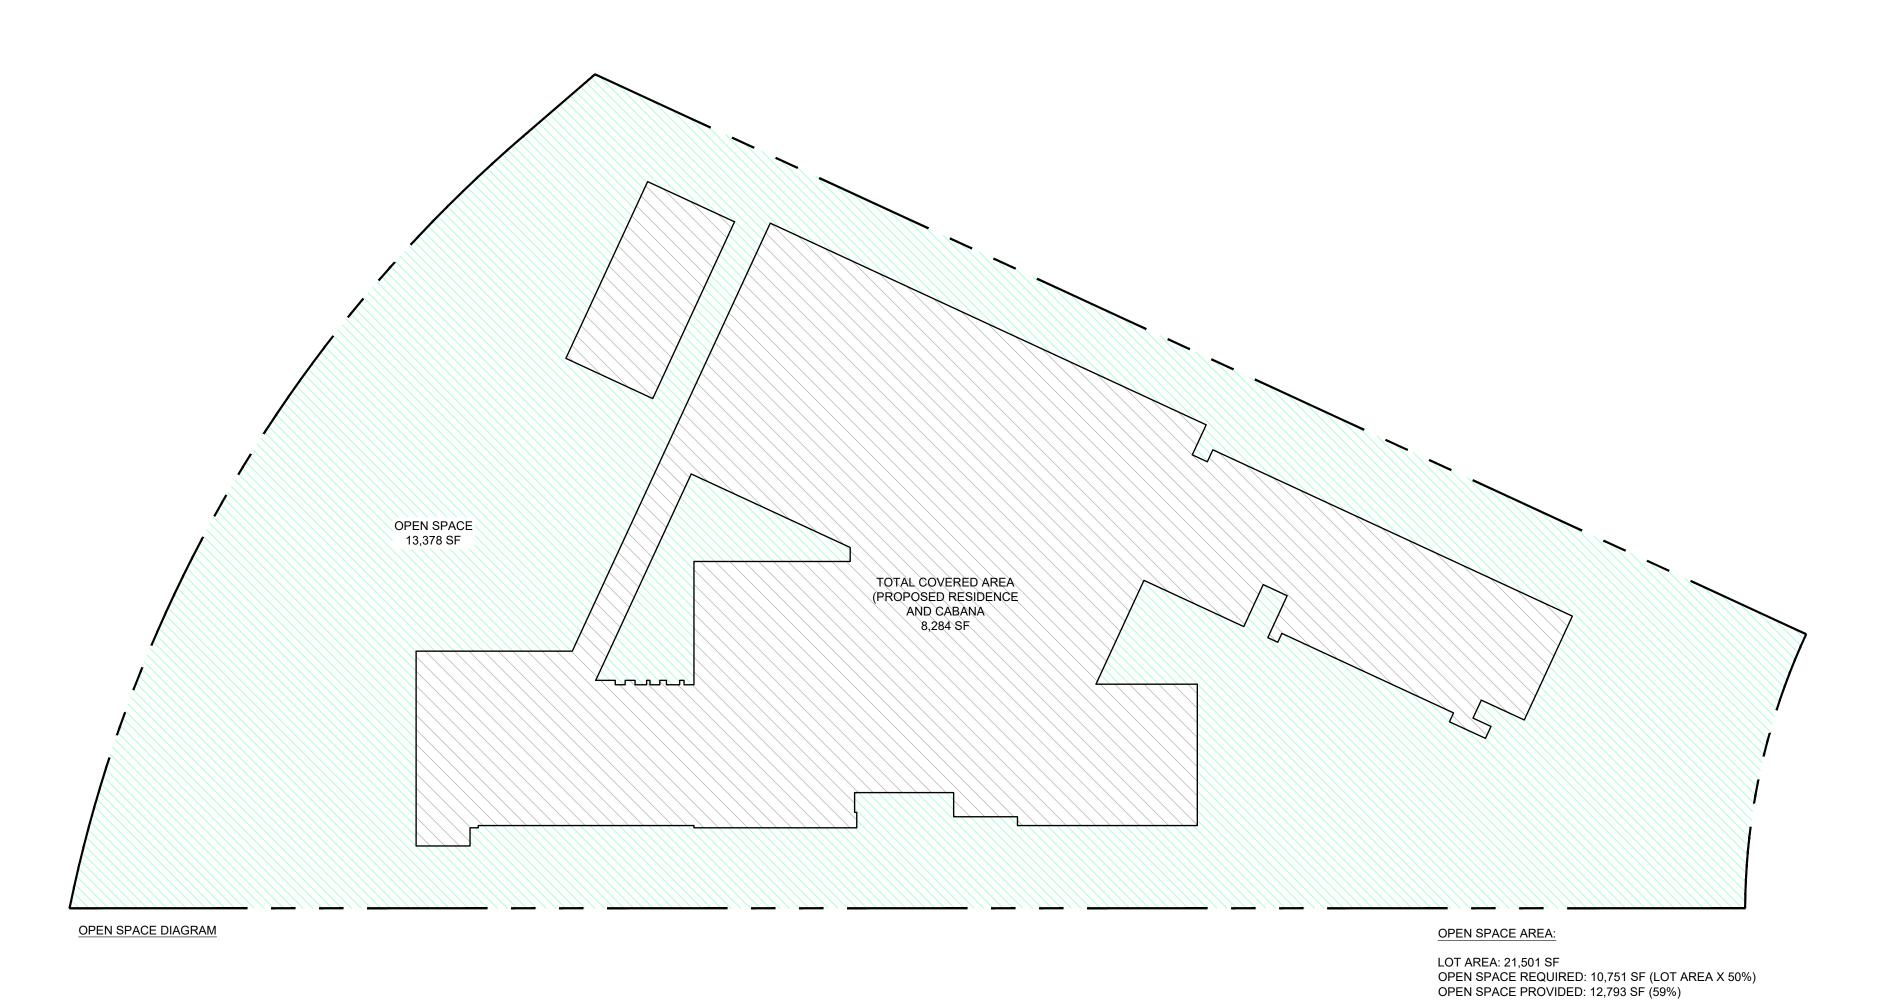

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Carolina
Digitally signed by Carolina
Monteiro Monteiro Date: 2021.09.03 09:46:51 -04'00'

> CAROLINA MONTEIRO DA SILVA REGISTERED LANDSCAPE ARCHITECT LA6667311

DRAWING TITLE:

PLANTING SCHEDULE, LEGEND AND OPEN SPACE DIAGRAM

REVISIONS:

ISSUE


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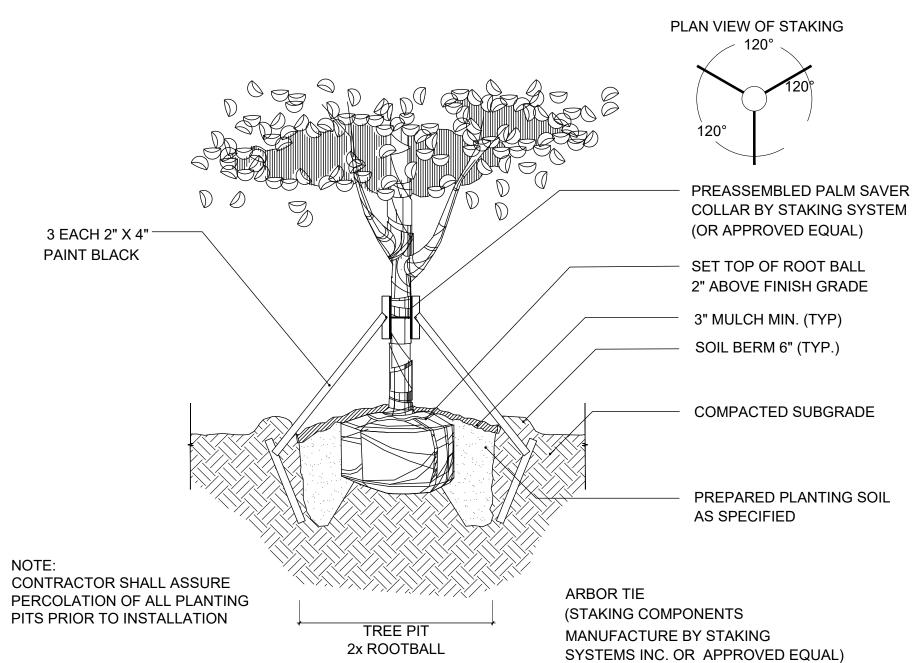
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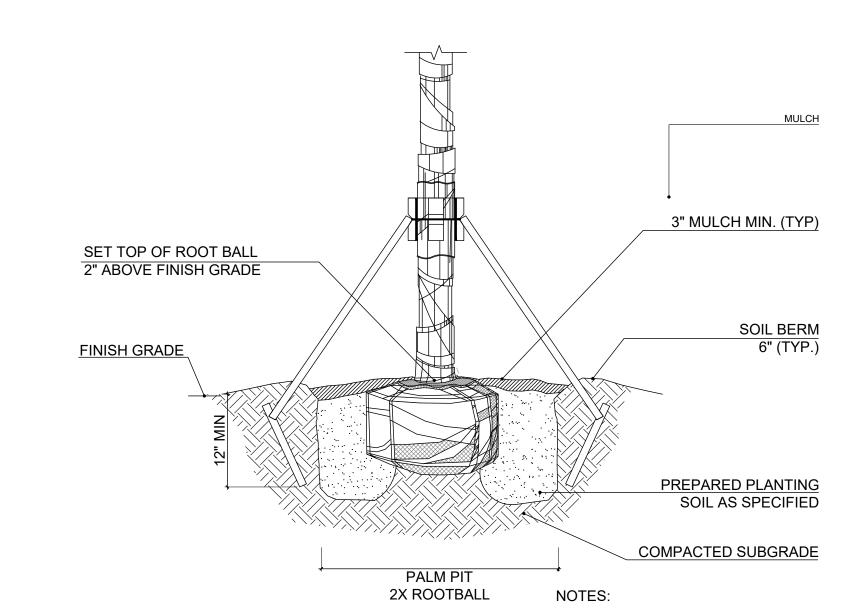


CONTRACTOR SHALL ASSURE PERCOLATION OF ALL PLANTING PITS PRIOR TO INSTALLATION

SPECIMEN TREE PLANTING DETAIL



SPECIMEN TREE STAKING DETAIL

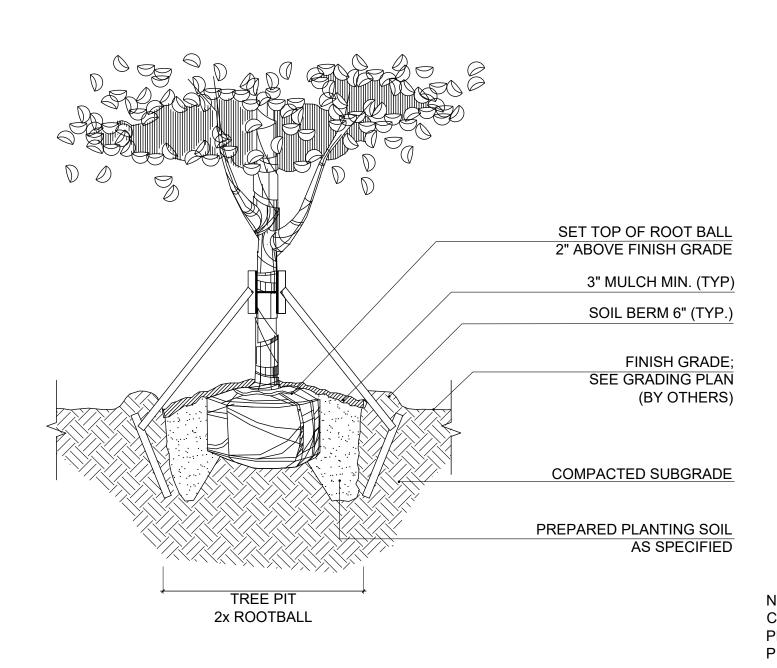

OF ALL PLANTING PITS PRIOR TO INSTALLATION. 2. SOIL BERMS ARE TO BE CONSTRUCTED AT RIGHT ANGLES TO THE TREE OR SHRUB OR IN THE POSITION WHICH WILL MOST EFFECTIVELY SERVE THE PURPOSE OF RETAINING WATER AT THE BASE OF THE PLANT.

1. CONTRACTOR SHALL ASSURE PERCOLATION

PRE ASSEMBLED PALM SAVER COLLAR BY STAKING SYSTEM PLAN VIEW OF STAKING (OR APPROVED EQUAL) 2"x4' PAINT BLACK 3 EACH 2'x4" STAKE (TYP.) TOP OF STAKE PAINT BLACK MUST BE MINIMUM OF 3" BELOW FINISHED GRADE FINISH GRADE

2X ROOTBALL


NOTES:

PLANT.

1. CONTRACTOR SHALL ASSURE PERCOLATION OF ALL PLANTING PITS

PRIOR TO INSTALLATION. 2. SOIL BERMS ARE TO BE CONSTRUCTED AT RIGHT ANGLES TO THE TREE OR SHRUB OR IN THE POSITION WHICH WILL MOST EFFECTIVELY SERVE THE PURPOSE OF RETAINING WATER AT THE BASE OF THE


PALM STAKING DETAIL

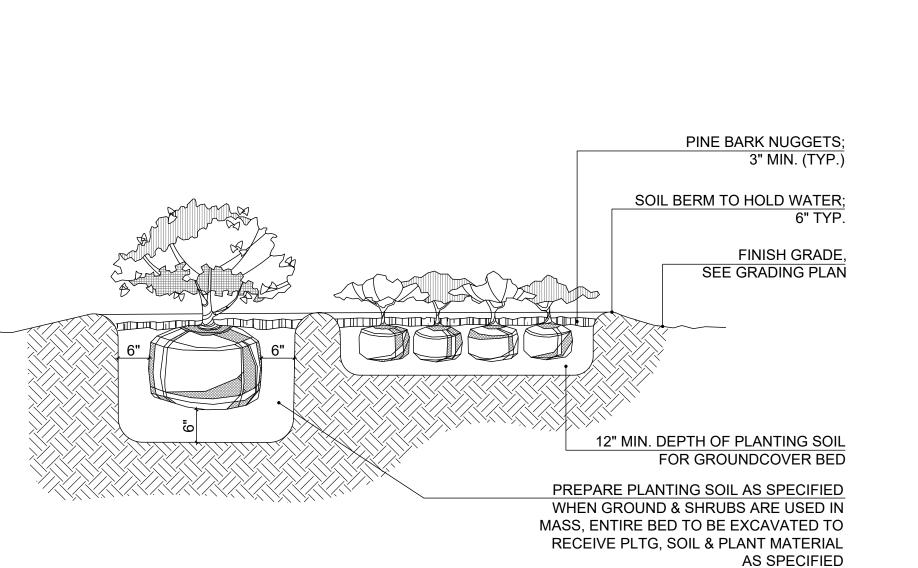

CONTRACTOR SHALL ASSURE PERCOLATION OF ALL PLANTING PITS/ BEDS PRIOR TO INSTALLATION



SHRUB AND GROUNDCOVER PLANTING DETAIL

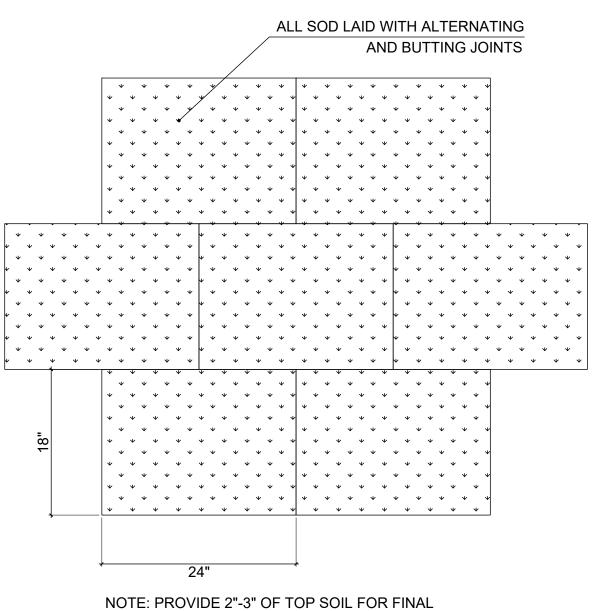

GRADING PRIOR TO LAY DOWN SOD

PALM PLANTING DETAIL

SOD PLANTING DETAIL

PRICE RESIDENCE MIAMI BEACH, FL

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Digitally signed Carolina by Carolina Monteiro Date: 2021.09.03 09:47:05 -04'00'

CAROLINA MONTEIRO DA SILVA REGISTERED LANDSCAPE ARCHITECT LA6667311

DRAWING TITLE:

DETAILS

PLANTING

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REVISIONS:

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LANDSCAPE NOTES DETERMINED BY THE OWNER OR LANDSCAPE ARCHITECT, AT LEAST FOURTEEN (14) WORKING DAYS PRIOR TO ITS INTENDED DELIVERY TO THE SITE. UPON APPROVAL OF SUBMITTALS, DELIVERY OF MATERIALS MAY BEGÍN. a. MULCH - ONE (1) CUBIC FOOT THE WORK CONSISTS OF FURNISHING ALL LABOR, MATERIALS, EQUIPMENT, TOOLS, TRANSPORTATION, AND ANY OTHER APPURTENANCES b. ROOT STIMULATOR - ONE (1) CONTAINER NECESSARY FOR AND INCIDENTAL TO THE COMPLETION OF THIS PROJECT AS SHOWN ON THE DRAWINGS, AS INCLUDED IN THE PLANT c. FERTILIZER - ONE (1) CONTAINER LIST. AND AS HEREIN SPECIFIED. d. TOPSOIL - ONE (1) CUBIC YARD PAINTED WITH BENJAMIN MOORE 2118-10 UNIVERSAL BLACK, FLAT/MATTE EXTERIOR. x. THERE WILL BE NO PLANT MATERIAL PLANTED INTO ROOT BALLS OF TREES AND PALMS. ii. WORK SHALL INCLUDE MAINTENANCE AND WATERING OF ALL PLANTING AREAS OF THIS DRAWING SET UNTIL CERTIFICATION OF e. PLANTS - ONE (1) REPRESENTATIVE PHOTOGRAPH OF EACH SHRUB AND GROUNDCOVER FOR APPROVAL PRIOR TO TAGGING. ACCEPTABILITY BY THE OWNER AND/OR THE LANDSCAPE ARCHITECT. TREES - ONE PHOTOGRAPH W/ CLEARLY LEGIBLE MEASURING ROD OF ACTUAL CONTRACTOR PRE-TAGGED TREES. UPON APPROVAL OF TREE SUBMITTAL, LANDSCAPE CONTRACTOR SHALL PROVIDE AT LEAST ONE WEEK NOTICE TO SCHEDULE TREE TAGGING. iii. PROTECTION OF EXISTING STRUCTURES, ALL EXISTING BUILDINGS, WALKS, WALLS, PAVING, PIPING, AND OTHER ITEMS OF CONSTRUCTION AND PLANTING ALREADY COMPLETED OR ESTABLISHED SHALL BE PROTECTED FROM DAMAGE BY THE CONTRACTOR g. PLANTING MIX - ONE (1) CUBIC YARD MIX AS SPECIFIED. THOROUGHLY WATER ALL PLANTS AFTER INSTALLATION. UNLESS OTHERWISE SPECIFIED. ALL DAMAGE RESULTING FROM NEGLIGENCE SHALL BE REPAIRED OR REPLACED TO THE SATISFACTION 4B. MULCH: 6F. WATER AND IRRIGATION: OF THE OWNER WITH COSTS BY CONTRACTOR. i. MULCH TYPE: PINE BARK MINI NUGGETS i. CONTRACTOR SHALL PROVIDE WATER FROM A LEGAL SOURCE. iv. ALL WORK SHALL BE PERFORMED TO SPECIFICATIONS WRITTEN IN ACCORDANCE WITH THE MOST CURRENT VERSION OF THE ANSI A-300, ii. MULCH MATERIAL SHALL BE MOISTENED AT THE TIME OF APPLICATION. ANSI Z-133, GOVERNMENT, AND LOCAL STANDARDS. iii. ALL TREES, SHRUBS, AND GROUND COVER BEDS SHALL RECEIVE A MINIMUM OF 2" OF MULCH IMMEDIATELY AFTER PLANTING. iv. MULCH SHALL BE MAINTAINED BELOW THE ELEVATION OF ADJACENT FINISHED SURFACES AND SWEPT CLEAR OF PATHS. 4C. FERTILIZER: IT IS THE CONTRACTOR'S RESPONSIBILITY TO NOTE AND PROTECT THE EXISTING TREES TO REMAIN ON SITE i. COMMERCIAL FERTILIZER: COMMERCIAL FERTILIZER SHALL BE A COMPLETE FORMULA; IT SHALL BE UNIFORM IN COMPOSITION, DRY AND HARMFUL OR INHIBITS VIGOROUS PLANT GROWTH ii. PRIOR TO COMMENCEMENT OF ANY WORK, CONTRACTOR SHALL PERFORM ROUTINE MAINTENANCE, PER ANSI A-300, ON THE EXISTING FREE FLOWING. THIS FERTILIZER SHALL BE DELIVERED TO THE SITE IN THE ORIGINAL UNOPENED CONTAINERS, EACH BEARING THE TREES TO REMAIN INCLUDING REMOVAL OF DEAD AND DECAYED WOOD, REMOVAL OF ATTACHED BRANCHES AND STRUCTURALLY MANUFACTURER'S GUARANTEED STATEMENT OF ANALYSIS. UNSOUND LIMBS, AND SUBORDINATE BRANCHES WHERE INCLUDED BARK IS PRESENT AND REMOVAL OF BRANCHES TO INCREASE LIGHT ii. FERTILIZER SHALL BE ORGANIC IN MATERIAL CONTAINING NITROGEN, PHOSPHORIC ACID AND POTASH IN EQUAL PERCENTAGES OF PLANT vi. IRRIGATION SYSTEM SHALL PROVIDE 100% COVERAGE WITH MINIMUM 50% OVERLAP. AND AIR PENETRATION WITHIN THE CANOPY. FOOD BY WEIGHT, IN THE FOLLOWING FORM: vii. IRRIGATION SYSTEM SHALL BE EQUIPPED WITH A RAIN SENSOR. iii. DO NOT REMOVE MORE THAN 25% OF THE CANOPY WITHIN A TWELVE-MONTH PERIOD. viii. INSTALLATION OF IRRIGATION SYSTEMS SHALL CONFORM TO SPECIFICATIONS PROVIDED WITH IRRIGATION PLANS. iii. CONTAINERIZED MATERIAL (I.E. SHRUBS, VINES, GROUND COVERS) SHALL RECEIVE A GRANULAR SUCH AS 'TRI-NITE' OR APPROVED iv. ROOT PRUNING SHALL BE COMPLETED PRIOR TO COMMENCEMENT OF THE CONSTRUCTION ACTIVITIES. THE ROOT SYSTEM SHALL NOT BE SUBJECT TO TEARING, RIPPING OR ANY OTHER METHOD EXCEPT CLEAN CUTS AS DESCRIBED IN ANSI A-300. iv. SPECIMENS SHALL RECEIVE TIME-RELEASED FERTILIZER, SUCH AS OSMOCOTE, OR APPROVED EQUAL WARRANTY OF WORK v. PROTECTIVE BARRIERS SHALL BE PLACED AT THE DRIP LINE OF EACH TREE, CLUSTER OF TREES, OR PRESERVATION AREA, AND IN NO v. THIS INSTRUCTION SHALL SUPERSEDE OTHER NOTES REGARDING FERTILIZERS ON THE DRAWINGS OR DETAILS. 7A. WARRANTY: CASE LESS THAN TEN (10) FEET FROM THE TRUNK OF ANY PROTECTED TREE, TREE CLUSTER OR PRESERVATION AREA. 4D. PLANTS: i. PLANT SPECIES AND SIZE SHALL CONFORM TO THOSE INDICATED ON THE DRAWINGS AND CITED HEREIN. ALL SIZES SHOWN FOR PLANT vi. ALL PROTECTIVE BARRIERS SHALL BE INSTALLED PRIOR TO THE START OF ANY CONSTRUCTION OR SITE DEVELOPMENT, INCLUDING TREE DAYS AFTER ACCEPTANCE BY OWNER. REMOVAL, DEMOLITION OR LAND-CLEARING ACTIVITIES, AND SHALL REMAIN IN PLACE THROUGHOUT ALL PHASES OF CONSTRUCTION. MATERIAL ON THE PLAN ARE TO BE CONSIDERED AS MINIMUMS. vii. ANY TREE WHOSE ROOT SYSTEM IS IMPACTED SHALL BE WATERED ACCORDING TO THE TREE RELOCATION SPECIFICATIONS. ii. ALL PLANTS SHALL BE FLORIDA GRADE NO.1 OR BETTER, GRADED IN ACCORDANCE WITH GRADES AND STANDARDS FOR NURSERY viii. WHERE CONSTRUCTION ACTIVITY IMPACTS THE EXISTING TREE ROOT SYSTEM, THE CONTRACTOR, UNDER THE GUIDANCE OF AN ASCA PLANTS, PUBLISHED BY THE STATE OF FLORIDA, DEPARTMENT OF AGRICULTURE. TREES AND SHRUBS SHALL HAVE PRONOUNCED ARBORIST, SHALL ONLY ROOT PRUNE IN THE IMPACTED AREAS PER SPECIFICATIONS WRITTEN IN ACCORDANCE WITH ANSI A-300 ACCEPTANCE BY THE OWNER. SYMMETRY OF FOLIAR CROWN. PLANTS JUDGED TO BE NOT IN ACCORDANCE WITH THESE STANDARDS WILL BE REJECTED AND SHALL BE STANDARDS. IMMEDIATELY REMOVED FROM THE SITE OF THE WORK AND REPLACED AT THE CONTRACTOR'S EXPENSE 7B. MAINTENANCE: ix. NATURAL GRADE SHALL BE MAINTAINED ON AREAS SURROUNDED BY PROTECTIVE BARRIERS IN THE EVENT THAT THE NATURAL GRADE iii. ALL QUANTITIES INDICATED ON THE PLANT LIST ARE INTENDED AS A GUIDE FOR THE BIDDERS AND DOES NOT RELIEVE THE BIDDER OF OF THE SITE IS CHANGED. THEIR RESPONSIBILITY TO DO A COMPREHENSIVE PLANT TAKE OFF. SHOULD A DISCREPANCY OCCUR BETWEEN THE BIDDER'S TAKE OFF x. UNDERGROUND UTILITY LINES, INCLUDING, BUT NOT LIMITED TO, IRRIGATION, PLUMBING, ELECTRICAL, OR TELECOMMUNICATION LINES, AND THE PLANT LIST QUANTITY, THE LANDSCAPE ARCHITECT IS TO BE NOTIFIED FOR CLARIFICATION PRIOR TO FINAL BID ACCEPTANCE. SHALL BE PLACED OUTSIDE THE AREAS ENCLOSED BY PROTECTIVE BARRIERS 4E. PLANTING MIX: CONDITION. xi. NO VEHICLES, EQUIPMENT, OR STOCKPILING/STORAGE OF MATERIALS SHALL BE PERMITTED WITHIN AREAS SURROUNDED BY i. PLANTING MIX SHALL BE 70/30 MIX. 70% CRUSHED OOLITIC LIMESTONE OR SAND, AND 30% ORGANIC MATERIAL (COMPOSED OF 15% DECOMPOSED WOOD CHIPS AND 15% EVERGLADES PEAT). PROTECTIVE BARRIERS xii. FENCES, WALKWAYS, AND WALLS SHALL BE CONSTRUCTED TO AVOID DISTURBANCE TO ANY PROTECTED TREE. ii. THE LANDSCAPE ARCHITECT RESERVES THE RIGHT TO REJECT PLANTING MIX UTILIZED THAT FAILS TO MEET THE SPECIFICATION AT ANY iii. TREES SHALL BE PRUNED IN THE FOLLOWING MATTER: TIME DURING EXECUTION OF WORK. 4F. SOD: THE TRUNK OR PARENT LIMB 3.a. RELOCATIONS, GENERAL: TRANSPLANTING SHALL CONSIST OF ON-SITE TRANSPLANTING OF EXISTING PLANT MATERIALS FROM i. SELECTION: PROPOSED CONSTRUCTION AREAS TO PERMANENT POSITIONS AS NOTED ON DRAWINGS. a. GRASS SPECIES: ZOYSIA SPP. SIMULTANEOUSLY WITHOUT ANY REDUCTION IN CROWN. b. AMERICAN SOD PRODUCERS ASSOCIATION GRADE: NURSERY GROWN OR APPROVED. FIELD GROWN SOD IS NOT ACCEPTABLE. i. ALL PLANTING, TRANSPLANTING AND RELOCATING OF TREES OR PALMS SHALL, AT MINIMUM, BE DONE IN COMPLIANCE WITH STANDARDS SET FORTH IN THE MOST RECENTLY PUBLISHED EDITION OF ANSI A-300 STANDARDS. FURNISHED IN PADS: 18" X 24" X 1" THICK EXCLUDING TOP GROWTH AND THATCH. ii. VERIFY THE PRESENCE OF VIGOROUS FEEDER ROOTS PRIOR TO RELOCATION OPERATIONS d. NOT STRETCHED, BROKEN OR TORN iii. SOAK TREE ROOT BALLS TO THE FULL DEPTH DAILY FOR SEVEN CONSECUTIVE DAYS PRIOR TO RELOCATING TWO-THIRDS (2/3) OF THE TREE. e. UNIFORMLY MOWED HEIGHT WHEN HARVESTED iv. LOCATE POSITION AND ELEVATION WHERE TREES ARE INTENDED TO BE PLANTED FOR VERIFICATION BY THE LANDSCAPE ARCHITECT e. NO MORE THAN ONE-THIRD (1/3) OF A TREE'S LIVING CANOPY SHALL BE REMOVED WITHIN A ONE (1) YEAR PERIOD. f. INSPECTED AND FOUND FREE OF DISEASES, NEMATODES, PESTS, AND PEST LARVAE. v. NOTIFY THE OWNER'S REPRESENTATIVE AND LANDSCAPE ARCHITECT 24 HRS IN ADVANCE OF EACH RELOCATION TO ALLOW FOR g. UNIFORM IN COLOR, LEAF TEXTURE, AND DENSITY. OBSERVATION OF PROCEDURES. h. DO NOT DELIVER MORE SOD THAN CAN BE INSTALLED WITHIN 24 HOURS. vi. MATERIALS TO BE TRANSPLANTED SHALL BE ROOT PRUNED A MINIMUM OF SIX MONTHS PRIOR TO RE-LOCATION. i. BEGIN INSTALLATION OF SOD AFTER COMPLETION OF PRECEDING WORK (I.E. EARTH WORK, UNDERGROUND SPRINKLER SYSTEM, SOIL vii. CONTRACTOR SHALL MAINTAIN TRANSPLANTED MATERIALS DURING CONSTRUCTION PERIOD BY WATERING, WEEDING, MOWING, PREPARATION, INSTALLATION OF TREES, SHRUBS AND GROUND COVERS, ETC.) SPRAYING, FERTILIZING, PRUNING, AND OTHER HORTICULTURAL PRACTICES ii. INSTALLATION: viii. OWNER AND/OR LANDSCAPE ARCHITECT SHALL REGULARLY INSPECT THE RELOCATED MATERIALS TO ENSURE THAT ALL HORTICULTURAL a. TRANSPLANT SOD WITHIN 48 HOURS AFTER HARVESTING PRACTICES ARE BEING ADHERED TO. OWNER SHALL SUBMIT A WRITTEN REPORT TO LANDSCAPE CONTRACTOR NOTIFYING HIM OF ANY b. CONTRACTOR SHALL SOD ALL AREAS THAT ARE NOT PAVED OR PLANTED AS DESIGNATED ON THE DRAWINGS HEREIN DEFICIENCIES FOUND DURING THE MAINTENANCE PERIOD. ANY LOSS OF PLANT MATERIALS DUE TO THE NEGLIGENCE OF THE LANDSCAPE c. BEGIN SODDING AT BOTTOM OF SLOPES DEFICIENCIES. CONTRACTOR SHALL RESULT IN THE REPLACEMENT OF THE MATERIAL AT NO ADDITIONAL COST TO THE OWNER. SAID PLANT MATERIALS d. LAY FIRST ROW OF SOD IN STRAIGHT LINE WITH LONG DIMENSION OF PADS PARALLEL TO SLOPE CONTOURS SHALL BE REPLACED WITH THE SAME SPECIES OF EQUAL SIZE. e. LAY ALL ROWS WITH ALTERNATING AND ABUTTING JOINTS. f. DO NOT STRETCH OR OVERLAP ROWS THE SUPERVISORS FOR TRANSPLANTING EXISTING TREES, PALMS AND/ OR SHRUBS SHALL HAVE A MINIMUM OF 5 YEARS EXPERIENCE IN g. ROLL SOD, EXCEPT PEGGED AREAS, WITH ROLLER WEIGHING NO MORE THAN 100LBS PER FOOT OF ROLLER WIDTH. THE FIELD OF RELOCATION OF SIMILAR TYPE PLANT MATERIALS AND SHALL BE A MEMBER OF THE AMERICAN ASSOCIATION OF h. DURING ROLLING, ALL DEPRESSIONS CAUSED BY SETTLEMENT OF ROLLING SHALL BE FILLED WITH ADDITIONAL SOIL, AND THE SURFACE AS NECESSARY PER NOTE HEREIN. NURSERYMAN. h. MAINTAIN ALL BEDS FREE OF DEBRIS AND DELETERIOUS MATERIAL SHALL BE RE-GRADED AND ROLLED UNTIL PRESENTING A SMOOTH AND EVEN FINISH THAT IS UP TO THE REQUIRED GRADE. ii. CONTRACTOR MUST VERIFY THE LOCATIONS OF ALL EXISTING UTILITIES, STRUCTURES AND PLANT MATERIAL iii. CONTRACTOR SHALL OBTAIN ALL PERMITS REQUIRED PRIOR TO COMMENCEMENT OF WORK a. PREPARE LOOSE BED FOUR (4) INCHES DEEP. APPLY FERTILIZER AT RATE OF TWENTY (20) POUNDS PER ONE THOUSAND (1000) SQUARE NATURE. iv. CONTRACTOR SHALL VERIFY THAT TREES IN THE FIELD MATCH TREES DESIGNATED IN THE DRAWINGS. FEET. APPLICATION SHALL BE UNIFORM, UTILIZING APPROVED MECHANICAL SPREADERS. v. VERIFY PERCOLATION RATES AND SOILS ACCEPTABILITY AT LOCATIONS TO WHICH THE TREES ARE TO BE TRANSPLANTED. b. MIX FERTILIZER THOROUGHLY WITH THE SOIL TO A DEPTH OF THREE (3) INCHES. HAND RAKE UNTIL ALL BUMPS AND DEPRESSIONS ARE vi. ALL TREES SHALL BE PRE-TIED IN OR TIED BACK TO PREVENT BREAKAGE AND SCRAPING OF LIMBS IN ORDER TO FACILITATE MACHINERY GRASS SPECIES, AND LOCATION OF NURSERY FROM WHICH SOD IS CUT REMOVED. COMPLIANCE WITH STATE AND FEDERAL QUARANTINE RESTRICTIONS. MOVEMENT iv. SOIL WATERING: a. WATER SOD AND SOIL TO DEPTH OF 6" WITHIN FOUR HOURS AFTER ROLLING. 3C. PREPARATION: iii. MANUFACTURER'S CERTIFICATE OF FERTILIZER AND HERBICIDE COMPOSITION. b. KEEP SOD MOIST DURING FIRST WEEK AFTER PLANTING. i. FERTILIZATION AND WATERING: a. INJECT FERTILIZER MIXTURE WITHIN 24 HRS AFTER CROWN PRUNING, AND AT A MINIMUM OF 14 DAYS PRIOR TO RELOCATION WITH REQUIREMENTS SPECIFIED. c. AFTER FIRST WEEK, SUPPLEMENT RAINFALL TO PRODUCE A TOTAL OF 2" PER DAY b. INJECT THE DEEP ROOT FERTILIZER MIXTURE AT A RATE RECOMMENDED BY THE MANUFACTURER INTO THE PLANT MATERIAL TO BE d. IT IS THE CONTRACTOR'S RESPONSIBILITY TO WATER ALL PLANT MATERIAL. RELOCATED ii. CROWN PRUNING: TREES: a. DO NOT REDUCE CROWN DIMENSIONS; TRIM TREES TO BE RELOCATED BY THINNING THE CROWN ONLY TREES AND PALMS SHALL BE FRESHLY DUG, BALLED AND BURLAPPED. ALL PLANT MATERIAL SHALL BE FREE OF BROKEN OR DAMAGED 9. GENERAL SUBMITTALS:). REMOVE SEED PODS FROM SABAL PALMS, AND ALL BUT THE YOUNGEST FRONDS. TRIM BOOTS TO A CLEAN REGULAR PATTERN ROOT BALLS, OR ROOT BOUND CONDITIONS. PLANT MATERIALS SHALL BE SOUND, HEALTHY, VIGOROUS, FREE FROM PLANT DISEASE, c. THERE SHOULD BE NO CANOPY PRUNING OR A MINIMUM OF CANOPY PRUNING BEFORE OR AFTER ROOT PRUNING. ONLY DEAD, DISEASED INSECT PESTS OR THEIR EGGS, AND SHALL HAVE HEALTHY, NORMAL ROOT SYSTEMS. i. FENCE/GATES - SAMPLE, 2' LENGTH WITH ALL MEMBERS AND CONNECTIONS OR DAMAGED BRANCHES SHALL BE PRUNED AT THIS TIME ii. TREES ARE NOTED ON PLANS AND HEREIN AS APPROVED BY THE LANDSCAPE ARCHITECT iii. LANDSCAPE ARCHITECT SHALL TAG ALL TREES. TAGS SHALL NOT BE REMOVED. ABSENCE OF TAG AT DELIVERY TO PROJECT SITE WILL iii. FURNITURE - PRODUCT DATA a. PERFORM ROUGH PRUNING AT NO LESS THAN HALF THE DISTANCE BETWEEN THE DRIP LINE AND THE TRUNK. iv. LANDSCAPE MATERIALS - SAMPLES PER DOCUMENTS HEREIN BE GROUNDS FOR REJECTION OF THE TREE iv. SUBSTITUTIONS IN PLANT SPECIES OR SIZES SHALL BE MADE ONLY AFTER WRITTEN AUTHORIZATION BY THE LANDSCAPE ARCHITECT. b. PROVIDE A MIN OF 10" OF ROOT BALL DIAMETER FOR EVERY 1" OF TRUNK CALIPER MEASURED AT 12" ABOVE GRADE. v. GEOTEXTILE MATERIALS - SAMPLE AND PRODUCT DATA c. TREES WITH A CALIPER MORE THAN 12" SHALL BE ROOT PRUNED BY HAND. v. THE HEIGHT AND OR WIDTH OF TREES SHALL BE MEASURED FROM THE TOP OF THE ROOT BALL TO THE TOP OF CANOPY. THIS vi. LANDSCAPE IRRIGATION DATA - SHOP DRAWINGS AND PRODUCT DATA d. PRIOR TO TRANSPLANTING, PRUNE ROOT SYSTEMS IN THIRDS, 8 WEEKS APART. MEASUREMENT SHALL NOT INCLUDE THE IMMEDIATE TERMINAL GROWTH. vii. ROOT BARRIERS - PRODUCT DATA vi. PLANTS LARGER IN SIZE THAN THOSE SPECIFIED IN THE PLANT LIST MAY BE USED IF APPROVED BY THE OWNER AND/OR LANDSCAPE 3D. SUBMITTALS: i. SUBMIT A LIST OF EQUIPMENT, PROCEDURES AND LABOR FORCE USED FOR TRANSPLANTING THE WORK. ARCHITECT. ii. ARBORIST MUST PROVIDE TO THE OWNER WEEKLY REPORTS INCLUDING: vii. IF THE USE OF LARGER PLANTS IS APPROVED, THE BALL OF EARTH OR SPREAD OF ROOTS SHALL BE INCREASED IN PROPORTION TO THE BY OWNER AND LANDSCAPE ARCHITECT. ix. STORM DRAINAGE MATERIALS - PRODUCT DATA a. SITE ACTIVITIES SUMMARY AND CONDITIONS RELATING TO ALL TREES ON SITE SIZE OF THE PLANT. viii. PLANTS SHALL BE SUBJECT TO INSPECTION AND APPROVAL AT THE PLACE OF GROWTH, OR UPON DELIVERY TO THE SITE, AS x. CAULKS AND SEALANTS - PRODUCT DATA b. EVALUATION OF EACH TREE'S CONDITION c. RECOMMENDATIONS FOR SURVIVABILITY OF RELOCATED TREES xi. STAIN AND PAINT - SAMPLE DETERMINED BY THE OWNER AND/OR LANDSCAPE ARCHITECT, FOR QUALITY, SIZE, AND VARIETY; SUCH APPROVAL SHALL NOT IMPAIR iii. SUBMIT MANUFACTURER'S LITERATURE ON WETTING AGENTS, FERTILIZERS, CONDITIONERS AND INJECTION EQUIPMENT INFORMATION. THE RIGHT OF INSPECTION AND REJECTION AT THE SITE DURING PROGRESS OF THE WORK OR AFTER COMPLETION FOR SIZE AND xii. STEEL EDGING - PRODUCT DATA 3E. WATER AND IRRIGATION: xiii.FERTILIZER - PRODUCT DATA CONDITION OF BALLS OR ROOTS, LATENT DEFECTS OR INJURIES. REJECTED PLANTS SHALL BE REMOVED IMMEDIATELY FROM THE SITE. i. CONTRACTOR SHALL PROVIDE WATER FROM A LEGAL SOURCE NOTICE REQUESTING INSPECTION SHALL BE SUBMITTED IN WRITING AT LEAST ONE (1) WEEK PRIOR TO ANTICIPATED DATE xiv.ROOT STIMULATORS - PRODUCT DATA xv. FILL MATERIAL FOR ROUGH AND FINE GRADING - PRODUCT DATA AND SAMPLE ii. CONTRACTOR IS RESPONSIBLE FOR HAND WATERING ALL RELOCATED PLANT MATERIAL ix. CALIPER MEASUREMENT (DBH, 54" ABOVE CROWN OF ROOT BALL), HEIGHT AND SPREAD MEASUREMENTS, ROOT BALL DIMENSIONS, AND iii. DAILY WATERING AND MONITORING SHALL BE PERFORMED DURING THE TERM OF THE CONSTRUCTION CONTRACT AND UNTIL FINAL CONTAINER SIZE WHEN APPLICABLE, SHALL CONFORM TO THE APPLICABLE STANDARDS ESTABLISHED WITHIN REFERENCE DOCUMENTS xvi.TREE BRACING DETAILS - SHOP DRAWINGS xvii.IPE DECK FASTENERS AND HARDWARE, IPE PRODUCTS - SAMPLE ACCEPTANCE. RATE OF WATER APPLICATION: A MINIMUM OF 20 GALLONS/ INCH CALIPER PER APPLICATION CITED HEREIN, AND THE REQUIREMENTS FOR THIS PROJECT. iv. WATER SHALL BE FREE OF SUBSTANCES HARMFUL TO PLANT GROWTH, OBJECTIONABLE ODOR OR STAINING AGENTS xviii. SAND STABILIZER - PRODUCT DATA v. THE WATER SHALL BE CLEAN, FREE OF SOIL, DEBRIS, POISONS, PESTICIDES, CONTAMINANTS, AND ANY OTHER MATERIAL THAT IS XIX.SOIL MIXTURE DOCUMENTATION AND CERTIFICATION IDENTIFYING THE JOB AND CONTRACTOR, INCLUDING TESTING OF PH, KEY 6. EXECUTION HARMFUL OR INHIBITS VIGOROUS PLANT GROWTH 6A. INSPECTION vi. FOR TREES THAT WILL BE RELOCATED, IRRIGATION MUST BE PRESENT AND APPLIED EFFECTIVELY FOR TWO TO FOUR WEEKS PRIOR TO XX. NURSERY CERTIFICATION FOR ALL PLANT MATERIALS. i. IN THE EVENT OF DISCREPANCY, IMMEDIATELY NOTIFY LANDSCAPE ARCHITECT IN WRITING. ROOT PRUNING, THROUGH THE PERIOD OF ROOT PRUNING, AND AFTER ROOT PRUNING AND TRANSPLANTATION UNTIL THE TREE HAS ii. DO NOT PROCEED WITH INSTALLATION OF MATERIALS OR PLANTS IN AREAS OF DISCREPANCY UNTIL ALL SUCH DISCREPANCIES HAVE BEEN COMPLETELY REESTABLISHED AT THE NEW PLANTING SPACE. BEEN FULLY RESOLVED TO THE SATISFACTION OF THE OWNER AND/OR LANDSCAPE ARCHITECT. vii. A TENSIOMETER SHALL BE USED TO MEASURE AND MONITOR AVAILABLE MOISTURE IN THE GROUND. WEEKLY OBSERVATION SHALL BE 10. FENCING: NOTED IN ARBORIST'S REPORT. i. VERIFY LOCATIONS OF ALL UTILITIES, CONDUITS, SUPPLY LINES AND CABLES, INCLUDING BUT NOT LIMITED TO: ELECTRICAL, GAS (LINES 10A. SUBMITTALS: 3F. TRANSPLANTING OPERATIONS: AND TANKS), WATER, SANITARY SEWER, STORM WATER LINES, CABLE AND TELEPHONE. PROPERLY MAINTAIN AND PROTECT EXISTING i. THE LANDSCAPE CONTRACTOR SHALL TAKE ALL PRECAUTIONS TO MINIMIZE SHOCK OF ROOT PRUNING AND TRANSPLANTING IN METHODS AND DEVICES SHOWING SIZES, EDGE DETAILS, AND ATTACHMENT DETAILS. ACCORDANCE WITH NURSERY TRADE PROCEDURES INCLUDING THE FOLLOWING: ii. STAKE OR MARK WITH PAINT THE PROPOSED LOCATION OF ALL TREES AND PALMS TO BE PLANTED. ii. MANUFACTURER'S LITERATURE: SUBMIT FOR APPROVAL PROPERLY IDENTIFIED LITERATURE GIVING MATERIAL SPECIFICATIONS, GATE a. ROOT PRUNE ONE THIRD OF BALL AT A TIME. iii. EXCAVATE PLANT BEDS. HARDWARE, AND INSTALLATION DETAILS. b. THIN OUT THE INTERIOR CROWN OF DICOTS, IN A SIMILAR SEQUENCE, TO COMPENSATE FOR ROOT LOSS, LEAVING THE ENTIRE CANOPY iv. ENSURE ALL PLANTING AREAS ARE FREELY DRAINING. ARCHITECT'S APPROVAL. v. PROVIDE PLANT MATERIALS, FERTILIZER, SOD, PLANTING MIX, AND INCIDENTAL MATERIALS AS SPECIFIED. c. LEAVE MONOCOT LEAVES ALONE, ALLOWING PLANT TO BALANCE ITSELF. PROTECT GROWING POINT AS REQUIRED. 10B. PRODUCTS: vi. SET PLANTS, BACKFILL, AND GUY OR BRACE PLANTS AS REQUIRED. d. AFTER ROOT PRUNING, BACKFILL WITH GOOD ORGANIC ROOTING MEDIUM. FERTILIZE WITH ORGANIC FERTILIZER TO PROMOTE ROOT vii. COMPLETE INCIDENTAL WORK RELATED TO PLANTING OPERATIONS, AND AS SPECIFIED. GROWTH AND USE 'ROOT STIMULATOR AND STARTER' BY GREEN LIGHT OR APPROVED EQUAL. 6C. APPLICATION: e. MULCH TO REDUCE WEEDS, DISCOURAGE FOOT TRAFFIC AND ITS COMPACTING EFFECT, CONSERVE MOISTURE AND MINIMIZE i. FINISH SUB-GRADE: UPON ACCEPTANCE OF ROUGH GRADING ELEVATIONS, ESTABLISH FINE SUB-GRADE WITH SMOOTH AND EVEN FINISH. ii. GATES: 316 STAINLESS STEEL BAR BEARING HINGES SIZE 4 1/2" X 4 1/2" MIN., MINIMUM (3) PER GATE. SELF CLOSING STAINLESS STEEL TEMPERATURE FLUCTUATION. REMOVE ROCKS EXCEEDING ONE (1) INCH DIAMETER, STICKS, DEBRIS, DELETERIOUS MATERIAL, GRASS AND SOIL CLODS, AND f. BRACE TRUNK AND LEAVE IN PLACE UNTIL TREES ARE WIND FORM (+/-1 YEAR). VEGETATION. SAGGING. g. AT THE TIME OF PLANTING, FILL AIR POCKETS TO KEEP ROOTS, ESPECIALLY FEEDER ROOTS MOIST, ALIVE AND HEALTHY. USE SOIL 6D. EXCAVATION: i. EXCAVATIONS IDENTIFIED AS HAVING POTENTIAL UTILITY OR SERVICE LINE CONFLICTS SHALL BE EXCAVATED WITH HAND TOOLS TO NEEDLE FOR WATERING NEW TRANSPLANT. DIRECT FINE SPRAY AT FOLIAGE TO HELP HARDEN OFF NEW LEAVES. DETERMINE THE LOCATION OF, AND AVOID DAMAGE TO, SUCH UTILITIES. i. ALL WOOD SHALL BE CERTIFIED WOOD: FABRICATE WITH COMPONENTS PRODUCED FROM WOOD OBTAINED FROM FORESTS CERTIFIED i. ALL TRANSPLANTING MACHINES WILL HAVE CLEAN, TIGHT FITTING AND SHARP BLADES. ii. EXCAVATE TREE AND PALM PLANTING PITS A MINIMUM OF 24" GREATER IN DIAMETER THAN THE ROOT BALL, AND MINIMUM OF 12" DEEPER THAN VERTICAL DEPTH OF THE ROOT BALL. TEST SOIL FOR QUALITY OF PERCOLATION. IF DRAINAGE IS INADEQUATE, CREATE BY AN FSC-ACCREDITED CERTIFICATION BODY TO COMPLY WITH FSC STD-01-001, "FSC PRINCIPLES AND CRITERIA FOR FOREST ii. TREES TO BE RELOCATED IN EXCESS OF 12" CALIPER SHALL BE RELOCATED VIA BOX OR OTHER APPROVED METHOD. UNDERGROUND SEEPAGE/DRAINAGE. NOTIFY LANDSCAPE ARCHITECT FOR APPROVAL. BUDGET SHOULD ALLOCATE AN ALLOWANCE TO 3H. DIGGING AND MOVING: i. DIG PITS TO A MINIMUM OF 42" DEEP WITH VERTICAL SIDES AND BOTTOMS COVER THIS POSSIBILITY AND SHOULD BE PART OF THE ORIGINAL BID. SEALANT FOR IPE WOOD SHALL BE MESSMERS WOOD SEALER- NATURAL. ii. HANDLE TREES TO AVOID DAMAGE TO BARK AND LIMBS. ATTACH SUPPORT STRAPS, CABLES, OR CHAIN AT MULTIPLE POINTS FOR WEIGHT iii. BARRICADE OR MARK EXCAVATIONS TO PREVENT HAZARDS TO MECHANICAL EQUIPMENT, VEHICLES, AND PEDESTRIANS 12. STONE: 6E. PLANTING: i. ALL MATERIALS SHALL BE FREE FROM DAMAGE, FROM EXTREMES OF TEMPERATURE AND HUMIDITY, PHYSICAL OR MECHANICAL iii. DO NOT FORCE TREE FROM GROUND PRIOR TO UNDERCUTTING ROOT BALLS. DETERMINE FINAL BALL DEPTH UPON ASSESSING i. SET TREES IN VERTICAL POSITION WITH THE TOP OF THE ROOT BALL FLUSH WITH THE ADJACENT, FINISH GRADE. AFTER SETTLEMENT, CONDITIONS AT TIME OF TRENCHING. NOTIFY LANDSCAPE ARCHITECT IF BALL DEPTH VARIES FOR SPECIFIED DEPTH. THE PLANT CROWN WILL STAND ONE (1) TO TWO (2) INCHES ABOVE GRADE. iv. PLACE TREES IN HEAVY GRADE BASKETS LINED WITH TWO LAYERS OF BURLAP FOR RELOCATION PROCEDURES. SET PLANT IN UPRIGHT POSITION IN CENTER OF PLANTING PIT AND PLACE SPECIFIED PLANTING MIX UNDER AND AROUND THE ROOT BALL. v. PLANT TOP OF ROOT BALL 3" ABOVE FINISH GRADE. FOR BURLAPPED ROOT BALLS, CUT TOP 1/3 OF BURLAP AWAY FROM ROOT BALL, AND TURN DOWN INTO THE SIDE OF THE PLANTING PIT, vi. ALL TRANSPLANTED TREES SHALL BE WATERED IN, SANDED, MULCHED, AND UNTIED ON THE SAME DAY. BEFORE PLACING PLANTING MIX AROUND THE ROOT BALL vii. STAKE OR BRACE RELOCATED TREES/ PALMS AS SHOWN ON THE DRAWINGS. iii. PROPER "JETTING IN" SHALL BE ASSURED TO ELIMINATE AIR POCKETS AROUND THE ROOTS. 'JET STICK' OR EQUAL IS RECOMMENDED. viii. SUPPORT TREE WITH MACHINERY UNTIL BRACING IS COMPLETE. iv. PRUNE TREES, REMOVING NO MORE THAN 1/3 OF TWIGS AND BRANCHES, WHILE MAINTAINING THE UNIFORM CHARACTER AND SHAPE OF iii. ALL WORKMANSHIP SHALL BE PROTECTED IMMEDIATELY UPON INSTALLATION. THE TREE. REMOVE ALL DEAD, DISEASED, RUBBING, AND DYING BRANCHES. ALL PLANT MATERIAL SHALL MEET SPECIFICATIONS AFTER 3I. POST RELOCATION: THE CONTRACTOR SHALL MAINTAIN ALL TRANSPLANTED MATERIAL IN A HEALTHY CONDITION UNTIL FINAL ACCEPTANCE CONFIRM WHETHER OR NOT MATERIAL CAN BE SUBMERGED IN WATER. ii. THE CONTRACTOR SHALL PREPARE ALL OPERATIONS NECESSARY TO ENSURE THAT PLANTS ARE HEALTHY, VIGOROUS AND UNDAMAGED. v. EARTH SHALL BE BANKED AT EDGE OF EACH PLANTING PIT TO FORM A WATERING SAUCER APPROXIMATELY 6" IN DEPTH. FLUSH PLANTING SOIL INTO PLACE WITH SLOW HOSE STREAM UNTIL AIR POCKETS ARE ELIMINATED AROUND ROOT BALL, AND PIT IS FILLED WITH PLANTING V. CONTRACTOR SHALL SUBMIT SHOP DRAWINGS OF LAYOUT. 3J. GUARANTEE: i. DEATH OF ANY RELOCATED PLANT MATERIAL SHALL BE REPLACED WITH THE SAME SIZE AND SPECIES AND APPROVED BY THE MIX TO TOP OF ROOT BALL. LANDSCAPE ARCHITECT. DETERMINATION OF SURVIVABILITY SHALL BE MADE AT THE END OF THE WARRANTEE PERIOD CRUSHED AGGREGATE FOR PERMEABLE INTERLOCKING PAVING SYSTEMS vi. PLACE MULCH IN LOOSE MEASURE 2" MIN. LAYER WITHIN EACH WATERING SAUCER. ii. RELOCATED PLANT MATERIAL INSTALLED BY THE CONTRACTOR SHALL BE WARRANTED IN WRITING FOR A PERIOD OF ONE (1) YEAR FROM vii. IF PLANTING IS PERFORMED AFTER SOD PLACEMENT, PROPER PROTECTION SHALL BE PROVIDED AND DAMAGE RESULTING FROM ii. AVOID CONTAMINATION BY SOILS AND SEDIMENT. THE DATE OF FINAL ACCEPTANCE. PLANTING OPERATIONS SHALL BE REPAIRED PROMPTLY. iii. MATERIALS STORED OR INSTALLED ON SITE SHALL BE PLACED ON FILTER FABRIC AND COVERED BY FILTER FABRIC. viii. TREE GUYING: FOR MATERIALS TO 12' IN HEIGHT, A MINIMUM OF FOUR WOVEN ANCHOR STRAP LINES EACH AT NINETY DEGREES FROM AND CONNECTED TO TREE TRUNK AND ANCHORED BELOW GRADE WITH PRESSURE TREATED STAKES. SECURE TREE AGAINST 4. MATERIALS

ix. TREE BRACING: FOR MATERIALS GREATER THAN 12' IN HEIGHT, A MINIMUM OF THREE 2X4 APPEARANCE GRADE BRACES, SET AT 60

4A. SUBMITTALS:

GENERAL SAMPLES OF MATERIALS AS LISTED BELOW SHALL BE SUBMITTED FOR APPROVAL, ON THE SITE OR AS OTHERWISE

DEGREES TO THE GROUND PLANE, EQUIDISTANT AROUND THE TRUNK OF THE TREE, AND SECURED INTO THE GROUND PLANE WITH ONE, 12" #4 REBAR OR 1/2" GALVANIZED PIPE PASSING THROUGH EACH SUCH 2X4 BRACE, DRIVEN INTO THE GROUND, AND SET FLUSH WITH THE TOP OF THE BRACE. SECURE EACH ANGLED BRACE TO ONE 12" LONG 2X4 VERTICAL BLOCK OVER FOUR LAYERS OF BURLAP. SECURE BLOCKS WITH TWO METAL OR PLASTIC STRAPS, ONE 3" FROM THE TOP AND ONE 3" FROM THE BOTTOM OF EACH BLOCK. NAIL BRACE TO BLOCK WITH FOUR 16D NAILS. SEE PLANTING DETAILS SHEET FOR ADDITIONAL INFORMATION AND BRACING DETAILS. BRACES TO BE

xi. SHRUBS AND GROUND COVERS SHALL BE EVENLY SPACED IN ACCORDANCE WITH THE DRAWING AND AS INDICATED ON THE PLANT LIST. CULTIVATE ALL PLANTING AREAS TO A MINIMUM DEPTH OF 6", REMOVE AND DISPOSE OF ALL DEBRIS. TILL INTO TOP 4" THE PLANTING SOIL

ii. DAILY WATERING AND MONITORING SHALL BE PERFORMED DURING THE TERM OF THE CONSTRUCTION CONTRACT AND UNTIL FINAL

iii. WATER SHALL BE FREE OF SUBSTANCES HARMFUL TO PLANT GROWTH, OBJECTIONABLE ODOR OR STAINING AGENTS. iv. THE WATER SHALL BE CLEAN, FREE OF SOIL, DEBRIS, POISONS, PESTICIDES, CONTAMINANTS, AND ANY OTHER MATERIAL THAT IS

v. ALL LANDSCAPED AREAS WITHIN LIMITS OF WORK SHALL BE IRRIGATED WITH AN AUTOMATIC IRRIGATION SYSTEM WHICH SHALL UTILIZE WELL AND/OR DOMESTIC WATER SUPPLY. IF DOMESTIC WATER IS USED. A BACKFLOW PREVENTER SHALL BE INSTALLED.

i. CONTRACTOR IS RESPONSIBLE FOR MAINTENANCE ON ALL LANDSCAPE MATERIALS, INCLUDING SOD, FOR NO LESS THAN NINETY (90)

ii. AFTER NINETY (90) DAYS, CONTRACTOR MUST VISIT THE SITE ONCE EVERY MONTH FOR TWELVE (12) MONTHS, AND SHALL PROVIDE THE OWNER WITH A WRITTEN LETTER NOTIFYING THE OWNER OF ANY WRONG DOING, NEGLIGENCE, OR ISSUES THAT MIGHT AFFECT THE OWNER'S WARRANTY. CONTRACTOR SHALL WARRANTY ALL LANDSCAPE MATERIAL FOR NO LESS THAN (12) MONTHS AFTER FINAL

i. OWNER IS RESPONSIBLE TO ENSURE THAT LANDSCAPING REQUIRED TO BE PLANTED PURSUANT TO CITY OF MIAMI BEACH IS INSTALLED IN COMPLIANCE WITH THE LANDSCAPE REQUIREMENTS; MAINTAINED AS TO PRESENT A HEALTHY, VIGOROUS, AND NEAT APPEARANCE FREE FROM REFUSE AND DEBRIS; AND SUFFICIENTLY FERTILIZED AND WATERED TO MAINTAIN THE PLANT MATERIAL IN A HEALTHY

ii. IF ANY TREE OR PLANT DIES WHICH IS BEING USED TO SATISFY CURRENT LANDSCAPE CODE REQUIREMENTS, SUCH TREE OR PLANT SHALL BE REPLACED WITH THE SAME LANDSCAPE MATERIAL OR AN APPROVED SUBSTITUTE MEETING CODE REQUIREMENTS.

a. ALL CUTS SHALL BE CLEAN, FLUSH, AND AT JUNCTIONS, LATERALS OR CROTCHES. ALL CUTS SHALL BE MADE AS CLOSE AS POSSIBLE TO

b. REMOVAL OF DEAD WOOD, CROSSING BRANCHES, WEAK OR INSIGNIFICANT BRANCHES, AND SUCKER SHALL BE ACCOMPLISHED

c. CUTTING OF LATERAL BRANCHES THAT RESULTS IN THE REMOVAL OF MORE THAN ONE-THIRD (1/3) OF ALL BRANCHES ON ONE (1) SIDE OF A TREE SHALL ONLY BE ALLOWED IF REQUIRED FOR HAZARD REDUCTION OR CLEARANCE PRUNING. d. LIFTING OF BRANCHES OR TREE THINNING SHALL BE DESIGNED TO DISTRIBUTE OVER HALF OF THE TREE MASS IN THE LOWER

f. TREES SHALL BE PRUNED ACCORDING TO THE CURRENT ANSI A300 STANDARDS AND THE LANDSCAPE MANUAL.

iv. TREES SHALL RECEIVE REGULAR MAINTENANCE FOR A MINIMUM OF ONE (1) YEAR FOLLOWING INSTALLATION. a. A CONTRACTED MAINTENANCE SERVICE SHALL BE RESPONSIBLE FOR FERTILIZATION AND PEST CONTROL

b. CHECK IRRIGATION HEADS AND LINES FOR BREAKS AND REGULAR FUNCTION, CHECK TIMER AND IRRIGATION SCHEDULE, ADJUST FOR SEASONAL WATER USAGE. CHECK AND MAKE SURE THAT RAIN SENSOR IS WORKING AT ALL TIMES.

c. CHECK ALL DRAINS FOR PROPER DRAINAGE. ADDRESS CLOGS AND RESOLVE MAINTENANCE ISSUES. d. OBSERVE ALL PLANTS TO ENSURE THAT NO ABNORMAL YELLOWING OR DISFIGUREMENT OCCURS WHICH INDICATE NUTRIENT

e. REPLACE OR REPAIR BRACING AS NECESSARY. MAINTAIN UNTIL LANDSCAPE CONTRACTOR DEEMS APPROPRIATE FOR REMOVAL SO THAT TREE HAS DEVELOPED A SUBSTANTIAL ROOT MASS AND HAS NATURAL STABILITY. DO NOT REMOVE DURING HURRICANE SEASON.

f. TREES SHALL BE MAINTAINED IN A FIRM POSITION IN THE GROUND AND ALL STAKES AND GUYS SHALL BE CHECKED REGULARLY. g. PROVIDE MULCH OVER ROOTS TO DRIP LINE OF TREE IF APPLICABLE OR WITHIN TREE PLANTING RING/PLANTER BED. ADD FRESH MULCH

i. LANDSCAPE INSPECTIONS SHALL OCCUR AFTER STRONG WINDS, TROPICAL STORMS, HURRICANES, AND OTHER DISTURBANCES OF

iv. CERTIFICATES FROM SUPPLIERS STATING THAT THE DELIVERED PLANTING MIX, DELIVERED PLANT MATERIALS, AND FERTILIZER COMPLY

v. CERTIFICATES OF INSPECTIONS: SHIPMENTS OR ORDERS OF PLANT MATERIAL SHALL BE PROPERLY INSPECTED AT NURSERY OR GROWING SITE BY AUTHORIZED FEDERAL AND STATE AUTHORITIES; INCLUDE CERTIFICATES WITH SHIPMENT.

9A. SHOP DRAWINGS, PRODUCT DATA, MOCK-UPS, OR SAMPLES FOR THE FOLLOWING:

ii. ELECTRICAL FIXTURES - PRODUCT DATA, AND FOUNDATION DETAILS (SHALL BE INCLUDED IN CONTRACTOR'S BID)

viii. CONCRETE MIX AND COLORS - DESIGN MIX SAMPLE AND PRODUCT SAMPLE. CREATE ON SITE A MOCK UP 6'X6' OF THE FINISHED CONCRETE SLAB AND DO NOT DESTROY OR REMOVE FROM THE JOB SITE UNTIL COMPLETION OF ALL SLABS ON GRADE AND ACCEPTANCE

NUTRIENTS, AND RECOMMENDATIONS OF SOIL AMENDMENTS FOR PROPOSED LANDSCAPE PLANTING

9B. ALL MOCK UPS, SAMPLES, AND SHOP DRAWINGS SHALL BE A PART OF THE ORIGINAL CONTRACT COST.

SHOP DRAWINGS: SUBMIT FOR APPROVAL, COMPLETE SHOP DRAWINGS SHOWING FENCING LAYOUT INCLUDING ALL ATTACHMENT

iii. SAMPLES: SUBMIT SAMPLE OF FENCING COMPONENT PARTS AND MANUFACTURER'S FENCING SPECIFICATION FOR LANDSCAPE

i. GATES, POSTS AND RAILS: AS PER DETAILS ON DRAWING SHEETS. WORKING HARDWARE: AS PER DETAILS ON DRAWINGS. USE ALL 316 STAINLESS STEEL HARDWARE, CONNECTORS, AND FASTENERS. MINIMUM (2) SCREWS AT EACH IPE/WOOD CONNECTION IF APPLICABLE. #8 DECK SCREWS, STAINLESS STEEL 316, SQUARE DRIVE, HEAD #2 BY SIMPSON STRONG TIE OR APPROVED EQUAL

HARDWARE, INCLUDE STAINLESS STEEL CANE BOLT AS REQUIRED. BRACE GATES AS REQUIRED TO PREVENT DISTORTION AND/OR

BLEMISHES OF ANY KIND SUCH AS BUT NOT LIMITED TO CRACKING, WARPING, OR SPLITTING, AND FREE FROM STAINING DUE TO RUST, CORROSION, MILDEW, ROT, OR ANY EXTERNAL SOURCE AT THE TIME OF INSTALLATION AND PRIOR TO FINAL ACCEPTANCE. ii. ALL STONE MATERIALS SHALL BE SEALED WITH MIRACLE 511 IMPREGNATING SEALER PRIOR TO OR IMMEDIATELY FOLLOWING INSTALLATION. STONE SHALL BE BRUSHED CLEAN PRIOR TO APPLICATION OF SEALER; FREE OF DUST, DEBRIS, OR STAINS AND SHALL BE

iv. IN POOL DECK CONDITIONS: MATERIAL SHALL COMPLY WITH CODE REQUIREMENTS, BE PROPERLY INSTALLED, STABLE, FIRM AND SLIP RESISTANT. MANUFACTURER/SUPPLIER TO CONFIRM THAT MATERIAL IS SUITABLE FOR USE IN EXTERIOR POOL ENVIRONMENT AND SHALL

AGGREGATES SHALL BE DUMPED, SPREAD AND COMPACTED WHEN THEY ARRIVE AT THE SITE.

iv. CONTRACTOR TO PROVIDE SILT FENCING AROUND INSTALLATION SITE. v. CONCRETE PAVERS SHALL BE INSTALLED IMMEDIATELY AFTER AGGREGATE BASE IS PLACED AND SPREAD.

PRICE RESIDENCE MIAMI BEACH, F

SITE ADDRESS:

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LANDSCAPE ARCHITECT

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DRAWING TITLE:

GENERAL LANDSCAPE

(C)	20	121	1 (ΙΔΙ)

REVISIONS:

08/16/21 DRB 1ST SUBMITTAL FINAL DRB SUBMITTAL 09/03/21

DATE

SCALE:

PROJ. N°: