

- CHI RESTAURANT

LOT 4, LESS THE WESTERLY 25.00 FEET THERE OF, BLOCK 2, FISHER'S FIRST SUBDIVISION OF ALTON BEACH, AS RECORDED IN PLAT BOOK 2 AT PAGE 77 OF THE PUBLIC RECORDS OF MIAMI-DADE COUNTY, FLORIDA. 1826 COLLINS AVE, FLORIDA, 33139. PROPERTY CONTAINS 9,557 SQUARE FEET, MORE OR LESS, OR 0.219 ACRES, MORE OR LESS.

GENERAL NOTES

- CONTRACTOR TO FURNISH ALL LABOR AND MATERIALS NECESSARY FOR A COMPLETE INSTALLATION AS DETAILED HEREIN. EACH CONTRACTOR SHALL RESPECT THE WORK OF OTHER CONTRACTORS AND IS RESPONSIBLE FOR AND LIABLE TO REPAIR OR REPLACE ANY DAMAGE CAUSED BY HIS WORK. STORAGE: THE CONTRACTOR SHALL PROVIDE ON—SITE, WEATHER PROTECTED STORAGE.
- CODES: ALL WORK SHALL BE PERFORMED IN STRICT COMPLIANCE WITH LOCAL AND STATE CODES AND REGULATIONS HAVING JURISDICTION. THE CONTRACTOR SHALL PROTECT AND NDEMNIFY. THE OWNER AND ARCHITECT AGAINST ANY CLAIM OR LIABILITY ARISING FROM VIOLATION OF ANY SUCH CODE OR REGULATION. THE CONTRACTOR SHALL OBTAIN AND PAY FOR ALL REQUIRED PERMITS, INSPECTIONS, AND APPROVALS..
- QUALITY: WORKMANSHIP SHALL BE OF THE HIGHEST TYPE, AND MATERIALS USED OR SPECIFIED TO BE OF THE BEST QUALITY THAT THE MARKET AFFORDS. ALL INSTALLATIONS AND APPLICATIONS SHALL CONFORM TO THE MANUFACTURER'S SPECIFICATIONS.
- COORDINATION OF THE WORK: THE GENERAL CONTRACTOR SHALL COORDINATE THE WORK OF ALL SUBCONTRACTORS AND MECHANICAL TRADES WHETHER THEY RECEIVE THEIR CONTRACT FROM THE CONTRACTOR OR OWNER. THE CONTRACTOR'S INSTRUCTIONS SHALL BE FOLLOWED BY ALL TRADES.
- MECHANICAL TRADES: THE MECHANICAL AND ELECTRICAL TRADES SHALL INSTALL THEIR WORK AS RAPIDLY AS THE OTHER WORK PERMITS, AND SHALL COMPLETE THE WORK BY THE TIME THE OTHER TRADES HAVE FINISHED. 8. EXAMINATION OF SITE AND DOCUMENTS: THE CONTRACTOR, BEFORE SUBMITTING HIS PROPOSAL, SHALL VISIT THE SITE AND EXAMINE FOR HIMSELF ALL CONDITIONS AND LIMITATIONS WHICH AFFECT THE CONTRACT. HE SHALL CAREFULLY EXAMINE ALL CONTRACT DOCUMENTS. TITLES AND SUBDIVISIONS IN THESE DOCUMENTS ARE FOR CONVENIENCE, AND NO
- REAL OR ALLEGED ERRORS IN ARRANGEMENT OF MATTER SHALL BE REASON FOR OMISSION OR DUPLICATION BY ANY CONTRACTOR. 9. SEPARATE CONTRACTS: THE OWNER RESERVES THE RIGHT TO LET OTHER CONTRACTS IN CONNECTION WITH THE WORK. THE GENERAL CONTRACTOR SHALL AFFORD OTHER CONTRACTORS REASONABLE OPPORTUNITY FOR THE EXECUTION OF THEIR WORK AND SHALL PROPERLY CONNECT AND COORDINATE HIS WORK WITH THEIRS.
- 10. GUARANTEE: ALL MATERIALS AND WORKMANSHIP SHALL BE GUARANTEED FOR A PERIOD OF ONE YEAR FROM THE DATE OF FINAL ACCEPTANCE UNLESS OTHERWISE SPECIFIED FOR A 11. TRASH REMOVAL: EACH CONTRACTOR SHALL PROVIDE TRASH REMOVAL. AT THE END OF EACH DAY, EACH CONTRACTOR SHALL REMOVE ALL TRASH AND DEBRIS FROM THE SITE
- AND/OR WITHIN THE BUILDING AREA. CONSTRUCTION AREA SHOULD BE SWEPT CLEAN. IF TRASH AND DEBRIS ARE NOT REMOVED, THE OWNER MAY (AT HIS OPTION) PAY FOR ITS REMOVAL AND BACK CHARGE THE CONTRACTOR 12. THE CONTRACTOR SHALL VERIFY ALL DIMENSIONS AND SITE CONDITIONS AT THE SITE AND REPORT ANY DISCREPANCY TO THE ARCHITECT BEFORE PROCEEDING WITH THE WORK OR
- SHALL BEAR FULL RESPONSIBILITY. 13. STUCCO APPLIED TO CONCRETE OR MASONRY TO MEET FIRE RESISTIVE REQUIREMENTS SHALL CONSIST OF AT LEAST 2 COATS AND THE TOTAL THICKENS SHALL BE NO LESS THAN
- 14. THE GENERAL CONTRACTOR SHALL COORDINATE THE LOCATION AND SIZE OF OPENINGS FOR VENTS, PIPES, INSERTS, BOXES, HANGERS, A/C DUCTS, ETC. 15. GENERAL CONDITIONS: THE GENERAL CONDITIONS FOR THIS CONTRACT SHALL BE AIA 201 1987 EDITION. EXCEPT AS HEREIN AMENDED.
- 16. ALL SECTIONS, DETAILS, MATERIALS, METHODS, ETC. SHOWN AND/OR NOTED ON ANY PLAN OR SECTION SHALL APPLY TO ALL OTHER SIMILAR LOCATIONS UNLESS OTHERWISE NOTED. 17. THE GENERAL CONTRACTOR SHALL SAFELY SHORE, BRACE, OR SUPPORT ALL WORK AS REQUIRED. THIS WORK SHALL BE THE FULL RESPONSIBILITY OF THE CONTRACTOR, AND NO ACT, DIRECTION, OR REVIEW OF ANY SYSTEM OR METHOD BY THE ARCHITECT SHALL RELIEVE THE CONTRACTOR OF THIS RESPONSIBILITY.
- 19. IT IS NOT THE INTENT OF THESE DRAWINGS TO SHOW NOR INDICATE ALL FASTENING OR FRAMING TECHNIQUES AND/OR DEVICES, OR TO SHOW ALL CONDITIONS PRESENT. 20. NOTE: ALL EXIT DOORS AND FRAMES CLASSIFIED AS "B" LABEL 1 1/2" HRS. FIRE PROTECTION SHALL BE LABELED SHOWING THAT SUCH DOORS DEVELOP ON THE UNEXPOSED
- FACE, AT THE END OF 30 MIN. OF FIRE EXPOSURE A TEMPERATURE THAT SHALL NOT EXCEED 450 F. 21. ALL SUCH FIRE RATED DOORS, FRAME AND WINDOWS MUST CONFORM W/SEC.3701.2(C) STD. METHOD OF FIRE TEST FOR DOOR ASSEMBLIES ASTM-E-152 (DOORS) AND 3701.2(C) OF WINDOWS ASSEMBLIES, ASTM-E-163.
- 22. SUBMIT SAMPLES OF ALL PAINTS AND STAINS FOR APPROVAL BY THE DESIGNER PRIOR TO APPLICATION. 23. UNLESS OTHERWISE NOTED, ALL FRAMING AND FINISH LUMBER ARE SIZED IN NOMINAL DIMENSIONS.
- 24. CONTRACTOR TO FIELD VERIFY ALL EXISTING UTILITIES AND REROUTE AS REQUIRED.
- 25. GENERAL CONTRACTOR TO PROVIDE ALL MEANS TO SECURE AND PROTECT CONSTRUCTION AREA FROM THE PUBLIC. 26. ALL PIPING, CONDUIT, BX CABLE AND SIMILAR CONSTRUCTION WILL BE LOCATED INSIDE A WALL
- 27. ALL EXPOSED EXISTING RAW WOOD WILL BE SEALED ON ALL SIDES PRIOR TO INSTALLATION. ALL NEW WOOD TO BE INHERENTLY FIRE RETARDANT.
- 28. ALL ANGULAR OPENINGS IN CONSTRUCTION WILL BE SEALED TO WITHIN 1/32".
- 29. PROVIDE PLYWOOD AND BLOCKING ON WALLS FOR ALL TOILET ROOM FIXTURES, CABINET HEATERS, KITCHEN WALLS AND MISCELLANIES. 30. PROVIDE WOOD TRIM AS REQUIRED TO CASE OPENINGS.
- 31. ALL FIRE RATED DOORS SHALL BE SELF CLOSED FROM 45° OPENING.

18. ALL WORK IS NEW UNLESS OTHERWISE NOTED.

VERT. CIRCULATION PARKING COMMERICAL

> MECH./ELEC. TOTAL

FLOOR AREA RATIO (FAR):

MAX. ALLOWED 1.5 (14,335 SF)

530 S.F.

EXIST. TOTAL 8,399 SQ.FT. PROPOSED TOTAL 8,648 SQ.FT.

- 32. PROVIDE HAND HELD FIRE EXTINGUISHERS ACCORDING TO THE LOCAL FIRE MARSHALL REQUIREMENTS MIN. 5# ABD. 33. THE GENERAL CONTRACTOR MUST SUBMIT A CONSTRUCTION SCHEDULE.
- 34. THE GENERAL CONTRACTOR & HIS SUBCONTRACTORS MUST ASSURE COMPLIANCE WITH BUILDING AND ZONING CODES.
- 35. PROVIDE SHOP DRAWINGS ON ALL STEEL, DOORS, WINDOWS, PLUMBING FIXTURES, ETC, FOR APPROVAL OR CONTRACTOR WILL BEAR FULL RESPONSIBILITY. 36. ALL ABANDONED PIPING MUST BE REMOVED & DISPOSED BEFORE COMMENCEMENT OF WORK.
- 37. SUBMIT SAMPLES OF ALL TRIM AND FINISH MATERIAL FOR APPROVAL BY THE DESIGNER PRIOR TO APPLICATION. 38. PATCH EXISTING EXTERIOR AND INTERIOR WALL AS REQUIRED.
- 39. SEAL ALL EXISTING PENETRATIONS THAT ARE NOT IN USE.
- 40. ANY DAMAGE TO WATERPROOFING MEMBRANE BELOW STRUCTURAL SALB TO BE REPAIRED AND GUARANTEED BY ORIGINAL INSTALLER. LAPS MUST BE BONDED AND TAPED.
- 41. GC MUST PROVIDE SUBCONTRACTOR WITH COMPLETE SET OF WORKING DRAWINGS OF ALL TRADES

CONTRACTOR SHALL VERIFY ALL DIMENSIONS AND SITE CONDITIONS BEFORE PROCEEDING WITH WORK. IF ANY DISCREPANCIES, ERRORS OR OMISSIONS SHOULD BE ENCOUNTERED ON PLANS, CONTRACTOR SHALL NOTIFY ARCHITECT BEFORE ANY PART OF THE WORK IS STARTED, SO THAT PROPER CORRECTIONS BE MADE. IF ARCHITECT IS NOT NOTIFIED PRIOR TO COMMENCING OF THE WORK, THE CONTRACTOR SHALL BEAR FULL RESPONSIBILITY FOR ANY DISCREPANCIES, ERRORS OR OMISSIONS.

SCALE= $\frac{1}{4}$ "-0'

SCALE= $\frac{1}{4}$ "-0"

SCALE= $\frac{1}{4}$ "-0'

AS NOTED

AS NOTED

AS NOTED

ARCHITECTURAL A-O GEN NOTES PROJECT INFORMATION A-2 GROUND LEVEL FURNITURE PLAN

 $SCALE = \frac{1}{4}$ "-0" A-3 GROUND LEVEL FINISH FLOOR PLAN SCALE= $\frac{1}{4}$ "-0" A-4 GROUND LEVEL REFLECTED CEILING PLAN SCALE= $\frac{1}{4}$ "-0" A-5 PROPOSED SECOND LEVEL FLOOR PLAN $SCALE = \frac{1}{4}$ "-0" A-6 SECOND LEVEL FURNITURE/EQUIPMENT PLAN $SCALE = \frac{1}{4}$ "-0" A-7 SECOND LEVEL FINISH FLOOR PLAN SCALE= $\frac{1}{4}$ "-0' A-8 SECOND LEVEL REFLECTED CEILING PLAN SCALE= $\frac{1}{4}$ "-0" A-9 PROPOSED THIRD LEVEL FLOOR PLAN SCALE= $\frac{1}{4}$ "-0' A-10 THIRD LEVEL FURNITURE/EQUIPMENT PLAN SCALE= $\frac{1}{4}$ "-0" A-11 THIRD LEVEL FINISH FLOOR PLAN A-12 THIRD LEVEL REFLECTED CEILING PLAN $SCALE = \frac{1}{4}$ "-0" A-13 PROPOSED FOURTH LEVEL FLOOR PLAN SCALE= $\frac{1}{4}$ "-0' SCALE= $\frac{1}{4}$ "-0'

A-14 FOURTH LEVEL FURNITURE/EQUIPMENT PLAN A-15 FOURTH LEVEL FINISH FLOOR PLAN A-16 FOURTH LEVEL REFLECTED CEILING PLAN A-17 ROOF LEVEL EQUIPMENT PLAN A-18 SECTIONS A-19 SECTIONS A-20 SCHEDULES, DETAILS

A-21 UL PARTITION & JOINT DETAILS

NTS LS-1 GROUND FLOOR LIFE SAFETY PLAN SCALE= 1/8"-0" KITCHEN EXHAUST HOOD AS NOTED H-1 HOOD/FAN DETAILS H-2 FIRE SUPPRESSION DETAILS

AS NOTED HOOD ELEVATIONS AS NOTED H-4 HOOD SECTION VIEW AS NOTED H-5 2ND FLOOR PLAN VIEW AS NOTED H-6 3RD FLOOR PLAN VIEW AS NOTED H-7 4TH FLOOR PLAN VIEW AS NOTED H-8 ROOF PLAN AS NOTED

AC-1 HVAC-GROUND LEVEL FLOOR PLAN & LEGEND AS NOTED AC-2 HVAC-SECOND LEVEL FLOOR PLAN & DETAILS AS NOTED AC-3 HVAC-THIRD LEVEL FLOOR PLAN & DETAILS AS NOTED AC-4 HVAC-FOURTH LEVEL FLOOR PLAN & DETAILS AS NOTED AC-5 HVAC-ROOF PLAN & DETAILS AS NOTED AC-6 HVAC-SCHEDULES & DETAILS AS NOTED AC-7 HVAC-SCHEDULES & DETAILS AS NOTED AC-8 DETAILS AS NOTED AC-9 GENERAL NOTES & DETAILS AS NOTED

P-1 PLUMBING-GROUND LEVEL FLOOR PLAN AS NOTED P-2 PLUMBING-SECOND LEVEL SANITARY & GREASE WASTE PLAN AS NOTED P-3 PLUMBING-SECOND LEVEL WATER & GAS PLAN AS NOTED P-4 PLUMBING-THIRD LEVEL SANITARY & GREASE WASTE PLAN AS NOTED AS NOTED P-5 PLUMBING-THIRD LEVEL WATER & GAS PLAN P-6 PLUMBING-FOURTH LEVEL PLAN AS NOTED P-7 PLUMBING-SANITARY ISOMETRIC AS NOTED P-8 PLUMBING-WATER & GAS ISOMETRIC AS NOTED P-9 PLUMBING-GREASE WASTE ISOMETRIC ELECTRICAL E-1 ELECTRICAL-GROUND LEVEL FLOOR PLAN AS NOTED E-2 ELECTRICAL-SECOND LEVEL FLOOR PLAN AS NOTED AS NOTED E-3 LIGHTING-SECOND LEVEL FLOOR PLAN AS NOTED E-4 PHOTOMETRIC EMERGENCY LIGHTS GROUND & SECOND LEVEL E-5 ELETRICAL-THIRD LEVEL FLOOR PLAN AS NOTED AS NOTED E-6 LIGHTING-THIRD LEVEL FLOOR PLAN E-7 ELECTRICAL-FOURTH LEVEL FLOOR PLAN AS NOTED E-8 LIGHTING FOURTH LEVEL FLOOR PLAN AS NOTED E-9 PHOTOMETRIC EMERGENCY LIGHTS THIRD & FOURTH LEVEL AS NOTED E-10 ELECTRICAL ROOF PLAN AS NOTED

E-11 ELECTRICAL GENERAL NOTES E-12 PANELS SCHEDULES E-13 FLECTRICAL RISER DIAGRAM
E-14 FOR REFERENCE ONLY: LIGHTING CONTROL INFO.

FIRE ALARM FA-1 FIRE ALARM FLOORS PLAN AS NOTED FA-2 FIRE ALARM NOTES& LEGEND AS NOTED FIRE SPRINKLER FP-1 FIRE SPRINKLER-GROUND LEVEL FLOOR PLAN AS NOTED FP-2 FIRE SPRINKLER-SECOND LEVEL FLOOR PLAN AS NOTED FP-3 FIRE SPRINKLER-THIRD LEVEL FLOOR PLAN AS NOTED

PROJECT DIRECTORY

PROJECT ARCHITECT

CHARLES H. BENSON & ASSOC, ARCH. 1665 WASHINGTON AVE. 2ND. FLOOR MIAMI BEACH FL. 33139 PHONE 305-532-6161 FAX 305-532-6151 EMAIL: carkitect@aol.com

PROJECT MEP ENGINEER LAUREDO ENGINEERING CO

100 ALMERIA AVE. SUITE 220 P.O. BOX 772934 CORAL GABLES, FL. 33134 PHONE 786-462-0795 FAX 305-445-9725

KITCHEN CONSULTANT COMM KITCHEN PLANNERS, INC. CAPTIVE AIRE

CORAL SPRINGS, FL 33077 PHONE 954-600-0234

6191 ORANGE DRIVE

DAVIE, FL. 32714 PHONE 800-477-0454 FAX 321-779-1219

FP-4 FIRE SPRINKLER-FOURTH LEVEL FLOOR PLAN

INTERIOR DESIGNER PROSPECT DESIGN

AS NOTED

AS NOTED

AS NOTED

15 AVENUE PRINCE DE GALLES 06400 CANNES-FRANCE PHONE (0033)4-92590044 FAX (0033)4-93398648 prospect.design@wanadoo.fr

BUILDING DEPARTMENT DATA

SCOPE OF WORK PER FBC:

1A ALTERATION: LEVEL 3 ACCORDING TO SECTION 404 FBC (EXISTING) THIS IS A NEW RESTAURANT IN AN EXISTING SPACE

SITE INFORMATION: ZONING DESIGNATION

CONSTRUCTION TYPE FBC SECC_602: CONSTRUCTION TYPE IIA. $/\!\!\!/$ CONSTRUCTION REQUIREMENTS FOR EXISTING BUILDING IN SHEET LS-1

FLOOR AREA RATIO (FAR):

MAX. ALLOWED 1.5 (14,335 SF) EXIST. TOTAL 8,399 SQ.FT. (PROPOSED TOTAL 8,648 SQ.FT.

OCCUPANCY CLASSIFICATION: A-2 ASSEMBLY OCUPANCY

SCHEDULE OF AREAS: TOTAL GROSS AREA (SF): 7,847 SF

(–ĽEVEĽ 1 °= °438 °SF ° >-LEVEL 2 = 2,696 SF < -LEVEL 3 = 2,675 SF <

\-LEVEL 4 = 2,038 SF\

CODE REVIEW INFORMATION: APPLICABLE CODES: ALL WORK DONE UNDER THIS CONTRACT SHALL COMPLY WITH THE PROVISIONS OF THE SPECIFICATIONS, DRAWINGS & CONSTRUCTION CRITERIA OF THE LANDLORD, AND SHALL SATISFY ALL

APPLICABLE CODES, ORDINANCES, AND REGULATIONS OF ALL GOVERNING BODIES INVOLVED. ANY MODIFICATIONS TO THE CONTRACT WORK REQUIRED BY SUCH AUTHORITIES SHALL BE PERFORMED BY THE TENANT'S CONTRACTOR. ALL PERMITS AND LICENSES NECESSARY FOR THE EXECUTION OF THE WORK SHALL BE SECURED AND PAID FOR BY THE TENANT'S CONTRACTOR(S). APPLICABLE CODES INCLUDE, BUT ARE NOT LIMITED TO THE FOLLOWING:

APPLICABLE BUILDING CODES:

2010 - FLORIDA BUILDING CODE EXISTING W/ADDENDUM BUILDING & STRUCTURAL: 2010 - FLORIDA BUILDING CODE W/ ADDENDUM PLUMBING: 2010 - FLORIDA PLUMBING CODE W/ ADDENDUM LIFE SAFETY: 2010 - FLORIDA FIRE PREVENTION CODE MECHANICAL: 2010 - FLORIDA MECHANICAL CODE W/ADDENDUM ELECTRICAL: 2008 - FLORIDA ELECTRICAL CODE ACCESSIBILITY: 2010 - FLORIDA ADA COMPLIANCE CODE 2010 - FLORIDA ENERGY CODE

ITEMS NOT PART OF PERMIT:

GENERAL CONTRACTOR SHALL SUBMIT FABRICATION SHOP DRAWINGS TO THE ARCHITECT FOR APPROVAL PRIOR TO ORDERING OR FABRICATION.

2. THE GENERAL CONTRACTOR SHALL SUBMIT MANUFACTURER'S CUTS FOR ALL FIXTURES AND EQUIPMENT CALLED FOR ON THE CONSTRUCTION DOCUMENTS TO ARCHITECT INCLUDING BUT

NOT LIMITED TO LIGHT FIXTURES, HARDWARE PLUMBING FIXTURES, KITCHEN EQUIPMENT, ETC. . BY SUBMITTING SHOP DRAWINGS AND PRODUCT DATA, THE CONTRACTOR REPRESENTS THAT HE/SHE HAS VERIFIED FIELD CONDITIONS, DIMENSIONS, AND RELATED CONSTRUCTION AND HAS COORDINATED THE SUBMISSION CONSTRUCTION WITH THE REQUIREMENTS OF ALL OTHER RELATED WORK IN THE CONSTRUCTION DOCUMENTS.

NUMBER

-WATER HEATER STEEL PLATFORM

-SIGN PACKAGE -METAL STAIRCASE -RAILINGS -HAND RAILINGS -MOTORIZED SHADES -TRASH CHUTE SYSTEM

1\ 04-30-13 CITY COMMENTS: TYPE OF CONSTRUCTION GENERAL NOTE #27 RECTIFIED, AREAS

ISSUED FOR PERMIT 2-18-2013 ISSUED FOR BIDDING <u>2-18-2013</u> ISSUED FOR CONSTRUCTION

/2\ 06-14-13 CITY COMMENTS: NEW SITE PLAN SHEET A-0.1

— ()

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NEW RESTAURANT FOR:

CHI SEAFOOD, LLC

1826 COLLINS AVE.

Miami Beach, Fl. 33139



CHARLES H. BENSON & ASSOCIATES ARCHITECTS, P.A. architect planner interiors

1665 WASHINGTON AVE. 2nd. FLOOR MIAMI BEACH, FLORIDA 33139 ARCHITECTURE LICENCE # AR14022

Ph: 305-532-6161 * Fax: 305-532-6151 NCARB CERTIFICATE # 42,136 Lilian R. Paez C.

SCALE


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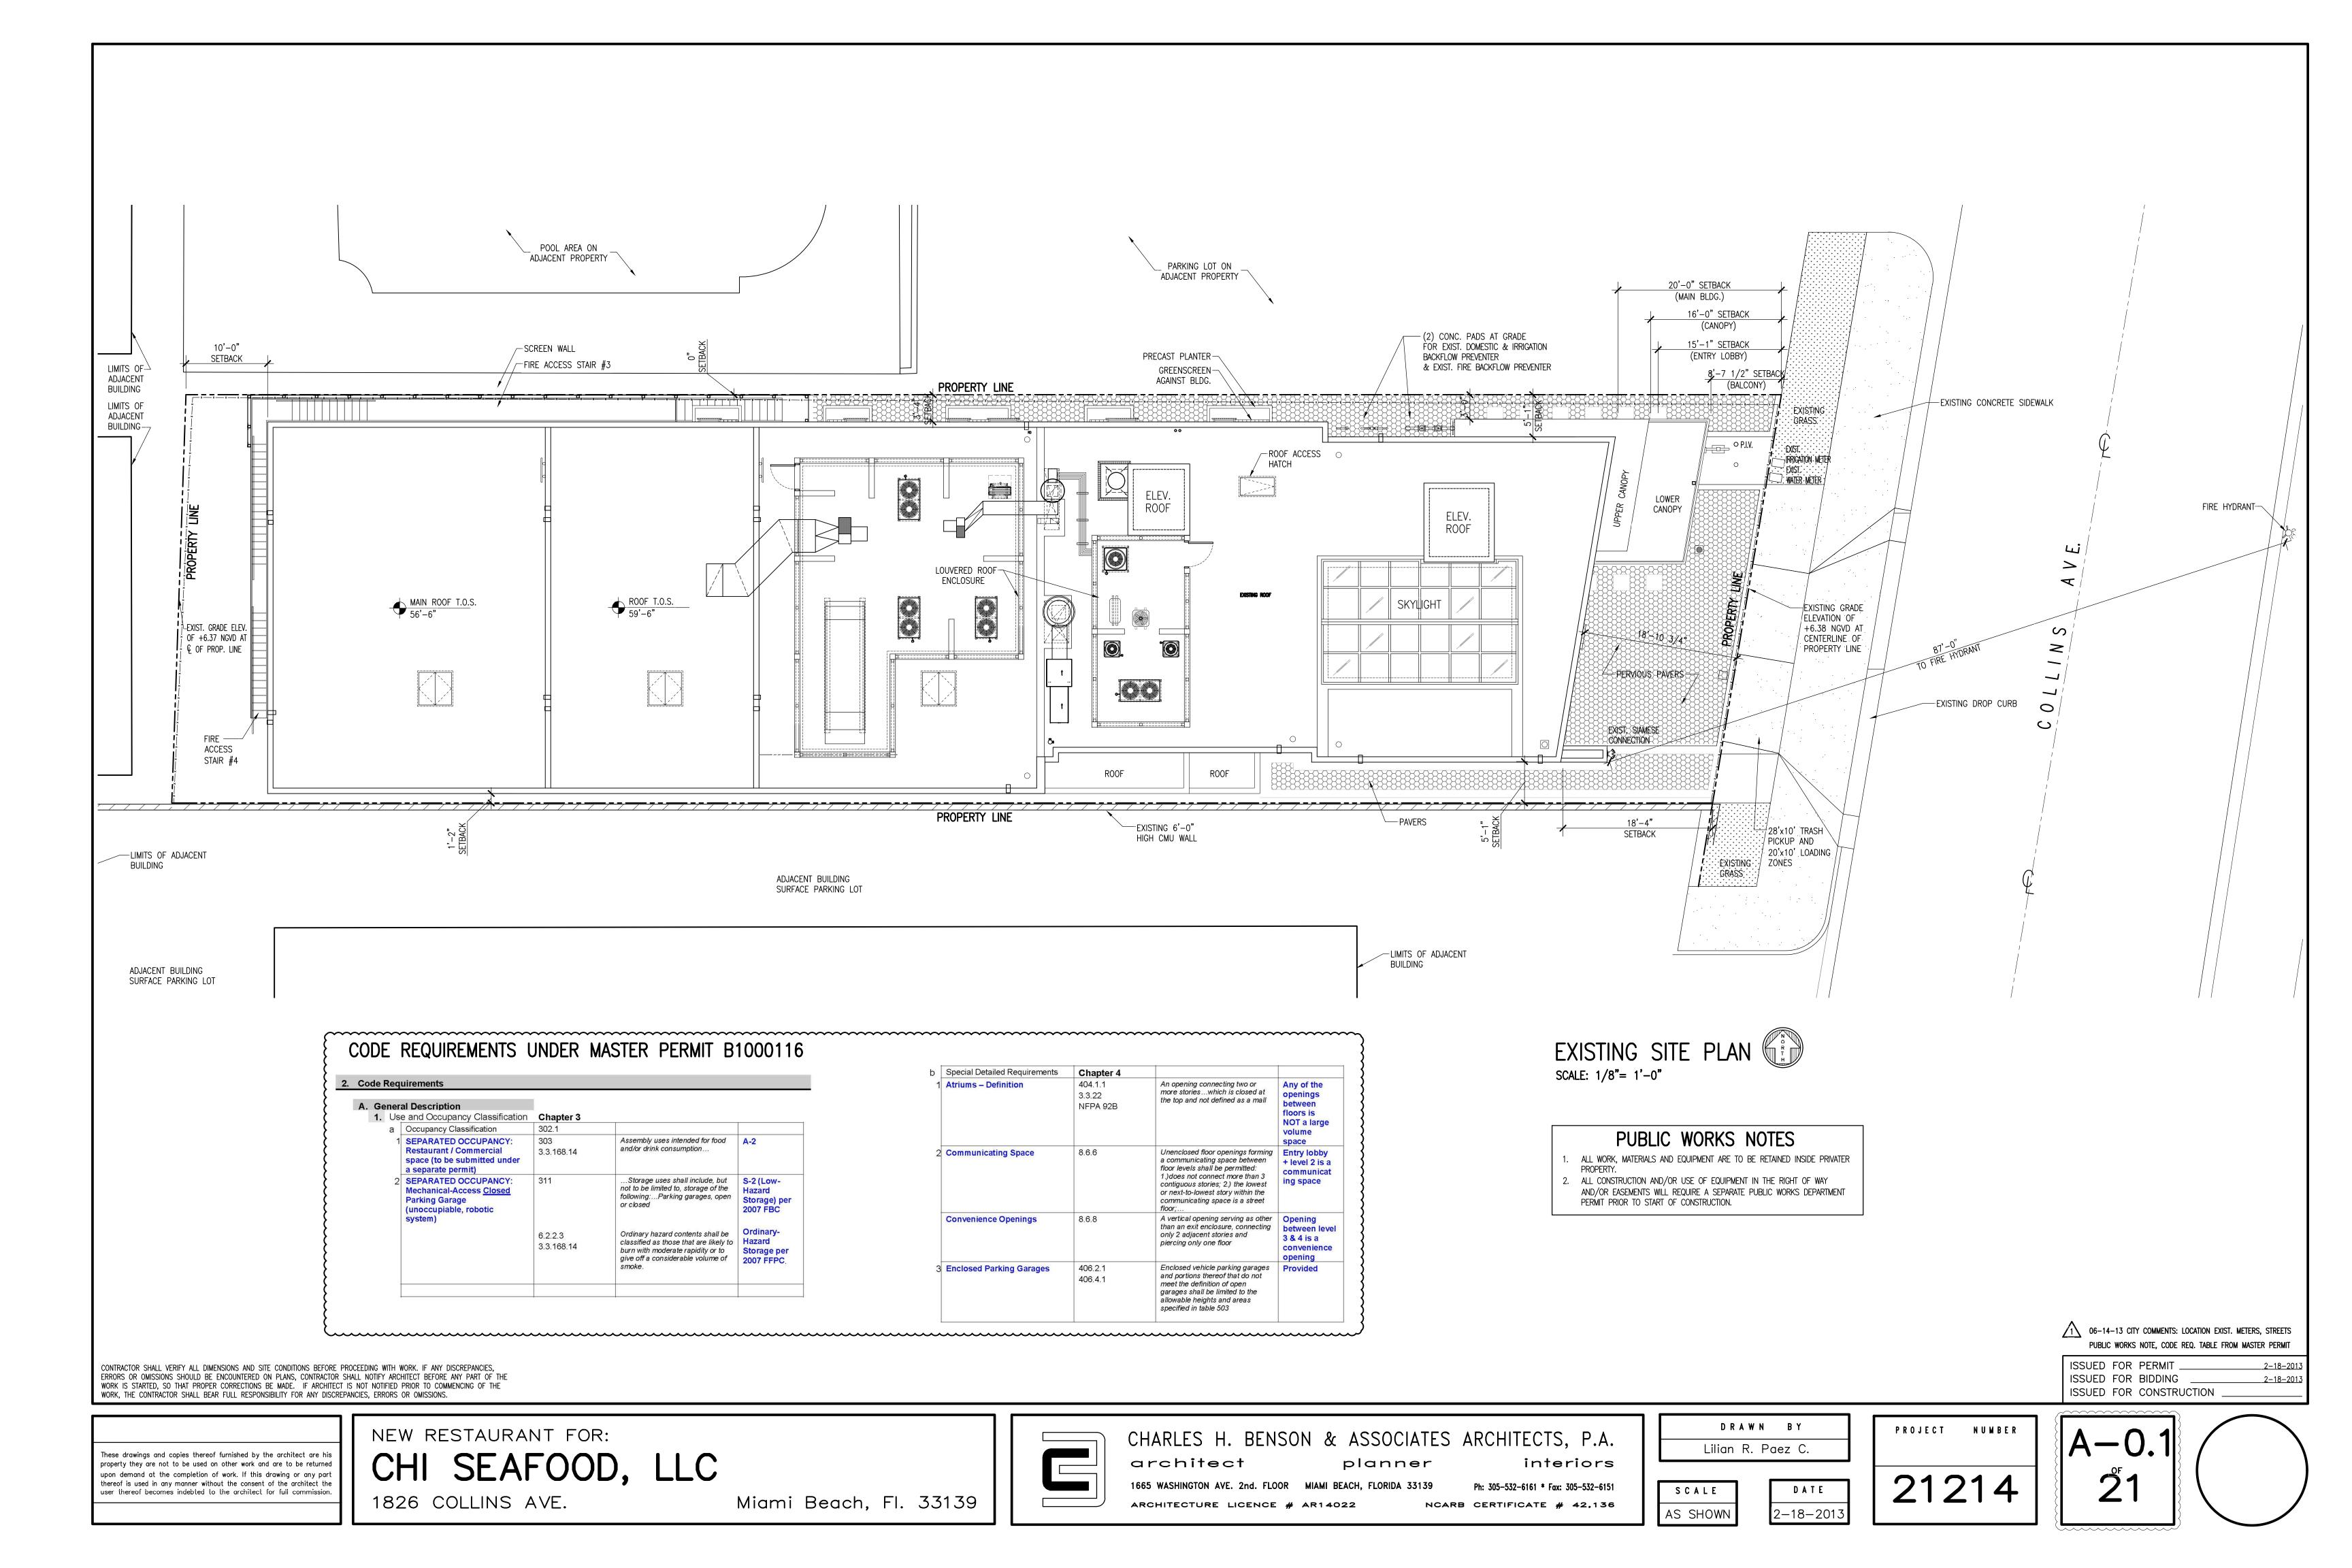
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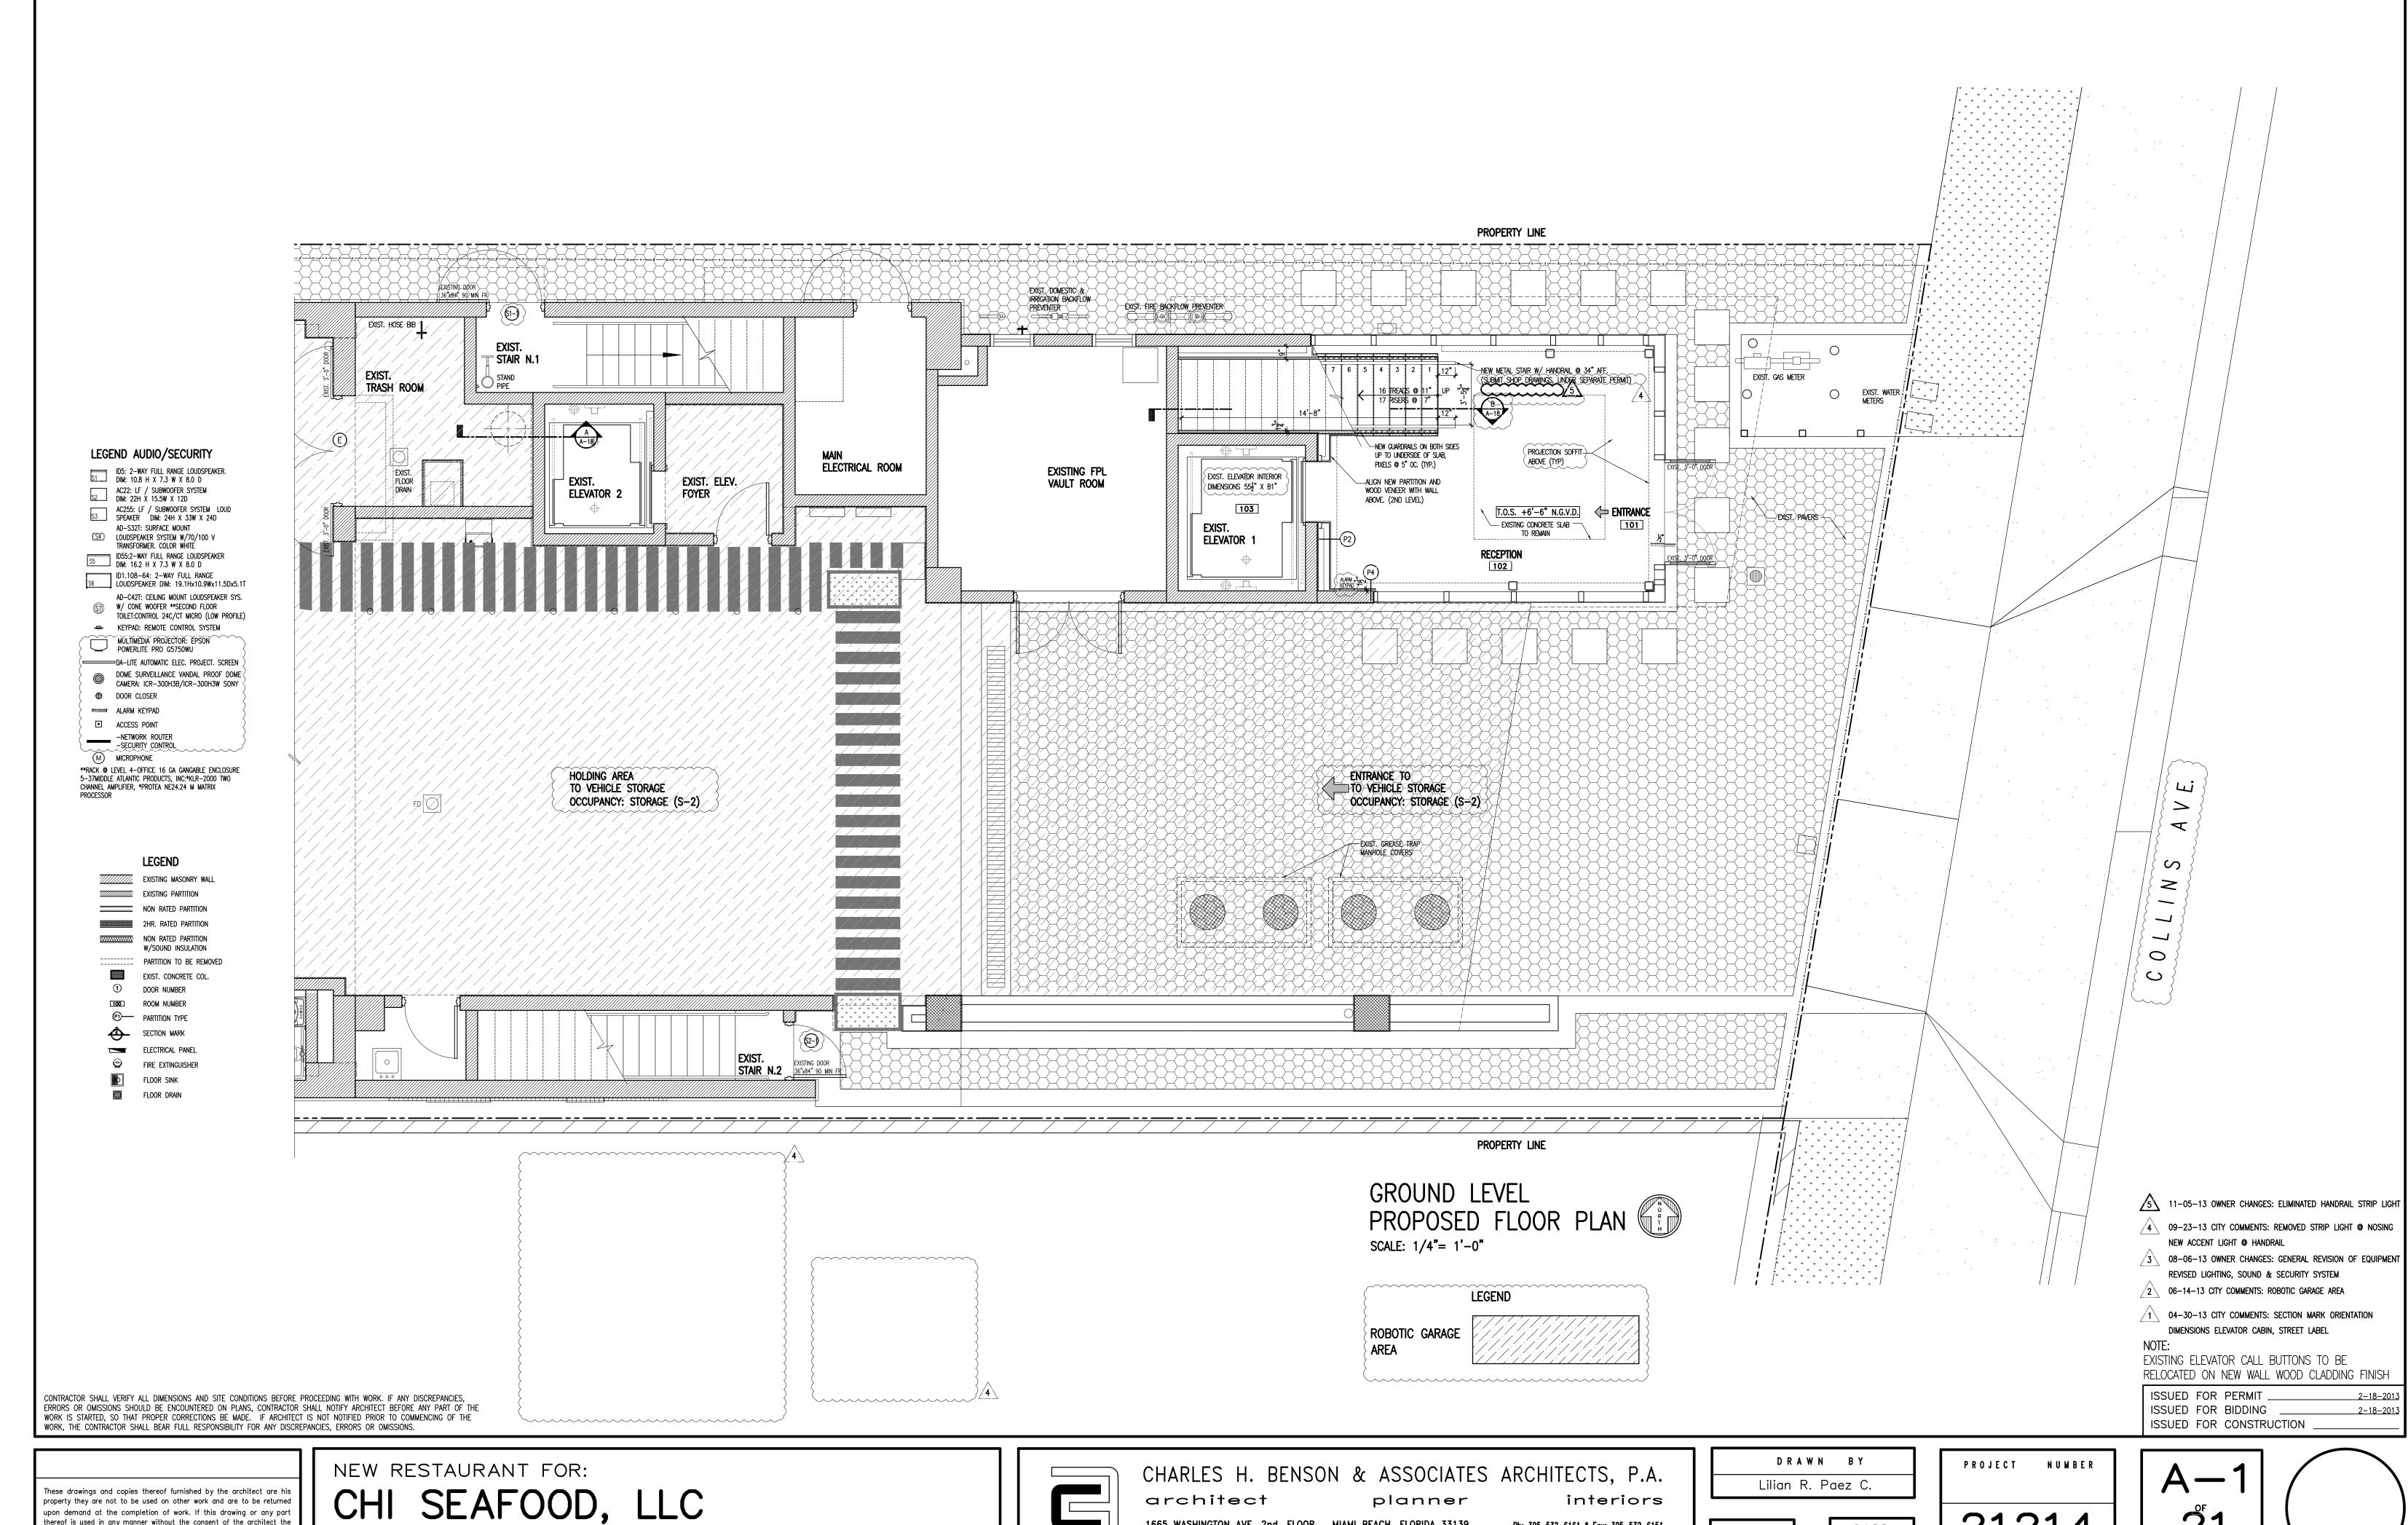
DATE 2-18-2013

21214

PROJECT





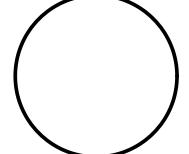

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1826 COLLINS AVE.

Miami Beach, Fl. 33139



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NCARB CERTIFICATE # 42,136


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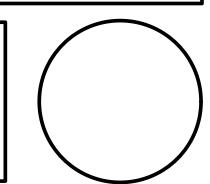
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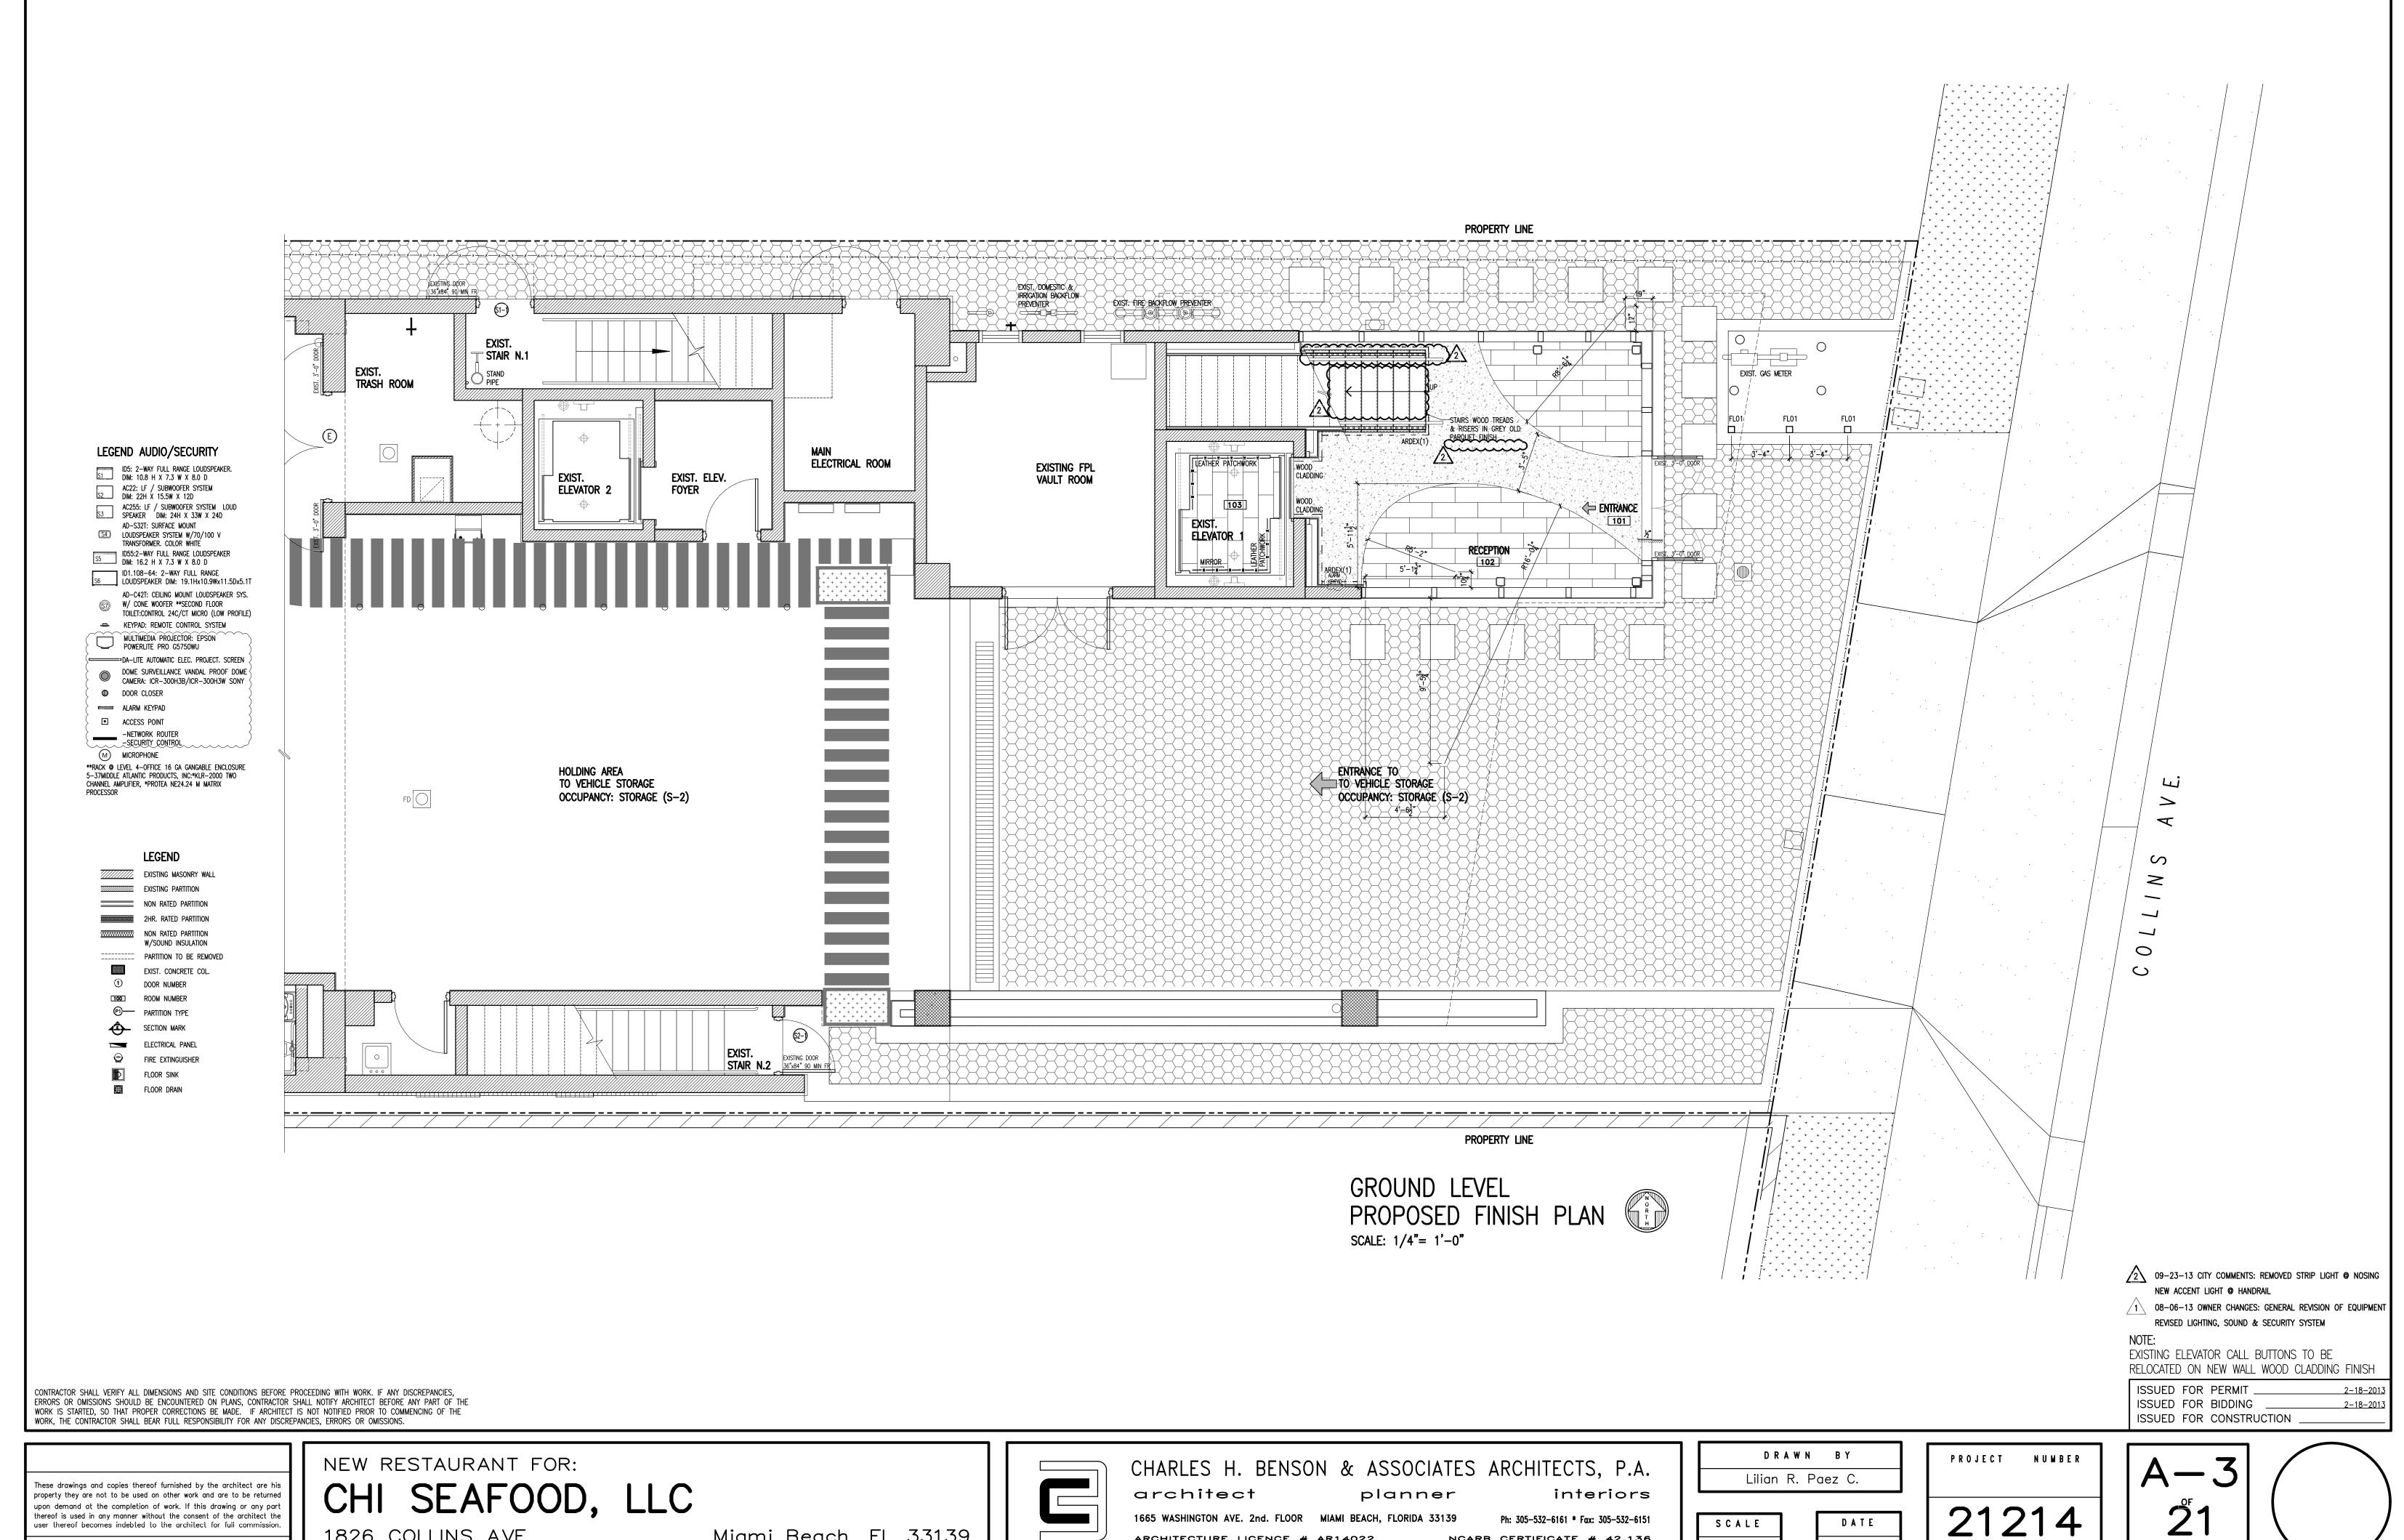


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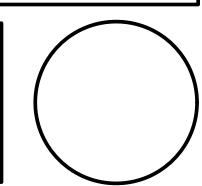
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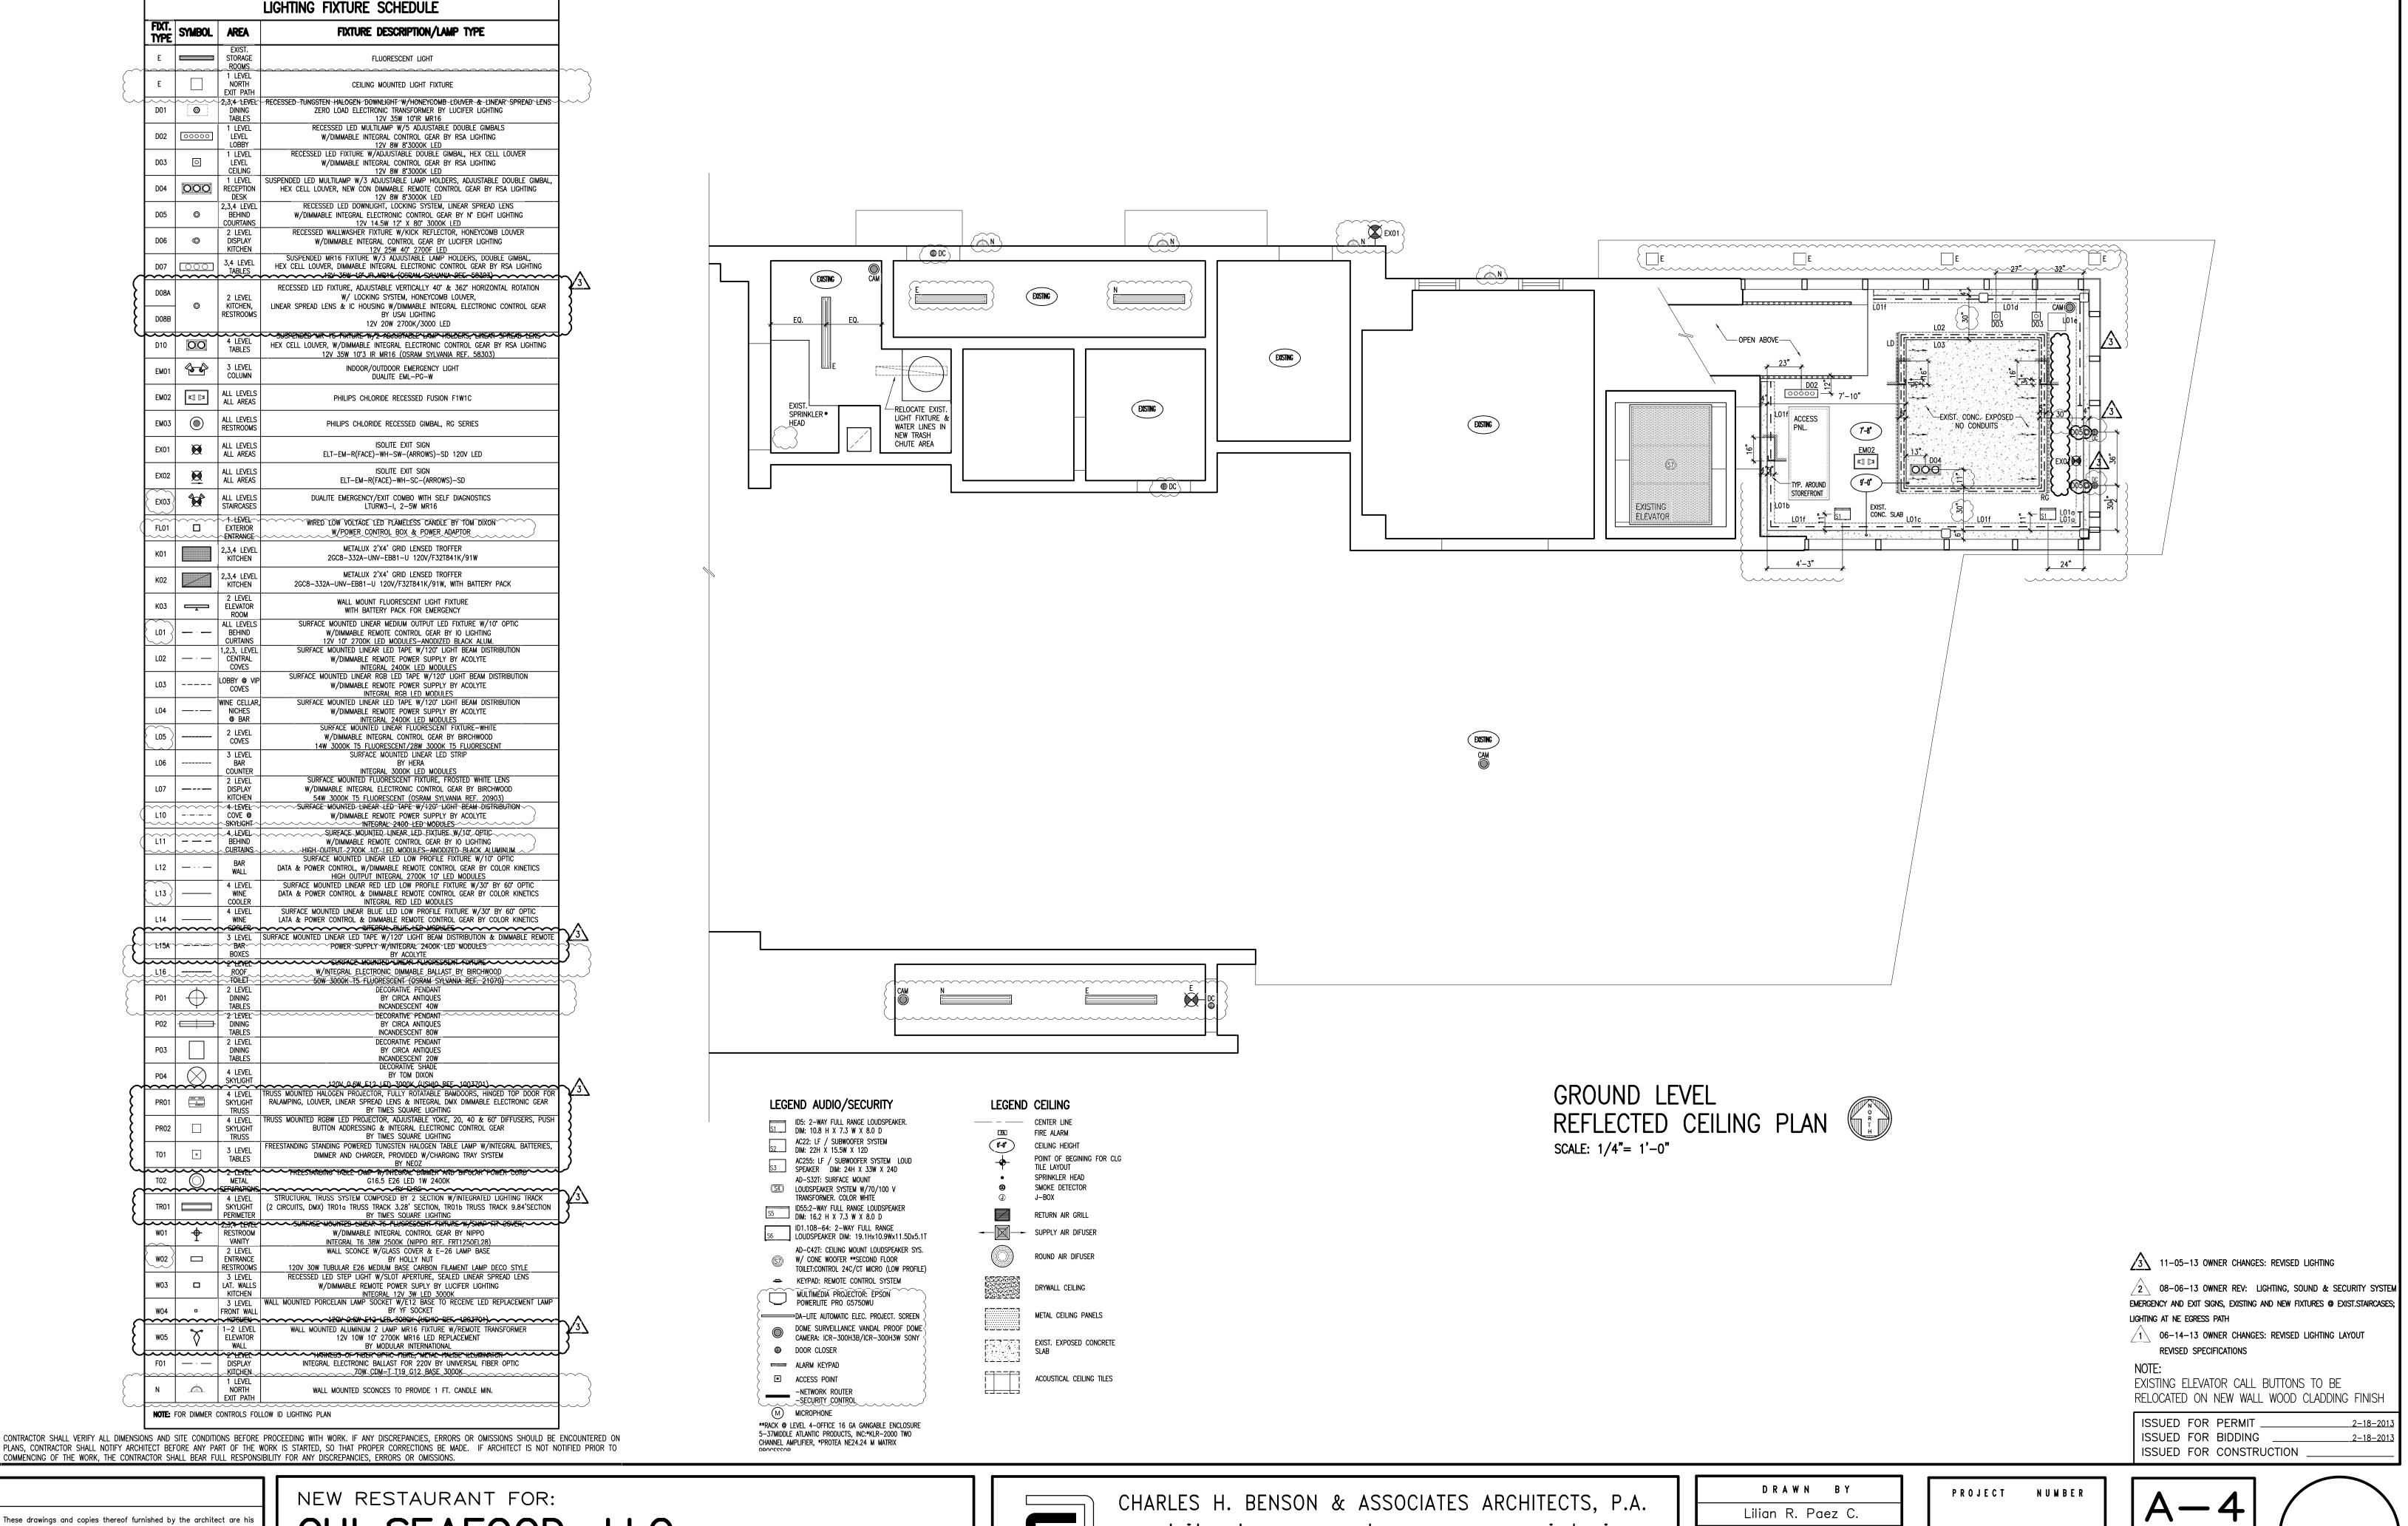


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CHI SEAFOOD, LLC

1826 COLLINS AVE. Miami Beach, Fl. 33139

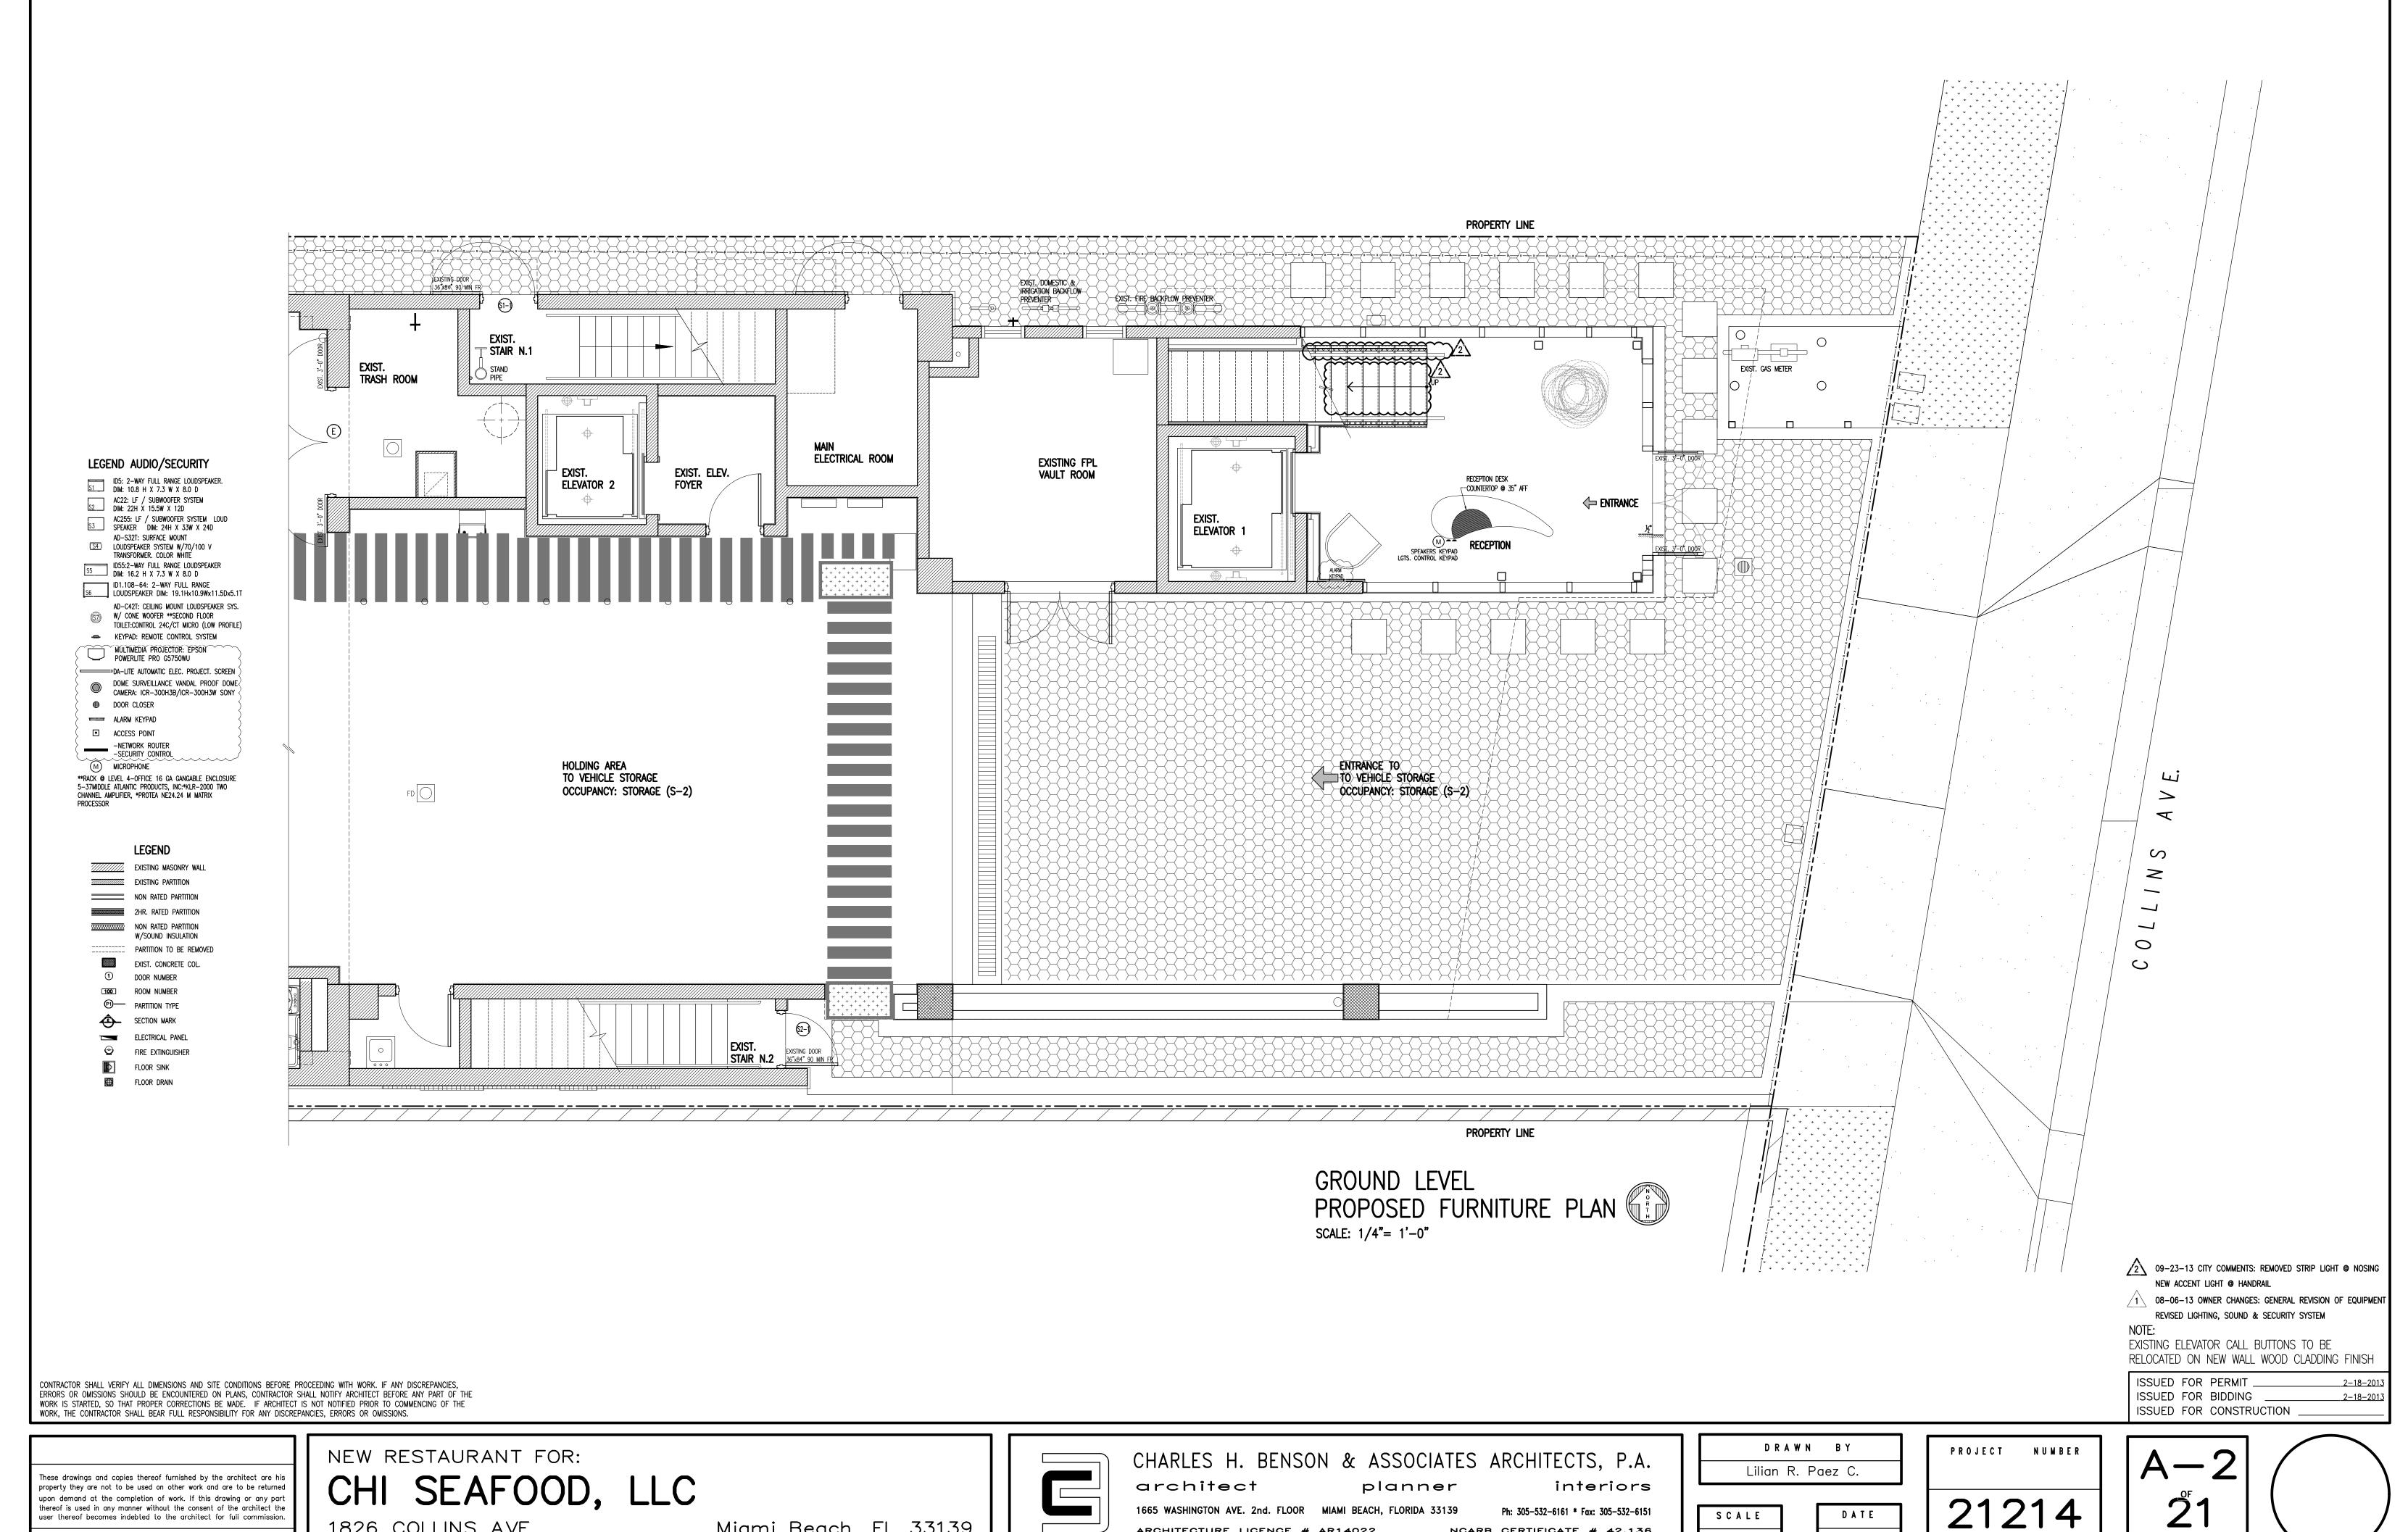

architect planner interiors


1665 WASHINGTON AVE. 2nd. FLOOR MIAMI BEACH, FLORIDA 33139 Ph: 305-532-6161 * Fax: 305-532-6151 ARCHITECTURE LICENCE # AR14022 NCARB CERTIFICATE # 42,136


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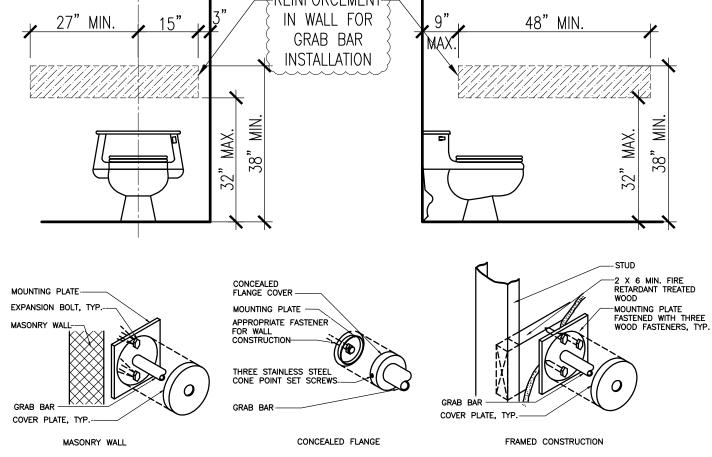
AS SHOWN

DATE

2-18-2013



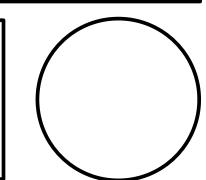

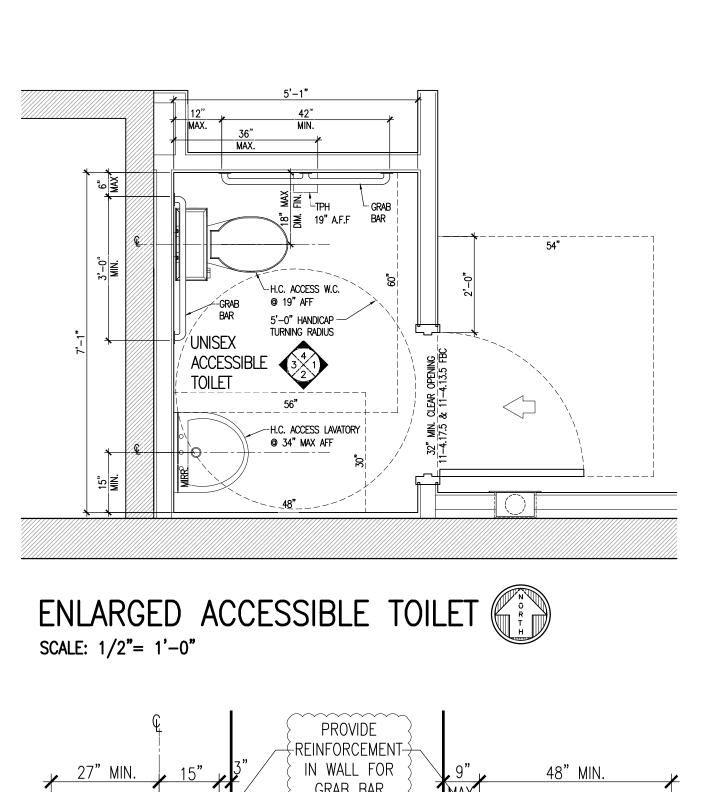

GRAB BAR DETS. & REINF. DIAGRAMS

LEGEND AUDIO/SECURITY

ID5: 2-WAY FULL RANGE LOUDSPEAKER.
DIM: 10.8 H X 7.3 W X 8.0 D

AC22: LF / SUBWOOFER SYSTEM DIM: 22H X 15.5W X 12D

S3 AC255: LF / SUBWOOFER SYSTEM LOUD SPEAKER DIM: 24H X 33W X 24D

AD-S32T: SURFACE MOUNT

LOUDSPEAKER SYSTEM W/70/100 V TRANSFORMER. COLOR WHITE

ID55:2-WAY FULL RANGE LOUDSPEAKER

S5 DIM: 16.2 H X 7.3 W X 8.0 D

ID1.108-64: 2-WAY FULL RANGE S6 LOUDSPEAKER DIM: 19.1Hx10.9Wx11.5Dx5.1T

AD-C42T: CEILING MOUNT LOUDSPEAKER SYS. (\$7) W/ CONE WOOFER **SECOND FLOOR TOILET:CONTROL 24C/CT MICRO (LOW PROFILE) KEYPAD: REMOTE CONTROL SYSTEM

MŮLTÍMĚDIÁ PŘOJECŤOŘ: ĚPŠÓN POWERLITE PRO G5750WU DA-LITE AUTOMATIC ELEC. PROJECT. SCREEN

DOME SURVEILLANCE VANDAL PROOF DOME CAMERA: ICR-300H3B/ICR-300H3W SONY DOOR CLOSER ALARM KEYPAD ACCESS POINT

M) MICROPHONE **RACK @ LEVEL 4-OFFICE 16 GA GANGABLE ENCLOSURE 5-37MIDDLE ATLANTIC PRODUCTS, INC:*KLR-2000 TWO CHANNEL AMPLIFIER, *PROTEA NE24.24 M MATRIX

CONTRACTOR SHALL VERIFY ALL DIMENSIONS AND SITE CONDITIONS BEFORE PROCEEDING WITH WORK. IF ANY DISCREPANCIES, ERRORS OR OMISSIONS SHOULD BE ENCOUNTERED ON PLANS, CONTRACTOR SHALL NOTIFY ARCHITECT BEFORE ANY PART OF THE

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WORK, THE CONTRACTOR SHALL BEAR FULL RESPONSIBILITY FOR ANY DISCREPANCIES, ERRORS OR OMISSIONS.

-NETWORK ROUTER -SECURITY CONTROL

LEGEND EXISTING MASONRY WALL EXISTING PARTITION NON RATED PARTITION 2HR. RATED PARTITION NON RATED PARTITION W/SOUND INSULATION PARTITION TO BE REMOVED EXIST. CONCRETE COL. DOOR NUMBER ROOM NUMBER PARTITION TYPE SECTION MARK


ELECTRICAL PANEL


FLOOR SINK


FLOOR DRAIN

FIRE EXTINGUISHER

— PORCELAIN STONEWARE TILES -(TYP.)

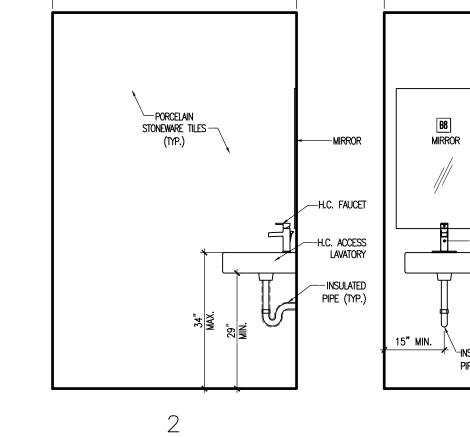

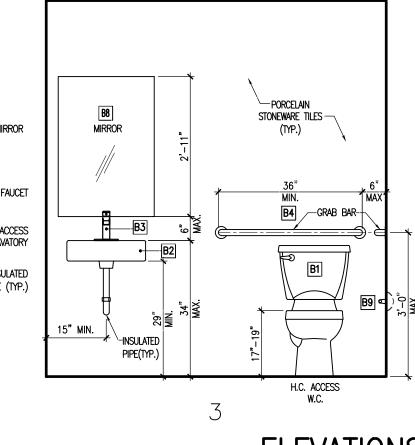

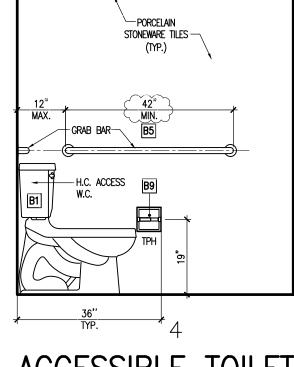

ELEVATIONS ACCESSIBLE TOILET SCALE: 1/2"= 1'-0"

<u>LEGEND</u>

- | B1 | ADA TOILET NEO METRO MODEL 8950-3 SATIN FINISH
- (B2 ADA LAVATORY NEO METRO MODEL 8935 SATIN FINISH
- B3 ADA WIDESPREAD FAUCET JADO 847/103 PIXIE HANDLE B4 36 ADA GRAB BARS BOBRICK B-5806 X 36 SATIN FINISH
- B5 42 ADA GRAB BARS BOBRICK B-5806 X 42 SATIN FINISH
- B6 ADA ELECTRONIC SENSOR NEO METRO MODEL FV1.0-W-SO B7 ADA WALL MOUNTED URINAL NEO METRO MODEL 8944-W


FIO RECESSED DIAPER CHANGING STATION BOBRIK KB110-SSRE

- B8 ADA MIRROR BOBRICK MODEL B-293
- B9 BOBRICK TOILET PAPER HOLDER. MODEL B-2888

TOILET ROOMS SHALL CONFORM TO ALL ACCESSIBILITY REQUIREMENTS OF THE "AMERICANS WITH DISABILITIES ACT (ADA)" INCLUDING, BUT NOT LIMITED TO, THE FOLLOWING

- A. WATER CLOSETS SEAT HEIGHT 19" A.F.F. B. CENTER LINE OF WATER CLOSET - 18" MAX FROM SIDE WALL
- C. TOILET PAPER DISPENSER 36" MAX. FROM REAR WALL D. KNEE CLEARANCE AT LAVATORY - 29" MIN. HEIGHT (APRON), 8" MIN. DEPTH E. LAVATORY DEPTH — 17" MIN.
- LAVATORY HOT WATER AND DRAIN PIPES INSULATED WHEREVER EXPOSED. G. LAVATORY RIM SURFACE - 34" MAX. A.F.F.
- H. INTERNATIONAL SYMBOL OF ACCESSIBILITY SHALL BE MOUNTED IN THE VICINITY OF MAIN
- J. URINALS RIM SHALL BE 17" MAX. AFF & 13-1/2" DEEP MIN. FROM OUTER FACE OF RIM TO BACK OF FIXTURE CONTROLS AND OPERATING MECHANISMS SHALL BE OPERABLE WITH ONE HAND AND SHALL NOT REQUIRE TIGHT GRASPING, PINCHING, OT TWISTING OF THE WRIST. THE FORCE REQUIRED TO ACTIVATE CONTROLS SHALL BE NO GREATER THAN 5 lbf 309 F.A.C.

SURROUNDING MATERIALS WALL WITHIN 2 FEET OF URINALS AND WATER CLOSETS SHALL HAVE A SMOOTH, HARD, NONABSORBENT SURFACE, TO A HEIGHT OF 4 FEET ABOVE THE FLOOR. 1210.2 F.B.C.

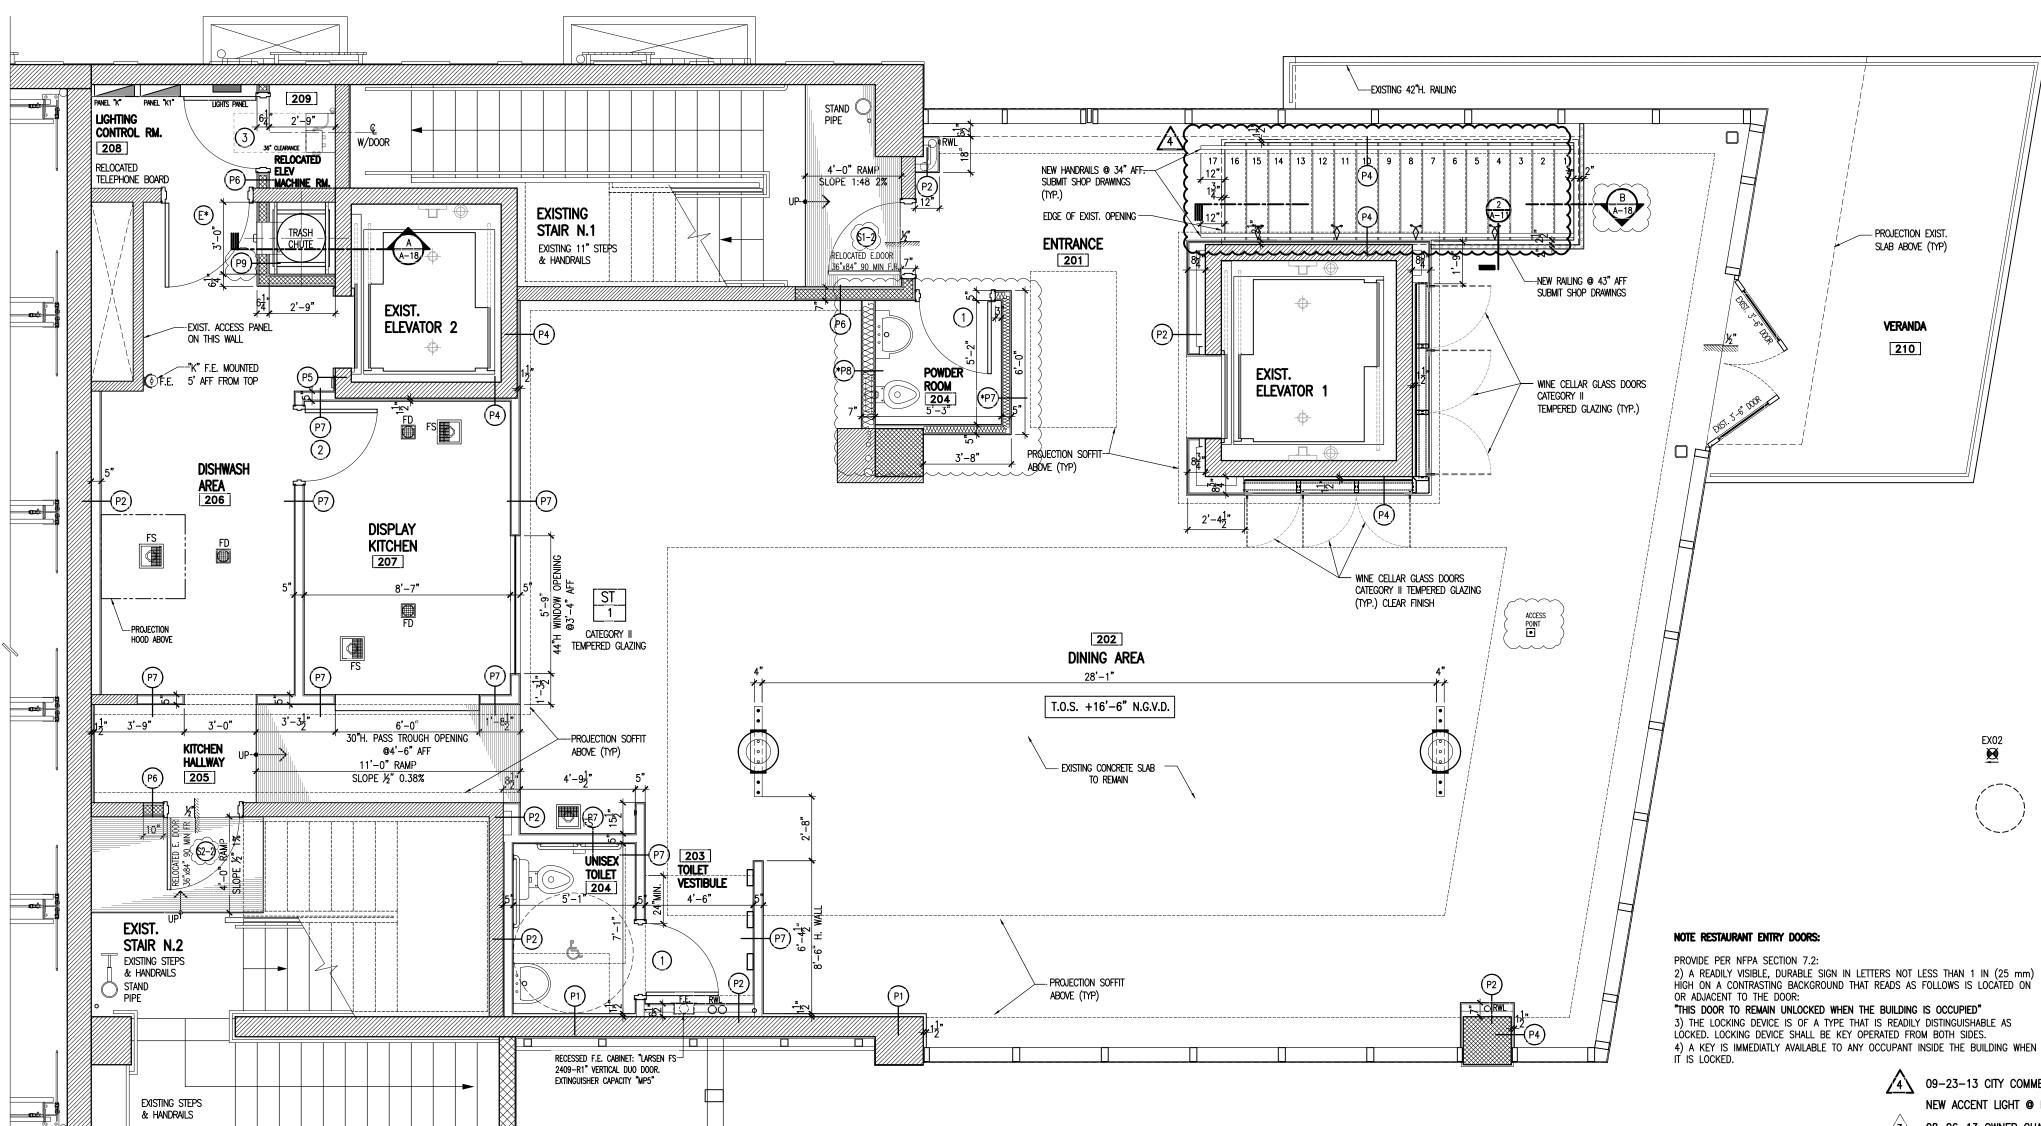

SECOND LEVEL PROPOSED FLOOR PLAN SCALE: 1/4"= 1'-0"



DATE

2-18-2013

4 09-23-13 CITY COMMENTS: REMOVED STRIP LIGHT @ NOSING NEW ACCENT LIGHT @ HANDRAIL

- 3\ 08-06-13 OWNER CHANGES: GENERAL REVISION OF EQUIPMENT REVISED LIGHTING, SOUND & SECURITY SYSTEM
- 2 06-14-13 CITY COMMENTS: TRASH CHUTE PARTITION TAG
- NEW POWDER ROOM, PLUMBING FIXTURES SPECS.
- 1 04-30-13 CITY COMMENTS: SECTION MARK ORIENTATION

SIDE GRAB BARS DIMENSIONS

EXISTING ELEVATOR CALL BUTTONS TO BE RELOCATED ON NEW WALL WOOD CLADDING FINISH

ISSUED FOR PERMIT 2-18-2013 ISSUED FOR BIDDING ____ <u>2-18-2013</u> ISSUED FOR CONSTRUCTION

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1665 WASHINGTON AVE. 2nd. FLOOR MIAMI BEACH, FLORIDA 33139 ARCHITECTURE LICENCE # AR14022


Ph: 305-532-6161 * Fax: 305-532-6151 NCARB CERTIFICATE # 42,136


DRAWN BY Lilian R. Paez C.

SCALE

AS SHOWN

PROJECT NUMBER

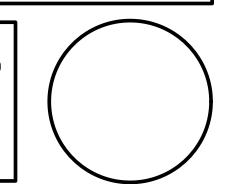

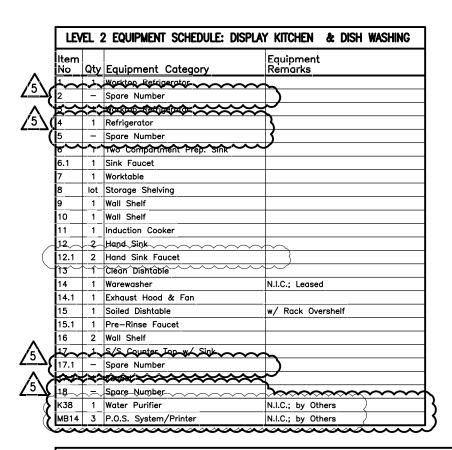

FIRE EXTINGUISHER

PROVIDE ONE "A.B.C." TYPE "2A" RATED FIRE EXTINGUISHER FOR EACH 2,500 SQ. FT. TOP OF EXTINGUISHER SHALL BE MOUNTED NOT TO EXCEED 5'-0" ABOVE FINISHED FLOOR. PROVIDE ONE "K" TYPE RATED FIRE EXTINGUISHER IN THE KITCHEN. TOP OF EXTINGUISHER SHALL BE MOUNTED NOT TO EXCEED 5'-0" ABOVE FINISHED FLOOR.

KITCHEN GENERAL CONST. NOTES

ALL DIMENSIONS SHOWN ARE TO BE MEASURED FROM FINISHED SURFACES AND FROM CENTERS OF COLUMN LINES. ALL WRITTEN DIMENSIONS SUPERSEDE SCALE.

THE FOOD SERVICE EQUIPMENT WILL BE PROVIDED WITH ONLY THE DEVICES SUPPLIED AS STANDARD BY THE MANUFACTURER OR SPECIFICALLY SPECIFIED BY THE CONSULTANT. THE GENERAL CONTRACTOR SHALL PROVIDE AND INSTALL ALL OTHER NECESSARY FRAMING, SUPPORTS, BACKINGS, HARDWARE, FINISHES AND ANY OTHER BUILDING STRUCTURES AND MATERIALS REQUIRED FOR A PROPER INSTALLATION.

THE GENERAL CONTRACTOR SHALL VERIFY ALL REQUIREMENTS FOR ITEMS LISTED AS: EXISTING, BY OWNER, BY VENDOR, N.I.C. OR BY OTHERS.

THE GENERAL CONTRACTOR SHALL COORDINATE ALL FIELD DIMENSIONS AND BUILDING REQUIREMENTS WITH THE FOOD SERVICE EQUIPMENT CONTRACTOR (F.S.E.C.). THE GENERAL CONTRACTOR SHALL VERIFY AND COORDINATE ALL BUILDING ACCESS REQUIREMENTS WITH THE FOOD

SERVICE EQUIPMENT CONTRACTOR (F.S.E.C.). THE FOOD SERVICE EQUIPMENT CONTRACTOR SHALL VERIFY ALL DATA CONTAINED HEREIN AND PERIODICALLY INSPECT ALL CONDITIONS AT THE SITE TO INSURE A COMPLETE AND PROPER INSTALLATION.

THE GENERAL CONTRACTOR SHALL PROVIDE EMPTY CONDUITS WITH PULL STRINGS FOR ALL POINT OF SALE (P.O.S.), AUDIO & VIDEO LOCATIONS HOME RUN TO OFFICE.

WALK-IN COOLER

MINIMUM REQUIREMENTS: FOAM PLASTIC HAVING A MAXIMUM FLAME SPREAD OF 75 MAY BE USED IN A THICKNESS UP TO 4" IN FREE STANDING WALK-IN COOLER OR FREEZER UNITS LESS THAN 400 SQ. FT. IN FLOOR AREA WITHOUT A THERMAL BARRIER AND WITHOUT AN AUTOMATIC FIRE SUPPRESSION SYSTEM WHEN THE FOAM PLASTIC IS COVERED BY A METAL FACING NOT LESS THAN 0.032 INCH-THICK ALUM. OR CORROSION RESISTANT STEEL HAVING A MIN. BASE METAL THICKNESS OF 0.016 INCH. WHEN PROTECTED BY A THERMAL BARRIER, THE FOAM PLASTIC MAY BE USED IN A THICKNESS UP TO 10".

REFER TO KITCHEN EQUIPMENT LAYOUT FOR EXACT LOCATION ON FLOOR DRAINS, SINK & SPECIAL ELECT. OUTLETS, TELEPHONE, ETC. COORDINATION W/ELECTRICAL, MECHANICAL & PLUMBING PLANS IS REQUIRED.

SEATING LAYOUT

PROVIDE A 81/2" x 11" SEATING LAYOUT PLAN TO THE FIELD FIRE INSPECTOR AT TIME OF FINAL. A LEGIBLE COPY WILL BE PERMANENTLY POSTED NEAR THE MAXIMUM CAPACITY SIGN

DRINKING FOUNTAIN

WATER WILL BE SERVED 410.1 F.B.C.WHERE WATER IS SERVED IN RESTAURANTS OR WHERE BOTTLED WATER COOLERS ARE PROVIDED IN OTHER OCCUPANCIES, DRINKING FOUNTAINS SHALL NOT BE REQUIRED"

			ABREVIATION	IS	
			JAN	=	JANITOR
A.P.	=	ACCESS PANEL	K.U.S	=	KETTLE UNIT STEAMER
BR.C	C =	BREAD CART	L	=	LOCKERS
B.C	=	BROOM CLOSET	MIN.	=	MINUMUM
C.R	=	CASH REGISTER	N.G.V.D.	=	NATIONAL GEODETIC VERTICAL DATUM
CH.S	S =	CHILD SEATS	0.SH	=	OVER SHELF
С	=	COFFEE	PNL	=	PANEL
C.C.	=	CORN COOKER	Р	=	PLANTER
CO	=	COUNTER	P.B	=	PORTABLE BINS
C.I.M	1. =	CUBE ICE MAKER	P.C	=	PRESSURE CLEANER
C.D	=	CUP DISPENSER	P.D.	=	PASTRY DISPLAY
D.C	=	DESSERT CABINET	P.D.R.	=	PRIVATE DINING ROOM
D.R.	=	DUNNAGE RACKS	P.O.B.	=	POINT OF BEGINNING
DR	=	DRAWER	R	=	RANGE
D	=	DUMP	REF	=	REFRIGERATOR
E.P	=	ELECTRICAL PANELS	S.S	=	SERVICE SINK
F.C	=	FILE CABINET	SH	=	SHELVING
F.E	=	FIRE EXTINGUISHER	3-C.S	=	THREE COMPARTMENT SINK
F.D	=	FLOOR DRAIN	T.K	=	TILTING KETTLE
F.S	=	FLOOR SINK	TI.C	=	TIME CARDS
FR	=	FREEZER	T.C	=	TRASH CAN
F	=	FRYER	T.CL.	=	TIME CLOCK
Ğ.D	=	GARBAGE DISPOSAL	TYP	=	TYPICAL
G.B	=	GRAB BAR	T & TC	=	TRAYS & TRASH CABINET
H	=	HANDICAP	SF	=	STOREFRONT
H.S	=	HAND SINK	2-C.S	=	TWO COMPARTMENT SINK
I.B	=	ICE BIND	U.REF	=	STREET REPORTER
I.T	=	ICE TEA	W.T	=	WORK TABLE

LEGEND AUDIO/SECURITY

ID5: 2-WAY FULL RANGE LOUDSPEAKER.
DIM: 10.8 H X 7.3 W X 8.0 D

AC22: LF / SUBWOOFER SYSTEM DIM: 22H X 15.5W X 12D AC255: LF / SUBWOOFER SYSTEM LOUD SPEAKER DIM: 24H X 33W X 24D

AD-S32T: SURFACE MOUNT S4 LOUDSPEAKER SYSTEM W/70/100 V TRANSFORMER. COLOR WHITE

ID55:2-WAY FULL RANGE LOUDSPEAKER DIM: 16.2 H X 7.3 W X 8.0 D ID1.108-64: 2-WAY FULL RANGE

S6 LOUDSPEAKER DIM: 19.1Hx10.9Wx11.5Dx5.1T AD-C42T: CEILING MOUNT LOUDSPEAKER SYS. (\$7) W/ CONE WOOFER **SECOND FLOOR TOILET:CONTROL 24C/CT MICRO (LOW PROFILE) KEYPAD: REMOTE CONTROL SYSTEM

MULTIMEDIA PROJECTION: Erso POWERLITE PRO G5750WU MÚLTIMEĎIA PŘOJĚCŤOR: EPSÓN DA-LITE AUTOMATIC ELEC. PROJECT. SCREEN DOME SURVEILLANCE VANDAL PROOF DOME CAMERA: ICR-300H3B/ICR-300H3W SONY

DOOR CLOSER ALARM KEYPAD

ACCESS POINT -NETWORK ROUTER -SECURITY CONTROL MICROPHONE

**RACK @ LEVEL 4-OFFICE 16 GA GANGABLE ENCLOSURE 5-37MIDDLE ATLANTIC PRODUCTS, INC:*KLR-2000 TWO

LEGEND

EXISTING MASONRY WALL EXISTING PARTITION NON RATED PARTITION 2HR. RATED PARTITION


MON RATED PARTITION W/SOUND INSULATION PARTITION TO BE REMOVED EXIST. CONCRETE COL.

ROOM NUMBER PARTITION TYPE SECTION MARK

DOOR NUMBER

ELECTRICAL PANEL FIRE EXTINGUISHER FLOOR SINK

FLOOR DRAIN

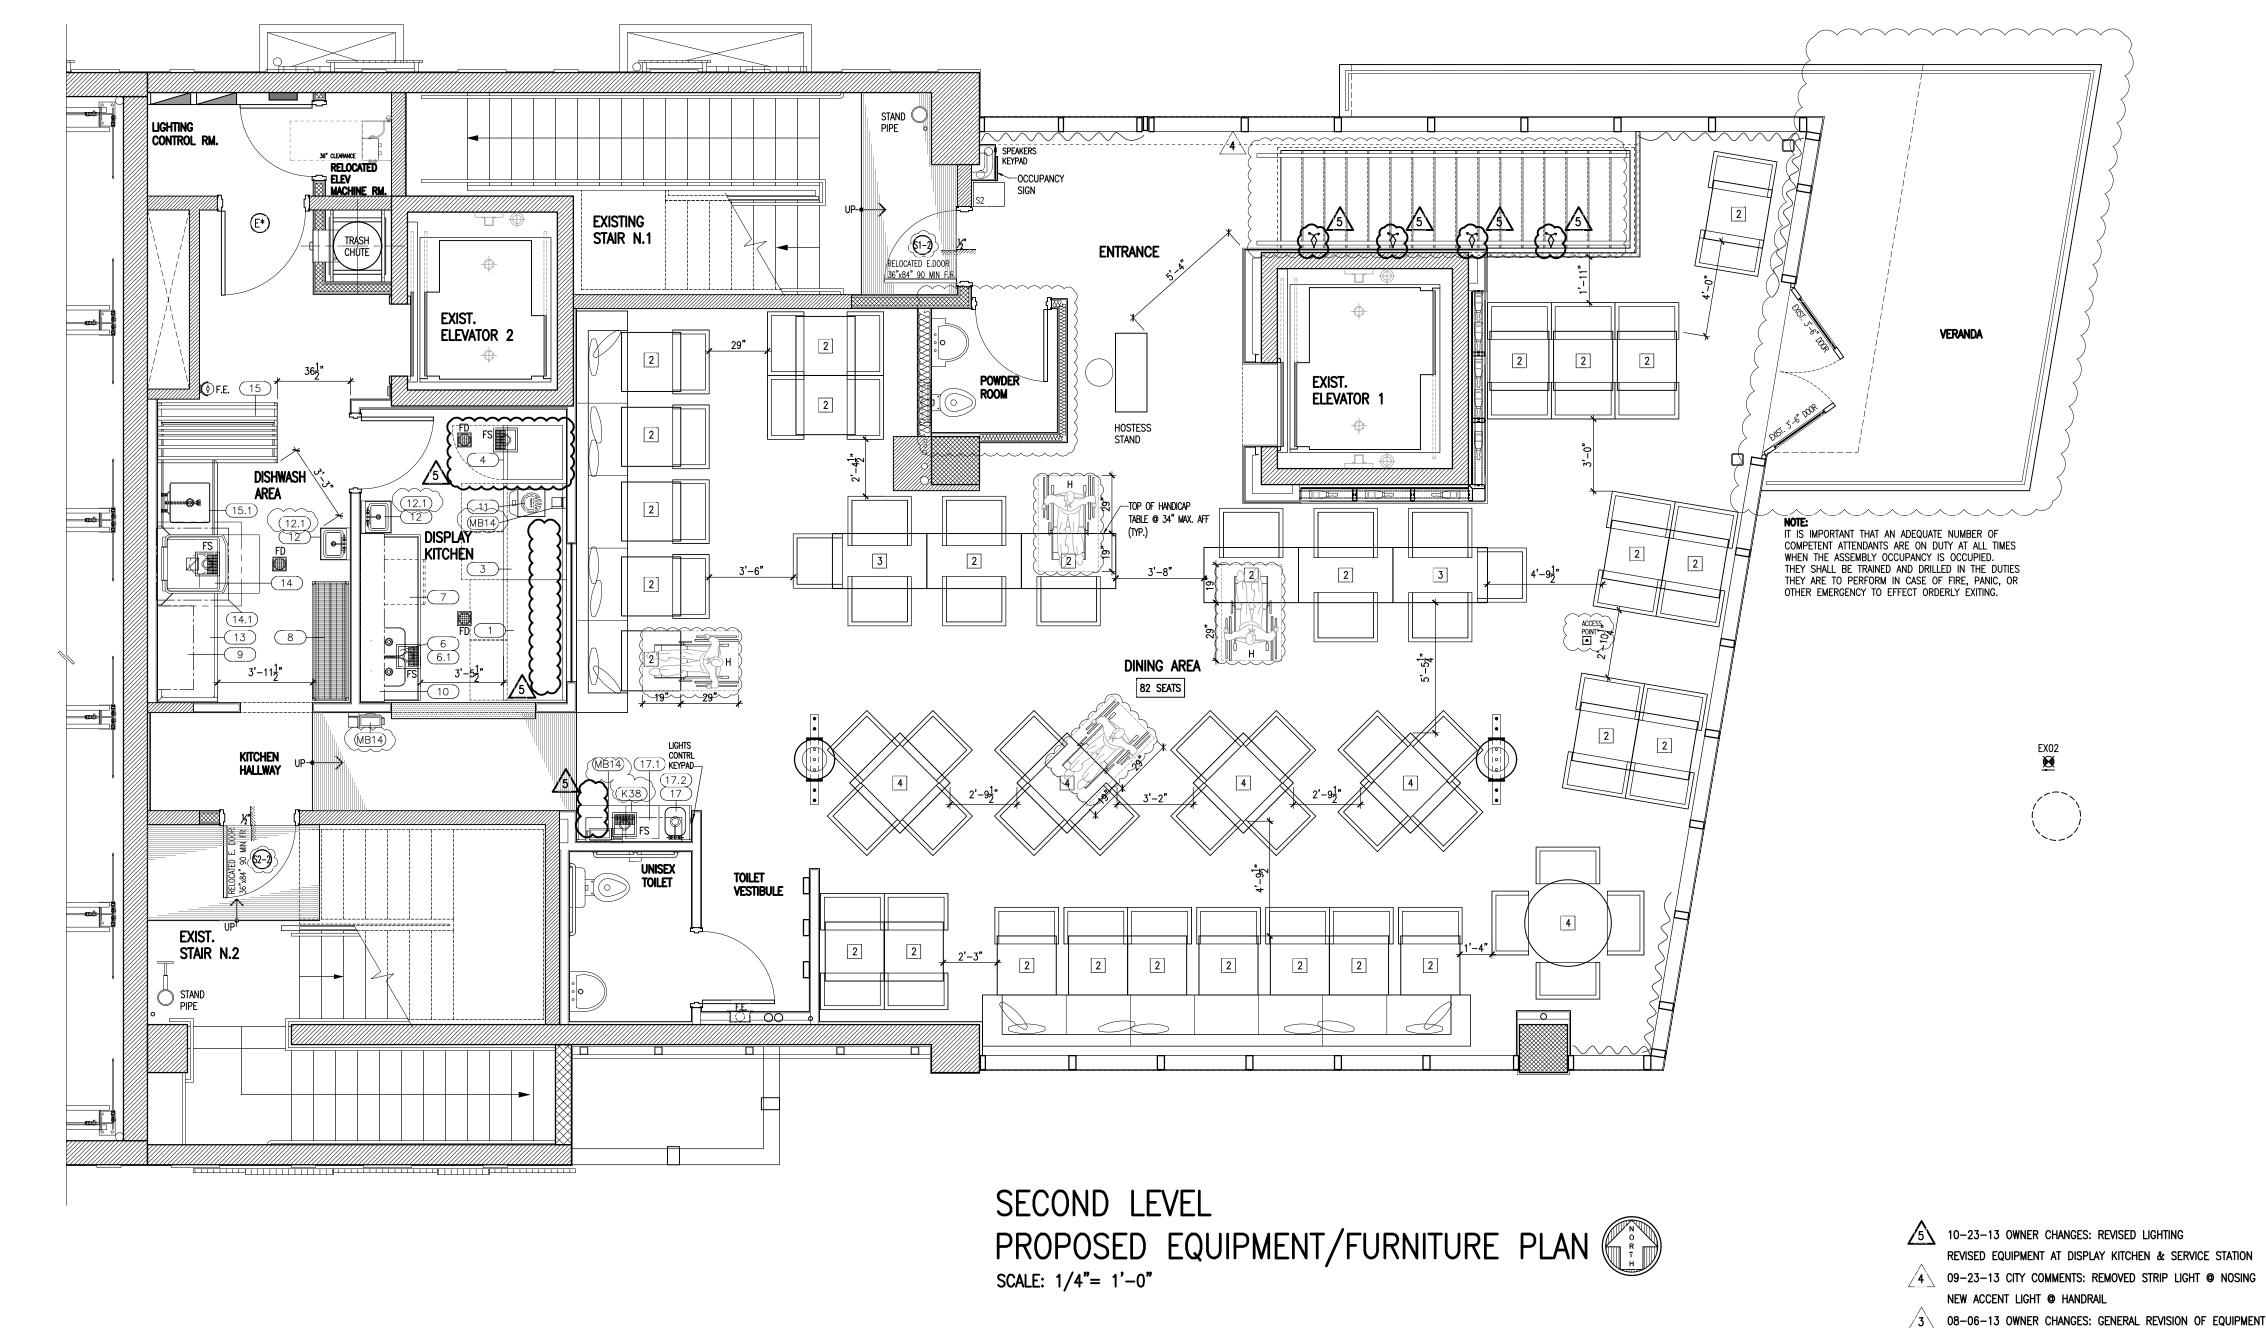

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DRAWN BY Lilian R. Paez C.

DATE

2-18-2013

SCALE

AS SHOWN

PROJECT NUMBER 21214

71

HANDICAP SEATING

EQ. SCHEDULE UPDATED

ISSUED FOR PERMIT


ISSUED FOR BIDDING ___

REVISED LIGHTING, SOUND & SECURITY SYSTEM 2 06-14-13 CITY COMMENTS: NEW POWDER ROOM

1 04-30-13 CITY COMMENTS: SEATING @ VERANDA REMOVED

RELOCATED ON NEW WALL WOOD CLADDING FINISH

EXISTING ELEVATOR CALL BUTTONS TO BE

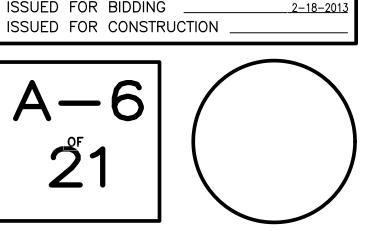

2-18-2013

NEW RESTAURANT FOR:

FLOOR		BASE			WALL			CEILING						
	No.	AREA	MATERIAL		С	MATERIAL		С	MATERIAL		С	MATERIAL		HGT
	101	ENTRANCE	CONCRETE	F-2	2			3			4	S.S. DRYWALL	C-1 P-1	VARIES
EL #1	102	RECEPTION	CONCRETE	F-1	2			3		W-3 W-4	4	S.S. DRYWALL	C-1 P-1	VARIES
LEVEL	103	ELEVATOR CABIN	METAL	F-1	2			3		W-8 M-3	4		C-5	
	201	ENTRANCE	CONCRETE	F-2	2			3	M.R. DRYWALL	W-3	4	S.S. DRYWALL	C-1 P-1	VARIES
	202	DINING AREA	CONCRETE	F-1	2			3	M.R. DRYWALL	W-4	4	S.S. DRYWALL	C-1 P-1	VARIES
	203	TOILET VESTIBULE	CONCRETE	F-1	2			3	S.S. DRYWALL	W-8 P-2	4	S.S. DRYWALL	C-1 P-1	VARIES
	204	TOILET POWDER ROOM	CONCRETE	F-3	2			3	M.R. DRYWALL	W-11	4	S.S. DRYWALL	C-2 P-2	7'-10
#2	205	KITCHEN HALLWAY	CONCRETE	F-2	2			3	M.R. DRYWALL	W-3 W-4	4	S.S. DRYWALL	C-1 P-1	VARIES
LEVEL	206	DISHWASH AREA	CONCRETE	F-5	2	QUARRY TILE	B-1	3	FRP ON M.R. DWL	W-10	4	ACOUSTICAL TILES	C-3	9'-0"
_	207	DISPLAY KITCHEN	CONCRETE	F-5	2	QUARRY TILE	B-1	3	FRP ON M.R. DWL	W-10	4	S.S. DRYWALL	C-2	9'-0"
	208	LIGHTING CONTROL RM	CONCRETE	F-5	2	QUARRY TILE	B-1	3	FRP ON M.R. DWL	W-10	4		C-1	
	209	ELEVATOR MACH. ROOM	CONCRETE	F-5	2	QUARRY TILE	B-1	3	FRP ON M.R. DWL	W-10	4		C-1	
	210	VERANDA	CONCRETE	F-6	2			3			4			
	301	BANQUETTE AREA		F-1	2			3			4	S.S. DRYWALL	C-1 P-1	VARIES
	302	DINING AREA	CONCRETE	F-1	2			3	M.R. DRYWALL	W-3 W-4	4	S.S. DRYWALL	C-1 P-1	VARIES
{	303	EXIT CORRIDOR	CONCRETE	F-2	2			3	M.R. DRYWALL	W-4 W-3 W-4	4	S.S. DRYWALL	C-1 P-1	VARIES
}	304	TOILET VESTIBULE	CONCRETE	F-2	2			3	M.R. DRYWALL	W-4 W-3 W-4	4	S.S. DRYWALL	C-1 P-1	VARIES
#3	305	MEN'S TOILET	CONCRETE	F-3	2			3	M.R. DRYWALL	W-6	4	S.S. DRYWALL	C-2/	7'–10
LEVEL	306	WOMEN'S TOILET	CONCRETE	F-3	2			3	M.R. DRYWALL	W-6	4	S.S. DRYWALL	P-2 C-2	7'-10
_	307	BAR	CONCRETE	F-5	2	QUARRY TILE	B-1	3	FRP ON M.R. DWL	W-10	4		/P-2	
	308		CONCRETE	F-5	2	QUARRY TILE	B-1	3	FRP ON M.R. DWL	W-10	4	ACOUSTICAL TILES	C-3	9'-0"
	309(EQUIPMENT ROOM	CONCRETE	F-5	2	QUARRY TILE	B-1	3	FRP ON M.R. DWL	W-10	4		C-1	
	310	D.J. 5	CONCRETE	F-1	2									
	401	LOUNGE AREA	CONCRETE	F-1	2			3	M.R. DRYWALL	W-3	4	S.S. DRYWALL	C-1	VARIES
	402	V.I.P	CONCRETE	F-4	2			3		W-4	4		∕P-1	VARIES
	404	TOILET POWDER ROOM	CONCRETE	F-3	2			3	M.R. DRYWALL	W-6	4	S.S. DRYWALL	C-2/	7'-10
#4	405	WALK-IN COOLER	CONCRETE	F-5	2	QUARRY TILE	B-1	3		"	4		∕P-2	, 10
LEVEL	406		CONCRETE	F-5	2	QUARRY TILE	B-1	3			4			
ت		WINE COOLER	CONCRETE	F-5	2	QUARRY TILE	B-1	3	FRP ON M.R. DWL	W-10	4	ACOUSTICAL TILES	C-3	8'-0"
	407 408	DRY STORAGE	CONCRETE	F-5	2	QUARRY TILE	B-1 B-1	3	FRP ON M.R. DWL	W-10	4	ACCUSTICAL TILES	C-3	J -0
	400	STORAGE	CONGRETE	Γ-0		QUARRI IILE		-	TINE ON MIR. DWL	W-10	+		U-1	

FINISH SCHEDULE NOTES

A.- CONTRACTORS SHALL VERIFY ALL DIMENSIONS AND SITE CONDITIONS BEFORE PROCEEDING WITH WORK. IF ANY DISCREPANCIES, ERRORS OR OMISSIONS SHOULD BE ENCOUNTERED ON PLANS, CONTRACTOR SHALL NOTIFY ARCHITECT BEFORE ANY PART OF THE WORK IS STARTED, SO THAT PROPER CORRECTIONS CAN BE MADE. IF ARCHITECT IS NOT NOTIFIED PRIOR TO COMMENCING OF THE WORK, THE CONTRACTOR SHALL BEAR FULL RESPONSABILITY FOR ANY DISCREPANCIES, ERRORS OR OMISSIONS. **B.-** ALL EXTERIOR CONCRETE BLOCK WALLS SHALL BE: R-4.2 MINIMUM FOIL-BACKED INSULATION. DRYWALL R-19 FOR CEILINGS, R-5 FOR EXTERIOR WALLS, R-3 BOTH SIDES FOR BCS COMMON WALLS, R-11 FOR FRAMED COMMON WALLS. CONTRACTOR SHALL NOT APPLY DRYWALL UNTIL INSULATION IS INSTALLED AND INSPECTED.

(C.— INTERIOR FLAME SPREAD ON BUILDING USING OPTION 4 AT WALLS AND CEILINGS,

(AA) VERTICAL EXITS – CLASS "A" OR "B" (BB) EXIT ACCESS - CLASS "A", "B" OR "C"

L- STAIRS ARE FINISHED W.NON-SLIP SURFACE

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(CC) LOBBIES, CORRIDORS THAT ARE NOT EXIT ACCESS - CLASS "A" OR "B" ALL NEW WOOD TO BE INHERENTLY FIRE RETARDANT. D.- PAINT ALL INTERIOR AND EXTERIOR SURFACES EXPOSED TO VIEW

E.- ALL INTERIOR FINISHES SHALL COMPLY WITH THE FFPC 2010 CHAP 10 & TABLE A.10.2.2 FOR NEW ASSEMBLY. ALL FLOOR FINISHES TO BE SLIP RESISTANT: 0.6 COEFFICIENT OF FRICTION FOR ACCESSIBLE ROUTE. 0.8 FOR RAMPS.

F.- ALL GROUT TO BE EPOXY GREASE RESISTANT & SEALED G.- PROVIDE FLOOR TO CEILING PLASTIC (SCREWED IN TYPE) CORNER GUARDS AT KITCHEN OUTSIDE CORNERS

(H.- INSTALL CLEAR SILICONE CAULK AT ALL JOINTS AS DIRECTED BY HEALTH J.- CERAMIC TILE TO BE INSTALLED ON A THICK BED OF EPOXY MORTAR, NOMINALLY 1" ON FLOORS, FACILITATS ACCURATE SLOPES TO DRAINS OR A LEVEL SURFACE.

K.- Interior floor to have surfaces which are even and sustantially even

M.- CONTRACTOR TO VERIFY IN FILED DIMENSIONS OF ALL OPENINGS & ACCOMODATE FINISH WHERE REQUIRED. P.- G.C. TO VERIFY ALL DOORS JAMB CLEAR WIDTH INCLUDING CASING REQS. BEFORE INSTALLATION OF ANY STUDS

FINISH SCHEDULE CODE KEY

FLOORING: F-1 SUPPLY & INSTALLATION OF WOOD FLOOR IN GREY OLD PARQUET FINISH F-2 FLOOR WORK IN CONCRETE EFFECT FINISH. F-3 MUTINA DECHIRER 24"X24" TILE, NERO NEUTRAL COLOR FINISH F-4 CARPET STEPEVI TERRA

F-5 6" X 6" QUARRY TILE OQ84-RED PAVER SMOOTH SKU#OQ84661PBP. TEC 929 CHARCOAL GRAY GROUT. MANUF: DALE TILE

2 BASE: B-1 6" X 6" PAVER COVE BASE P-3665 RED

TEC 929 CHARCOAL GRAY GROUT. MANUF: DALE TILE **3 WALLS:** W-1 SMOOTH STUCCO W-2 HORIZONTAL STRIP OLD WOOD FINISH

— W-3 CONC. FINISH W/ARDEX PANDOMO W1, PATTERN ———— W-4 CONC. FINISH W/ARDEX PANDOMO W1, STAGGERED HORIZONTAL STRIP PATTERN — W-5 CONC. FINISH W/ARDEX PANDOMO W1, UPHOLSTERED PATTERN ----- W-6 MUTINA DECHIRER 24"X24" TILE, DECOR NERO COLOR W-7 METALLIC FINISH

——×—— W–8 PATCHWORK VINTAGE LEATHER FINISH W-9 STAINLESS STEEL SHEETS ----- W-10 FRP

W-11 MUTINA DECHIRER 24"X24" TILE, DECOR WHITE COLOR M−1 ½" MIRROR M−2 MIRROR IN GREY FINISH M-3 MIRROR IN BRONZE FINISH

P-1 WHITE LACQUER PAINT 4 CEILING: C-1 EXISTING EXPOSED CONCRETE C-2 SMOOTH DRYWALL


C-3 SUSPENDED CEILING SYSTEM, WHITE, STYLE: HEALTH ZONE ULTMA #1936 MANUF: ARMSTRONG COLOR: WHITE C-4 24"X24" PANZ ALUMINUML CEILING PANELS USG.COM PHONE (800) 950-3839

C-5 GRILLE CEILING, RUSTED EFFECT METAL FINISH P-1 LIGHT GREY COLOR OVER DRYWALL P-2 WHITE LACQUER P-3 OLD EFFECT METAL PAINT

- EXTERIOR ELEVATOR WALLS AT ALL LEVELS: W-2 HORIZONTAL STRIP OLD WOOD FINISH. LED SCREEN STRIPS @ DIFFERENT HEIGHTS, SEE I.D DRAWINGS ELEVATOR DOORS: METAL PLY & RIBETS IN RUSTED FINISH

- WINE CELLAR ON SECOND LEVEL: M-2 MIRROR ON WALL BEHIND RACKS

- BAR MAIN COUNTER & FRAME IN OLD WOOD ARCH FINISH. FACADE RUSTED METAL PLY WITH RIVETS -ALL EXPOSED EXISTING STEEL COLS. AND BEAMS PAINTED IN OLD EFFECT METAL COLOR TBD.

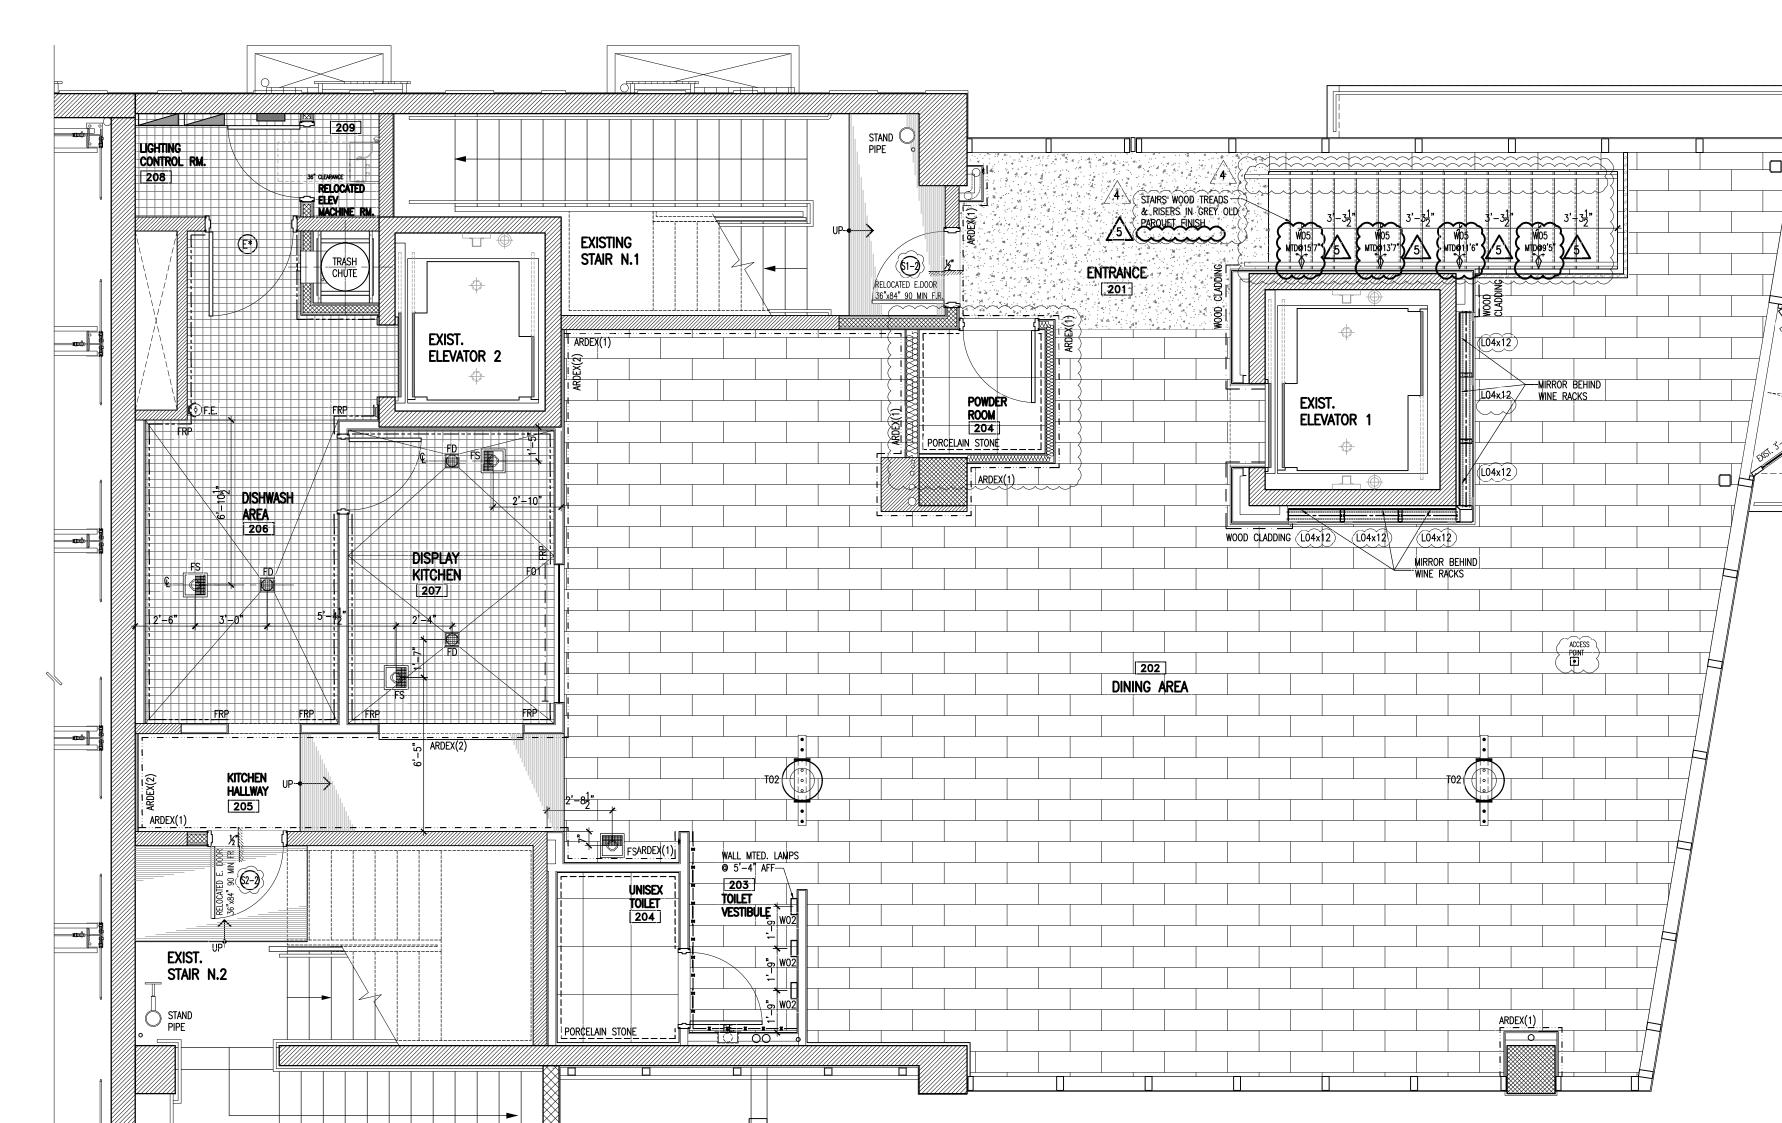

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DRAWN BY Lilian R. Paez C.

DATE

2-18-2013

SCALE

AS SHOWN

SECOND LEVEL

SCALE: 1/4"= 1'-0"

PROPOSED FINISH PLAN

PROJECT NUMBER

CLADDING FINISH

VERANDA 210

LEGEND AUDIO/SECURITY

ID5: 2-WAY FULL RANGE LOUDSPEAKER DIM: 10.8 H X 7.3 W X 8.0 D

AC255: LF / SUBWOOFER SYSTEM LOUD SPEAKER DIM: 24H X 33W X 24D AD-S32T: SURFACE MOUNT LOUDSPEAKER SYSTEM W/70/100 V TRANSFORMER. COLOR WHITE

ID55:2-WAY FULL RANGE LOUDSPEAKER

W/ CONE WOOFER **SECOND FLOOR

← KEYPAD: REMOTE CONTROL SYSTEMO2 MÚLTIMEDIA PŘOJECTOR: ÉPSON POWERLITE PRO G5750WU

DA-LITE AUTOMATIC ELEC. PROJECT: SCRÈEN,

**RACK @ LEVEL 4-OFFICE 16 GA GANGABLE ENCLOSURE

5-37MIDDLE ATLANTIC PRODUCTS, INC:*KLR-2000 TWO

CHANNEL AMPLIFIER, *PROTEA NE24.24 M MATRIX

LEGEND

EXISTING MASONRY WALL

EXISTING PARTITION

NON RATED PARTITION

2HR. RATED PARTITION

NON RATED PARTITION

W/SOUND INSULATION

EXIST. CONCRETE COL.

DOOR NUMBER

100 ROOM NUMBER

PARTITION TYPE

SECTION MARK

ELECTRICAL PANEL

FIRE EXTINGUISHER

11-05-13 OWNER CHANGES: REVISED LIGHTING

NEW ACCENT LIGHT @ HANDRAIL

FINISH SCHEDULE NOTES RECTIFIED

1 04-30-13 CITY COMMENTS:

ISSUED FOR PERMIT

4 09-23-13 CITY COMMENTS: REMOVED STRIP LIGHT @ NOSING

3\ 08-06-13 OWNER CHANGES: GENERAL REVISION OF EQUIPMENT

REVISED LIGHTING, SOUND & SECURITY SYSTEM 2 06-14-13 CITY COMMENTS: NEW POWDER ROOM UPDATED FINISH SCHEDULE & NOTES

EXISTING ELEVATOR CALL BUTTONS TO BE RELOCATED ON NEW WALL WOOD

FLOOR SINK

FLOOR DRAIN

PARTITION TO BE REMOVED

DOOR CLOSER

ALARM KEYPAD

ACCESS POINT


M MICROPHONE

-NETWORK ROUTER -SECURITY CONTROL

DOME SURVEILLANCE VANDAL PROOF DOME CAMERA: ICR-300H3B/ICR-300H3W SONY/


TOILET:CONTROL 24C/CT MICRO (LOW PROFILE)

DIM: 16.2 H X 7.3 W X 8.0 D ID1.108-64: 2-WAY FULL RANGE S6 LOUDSPEAKER DIM: 19.1Hx10.9Wx11.5Dx5.1T AD-C42T: CEILING MOUNT LOUDSPEAKER SYS

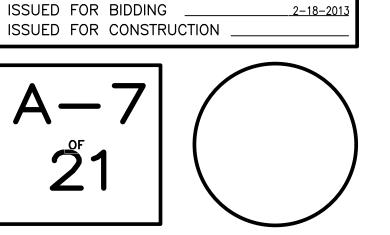

2-18-2013

NEW RESTAURANT FOR:

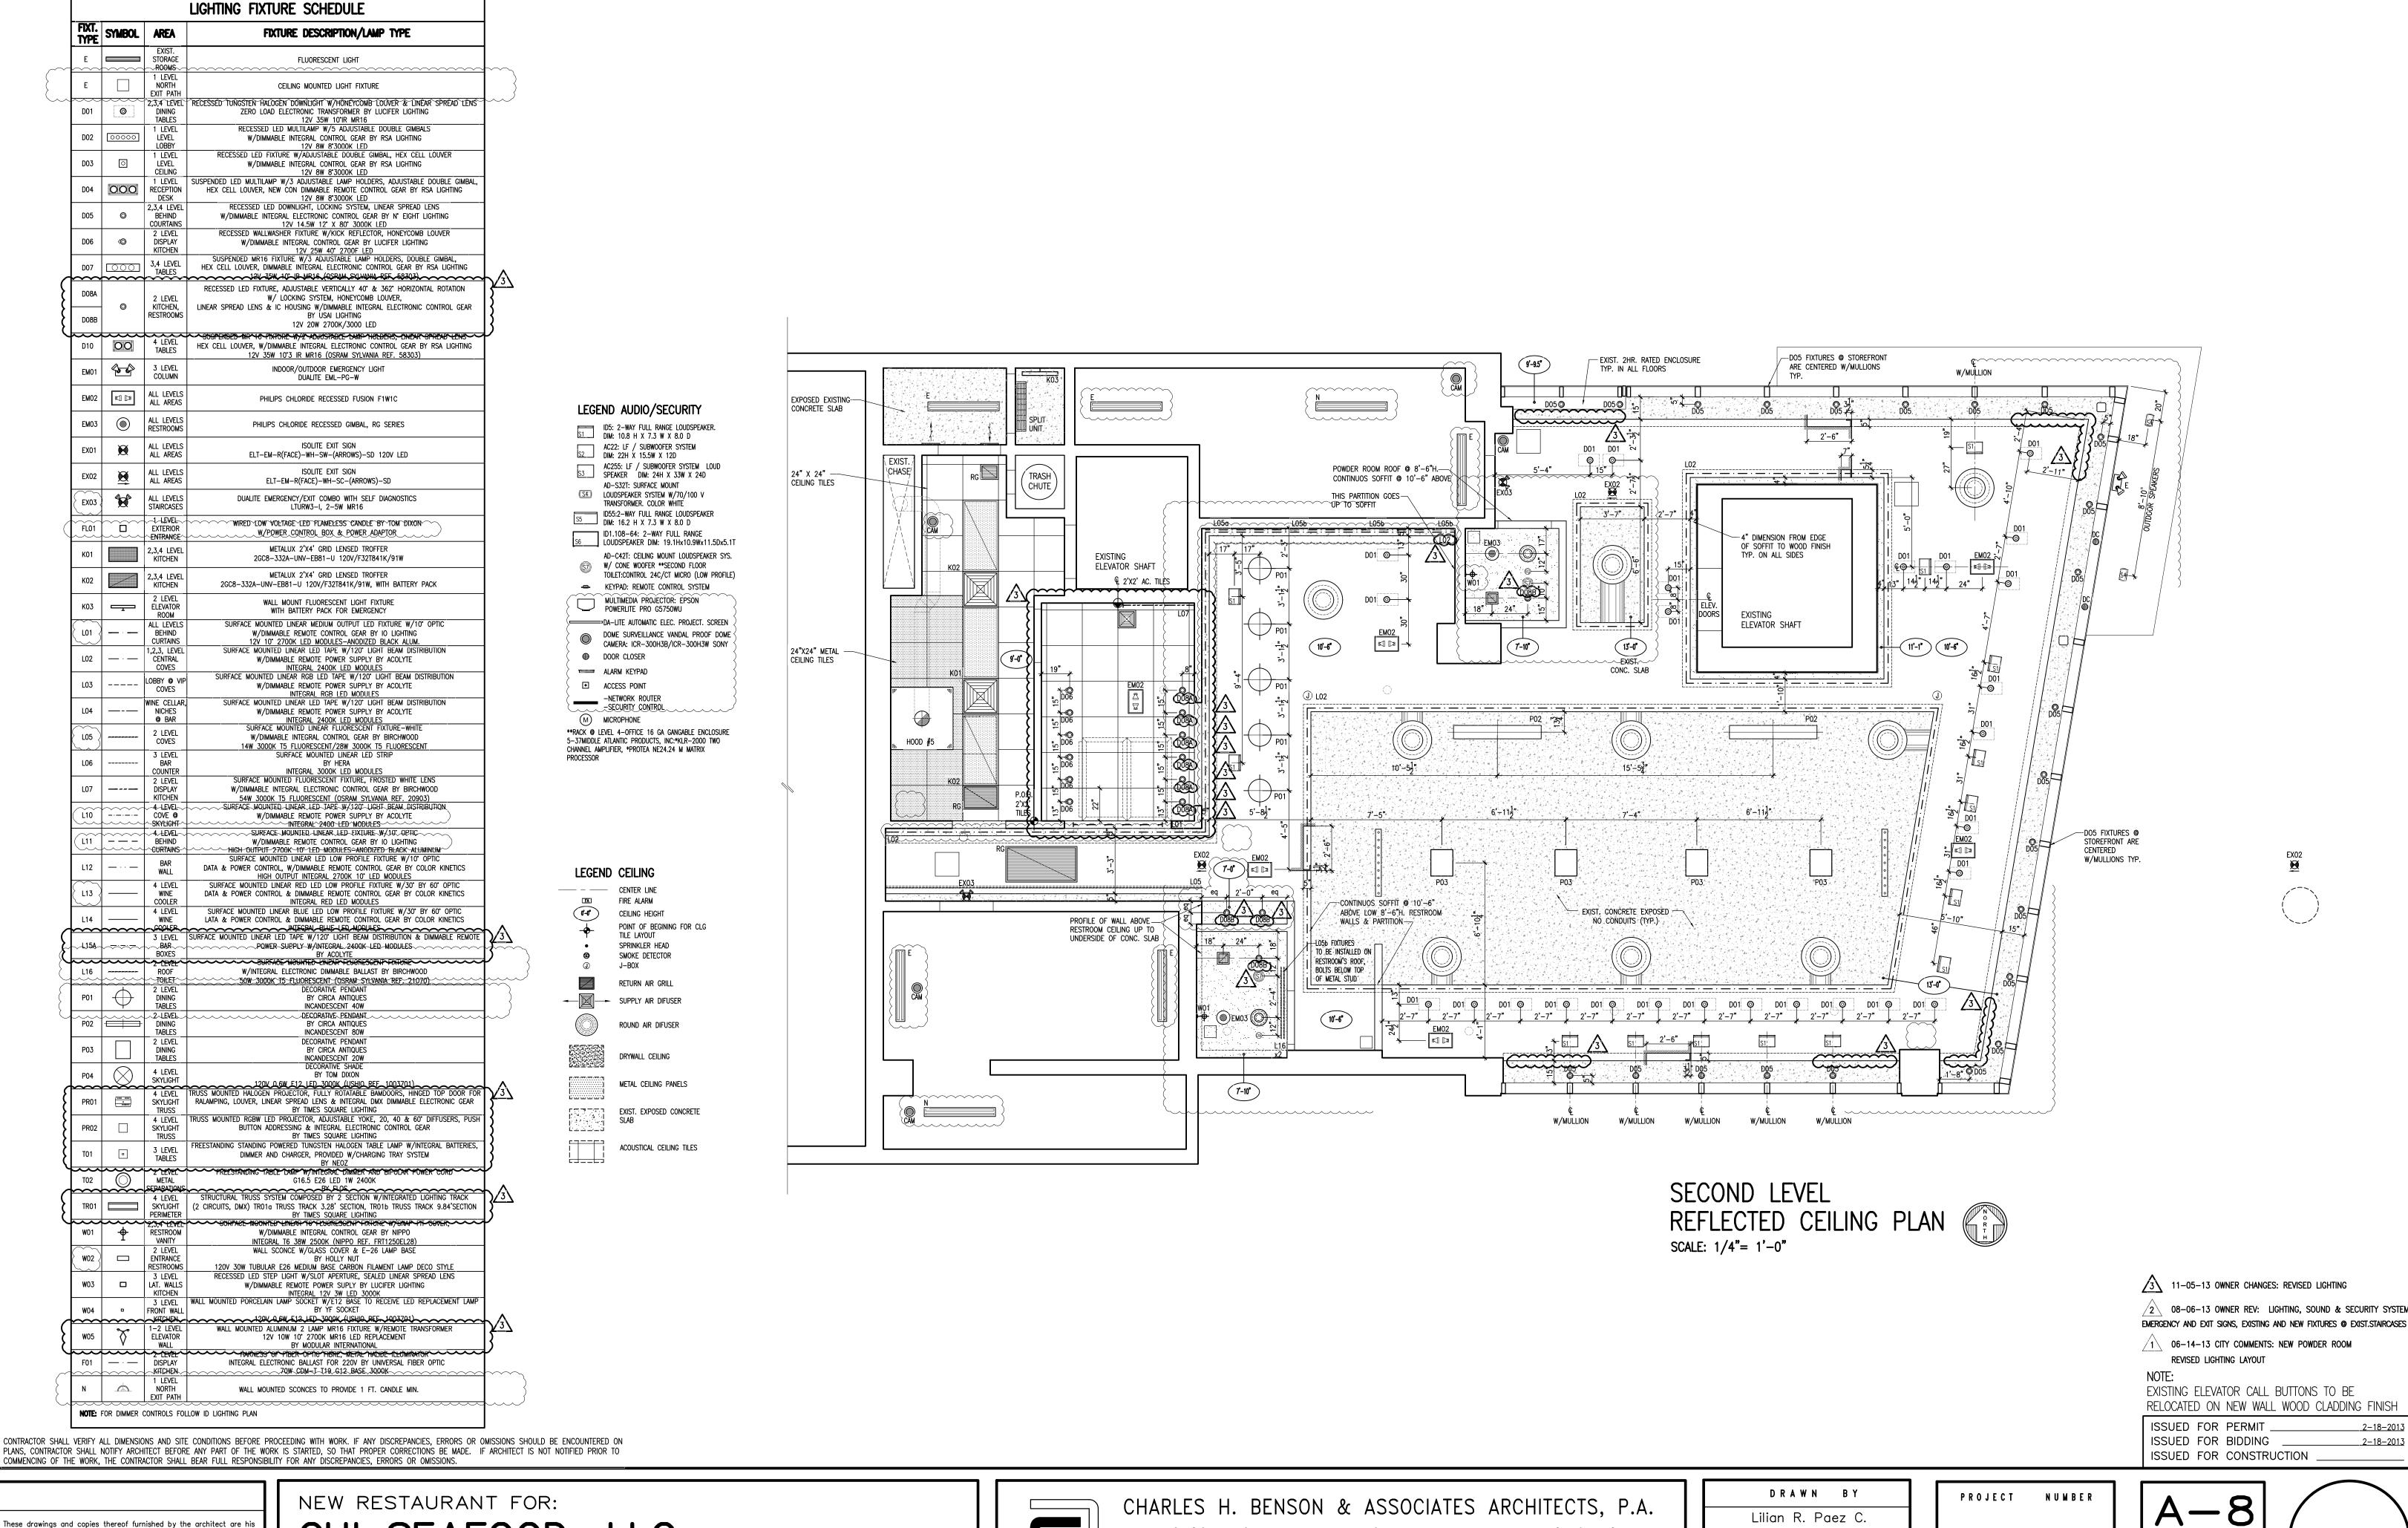

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CHI SEAFOOD, LLC

1826 COLLINS AVE.

Miami Beach, Fl. 33139



architect planner

ARCHITECTURE LICENCE # AR14022

interiors 1665 WASHINGTON AVE. 2nd. FLOOR MIAMI BEACH, FLORIDA 33139 Ph: 305-532-6161 * Fax: 305-532-6151

NCARB CERTIFICATE # 42,136


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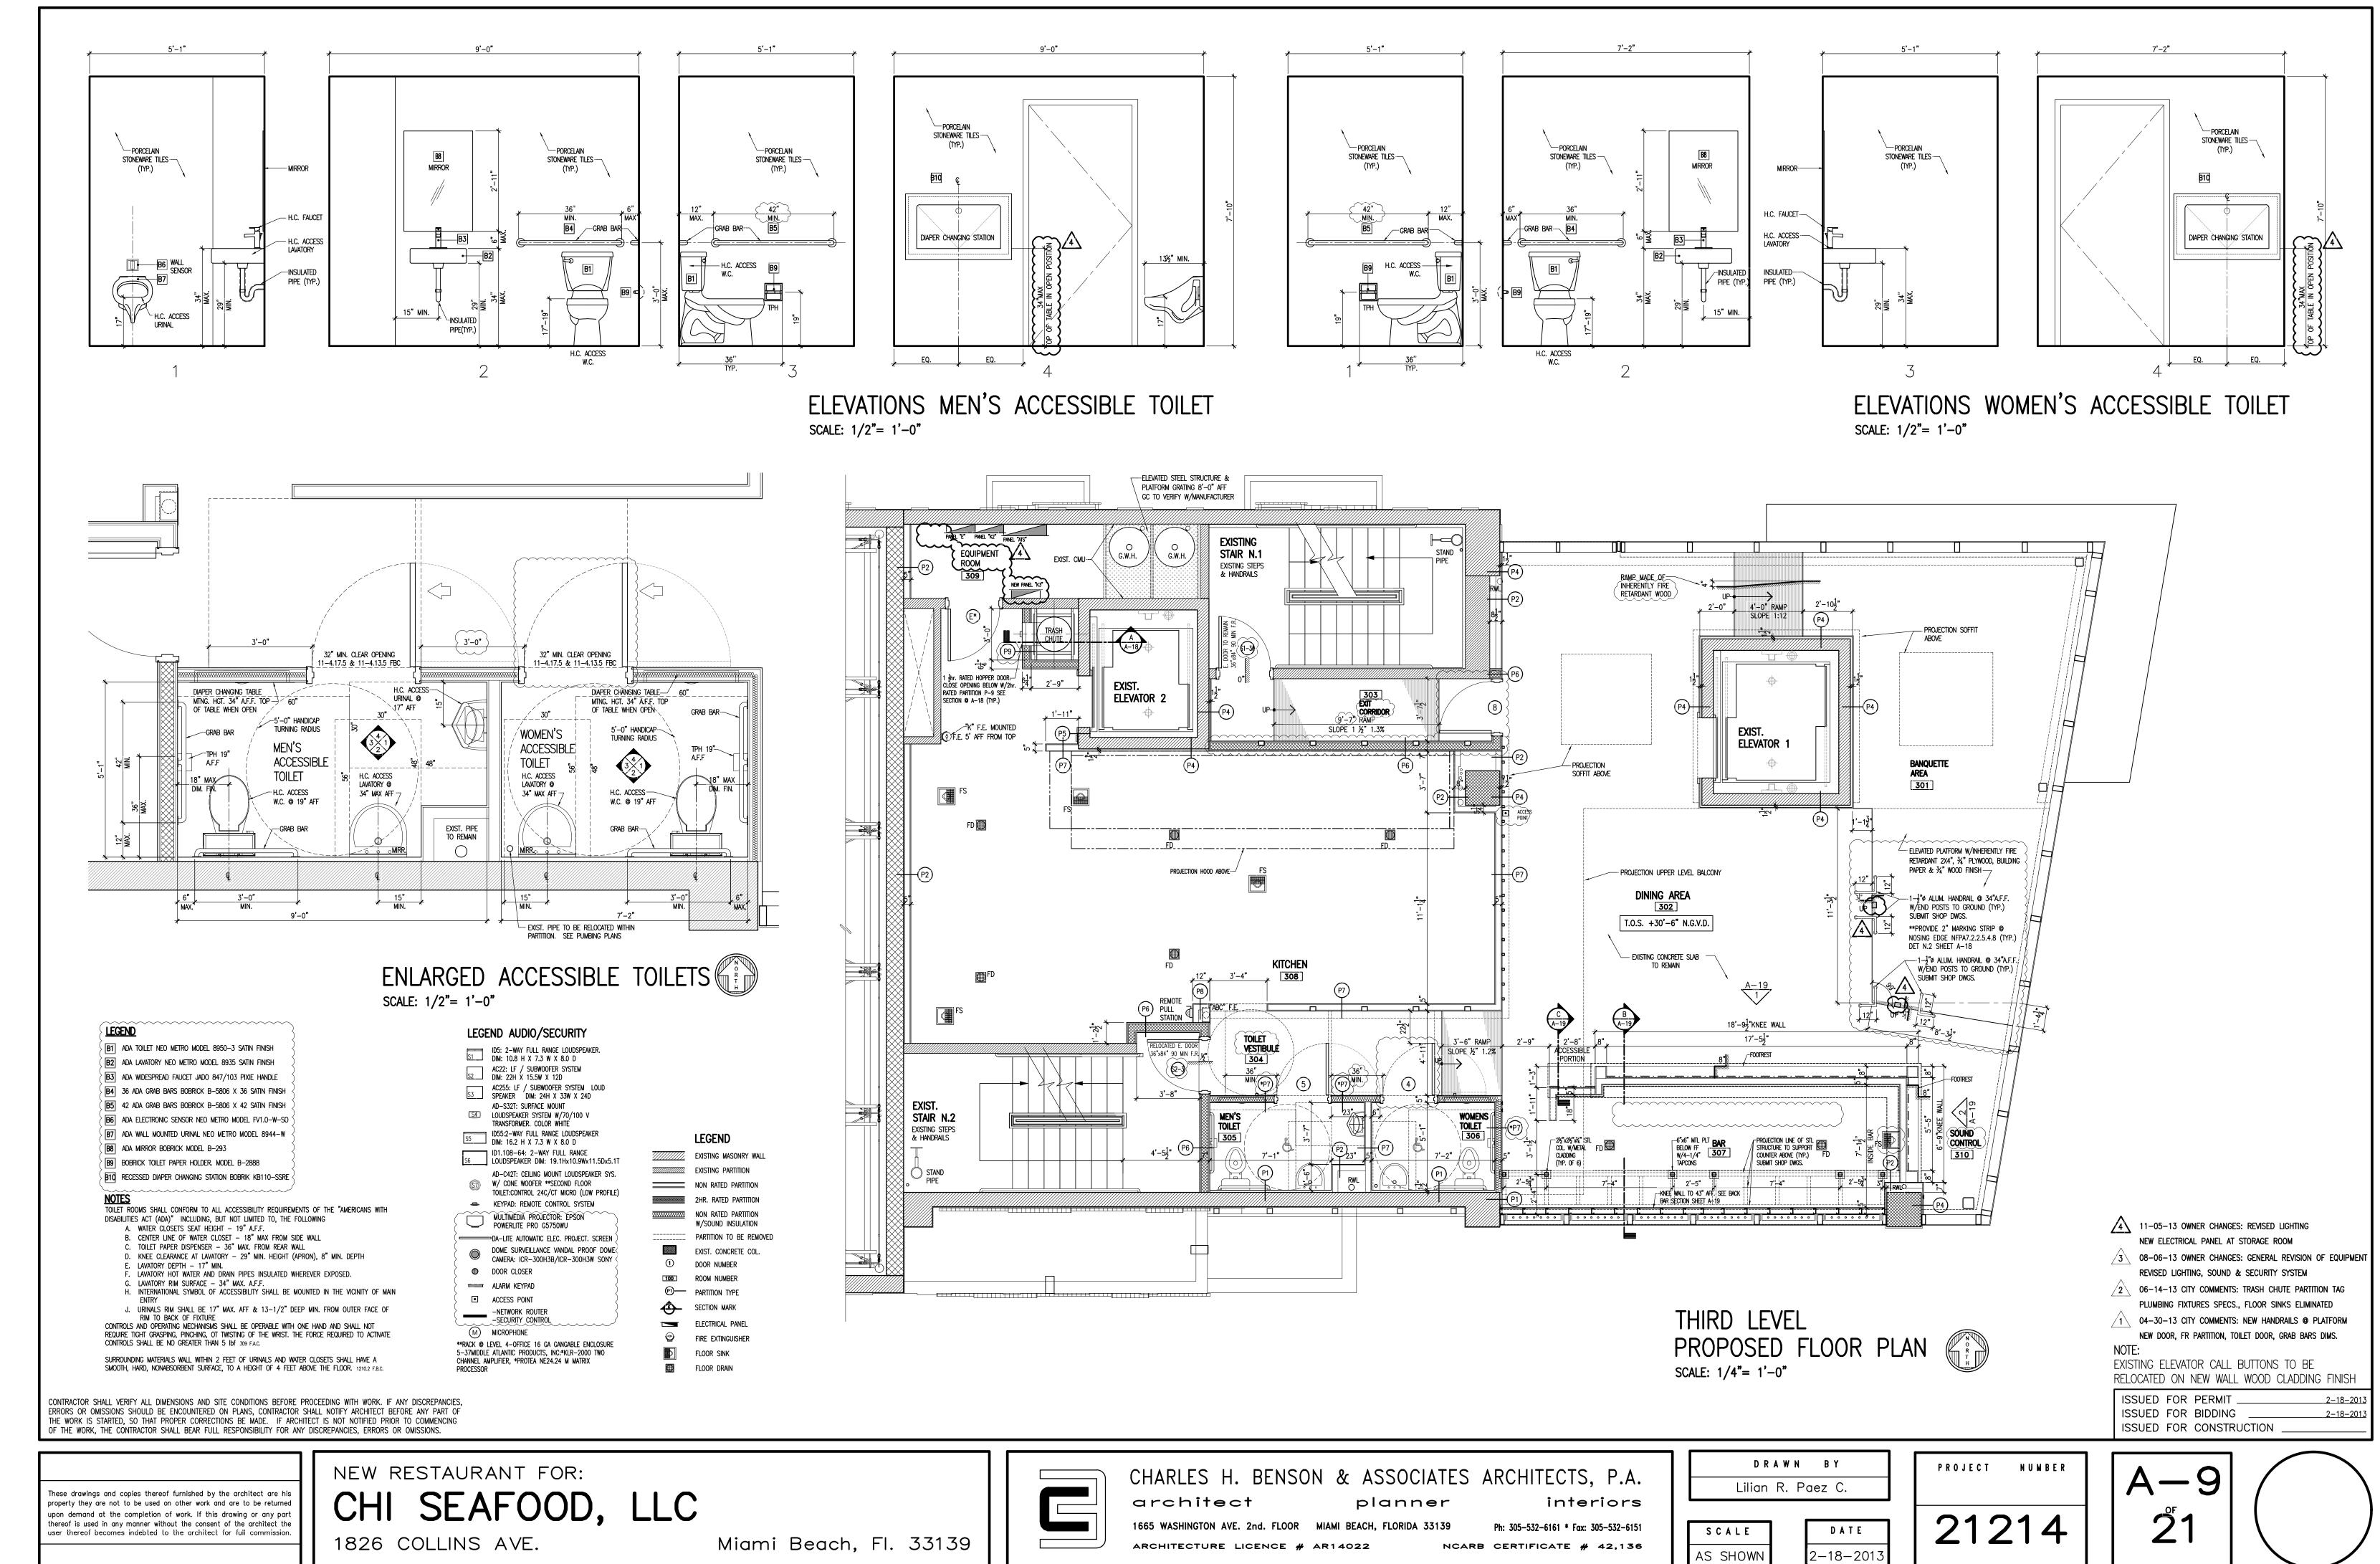
2-18-2013

SCALE

AS SHOWN

21214




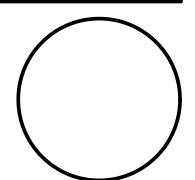



1826 COLLINS AVE.

ARCHITECTURE LICENCE # AR14022

AS SHOWN

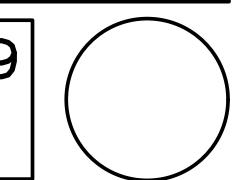


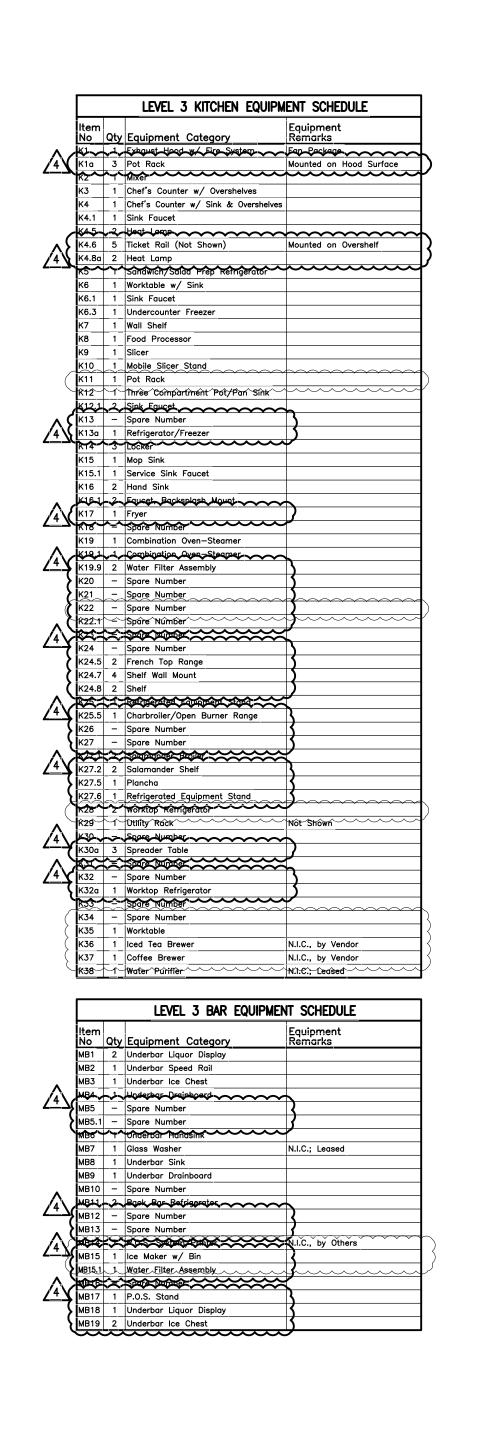

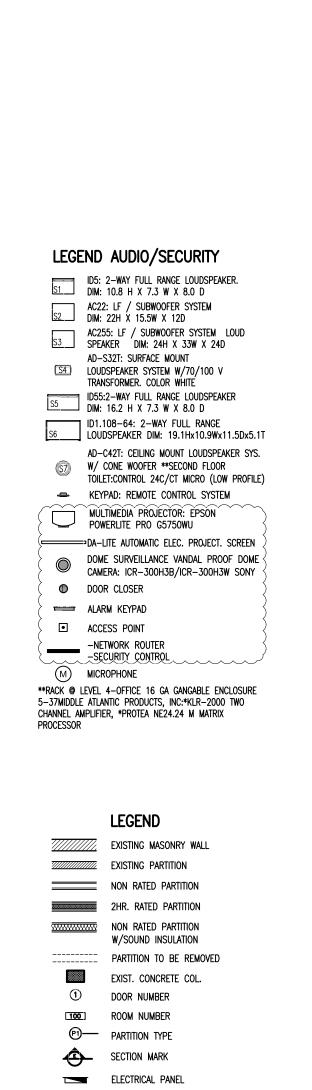

FIRE EXTINGUISHER

FLOOR DRAIN

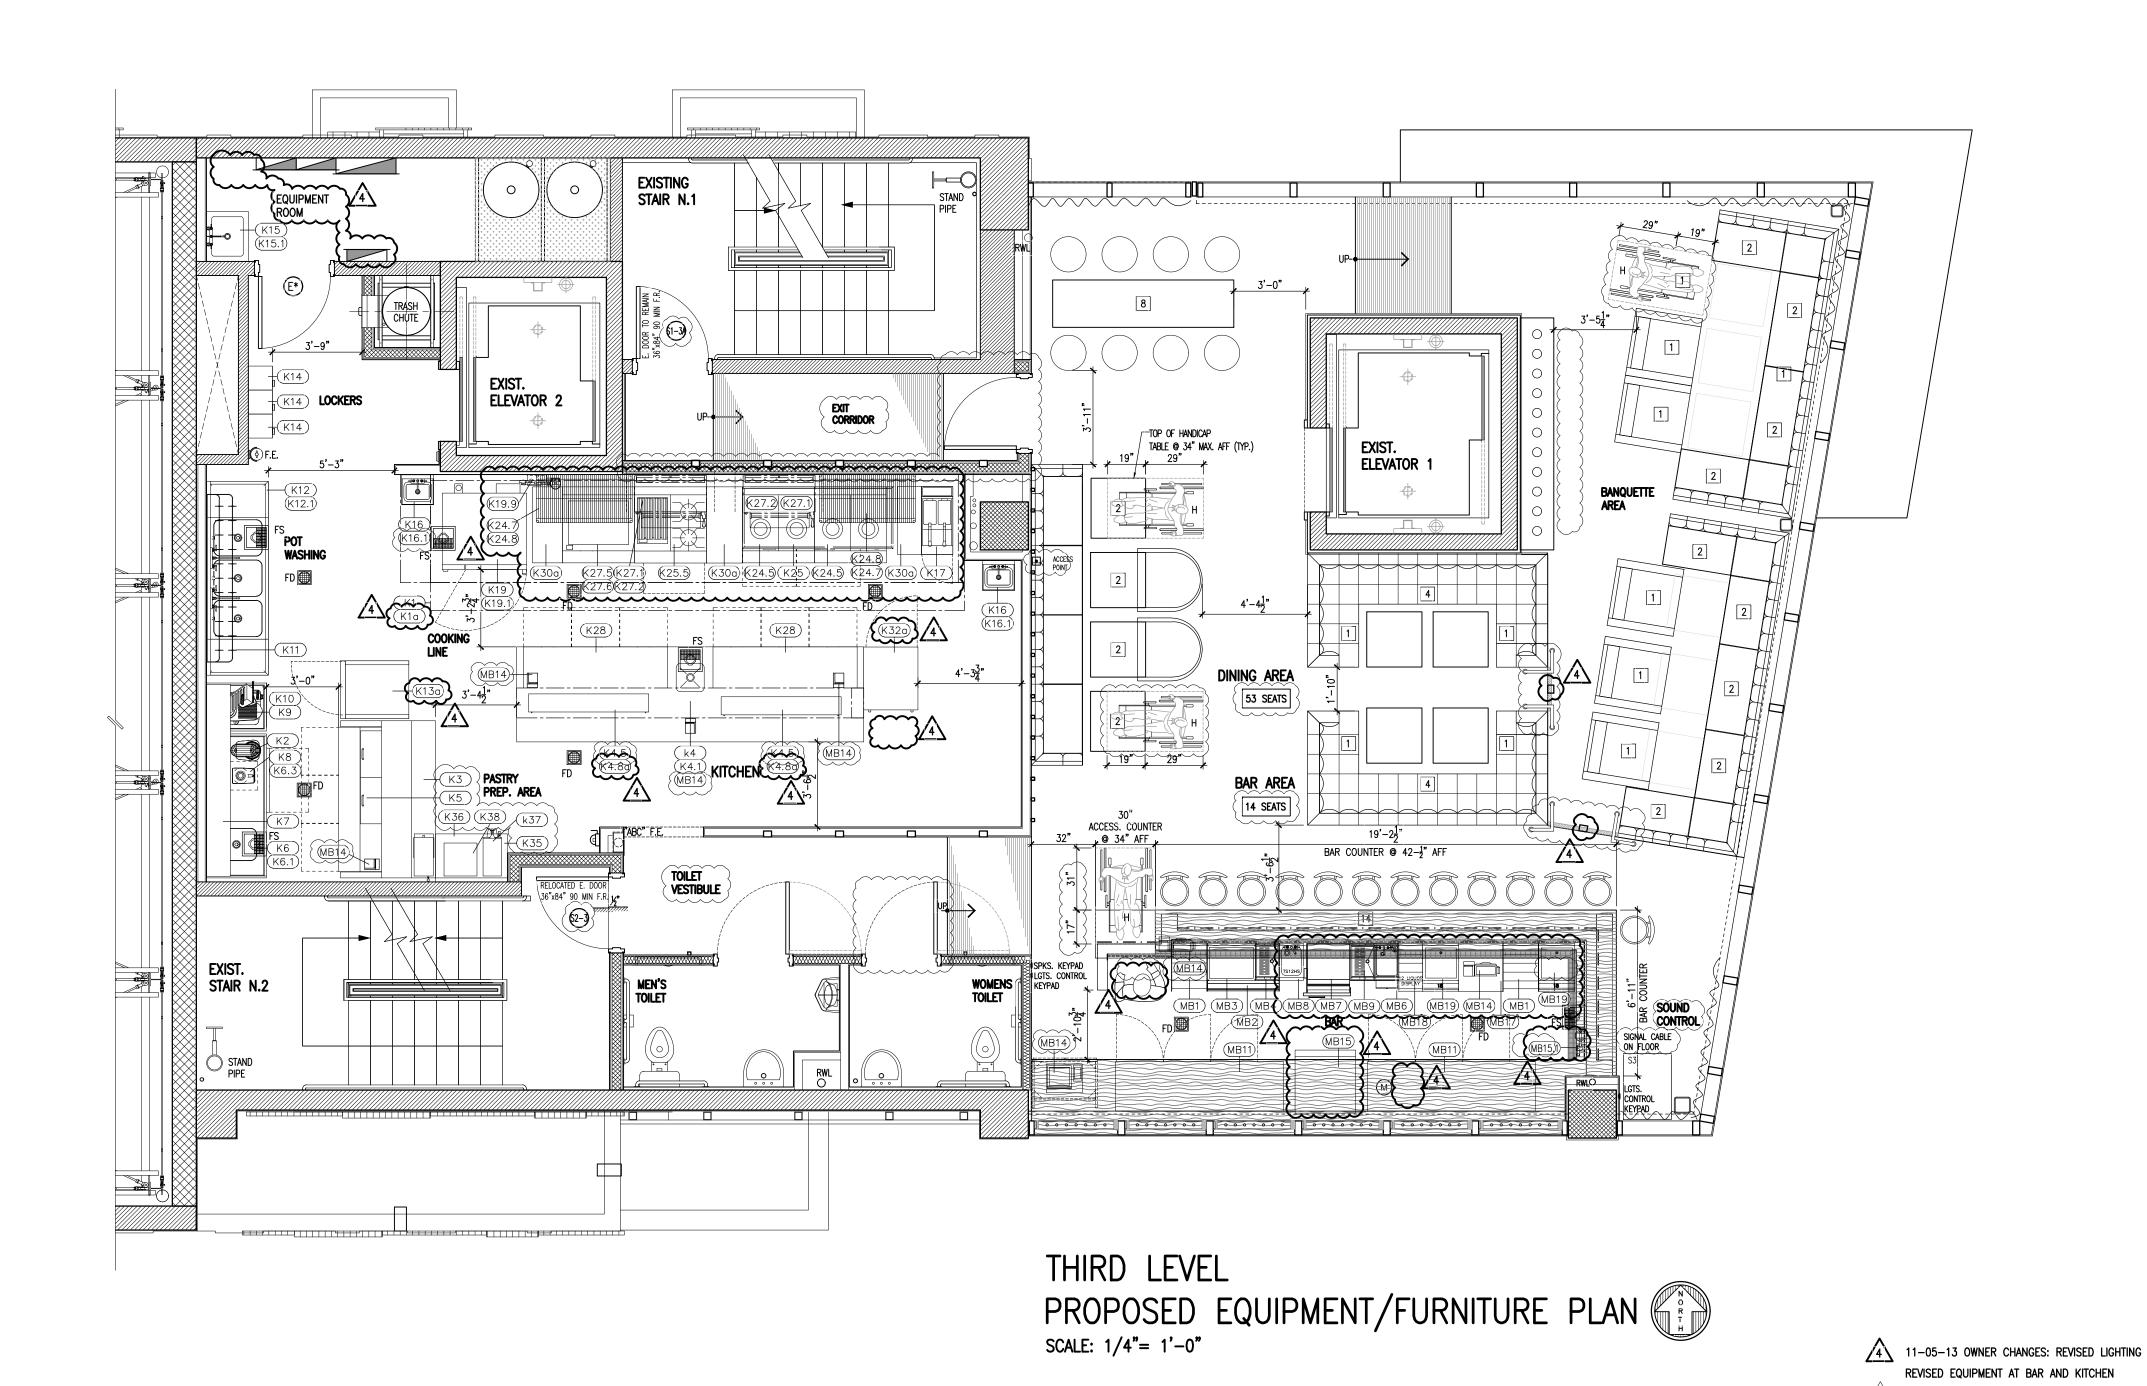

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CHARLES H. BENSON & ASSOCIATES ARCHITECTS, P.A. architect planner interiors

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DRAWN BY Lilian R. Paez C.

SCALE

AS SHOWN


DATE

2-18-2013

PROJECT NUMBER

21214

71

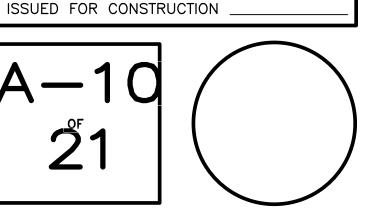

2-18-2013

2-18-2013

3 08-06-13 OWNER CHANGES: GENERAL REVISION OF EQUIPMENT

1\ 04-30-13 CITY COMMENTS: NEW HANDRAILS @ PLATFORM

RELOCATED ON NEW WALL WOOD CLADDING FINISH


REVISED LIGHTING, SOUND & SECURITY SYSTEM 2 06-14-13 CITY COMMENTS: HANDICAP SEATING


EXISTING ELEVATOR CALL BUTTONS TO BE

NEW DOOR, OCCUPANCY

ISSUED FOR PERMIT

ISSUED FOR BIDDING ____

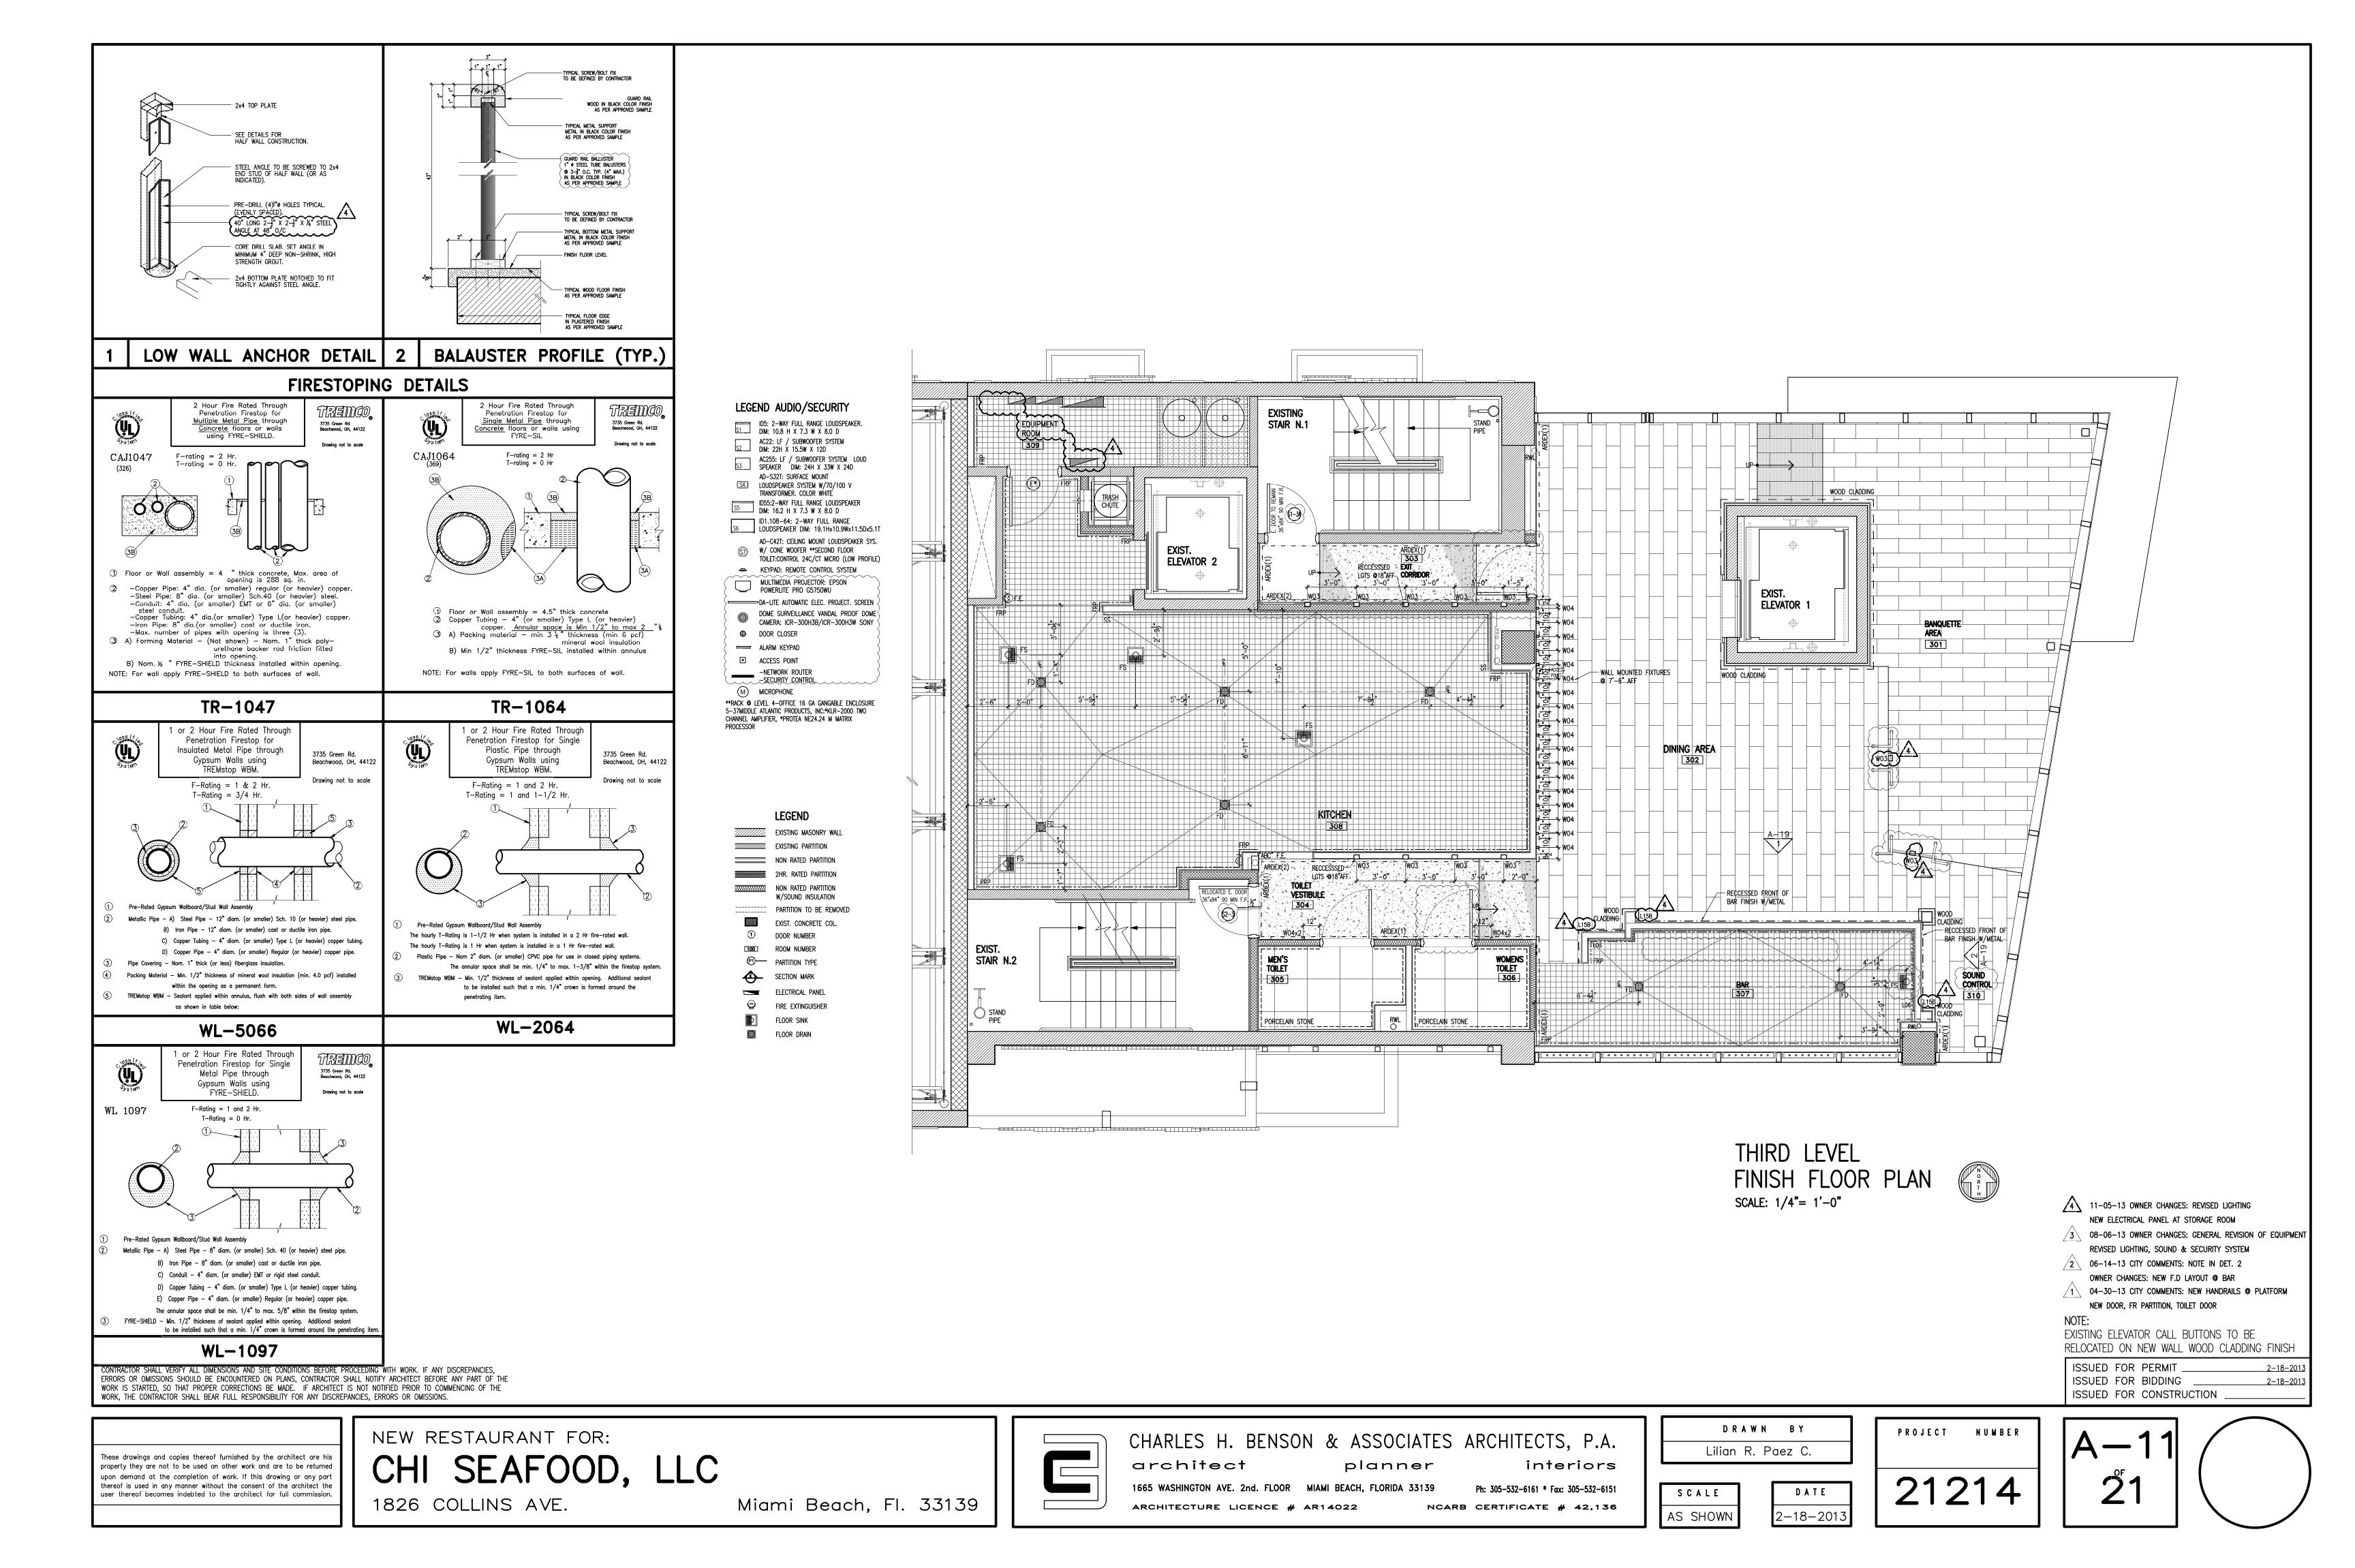

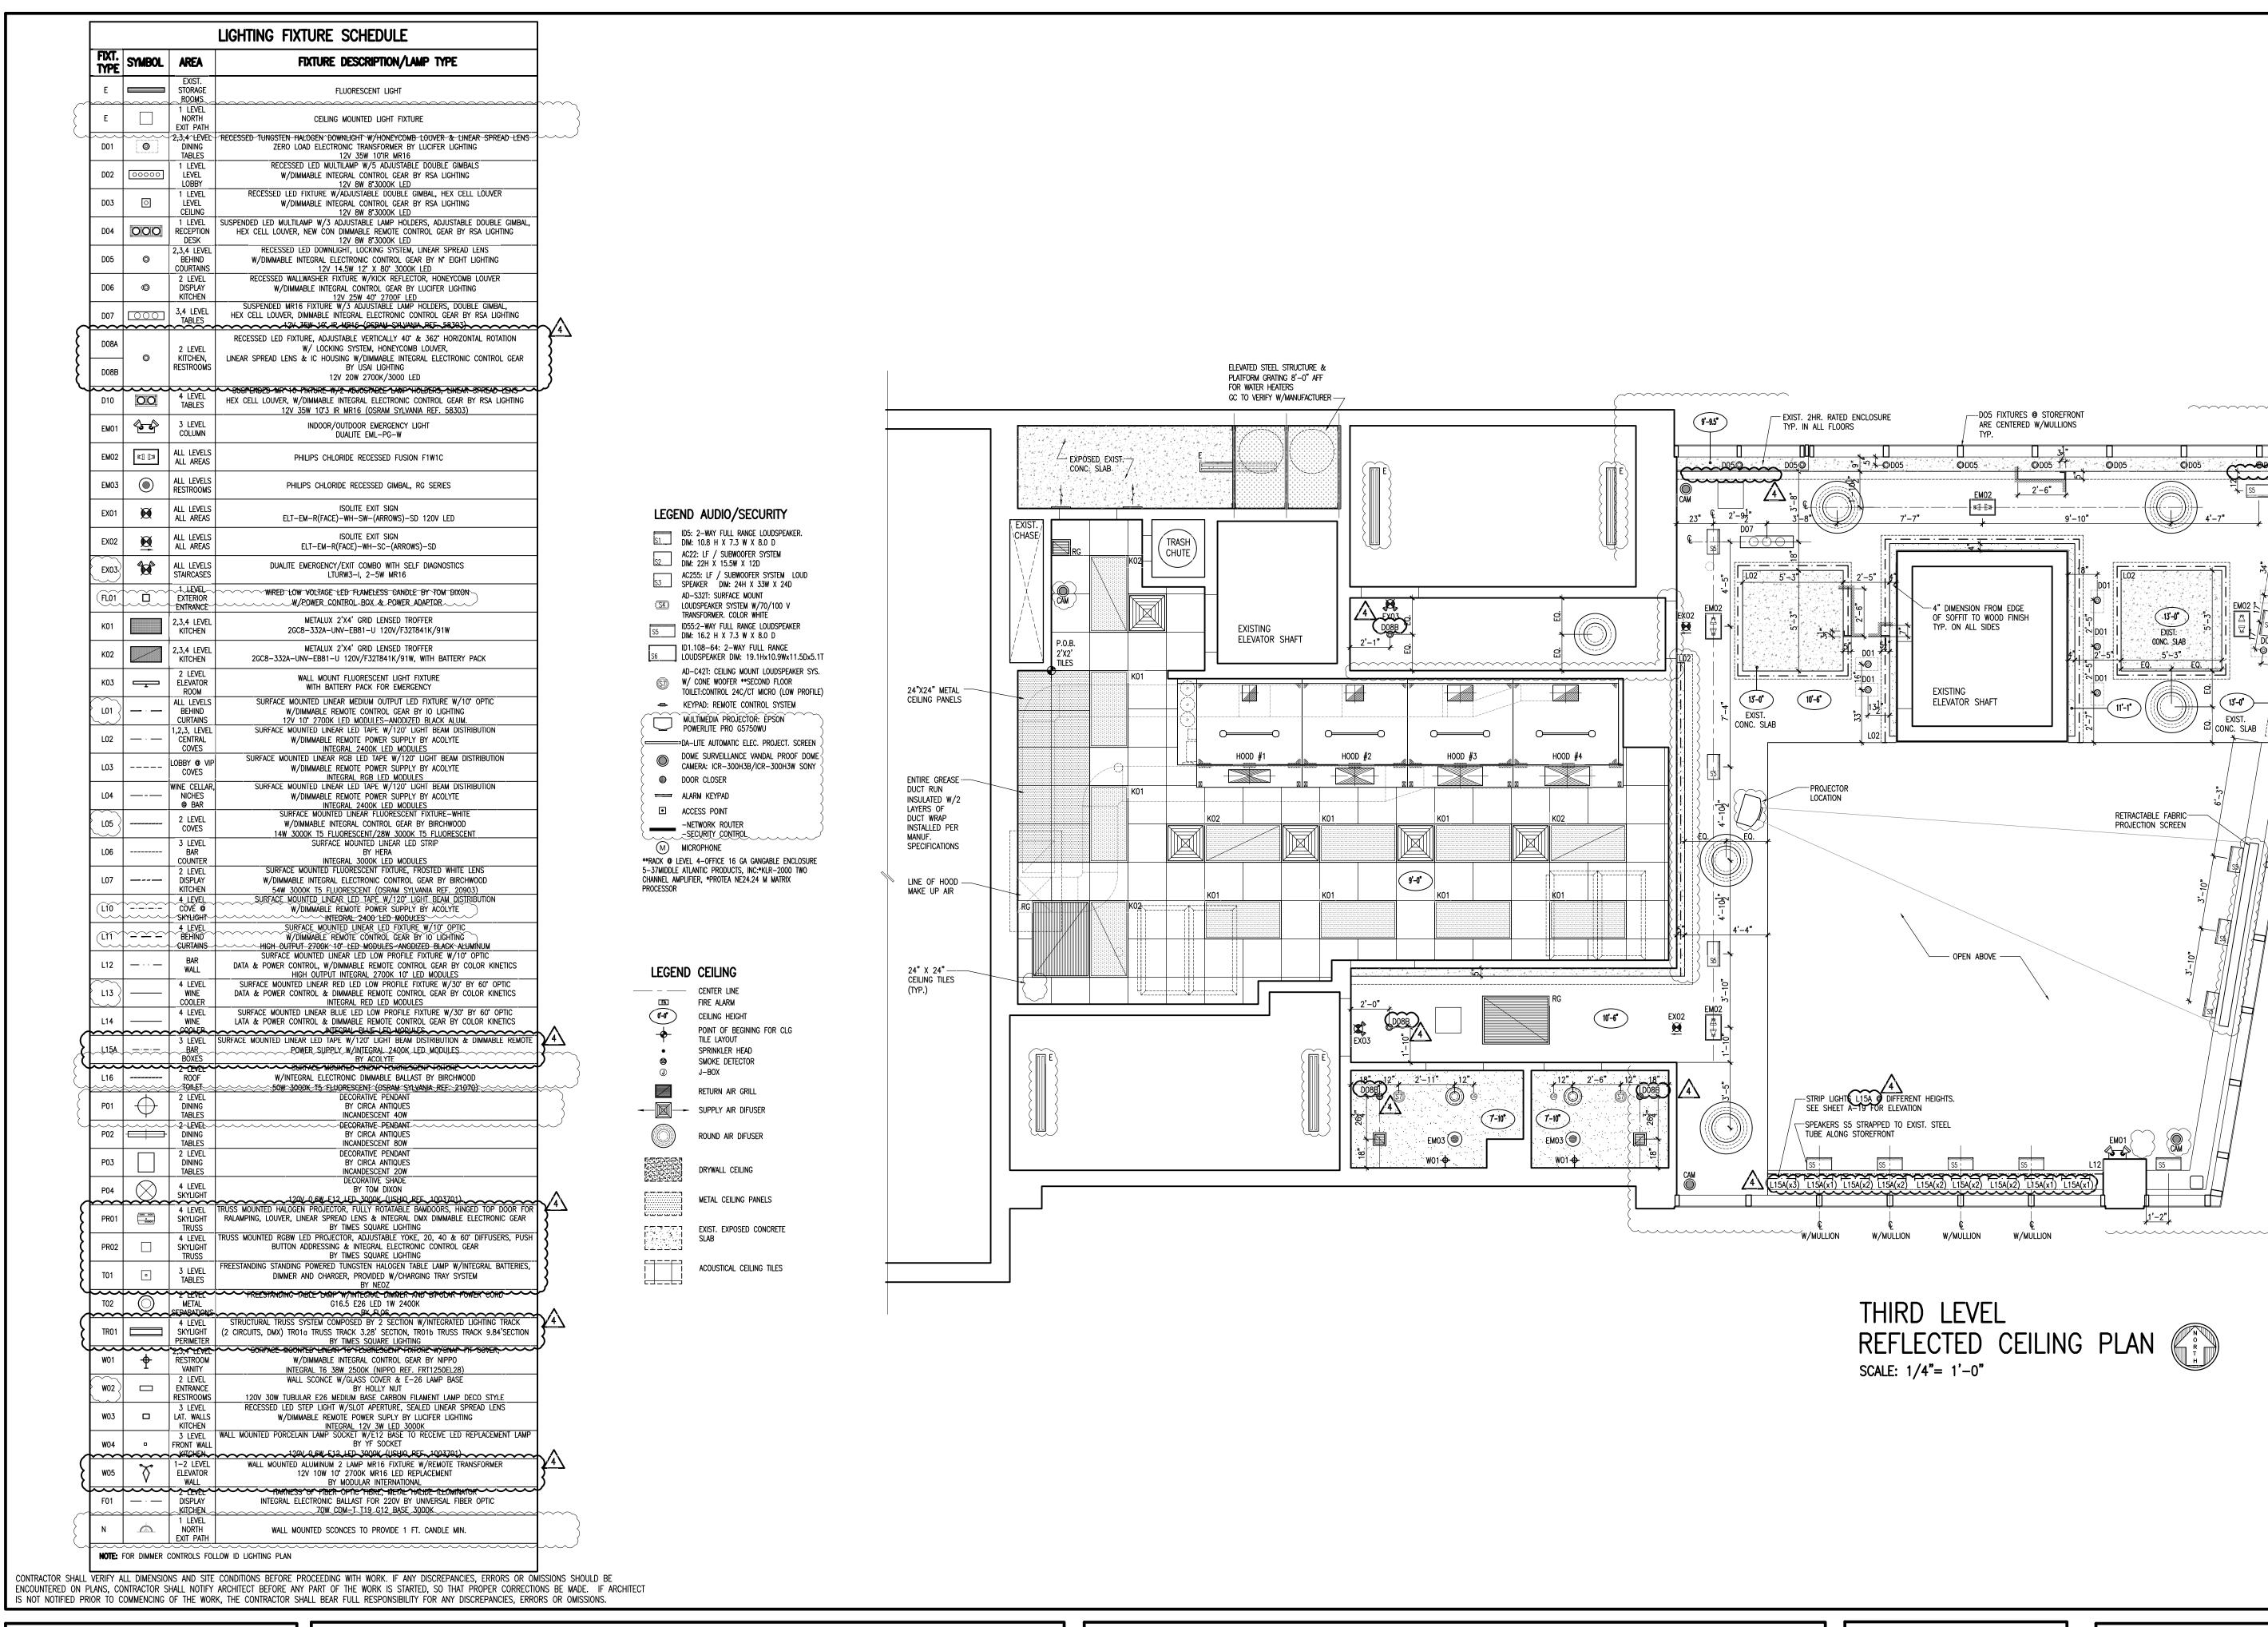

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DRAWN BY Lilian R. Paez C.

DATE

2-18-2013

SCALE

AS SHOWN

PROJECT NUMBER

21214

سسسس

CONC. SLAB

RETRACTABLE FABRIC-

PROJECTION SCREEN

©D05

NOTE:

11-05-13 OWNER CHANGES: REVISED LIGHTING

08-06-13 OWNER REV: LIGHTING, SOUND & SECURITY SYSTEM

EMERGENCY AND EXIT SIGNS, EXISTING AND NEW FIXTURES @ EXIST.STAIRCASES

06-14-13 OWNER CHANGES: REVISED LIGHTING LAYOUT


1\ 04-30-13 CITY COMMENTS: NEW DOOR, FR PARTITION

RELOCATED ON NEW WALL WOOD CLADDING FINISH


EXISTING ELEVATOR CALL BUTTONS TO BE

ISSUED FOR PERMIT

ISSUED FOR BIDDING ___

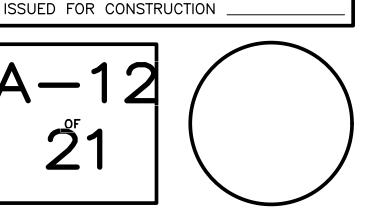

2-18-2013

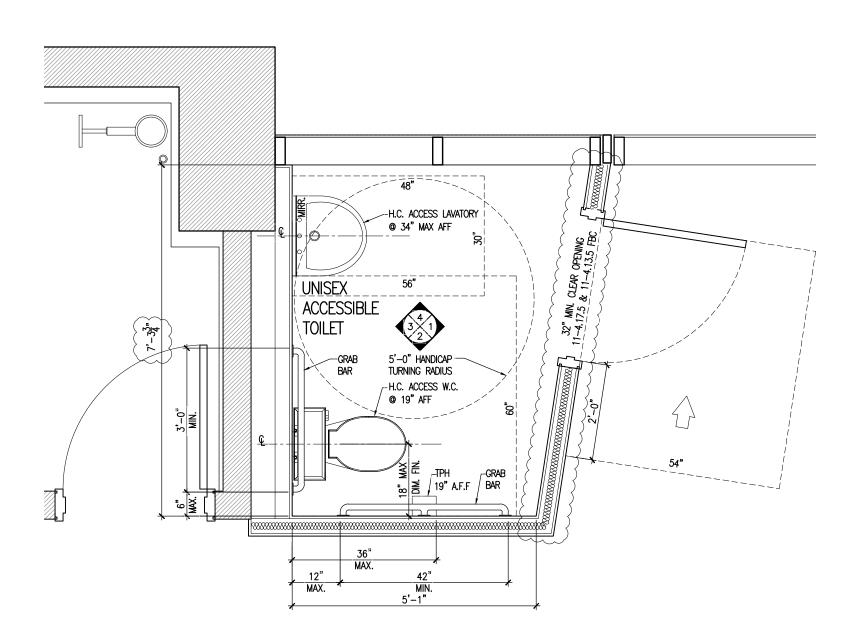



STOREFRONT NOTES

STOREFRONT ELEVATIONS ARE FOR GENERAL CONFIGURATION ONLY. MANUFACTURER TO DESIGN STOREFRONTS TO MEET ALL APPLICABLE BUILDING CODE REQUIREMENTS AND SHALL SUBMIT SHOP DRAWINGS, PRODUCT APPROVAL AND STRUCTURAL CALCULATIONS SIGNED AND SEALED BY A FLORIDA REGISTERED ENGINEER FOR REVIEW.

- . ALL GLAZING SHALL MATCH EXISTING AND BE IMPACT RESISTANT 3. ALL ALUMINUM IN STOREFRONTS TO MATCH EXISTING
- . FIELD VERIFY ALL MASONRY OPENINGS PRIOR TO FABRICATION AND NOTE IN SHOP DRAWINGS SUBMITTAL
- . SUBMIT PRODUCT APPROVAL

WITH INSERTS.

- . PROVIDE ANY AND ALL NECESSARY BREAK METAL TO MATCH STOREFRONT ON EXTERIOR VERTICAL AND HORIZONTAL STEEL COLUMNS
- CAULK ALL INTERIOR AND EXTERIOR JOINTS EXPOSED TO VIEW AND DOUBLE BEAK OF CAULKING WHERE BUCK MEETS MASONRY
- ALL REQUIRED STEEL TUBING BETWEEN STOREFRONT SYSTEM BY GLASS
- 9. GLASS DOORS AND ADJACENT GLASS PANELS ARE CATEGORY II SAFETY GLAZING.

SECURITY & FORCED ENTRY PREVENTION REQS.

- ALL SINGLE EXTERIOR SWINGING DOORS SHALL HAVE A LOCK TO BE KEY- OPERATED FROM THE EXTERIOR WITH A MIN. OF 6,000 POSSIBLE KEY CHANGES OR LOCKING AUXILIARY SINGLE DEAD BOLT WITH HARDENED BOLT INSERTS.
- ALL LOCKS ON EXTERIOR DOORS SHALL BE CAPABLE OF RESISTING A FORCE OF 300 POUNDS APPLIED IN ANY MOVABLE DIRECTION AND IN ACCORDANCE WITH RESISTANCE STANDARDS SET FORTH IN THE SOUTH FLORIDA BUILDING CODES.
- THE ACTIVE LEAF OF PAIRS OF EXTERIOR SWINGING DOORS SHALL HAVE THE SAME LOCK AS REQUIRED FOR SINGLE EXTERIOR SWINGING DOORS. THE INACTIVE LEAF OF THESE PAIR OF DOORS SHALL HAVE A MULTIPLE POINT LOCK WITH 5/8" MIN. THROW BOLTS
- . HINGES ON EXTERIOR OUT-SWINGING DOORS SHALL HAVE NON-REMOVABLE PINS. JAMBS OF ALL EXTERIOR OFFSET TYPE IN-SWINGING DOORS SHALL BE RABBETED OR OF A SIMILAR FABRICATION MAINTAIN THE INTEGRITY OF LOCKS AND LATCHES.
- 6. VISION PANELS IN EXTERIOR DOORS, OTHER THAN GLAZING WITHIN 40" OF THE INSIDE LOCK ACTIVATING DEVICE, SHALL COMPLY WITH ANSI 297.1.

TERMITE PROTECTION

105.10 CERTIFICATE OF PROTECTIVE TREATMENT FOR PREVENTION OF TERMITES.

A WEATHER RESISTANT JOBSITE POSTING BOARD SHALL BE PROVIDED TO RECEIVE DUPLICATE TREATMENT CERTIFICATES AS EACH REQUIRED PROTECTIVE TREATMENT IS COMPLETED, PROVIDING A COPY FOR THE PERSON THE PERMIT IS ISSUED TO AND ANOTHER COPY FOR THE BUILDING PERMIT FILES. THE TREATMENT CERTIFICATE SHALL PROVIDE THE PRODUCT USED. IDENTITY OF THE APPLICATOR, TIME AND DATE OF THE TREATMENT, SITE LOCATION, AREA TREATED, CHEMICAL USED, PERCENT CONCENTRATION AND NUMBER OF GALLONS USED, TO ESTABLISH A VERIFIABLE RECORD OF PROTECTIVE TREATMENT. IF THE SOIL CHEMICAL BARRIER METHOD FOR TERMITE PREVENTION IS USED, FINAL EXTERIOR TREATMENT SHALL BE COMPLETED PRIOR TO FINAL BUILDING APPROVAL.

105.11 NOTICE OF TERMITE PROTECTION.

DEPARTMENT OF AGRICULTURE AND CONSUMER SERVICES."

A PERMANENT SIGN WHICH IDENTIFIES THE TERMITE TREATMENT PROVIDER AND NEED FOR RE-INSPECTION AND TREATMENT CONTRACT RENEWAL SHALL BE PROVIDED. THE SIGN SHALL BE POSTED NEAR THE WATER HEATER OR ELECTRIC PANEL.


1816.1 TERMITE PROTECTION.

ALL BUILDINGS SHALL HAVE PRE-CONSTRUCTION TREATMENT PROTECTION AGAINST SUBTERRANEAN TERMITES. THE RULES AND LAWS AS ESTABLISHED BY THE FLORIDA DEPARTMENT OF AGRICULTURE AND CONSUMER SERVICES SHALL BE DEEMED AS APPROVED WITH RESPECT TO PRE-CONSTRUCTION SOIL TREATMENT FOR PROTECTION AGAINST SUBTERRANEAN TERMITES. A CERTIFICATE OF COMPLIANCE SHALL BE ISSUED TO THE BUILDING DEPARTMENT BY THE LICENSED PEST CONTROL COMPANY THAT CONTAINS THE FOLLOWING STATEMENT: "THE BUILDING HAS RECEIVED A COMPLETE TREATMENT FOR THE PREVENTION OF SUBTERRANEAN TERMITES. TREATMENT IS IN ACCORDANCE WITH RULES AND LAWS ESTABLISHED BY THE FLORIDA

CONTRACTOR SHALL VERIFY ALL DIMENSIONS AND SITE CONDITIONS BEFORE PROCEEDING WITH WORK. IF ANY DISCREPANCIES, ERRORS OR OMISSIONS SHOULD BE ENCOUNTERED ON PLANS, CONTRACTOR SHALL NOTIFY ARCHITECT BEFORE ANY PART OF THE

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STOREFRONT ELEVATION SCALE: 1/4"= 1'-0"

LEGEND AUDIO/SECURITY

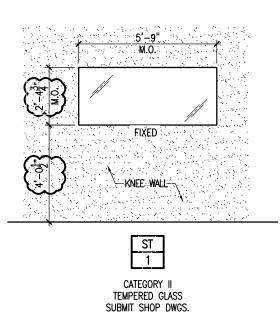
- AC22: LF / SUBWOOFER SYSTEM S2 DIM: 22H X 15.5W X 12D
- LOUDSPEAKER SYSTEM W/70/100 V TRANSFORMER. COLOR WHITE ID55:2-WAY FULL RANGE LOUDSPEAKER
- DIM: 16.2 H X 7.3 W X 8.0 D ID1.108-64: 2-WAY FULL RANGE (\$7) W/ CONE WOOFER **SECOND FLOOR
- ── KEYPAD: REMOTE CONTROL SYSTEM MULTIMEDIA PROJECTOR: EPSON POWERLITE PRO G5750WU DA-LITE AUTOMATIC ELEC. PROJECT. SCREEN DOME SURVEILLANCE VANDAL PROOF DOME CAMERA: ICR-300H3B/ICR-300H3W SONY
- DOOR CLOSER ALARM KEYPAD ACCESS POINT
- -NETWORK ROUTER
 -SECURITY CONTROL MICROPHONE **RACK @ LEVEL 4-OFFICE 16 GA GANGABLE ENCLOSURE 5-37MIDDLE ATLANTIC PRODUCTS, INC:*KLR-2000 TWO CHANNEL AMPLIFIER, *PROTEA NE24.24 M MATRIX

LEGEND

① DOOR NUMBER ROOM NUMBER PARTITION TYPE


SECTION MARK FIRE EXTINGUISHER FLOOR SINK FLOOR DRAIN

PARTITION TO BE REMOVED EXIST. CONCRETE COL.

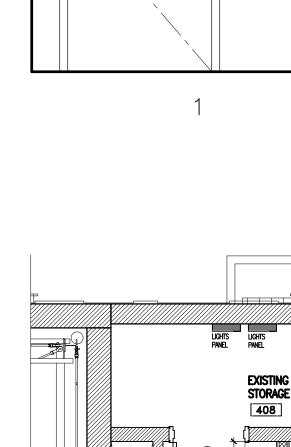

—PORCELAIN

STONEWARE TILES -

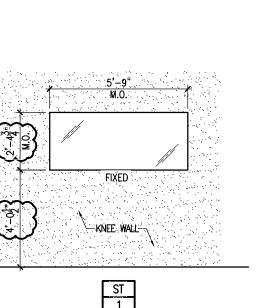

- ID5: 2-WAY FULL RANGE LOUDSPEAKER DIM: 10.8 H X 7.3 W X 8.0 D
- AC255: LF / SUBWOOFER SYSTEM LOUD SPEAKER DIM: 24H X 33W X 24D AD-S32T: SURFACE MOUNT
- LOUDSPEAKER DIM: 19.1Hx10.9Wx11.5Dx5.1T AD-C42T: CEILING MOUNT LOUDSPEAKER SYS. TOILET:CONTROL 24C/CT MICRO (LOW PROFILE)
 - - ELECTRICAL PANEL

______EXISTING MASONRY WALL NON RATED PARTITION 2HR. RATED PARTITION NON RATED PARTITION W/SOUND INSULATION

— PORCELAIN STONEWARE TILES -STONEWARE TILES --STONEWARE TILES -H.C. FAUCET — H.C. ACCESS-LAVATORY H.C. ACCESS — INSULATED--∠-INSULATED PIPE (TYP.)

15" MIN.

ELEVATIONS ACCESSIBLE TOILET SCALE: 1/2"= 1'-0"

- B1 ADA TOILET NEO METRO MODEL 8950-3 SATIN FINISH
 - B2 ADA LAVATORY NEO METRO MODEL 8935 SATIN FINISH B3 ADA WIDESPREAD FAUCET JADO 847/103 PIXIE HANDLE
- B4 36 ADA GRAB BARS BOBRICK B-5806 X 36 SATIN FINISH
- B5 42 ADA GRAB BARS BOBRICK B-5806 X 42 SATIN FINISH
- B6 ADA ELECTRONIC SENSOR NEO METRO MODEL FV1.0-W-SO <
- B7 ADA WALL MOUNTED URINAL NEO METRO MODEL 8944-W B8 ADA MIRROR BOBRICK MODEL B-293

CONTROLS SHALL BE NO GREATER THAN 5 lbf 309 F.A.C.


B9 BOBRICK TOILET PAPER HOLDER, MODEL B-2888 \$\overline{\begin{align} \begin{align} \begi

TOILET ROOMS SHALL CONFORM TO ALL ACCESSIBILITY REQUIREMENTS OF THE "AMERICANS WITH DISABILITIES ACT (ADA)" INCLUDING, BUT NOT LIMITED TO, THE FOLLOWING

- A. WATER CLOSETS SEAT HEIGHT 19" A.F.F.
- B. CENTER LINE OF WATER CLOSET 18" MAX FROM SIDE WALL C. TOILET PAPER DISPENSER — 36" MAX. FROM REAR WALL
- D. KNEE CLEARANCE AT LAVATORY 29" MIN. HEIGHT (APRON), 8" MIN. DEPTH E. LAVATORY DEPTH — 17" MIN.
- LAVATORY HOT WATER AND DRAIN PIPES INSULATED WHEREVER EXPOSED. G. LAVATORY RIM SURFACE - 34" MAX. A.F.F. H. INTERNATIONAL SYMBOL OF ACCESSIBILITY SHALL BE MOUNTED IN THE VICINITY OF MAIN
- J. URINALS RIM SHALL BE 17" MAX. AFF & 13-1/2" DEEP MIN. FROM OUTER FACE OF

RIM TO BACK OF FIXTURE CONTROLS AND OPERATING MECHANISMS SHALL BE OPERABLE WITH ONE HAND AND SHALL NOT REQUIRE TIGHT GRASPING, PINCHING, OT TWISTING OF THE WRIST. THE FORCE REQUIRED TO ACTIVATE

SURROUNDING MATERIALS WALL WITHIN 2 FEET OF URINALS AND WATER CLOSETS SHALL HAVE A SMOOTH, HARD, NONABSORBENT SURFACE, TO A HEIGHT OF 4 FEET ABOVE THE FLOOR. 1210.2 F.B.C.

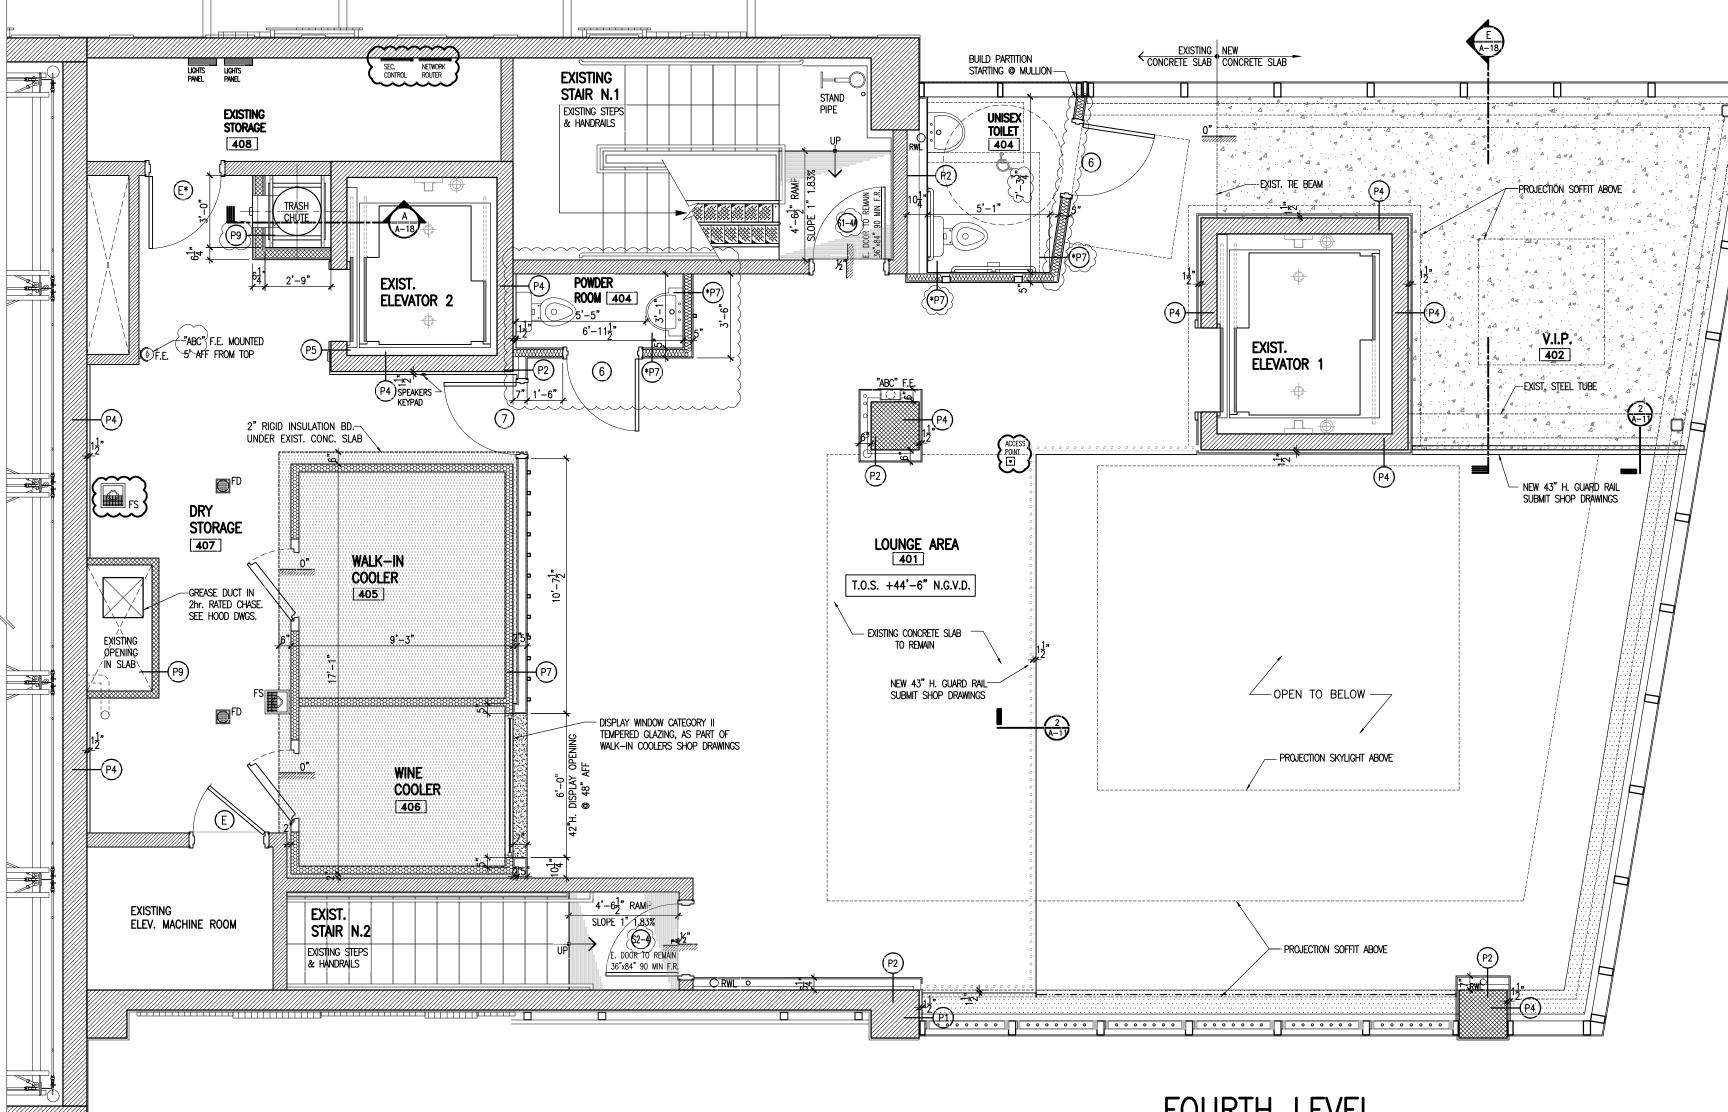

H.C. ACCESS

FOURTH LEVEL PROPOSED FLOOR PLAN SCALE: 1/4"= 1'-0"



23 08-06-13 OWNER CHANGES: GENERAL REVISION OF EQUIPMENT REVISED LIGHTING, SOUND & SECURITY SYSTEM

2 06−14−13 CITY COMMENTS: TRASH CHUTE PARTITION TAG NEW POWDER ROOM, F.E KITCHEN, PLUMBING FIXTURES SPECS.

1 04-30-13 CITY COMMENTS: TOILET CONFIGURATION SIDE GRAB BARS DIMENSIONS

EXISTING ELEVATOR CALL BUTTONS TO BE RELOCATED ON NEW WALL WOOD CLADDING FINISH

ISSUED FOR PERMIT 2-18-2013 ISSUED FOR BIDDING ___ <u>2-18-2013</u> ISSUED FOR CONSTRUCTION

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CHARLES H. BENSON & ASSOCIATES ARCHITECTS, P.A. architect planner interiors


1665 WASHINGTON AVE. 2nd. FLOOR MIAMI BEACH, FLORIDA 33139 Ph: 305-532-6161 * Fax: 305-532-6151 ARCHITECTURE LICENCE # AR14022 NCARB CERTIFICATE # 42,136


DATE SCALE 2-18-201 AS SHOWN

DRAWN BY


Lilian R. Paez C.

PROJECT NUMBER

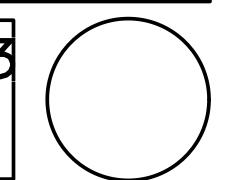

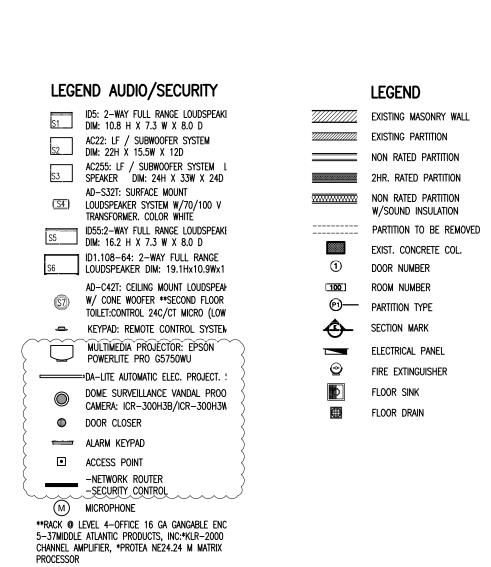

		EVEL 4 FOOD STORAGE EQU	II MILITI SCIILDOLL	
<u>l</u> tem		5	Equipment	
No		Equipment Category	Remarks	
TFS1	1	Reach-In Freezer	<u> </u>	
TSF2	 -	Dry Storage Shelving	Verify Location	
TSF3	1	Walk-In Cooler		
TSF3.1	1	Cooler Evaporator Coil		
TSF3.2	1	Remote Cooler Condenser	On Roof (Sheet FS-203)	
TSF4		Cold Storage Shelving		
TSF4.1	+	Cold Storage Shelving		
TSF5		Cold Storage Shelving		
TSF6	lot	Cold Storage Shelving		
TSF7	1	Walk-In Cooler		
TSF7.1	1	Cooler Evaporator Coil		
TSF7.2	1	Remote Cooler Condenser	On Roof (Sheet FS-203)	
TSF8	lot	Dry Storage Shelving	Not Shown; Verify Location	
TSF9	lot	Wine Rack		
TSF10.1	1_	Wine Shelving	Not Shown; Verify Location	
TSF10.2	_ 1	Wine Shelving	Not Shown; Verify Location	
TSF,11,_	~	Spare Number	······	`
TSF12	1	lce Maker) _
JSF12,1,	1-	Remote Ice Maker Condenser	On Roof (Sheet FS-203)	2/4
TSF12.2	1	Ice Storage Bin	w/ Transport Cart	} x — ∠
TSF 12.3	~~	îcemaker Filter System	~~~~~~~~~~~~~~~~~~~~~~~~~~~~~~~~~~~~~~~	7
ĴSFĴ3	$\stackrel{\sim}{\sim}$	Spare Number		
TSF14	1	Hand Sink)
TSF14.1	1	Faucet, Backsplash Mount)
K38	1	Water Purifier, Wall Mounted	N.I.C., Leased)
MB14	1	P.O.S. System/Printer	N.I.C., by Others)

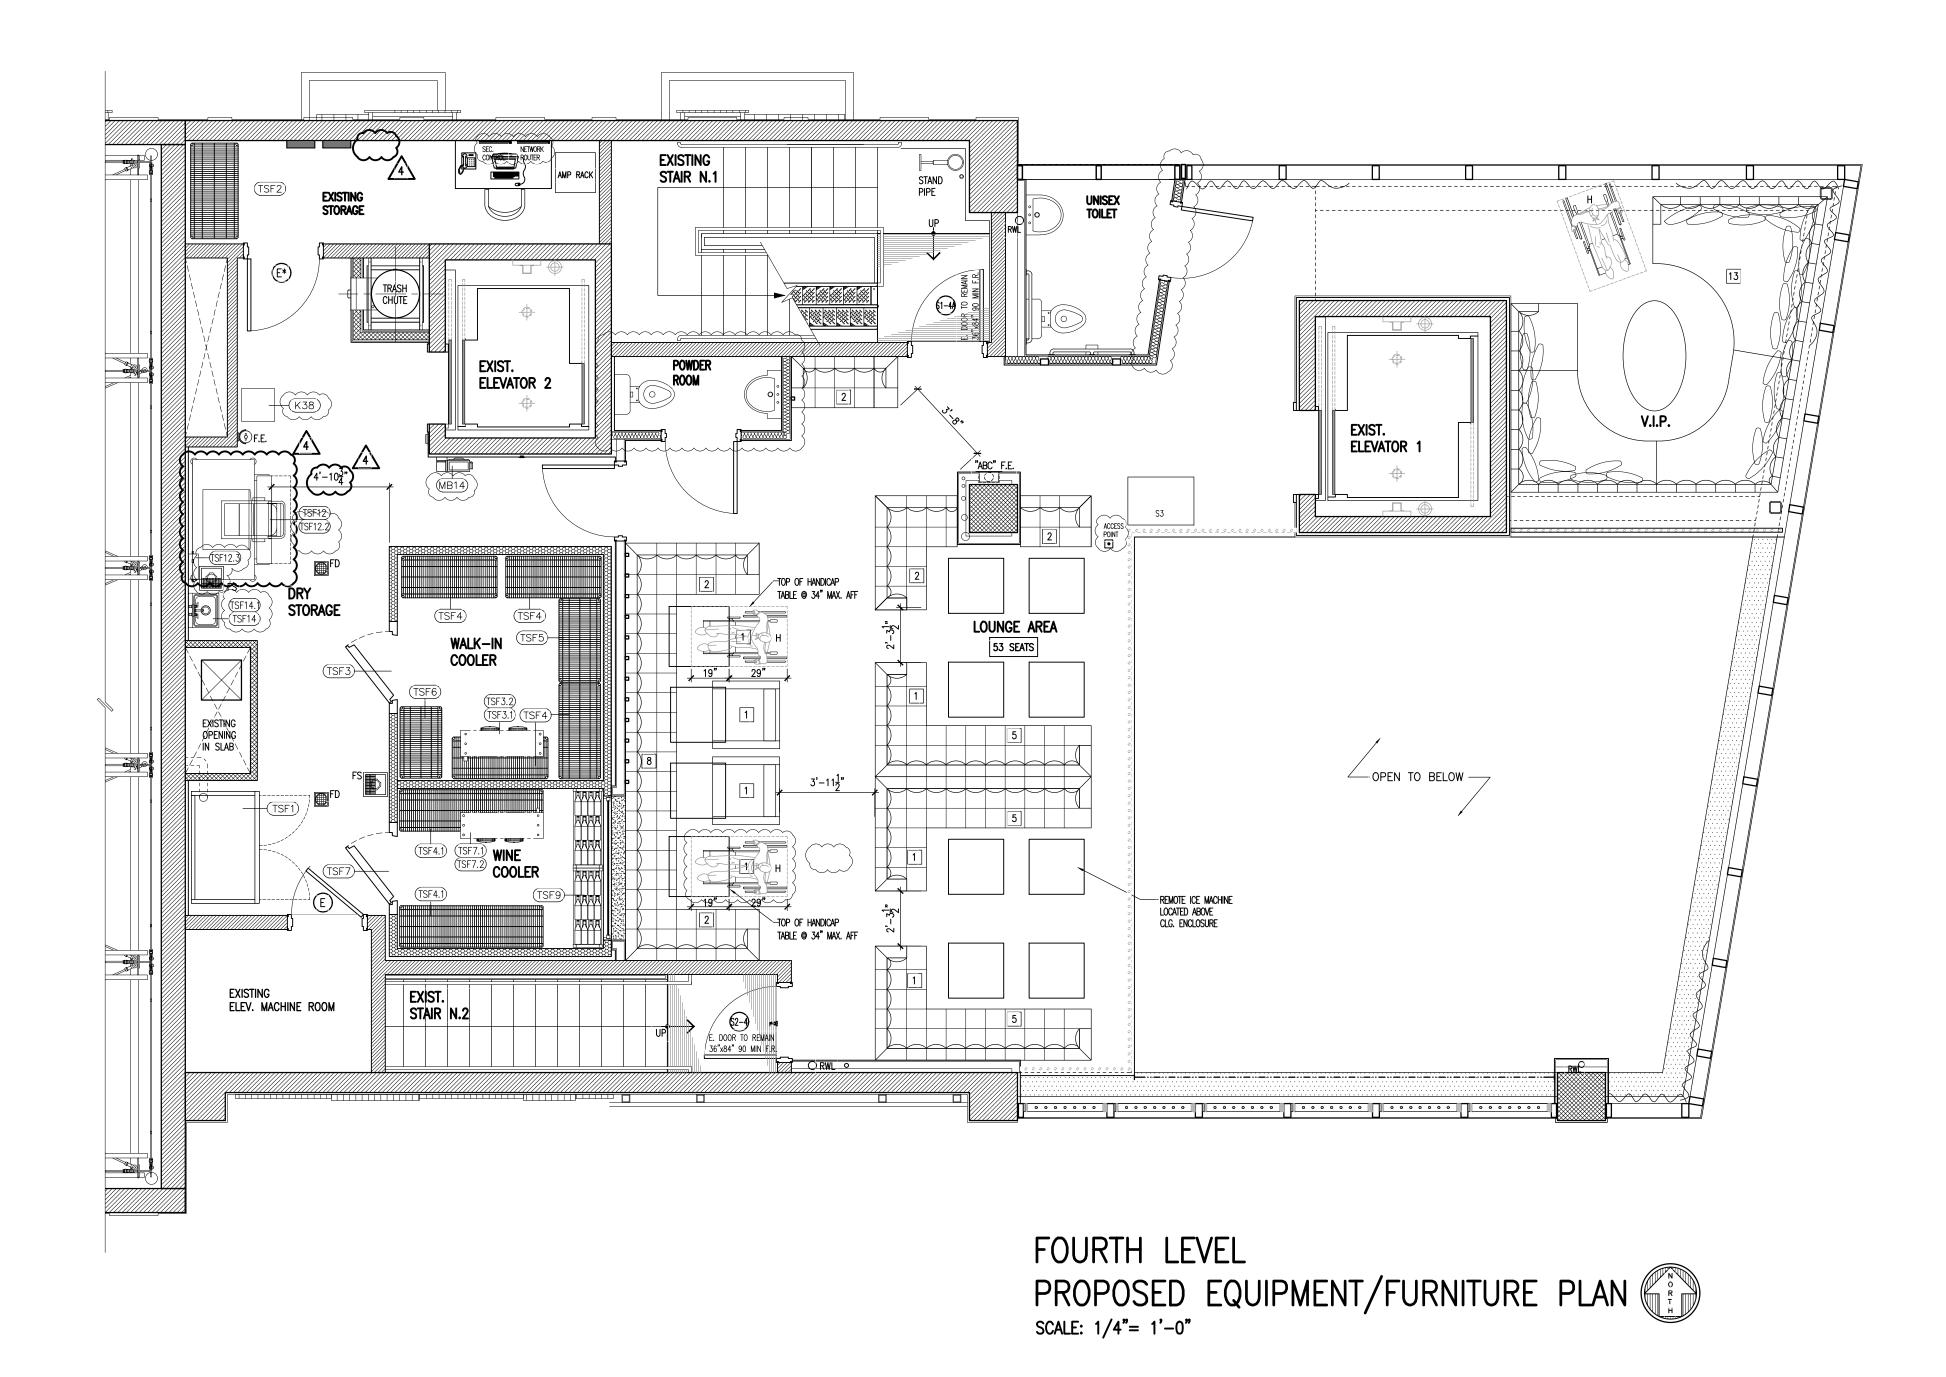

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REVISED EQUIPMENT AT DRY STORAGE

3 08-06-13 OWNER CHANGES: GENERAL REVISION OF EQUIPMENT REVISED LIGHTING, SOUND & SECURITY SYSTEM

11-05-13 OWNER CHANGES: REVISED LIGHTING

2 06-14-13 CITY COMMENTS: NEW POWDER ROOM

1 04-30-13 CITY COMMENTS: RECONFIGURATION TOILET WALL

EXISTING ELEVATOR CALL BUTTONS TO BE RELOCATED ON NEW WALL WOOD CLADDING FINISH

ISSUED FOR PERMIT 2-18-2013 ISSUED FOR BIDDING ____ ISSUED FOR CONSTRUCTION

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Ph: 305-532-6161 * Fax: 305-532-6151 NCARB CERTIFICATE # 42,136

DRAWN BY Lilian R. Paez C.

SCALE


AS SHOWN


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LEGEND AUDIO/SECURITY

AC22: LF / SUBWOOFER SYSTEM DIM: 22H X 15.5W X 12D

ID5: 2-WAY FULL RANGE LOUDSPEAKER.
DIM: 10.8 H X 7.3 W X 8.0 D

AC255: LF / SUBWOOFER SYSTEM LOUD SPEAKER DIM: 24H X 33W X 24D AD-S32T: SURFACE MOUNT LOUDSPEAKER SYSTEM W/70/100 V TRANSFORMER. COLOR WHITE ID55:2-WAY FULL RANGE LOUDSPEAKER DIM: 16.2 H X 7.3 W X 8.0 D

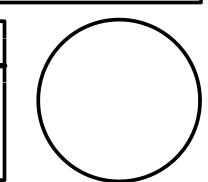ID1.108-64: 2-WAY FULL RANGE LOUDSPEAKER DIM: 19.1Hx10.9Wx11.5Dx5.1T

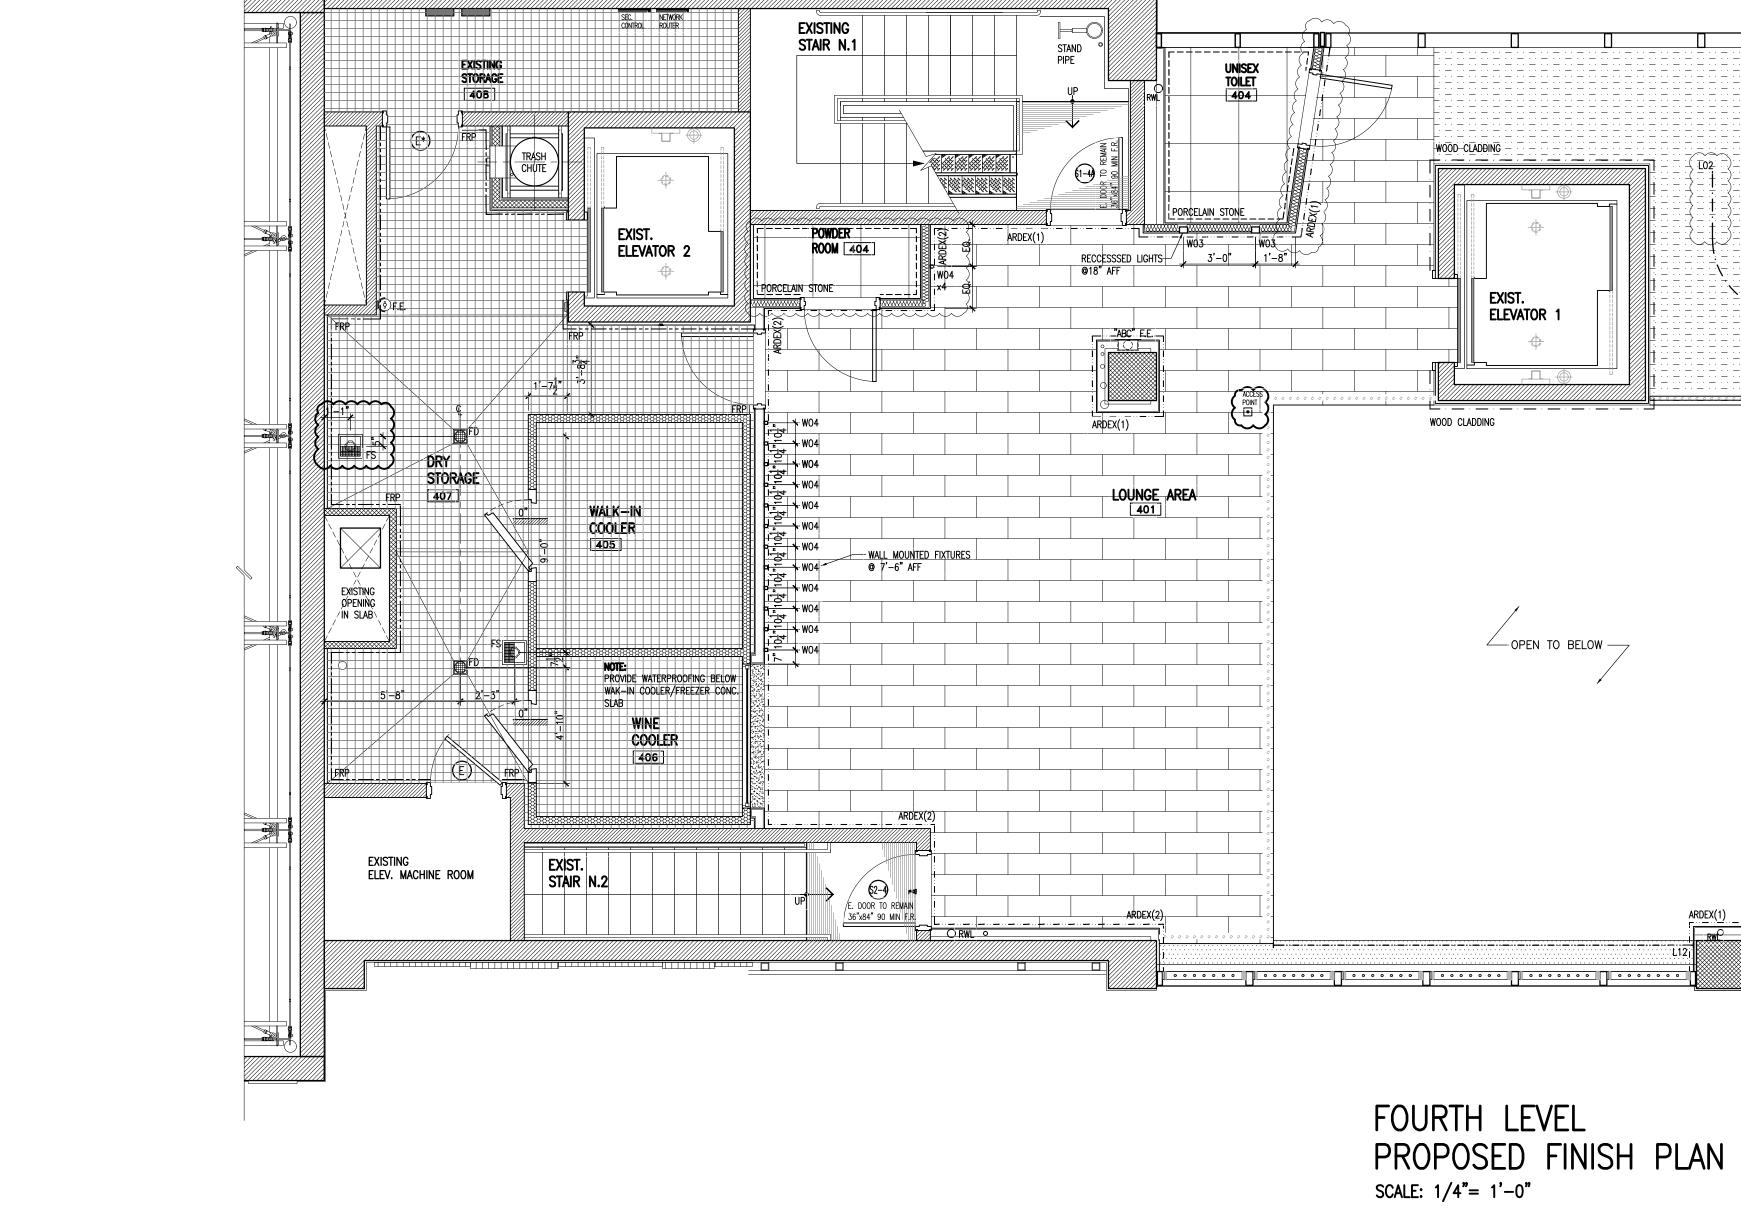(\$7) W/ CONE WOOFER **SECOND FLOOR

KEYPAD: REMOTE CONTROL SYSTEM

POWERLITE PRO G5750WU

DOOR CLOSER

ALARM KEYPAD

ACCESS POINT

(M) MICROPHONE

MULTIMEĎIA PŘOJĚCTOR: EPSÓN

DA-LITE AUTOMATIC ELEC. PROJECT. SCREEN

DOME SURVEILLANCE VANDAL PROOF DOME CAMERA: ICR-300H3B/ICR-300H3W SONY

-NETWORK ROUTER
-SECURITY CONTROL

**RACK @ LEVEL 4-OFFICE 16 GA GANGABLE ENCLOSURE 5-37MIDDLE ATLANTIC PRODUCTS, INC:*KLR-2000 TWO

LEGEND EXISTING MASONRY WALL NON RATED PARTITION 2HR. RATED PARTITION NON RATED PARTITION

> W/SOUND INSULATION PARTITION TO BE REMOVED

EXIST. CONCRETE COL. ① DOOR NUMBER [100] ROOM NUMBER PARTITION TYPE

SECTION MARK ELECTRICAL PANEL FIRE EXTINGUISHER FLOOR SINK FLOOR DRAIN

CHANNEL AMPLIFIER, *PROTEA NE24.24 M MATRIX

AD-C42T: CEILING MOUNT LOUDSPEAKER SYS.

TOILET:CONTROL 24C/CT MICRO (LOW PROFILE)

RELOCATED ON NEW WALL WOOD CLADDING FINISH ISSUED FOR PERMIT 2-18-2013

08-06-13 OWNER REV: LIGHTING, SOUND & SECURITY SYSTEM

/1\ 04-30-13 CITY COMMENTS: RECONFIGURATION TOILET WALL

06-14-13 CITY COMMENTS: NEW POWDER ROOM

EXISTING ELEVATOR CALL BUTTONS TO BE

ISSUED FOR BIDDING ____ ISSUED FOR CONSTRUCTION

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NEW RESTAURANT FOR:

CHI SEAFOOD, LLC

1826 COLLINS AVE.

Miami Beach, Fl. 33139



CHARLES H. BENSON & ASSOCIATES ARCHITECTS, P.A. architect planner interiors

1665 WASHINGTON AVE. 2nd. FLOOR MIAMI BEACH, FLORIDA 33139 Ph: 305-532-6161 * Fax: 305-532-6151 ARCHITECTURE LICENCE # AR14022 NCARB CERTIFICATE # 42,136

DRAWN BY Lilian R. Paez C.

SCALE

AS SHOWN


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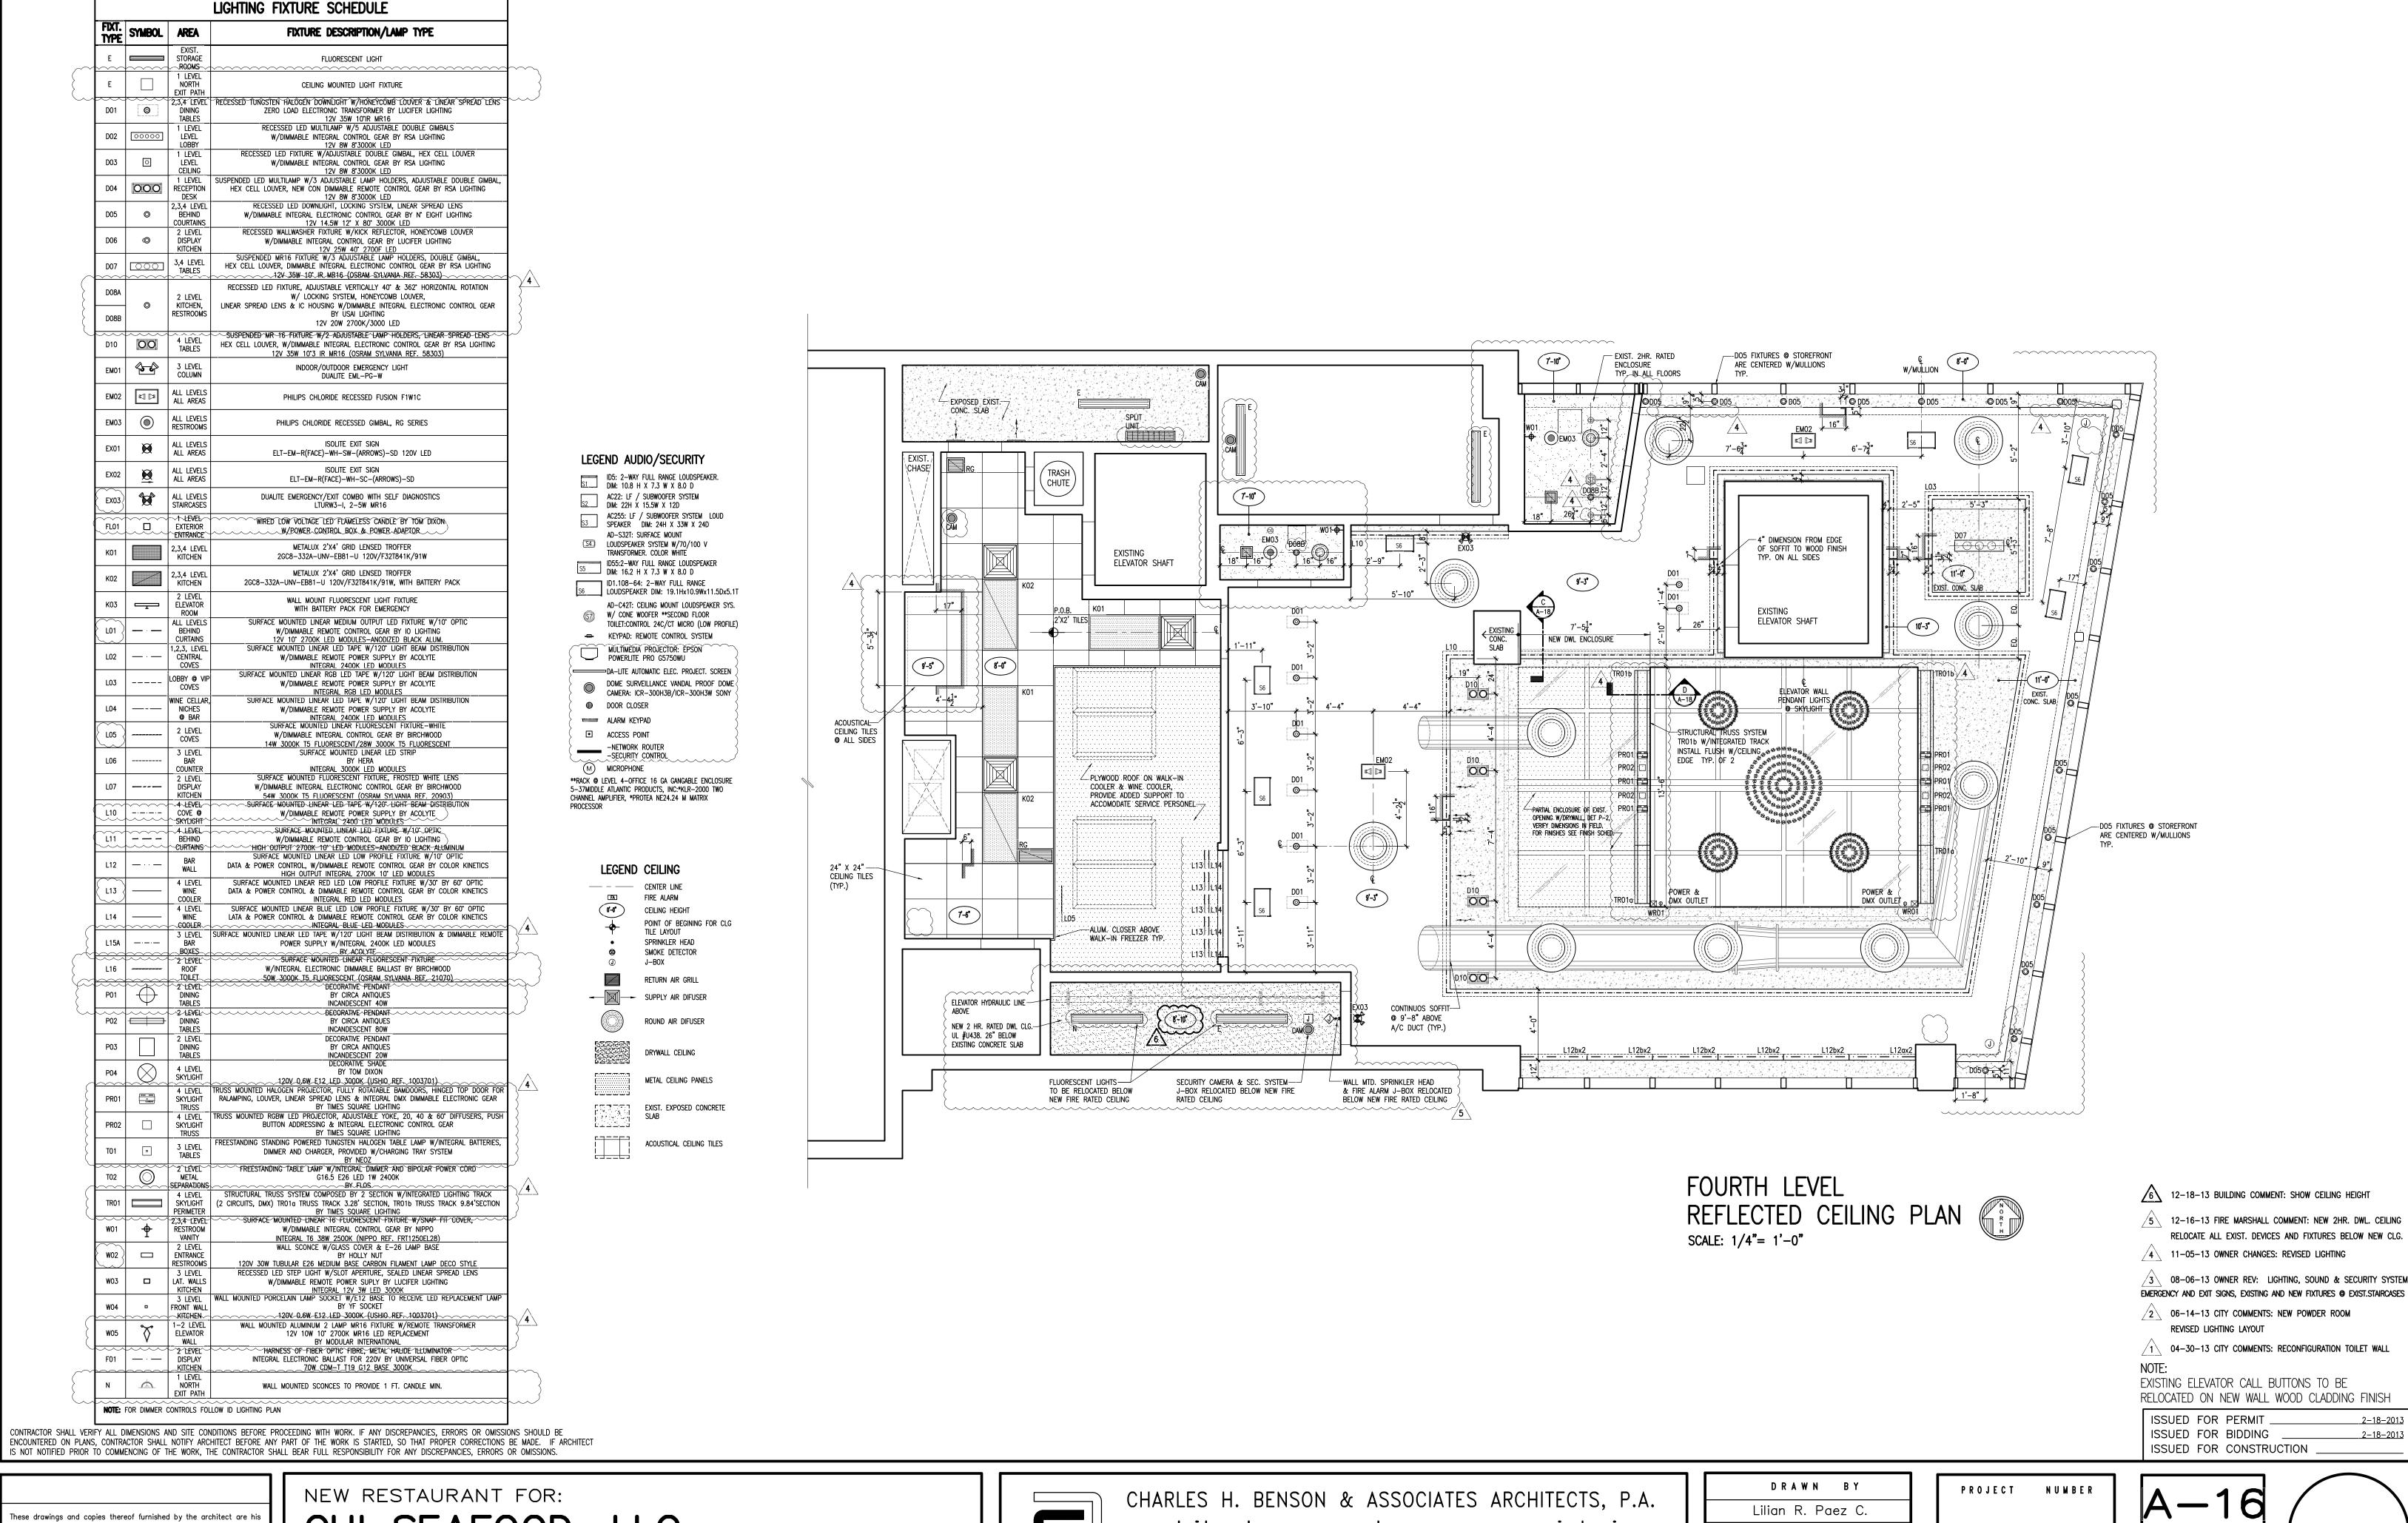
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ELEVATOR

∠OPEN TO BELOW —

PROJECT NUMBER



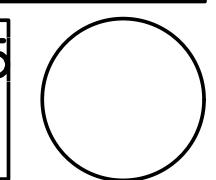

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CHI SEAFOOD, LLC

1826 COLLINS AVE.

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architect planner interiors


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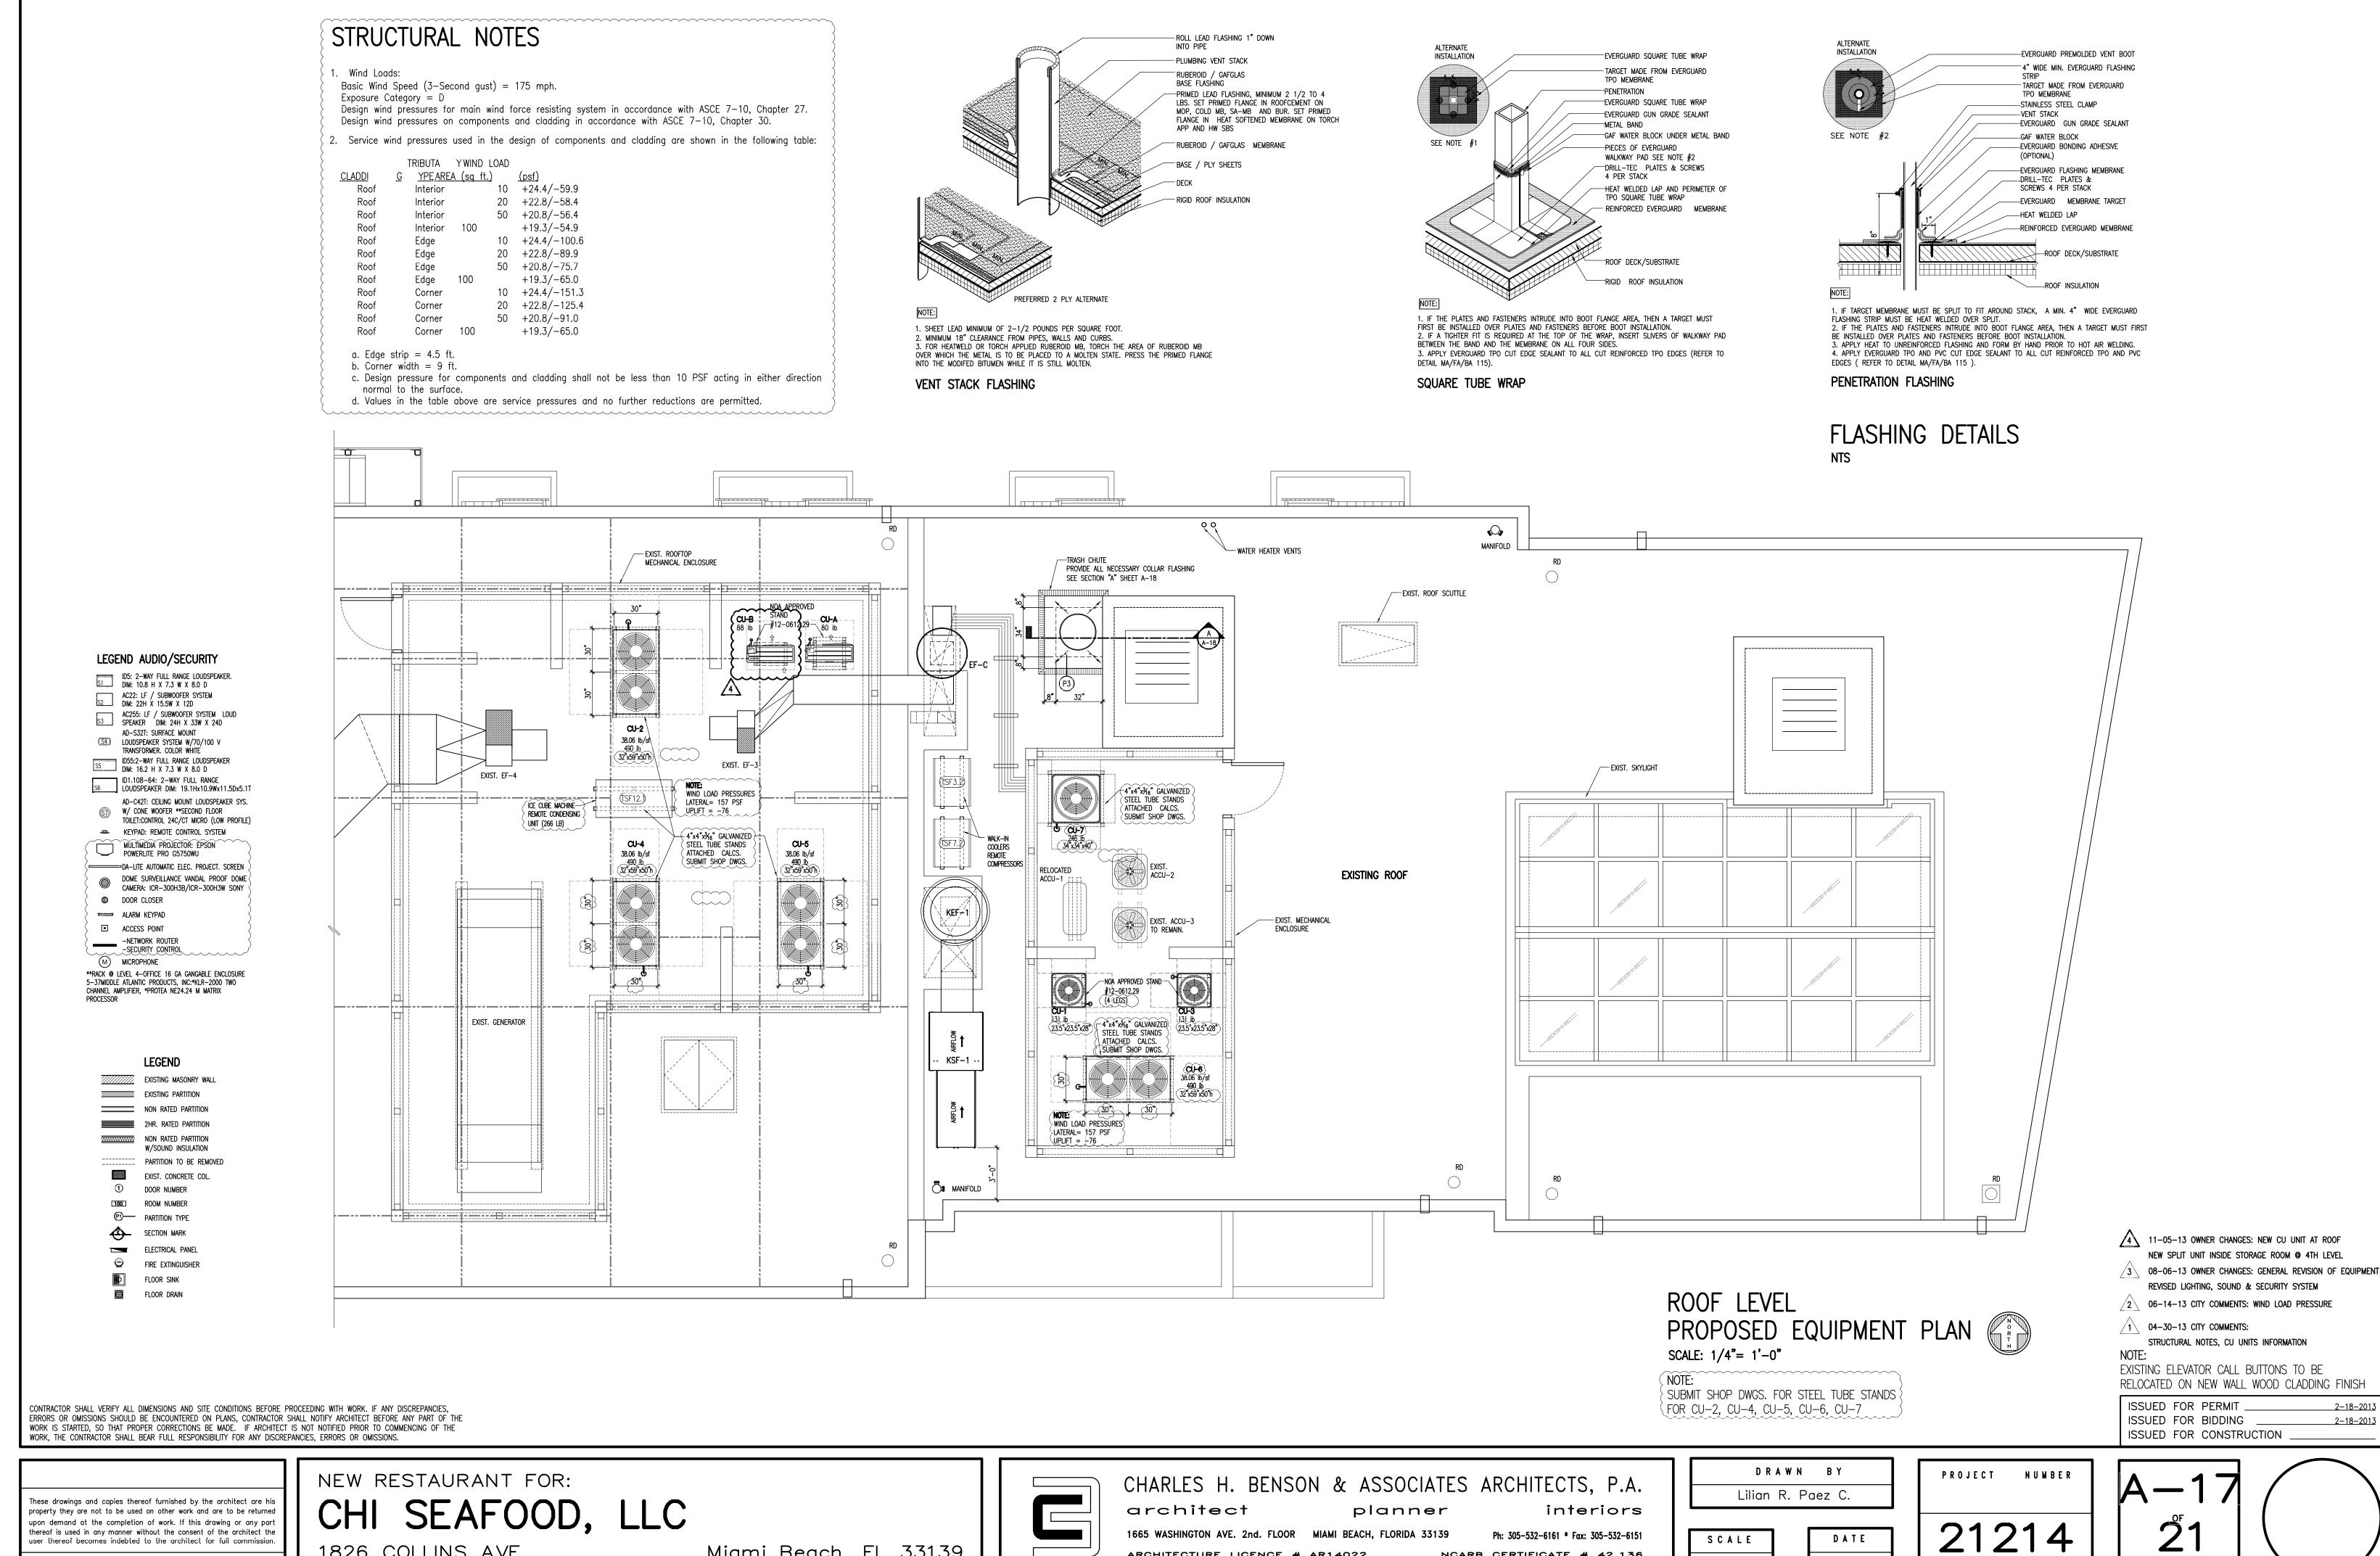
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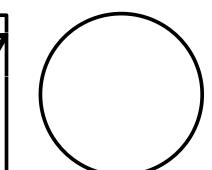
Miami Beach, Fl. 33139




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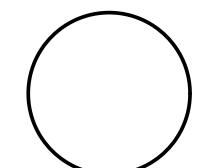



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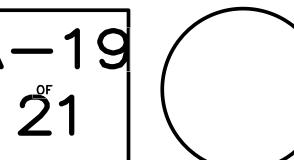
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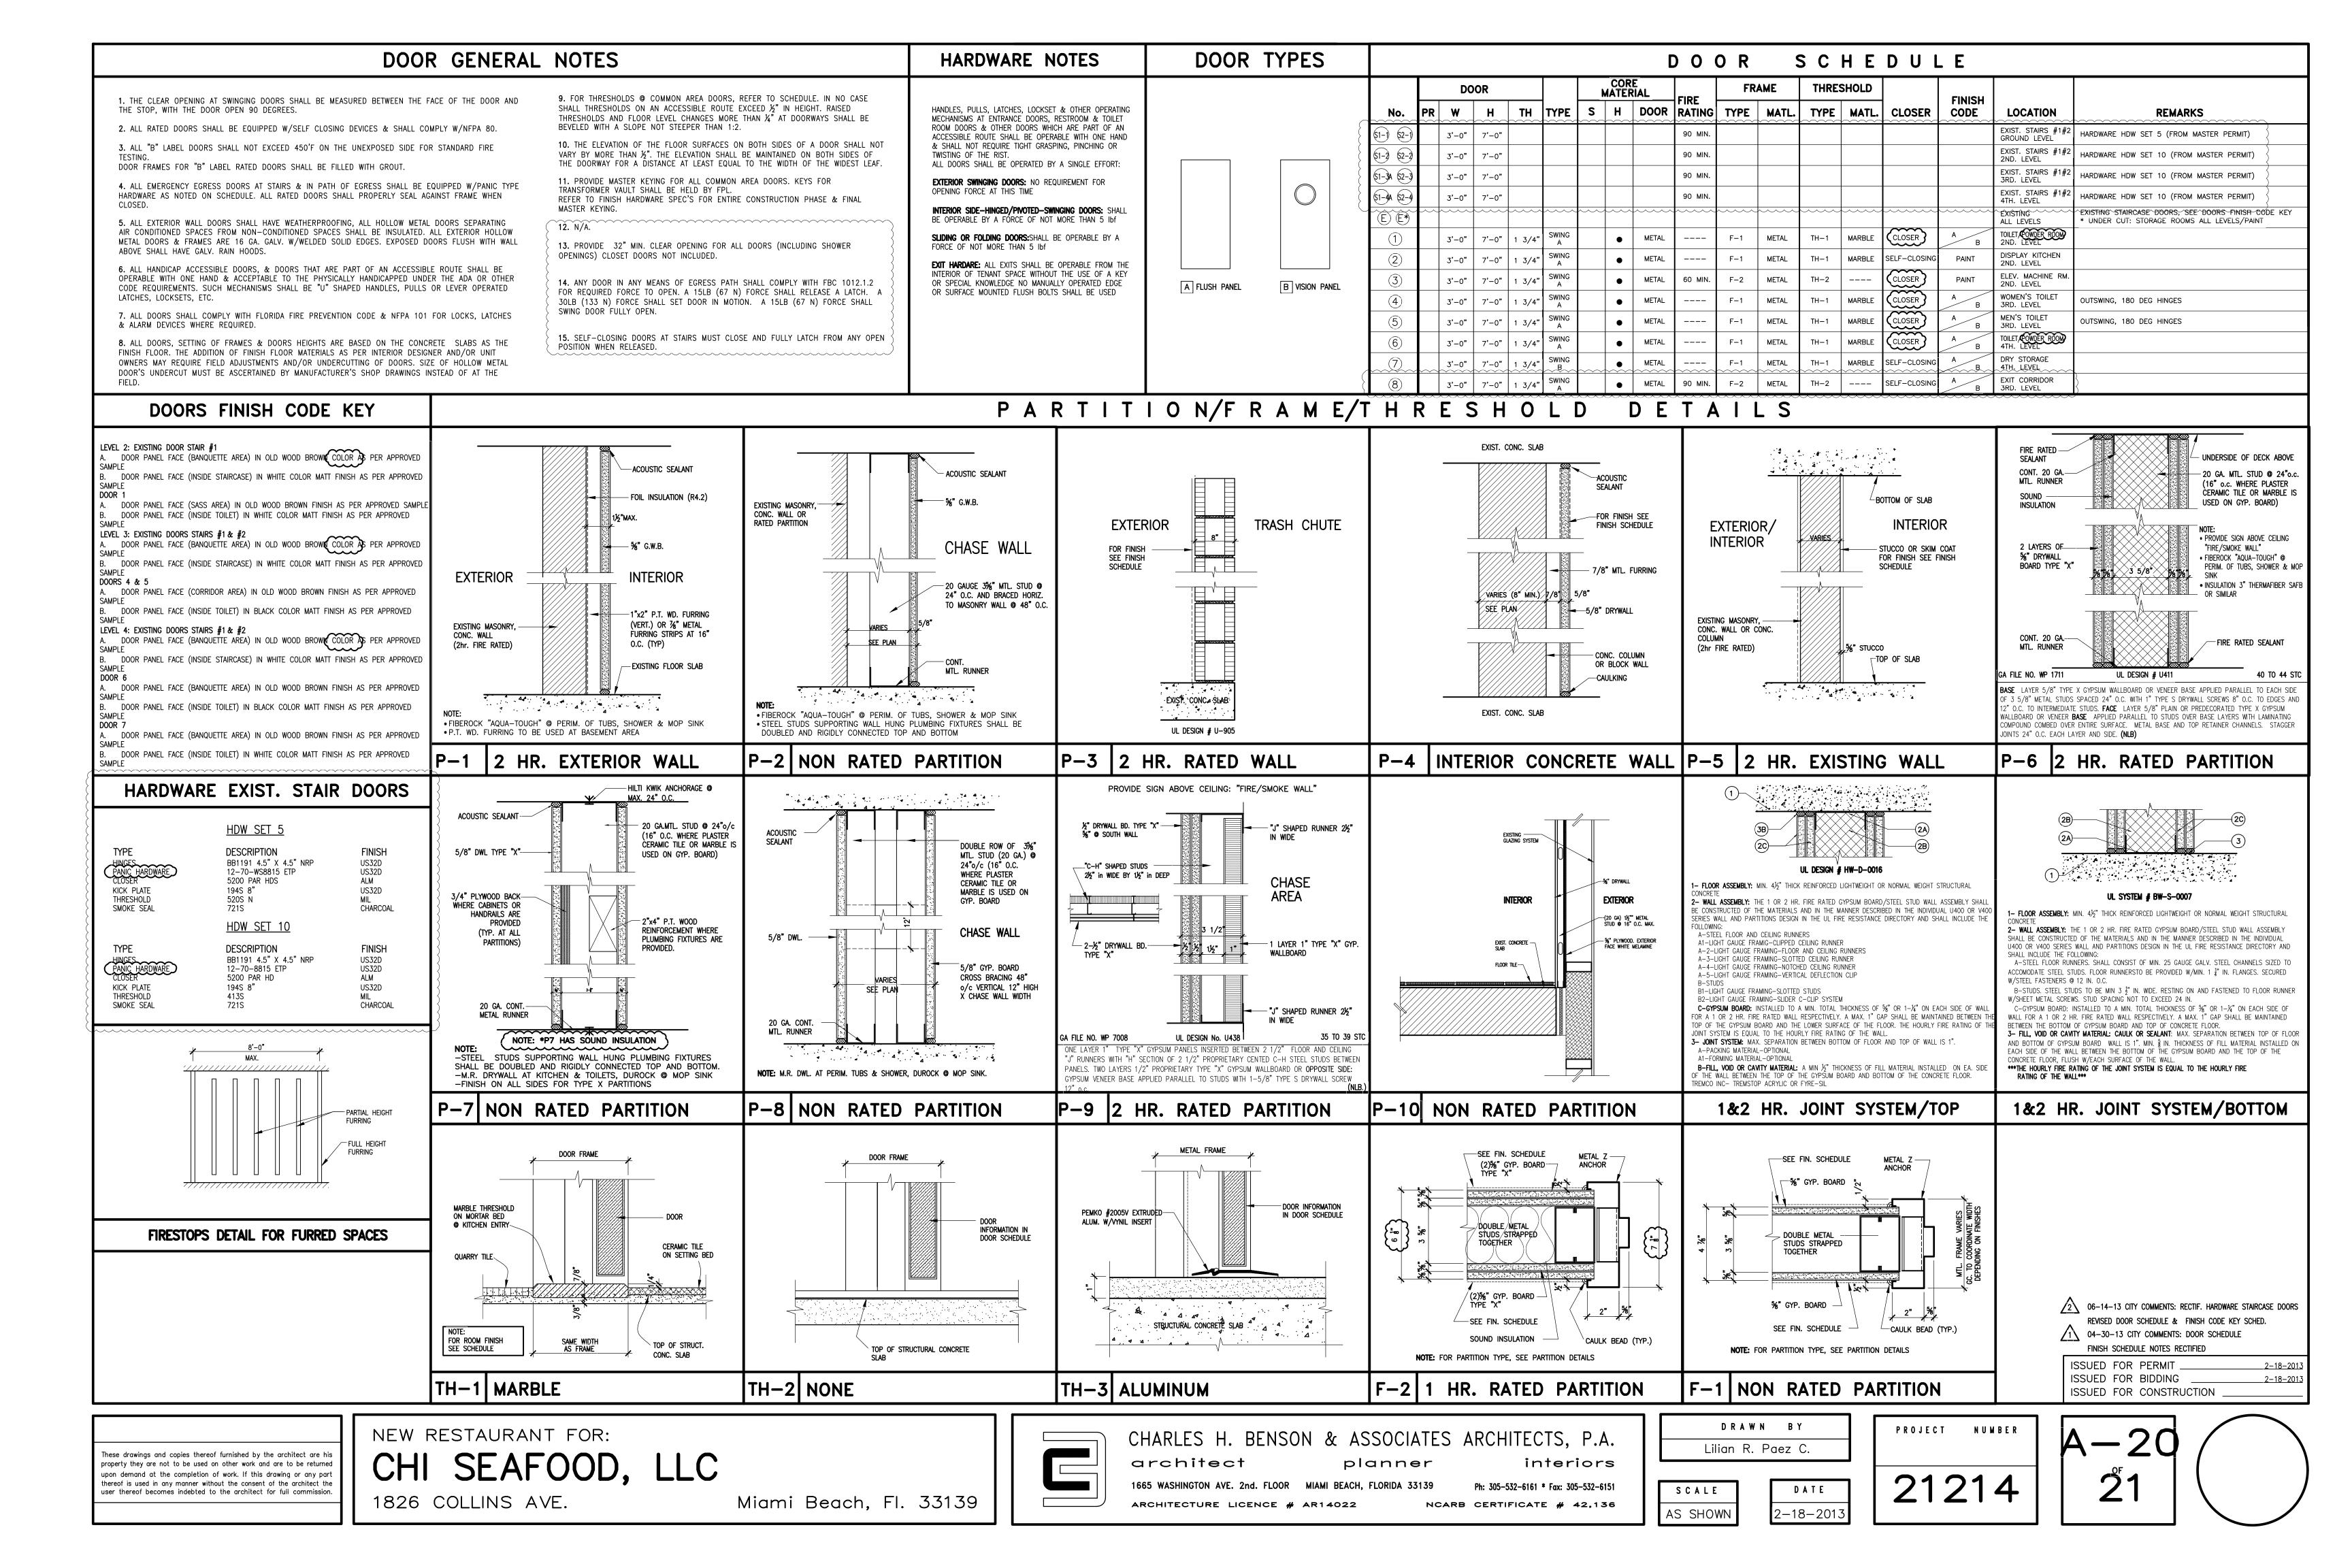
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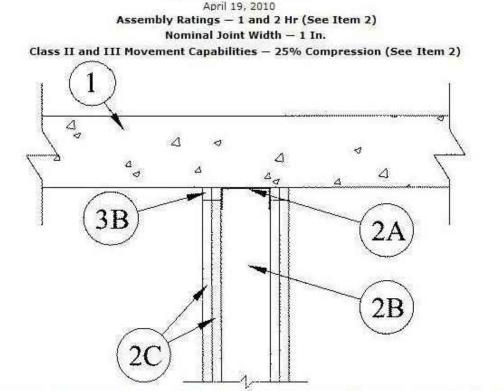
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System No. HW-D-0016

1. Floor Assembly - Min 4-1/2 in. (114 mm) thick reinforced lightweight or normal weight (100-150 pcf (1600-2400 kg/m3)) structural concrete.

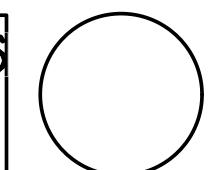2. Wall Assembly - The 1 or 2 h fire-rated gypsum board/steel stud wall assembly shall be constructed of the materials and in the manner described in the individual U400 or V400 Series Wall and Partition Designs in the UL Fire Resistance Directory and shall include the following construction features: A. Steel Floor and Ceiling Runners — Floor runners of wall assembly shall consist of galv steel channels sized to accommodate steel studs (Item 2B). Ceiling runners of wall assembly shall consist of min No. 26 gauge galv steel channels sized to accommodate steel studs (Item 2B). Ceiling runners to be provided with 2 in. (51

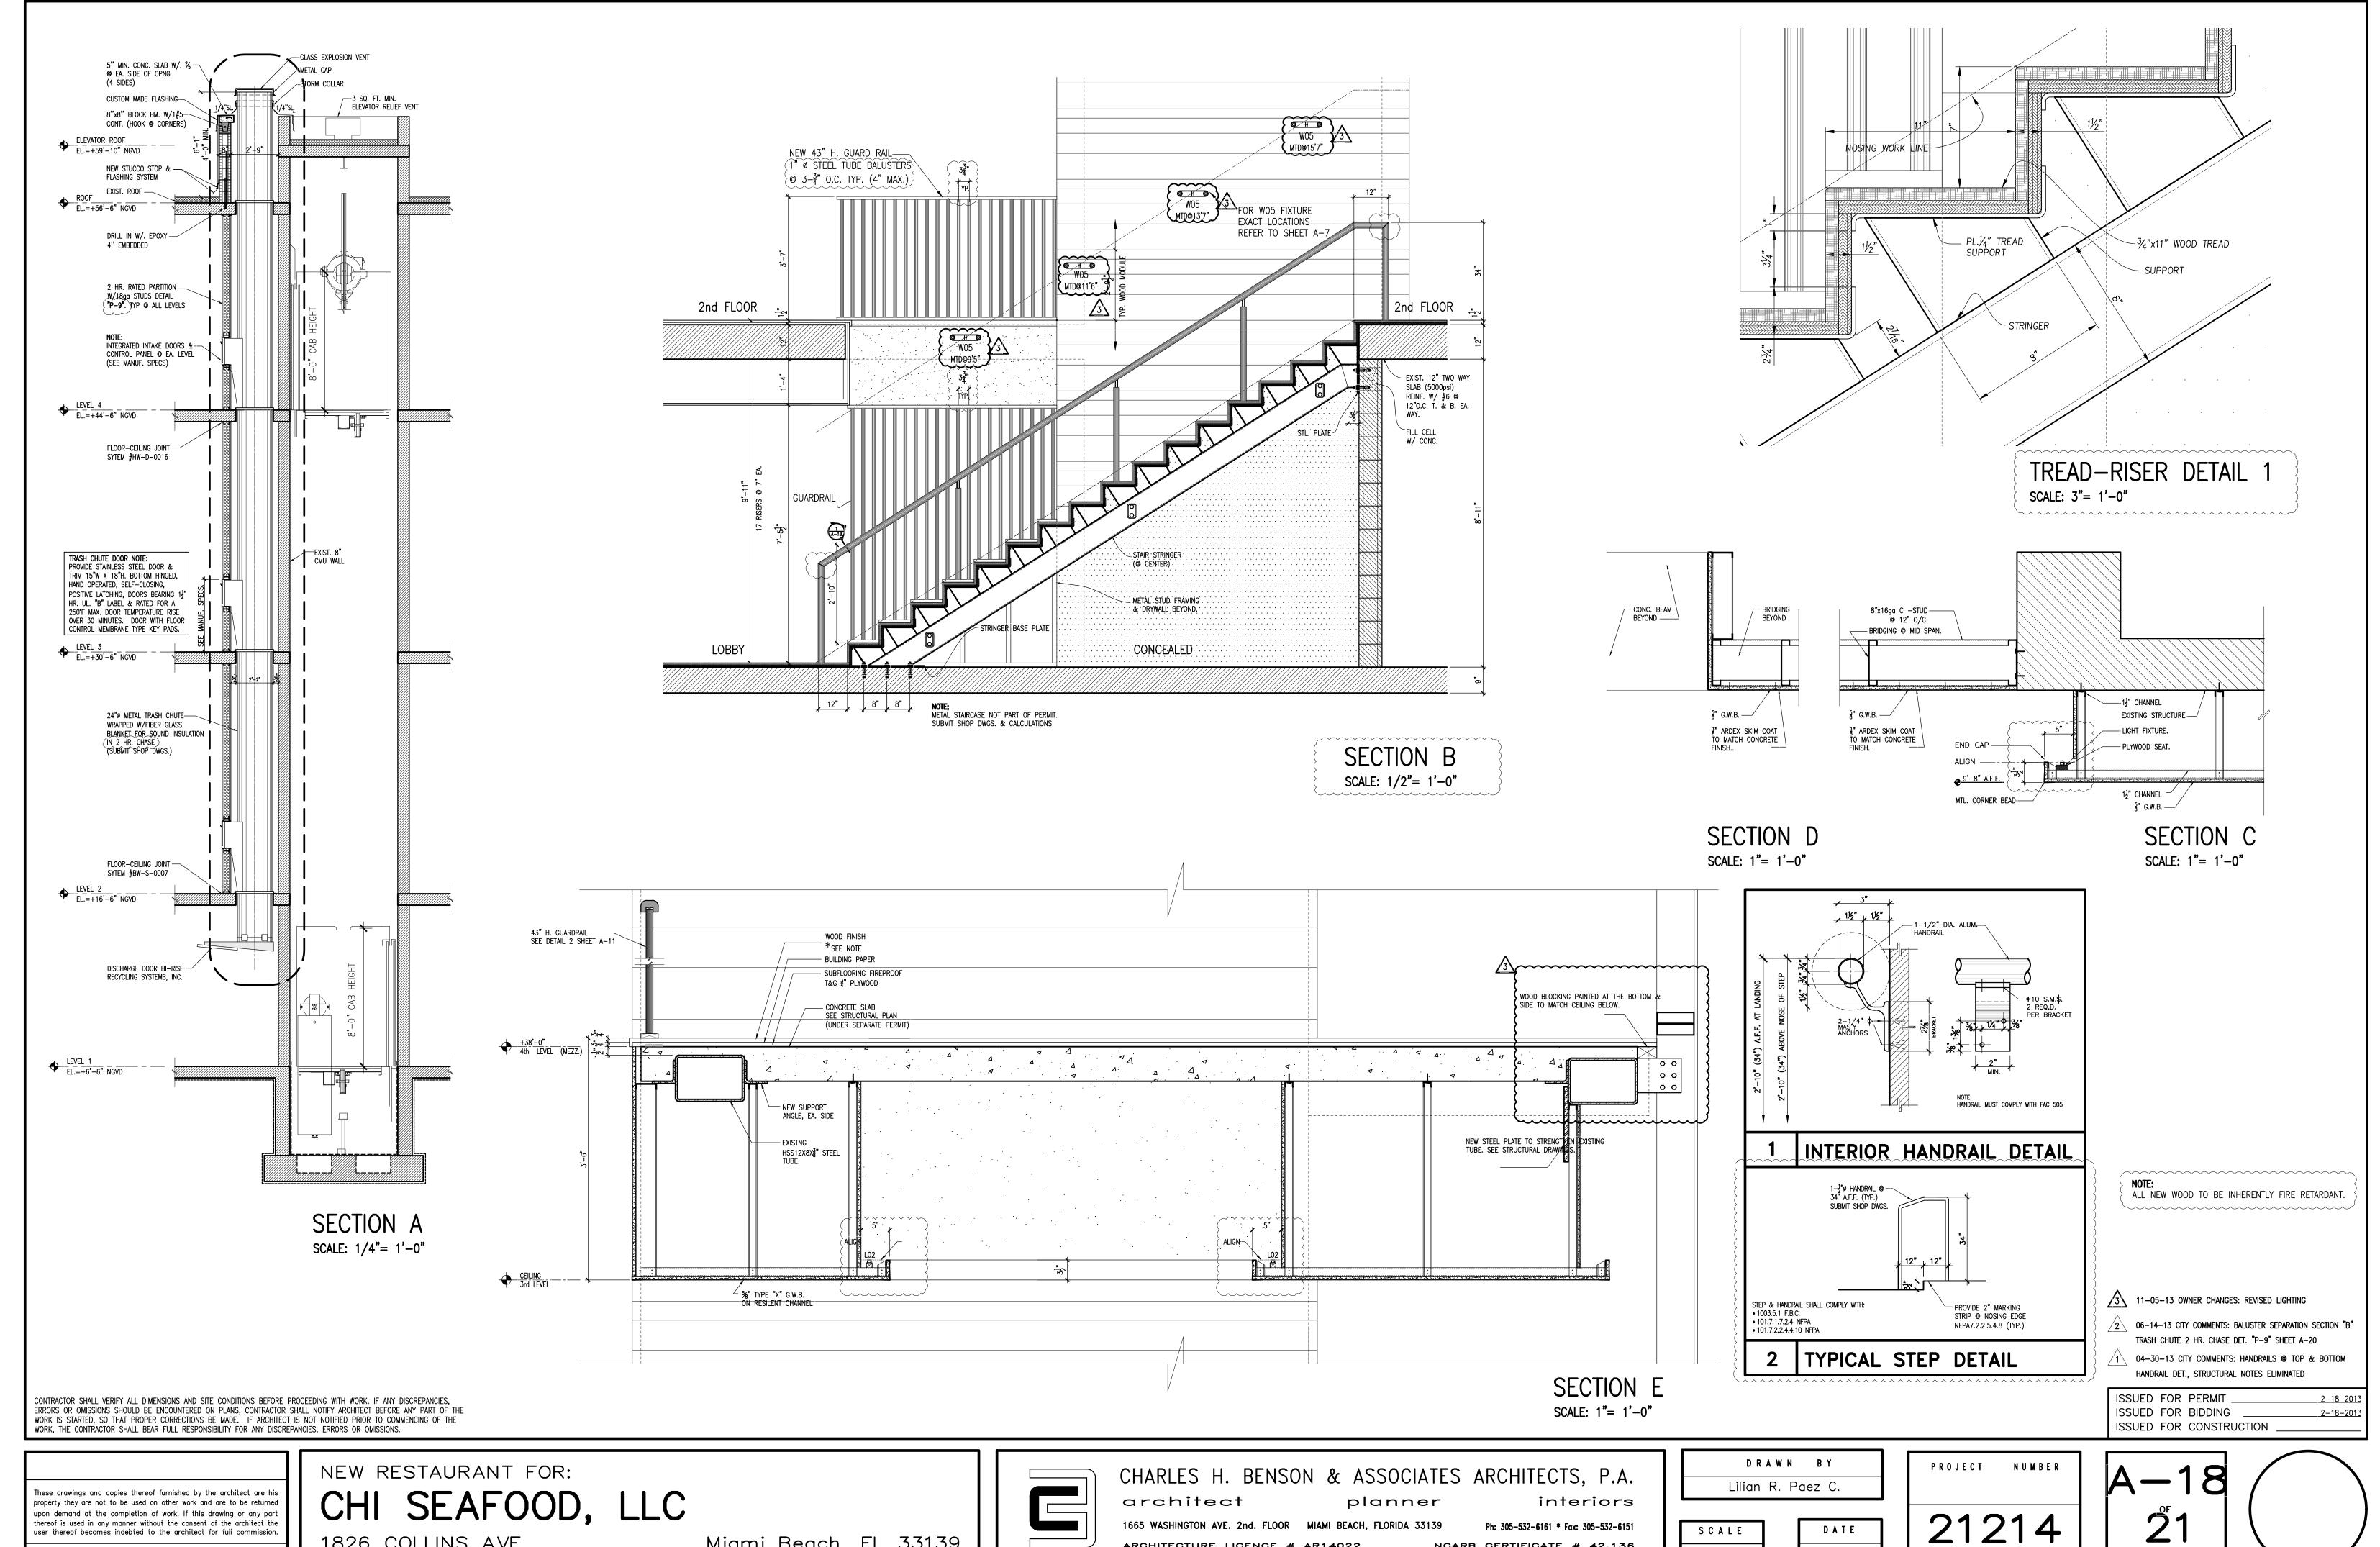mm) flanges. Ceiling runner secured to lower surface of floor with steel fasteners

A1. Light Gauge Framing* — Clipped Ceiling Runner — As an alternate to the ceiling runner in Item 2A, clipped runner to consist of galv steel channel with clips preformed in track flanges which positively engage the inside flange of the steel studs (Item 2B). Track sized to accommodate steel studs (Item 2B). Track flanges to be mir 2-1/2 in. (64 mm). Clipped ceiling runner installed to concrete floor (Item 1) with steel

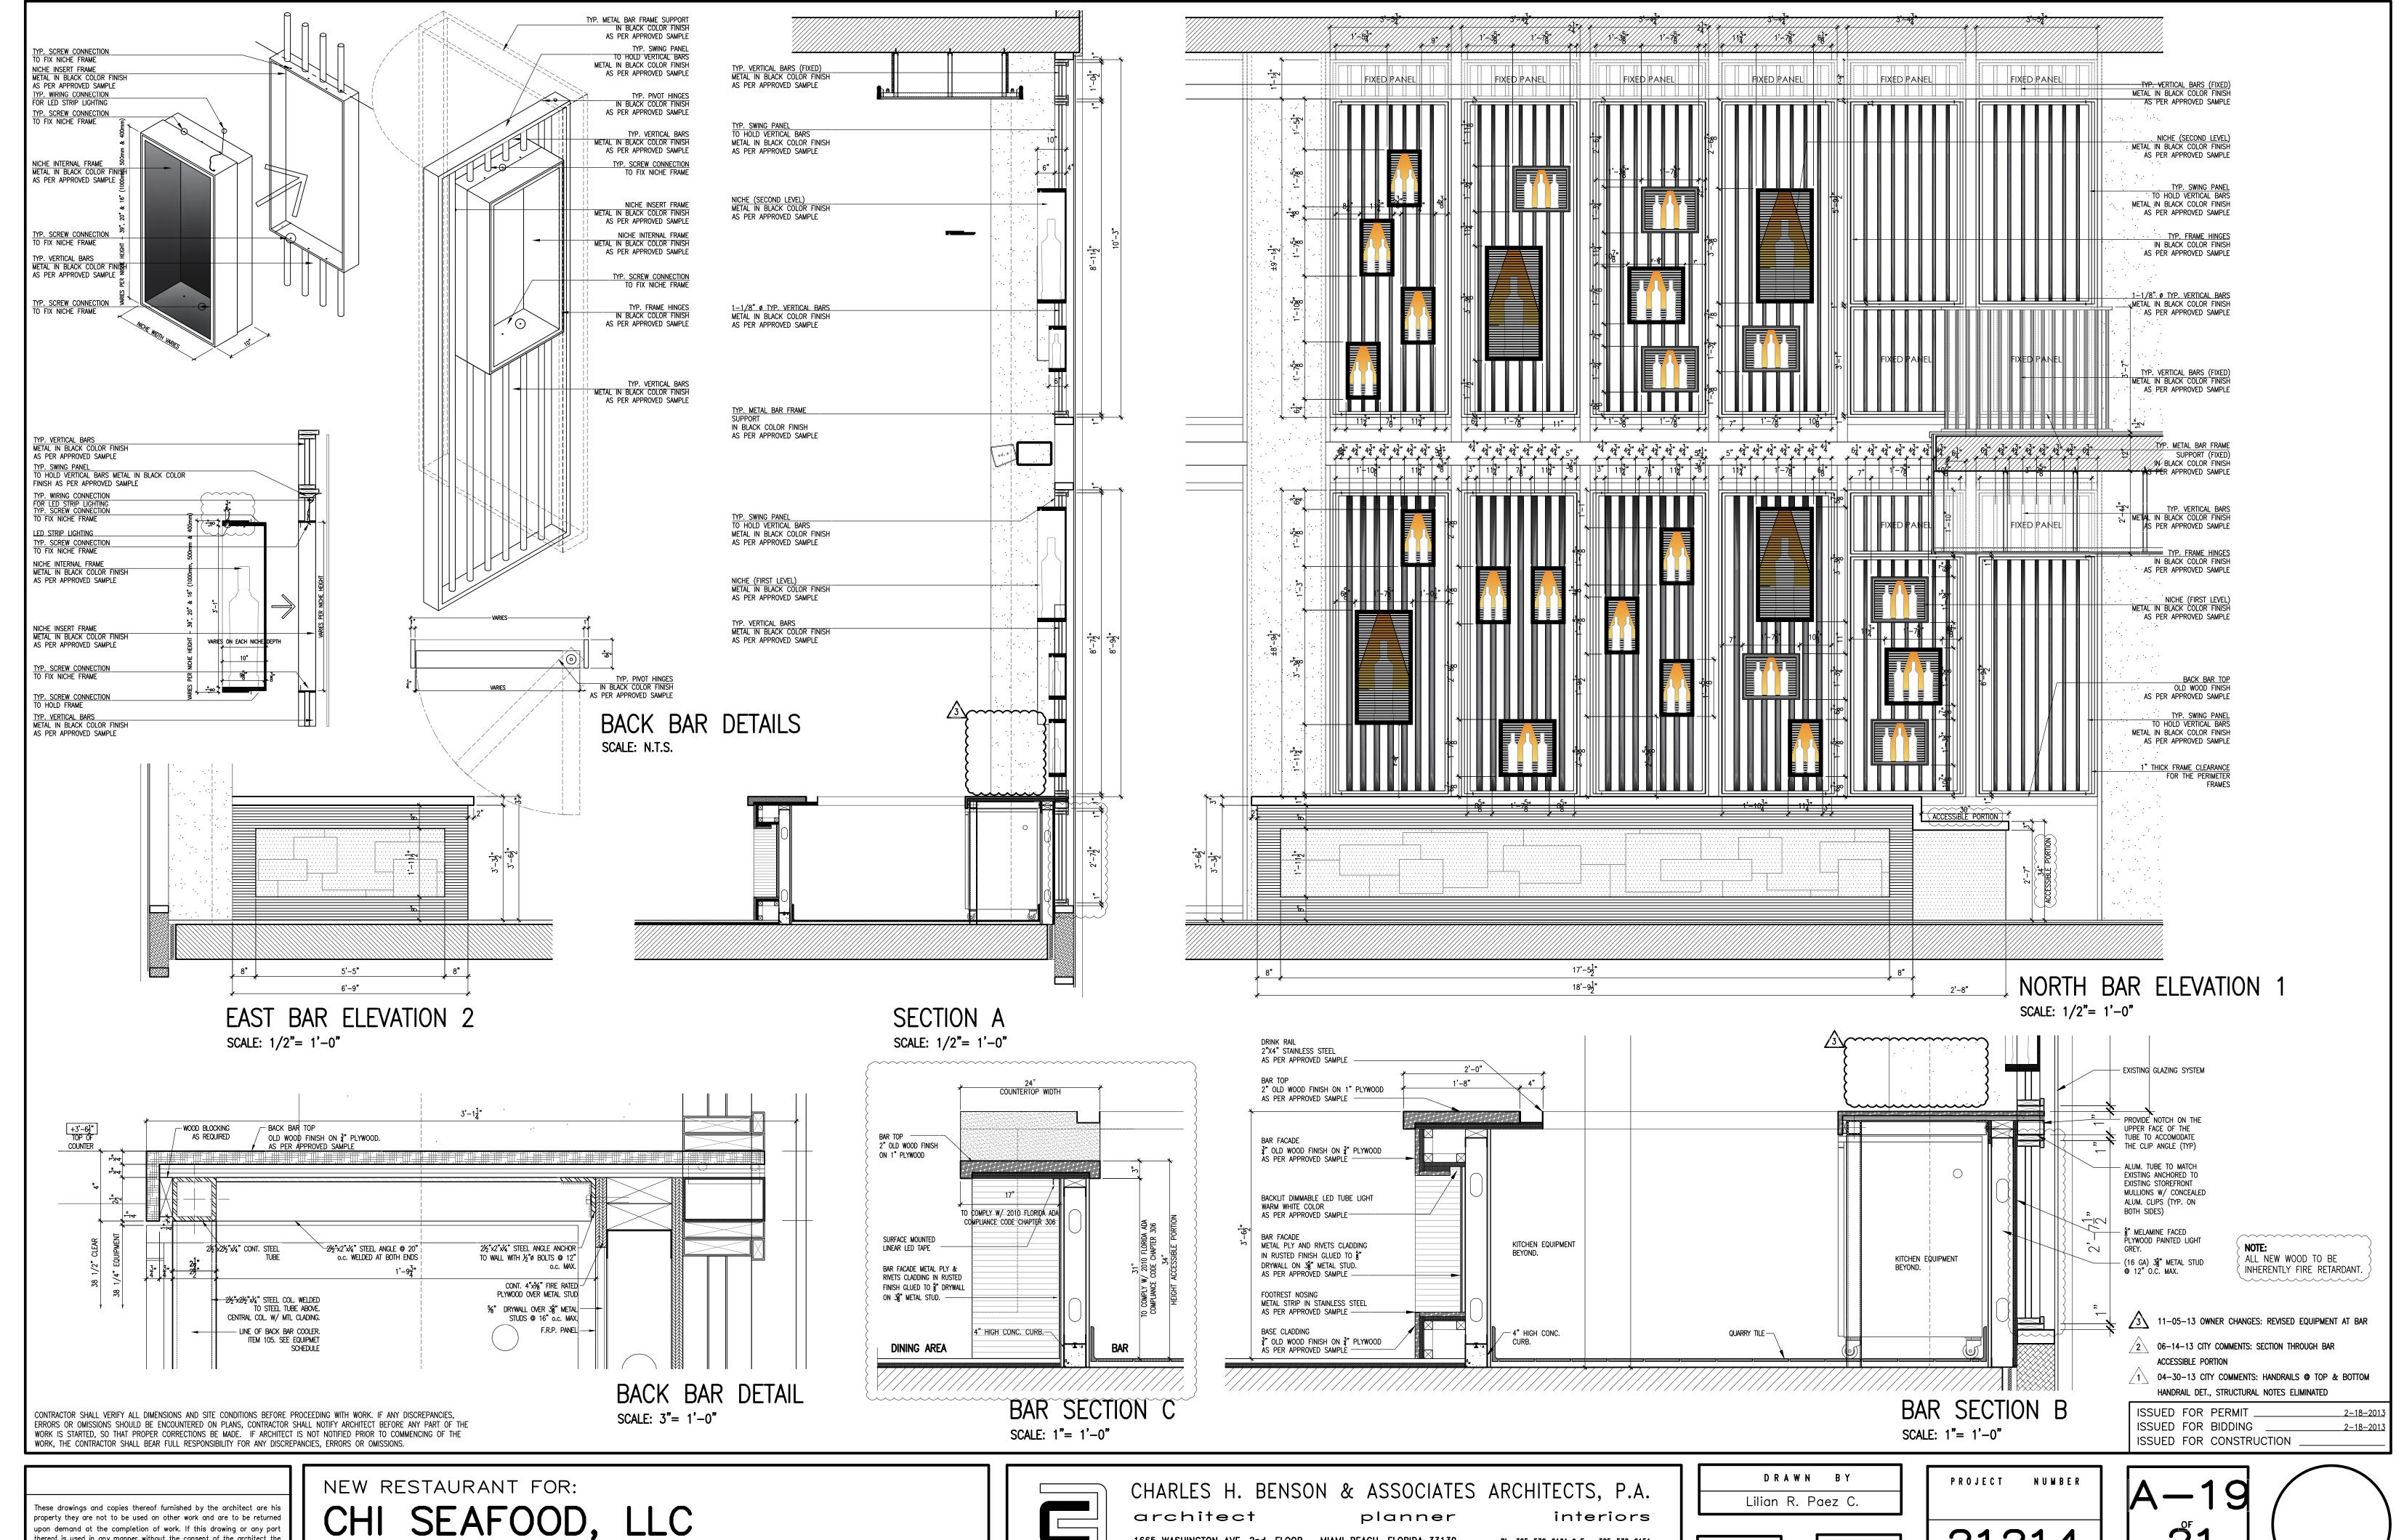fasteners spaced max 24 in. (610 mm) OC. TOTAL STEEL SOLUTIONS L L C - Snap Trak A2. Light Gauge Framing —Floor and Ceiling Runners — As an alternate to the ceiling and floor runners in Item 2A and 2A1, floor and ceiling runners to consist of galv steel channel sized to accommodate the Light Gauge Framing* Slotted Stud (Item 2B1) or Light Gauge Framing* Slider C-Clip System (Item 2B2). Floor and ceiling runners to be provided with min 1-1/4 in. (32 mm) and 3 in. (76 mm) flanges,

respectively. Ceiling runner secured to lower surface of floor with steel fasteners

spaced max 12 in. (305 mm) OC.

STEELER INC — Floor and Ceiling Runners A3. Light Gauge Framing* - Slotted Ceiling Runner — As an alternate to the ceiling runner in Items 2A, 2A1 and 2A2, slotted ceiling runner to consist of galv steel channel with slotted flanges sized to accommodate steel stude (Item 2B). Ceiling runner secured to concrete floor with steel fasteners spaced max 24 in. (610 mm) OC. SCAFCO STEEL STUD MANUFACTURING CO, DBA SLIPTRACK SYSTEMS - SLP-TRK BRADY CONSTRUCTION INNOVATIONS INC, STEELER INC - Steeler Slotted Ceiling Runner

TELLING INDUSTRIES L L C — True-Action Deflection Track A4. Light Gauge Framing*- Notched Ceiling Runner — As an alternate to the ceiling runners in Items 2A through 2A3, notched ceiling runners to consist of Cshaped galv steel channel with notched return flanges sized to accommodate steel studs (Item 2B). Notched ceiling runner secured to concrete floor slab with steel masonry anchors spaced max 24 in. (610 mm) OC. When notched ceiling runner is used, deflection channel (Item 3A) shall not be used.

OLMAR SUPPLY INC - Type SCR A5. Light Gauge Framing* -Vertical Deflection Clip - (Optional) Steel clips can be used in conjunction with steel studs (Item 2B) or ceiling runner (Item 2A). Clips installed over the top of studs and inserted within the ceiling runner. Clip shall be secured to the ceiling runner with No. 8 self drilling, self tapping steel fasteners through holes provided within the clip. Clip may be secured to the stud with No. 6 pan head steel screw through holes provided within the clip. As an alternate, the legs of the clip may be installed over the top of the stud without attachment in accordance with manufacturer's installation instructions

FLEX-ABILITY CONCEPTS L L C — Three Legged Dog Deflection Clip B. Studs - Steel studs to be min 2-1/2 in. (64 mm) wide. Studs cut 1 in. (25 mm) less in length than assembly height with bottom nesting in and resting on floor runner and with top nesting in ceiling runner without attachment. When slotted ceiling runner (Item 2A3) is used, steel studs secured to slotted ceiling runner with No. 8 by 1/2 in. (13 mm) long wafer head steel screws at midheight of slot on each side of wall. Stud spacing not to exceed 24 in. (610 mm) OC

B1, Light Gauge Framing* -Slotted Studs - Slotted steel stud to be used in conjunction with Light Gauge Framing* —Floor and Ceiling Runners (Item 2A4). Slotted steel studs to be min 2-1/2 in. (64 mm) wide. Slotted steel studs cut 1 in. (25 mm) less in length than assembly height with bottom nesting in and secured to both ceiling and floor runners. Ceiling runner secured to preformed slot within steel stud by means of No. 10 by 3/4 in. (19 mm) long low profile head steel screw. Floor runner attached to bottom of steel stud by means of No. 8 by 1/2 in. (13 mm) long pan head steel screw. Slotted steel stud spacing not to exceed 24 in. (610 mm) OC

STEELER INC - Slotted Stud B2. Light Gauge Framing* —Slider C-Clip System — As an alternate to the Light Gauge Framing* —Slotted Steel Studs (Item 2B1), a Slider C-Clip System consisting of a C shaped steel clip with a slotted opening and a steel stud to be used in conjunction with Light Gauge Framing —Floor and Ceiling Runners (Item 2A2). Steel clips and studs to be min 2-1/2 in. (64 mm) wide. Steel clip inserted into inside lange of steel stud without attachment. Total length of steel stud cut 1 in. (25 mm) less than assembly height with bottom of steel stud nesting in and secured to floor runner. Floor runner attached to bottom of steel stud by means of No. 8 by 1/2 in. (13 mm) long pan head steel screw. Ceiling runner secured to steel C-Clip by means of No. 10 by 3/4 in. (19 mm) long pan head steel screw located 3/8 in. (10 mm) below top of ceiling runner. Top row of gypsum board screws shall be centered within the preformed slot of the C-Clip. Steel stud and steel clips spacing not to exceed 24 in (610 mm) OC. STEELER INC - Slider C Clip System C. Gypsum Board* — Gypsum board sheets installed to a min total thickness of 5/8 or 1-1/4 in. (16 or 32 mm) on each side of wall for a 1 or 2 h fire rated wall,

respectively. Wall to be constructed as specified in the individual Wall and Partition Design in the UL Fire Resistance Directory, except that a max 1 in. (25 mm) gap shall be maintained between the top of the gypsum board and the lower surface of the floor. The top row of screws shall be installed into the stude 4 in. (102 mm) below the lower surface of the floor. The hourly fire rating of the joint system is equal to the hourly fire rating of the wall.

The hourly fire rating of the joint system is equal to the hourly fire rating of the wall. The movement capability of the joint system is Class II and III except that when the vertical deflection clip (Item 2A5) is used, the movement capability is Class II only. 3. Joint System — Max separation between bottom of floor and top of wall (at time of

installation of joint system) is 1 in. (25 mm). The joint system is designed to accommodate a max 25 percent compression from its installed width. The joint system consists of a packing or forming material and a fill material between the top of the wallboard and the bottom of the floor, as A. Packing Material - (Optional, Not Shown)-For 2 h rated systems, two layers of nom 7/8 in. (22 mm) diam polyurethane backer rod friction-fitted on top of each other into the gap between the top of the gypsum board and the bottom of the concrete floor on both sides of the wall and recessed from each surface of wall to

accommodate the required thickness of fill material. A1. Forming Material* - (Optional, Not Shown)-For 2 h rated systems, min 3/4 in. (19 mm) width of 4 pcf (64 kg/m³) mineral wool batt insulation compressed 50 percent in thickness and packed into the gap between the top of the gypsum board and bottom of the floor on both sides of the wall.

FIBREX INSULATIONS INC - FBX Safing Insulation, ROXUL ASIA SDN BHD - Type Safe IIG MINWOOL L L C — MinWool-1200 Safing, THERMAFIBER INC — Type SAF ROCK WOOL MANUFACTURING CO - Delta Board or Delta-8, ROXUL INC - Type Safe B. Fill, Void or Cavity Material* — A min 1/2 in. (13 mm) thickness of fill material installed on each side of the wall between the top of the gypsum board and bottom of the concrete floor. As an option for 1 hr systems and in 2 hr systems where packing material (Item 3A) or forming material (Item 3B) are not used, bond breaker tape may be applied to ceiling runner on each side of wall .

TREMCO INC - TREMstop Acrylic or Fyre-Sil *Bearing the UL Classification Mark

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Last Updated on 2010-04-19

Design No. U438 Nonbearing Wall Rating - 2 HR. CEILING

1. Floor and Ceiling Runners - "J" -shaped runner, 2-1/2 in. wide with unequal legs of 1 in. and 2 in., fabricated from 24 MSG galv steel. Runners positioned with short leg toward finished side of wall. Runners attached to structural supports with steel fasteners located not greater than 2 in. from ends and not greater than 24 in. OC.

 Steel Studs — "C-H" -shaped studs, 2-1/2 in. wide by 1-1/2 in. deep, fabricated from 25 MSG galv steel. Cut to lengths 3/8 to 1/2 in. less than floor to ceiling height and spaced 24 in. or 600 mm OC. Steel Studs — (Not shown)-"E" -shaped studs installed in place of "C-H" -shaped studs (Item 2) to secure the closure liner panels at the ends of walls. Fabricated from 25 MSG galv steel, 2-1/2 in. wide, with one leg 1 in. long and two legs 3/4 in. long. Shorter legs 1 in. apart to engage gypsum liner panels. Cut to lengths 3/8 in. less than floor to ceiling height. Sill and lintel of opening formed with "J" -shaped runners (Item 1) secured to "E" -shaped studs with angle clips and steel

. Gypsum Board* — 1 in. thick gypsum wallboard liner panels, supplied in nom 24 in. or 600 mm (for metric spacing) widths. Panels cut 1 in. less in length than floor to ceiling height. Vertical edges inserted in "H" -shaped section of "C-H" studs. Free edge of end panels attached to long leg of "J" -runners with 1-5/8 in. long Type S steel screws spaced not greater than 12 in. OC.

CANADIAN GYPSUM COMPANY -Type SLX. UNITED STATES GYPSUM CO -Type SLX. USG MEXICO S A DE C V , DF-Type SLX.

. Gypsum Board* — 1/2 in. thick, 4 ft. or 1200 mm (for metric spacing) wide wallboard applied vertically in two layers. Inner or base layer attached to studs with 1 in. long Type S steel screws spaced 24 in. OC along the edges and in the field of the boards. Outer or face layer attached to studs and "J" -runners with 1-5/8 in. long Type S steel screws spaced 12 in. along the edges and in the field of the boards, staggered from screws in inner layer. Joints between inner and outer

Outer layer joints covered with paper tape and joint compound. Exposed screw heads covered with joint compound As an alternate method, inner wallboard layer applied vertically, outer wallboard layer applied horizontally. Inner layer attached to study with 1 in. Type S steel screws spaced 24 in. OC along vertical edges and in the field. Outer layer attached to the studs and "J" runners over the inner layer with 1-5/8 in. long Type S steel screws spaced 12 in. OC in the field, along the vertical edges and to the floor and ceiling runners. Outer layer secured to inner layer wallboard with 1-1/2 in. long Type G steel screws

located midway between studs and 1 in. from the horizontal joint. AMERICAN GYPSUM CO -Types AG-C . BPB AMERICA INC —Type FRPC, ProRoc Type C. BPB CANADA INC — ProRoc Type C.

CANADIAN GYPSUM COMPANY -Type C, IP-X2, or WRC. G-P GYPSUM CORP, SUB OF GEORGIA-PACIFIC CORP —Type 5.

LAFARGE NORTH AMERICA INC -Types LGFC-C, LGFC-NATIONAL GYPSUM CO - Types FSK-C, FSW-C, FSMR-C.

PABCO GYPSUM, DIV OF PACIFIC COAST BUILDING PRODUCTS INC -Types PG-C. STANDARD GYPSUM L L C -Type SG-C. TEMPLE-INLAND FOREST PRODUCTS CORP -- Type TG-C. UNITED STATES GYPSUM CO -Type C. IP-X2 or WRC

USG MEXICO S A DE C V, DF-Type C, IP-X2 or WRC. 4A. Gypsum Board* - (As an alternate to Item 4) - 5/8 in. thick, 4 ft wide. Attached as described in Item 4.

CANADIAN GYFSUM COMPANY -Type AR, IP-AR, IP-X1, UNITED STATES GYPSUM CO -Type AR, FRX-G, IP-AR,

IP-X1, SCX or WRX. USG MEXICO S A DE C V , DF—Type AR, IP-AR, IP-X1, SCX

5 Batts and Blankets* — (Optional) — (Not shown) — Mineral wool or glass fiber batts partially or completely filling stud cavity. Any mineral wool or glass fiber batt material bearing the UL Classification Marking as to Fire Resistance.


A. Fiber, Sprayed* — As an alternate to Batts and Blankets (Item 5) — Spray applied cellulose material. The fiber is applied with water to completely fill the enclosed cavity in accordance with the application instructions supplied with the product. Nominal dry density of 3.0 lb/ft3. Alternate application method: The fiber is applied with U.S. Greenfiber LLC Type AD100 hot melt adhesive at a nominal ratio of one part adhesive to 6.6 parts fiber to completely fill the enclosed cavity in accordance with the application instructions supplied with the product. Nominal dry density of 2.5 lb/ft3.

U S GREENFIBER L L C - Cocoon2 Stabilized or Cocoon-FRM (Fire Rated Material)

5B. Fiber, Sprayed* — As an alternate to Batts and Blankets (Item 5) and Item 5A - Spray applied cellulose insulation material. The fiber is applied with water to interior surfaces in accordance with the application instructions supplied with the product. Applied to completely fill the enclosed cavity. Minimum dry density of 4.3 pounds per cubic ft. NU-WOOL CO INC — Cellulose Insulation

*Bearing the UL Classification Mark

Design No. U411 Nonbearing Wall Rating - 2 HR.

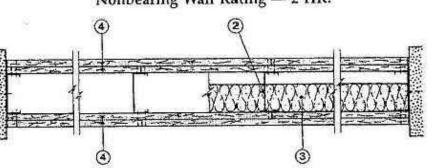

Floor and Ceiling Runner — (Not Shown) — Min. 25 MSG galv steel 1 in. high, return legs 2-1/2 in. wide (min), attached to floor and ceiling with fasteners 24 in. OC.

Steel Studs - Min 2-1/2 in. wide, 1-1/4 in. legs, 3/8 in. return, formed of min 25 MSG galv steel max stud spacing 24 in. OC. Studs to be cut 3/4 in. less than assembly height.

. Batts and Blankets* — (Optional) — Mineral wool or glass fiber batts partially or completely filling stud cavity. Fasten each batt to wallboard base layer with a min 9/16 in. long staple. Use five staples for each 4 ft piece. Drive one staple in the center of each piece and a staple at each corner, approx 3 in. from edges.

See Batts and Blankets (BZJZ) category for names of manufacturers. 3A. Fiber, Sprayed* — As an alternate to Batts and Blankets (Item 3) — Spray applied cellulose material. The fiber is applied with water to completely fill the enclosed cavity in accordance with the application instructions supplied with the product. Nominal dry density of 3.0 lb/ft3. Alternate application method: The fiber is applied with U.S. Greenfiber LLC Type AD100 hot melt adhesive at a nominal ratio of one part adhesive to 6.6 parts fiber to completely fill the enclosed cavity in accordance with the application instructions supplied with the product. Nominal dry density of 2.5 lb/ft3.

U S GREENFIBER L L C - Cocoon2 Stabilized or Cocoon-FRM (Fire Rated Material)

3B. Fiber, Sprayed* — As an alternate to Batts and Blankets (Item 3) and Item 3A - Spray applied cellulose insulation material. The fiber is applied with water to interior surfaces in accordance with the application instructions supplied with the product. Applied to completely fill the enclosed cavity. Minimum dry density of 4.3 pounds per cubic ft.

NU-WOOL CO INC — Cellulose Insulation

4. Gypsum Board* — 5/8 in. thick, outer layer paper or vinyl surfaced. (Laminated System) Wallboard applied vertically in two layers. Inner layer attached to studs with 1 in. long Type S steel screws spaced 8 in. OC along vertical edges, and 12 in. OC in the field and outer layer laminated to inner layer with joint compound, applied with a notched spreader producing continuous beads of compound about 3/8 in. in diameter, spaced not greater than 2 in. OC. Joints of laminated outer layer offset 12 in. from inner layer joints Outer layer wallboard attached to floor and ceiling runner track with 1-5/8 in. long Type S steel screws spaced 12 in. OC.

Optional, (Direct Attached System), Inner layer attached to studs with 1 in. long Type S steel screws spaced 16 in. OC in the field and along the vertical edges. Outer layer attached to the studs over the inner layer with 1-5/8 in. long Type S steel screws spaced 16 in. OC in the field and along

AMERICAN GYPSUM CO — Types AG-C, AGX-1, AGX-11. BEILING NEW BUILDING MÁTERIALS CO LTD — Type

BPB AMERICA INC —Types 1, FRPC, EGRG, ProRoc Type X or BPB CANADA INC — ProRoc Type C, ProRoc Type X or ProRoc

Type Abuse-Resistant. CANADIAN GYPSUM COMPANY —Type AR, C, FCV, IP-AR, IP-X1, IP-X2, IPC-AR, SCX, SHX, WRC or WRX.

G-P GYPSUM CORP, SUB OF GEORGIA-PACIFIC CORP — Types 5, 9, C, DAP, DD, DA, DGG,

LAFARGE NORTH AMERICA INC -Types LGFC2, LGFC2A, LGFC3, LGFC6, LGFC6A, LGFC-C, LGFC-C/A. NATIONAL GYPSUM CO —Types FSK-C, FSW, FSW-3, FSW-5, FSW-C, FSW-G, FSMR-C.

PABCO GYPSUM, DIV OF PACIFIC COAST BUILDING PRODUCTS INC -Type C, PG-3, PG-5, PG-9 or PG-C.

PANEL REY S A , NL— Type PRX. SIAM GYPSUM INDUSTRY (SARABURI) CO LTD -Type STANDARD GYPSUM L L C — Type SGC, SG-C or SGC-G.

TEMPLE-INLAND FOREST PRODUCTS CORP —Types T, TG-C, VPB-Type T. UNITED STATES GYPSUM CO -Type AR, C, FCV, FRX-G, IP-AR, IP-X1, IP-X2, IPC-AR, SCX, SHX, WRC or WRX.


USG MEXICO S A DE C V , DF—Type AR, C, FCV, IP-AR, IP-X1, IP-X2, IPC-AR, SCX, SHX, WRC or WRX. 4A. Gypsum Board* — (As an alternate to Item 4) — Nom 3/4 in. thick, nstalled as described in Item 4 with 1-1/4 in. long Type S screws for inner layer and 2-1/4 in. long Type S screws for outer layer.

CANADIAN GYPSUM COMPANY —Types AR, IP-AR.

UNITED STATES GYPSUM CO —Types AR, IP-AR. USG MEXICO S A DE C V, DF—Types AR, IP-AR. 4B. Gypsum Board* — (As an alternate to Item 4, 4A and 4B)-5/8 in. thick, 2 ft wide, tongue and groove edge, applied horizontally as the outer layer to one side of the assembly. Secured as described in Item 4

for the direct attached system. CANADIAN GYPSUM COMPANY — Type SHX. UNITED STATES GYPSUM CO -Type SHX. USG MEXICO S A DE C V, DF-Type SHX. *Bearing the UL Classification Mark

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System No. BW-S-0007

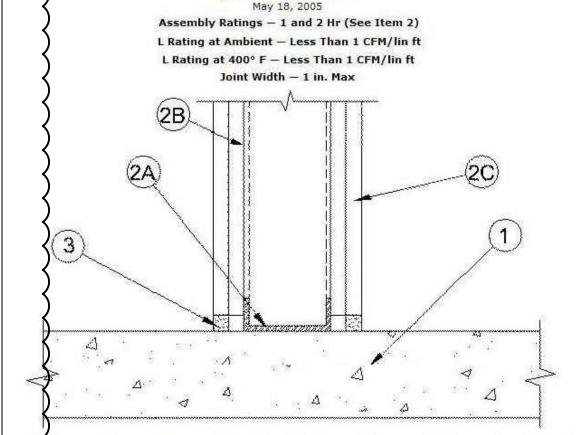Noor Assembly - Min 4-1/2 in, (114 mm) thick reinforced lightweight or normal weight (100-150 pcf 600-2400 kg/m³) structural concrete. Floor may also be constructed of any 6 in. (152 mm) thick UL Classified hollow-core Precast Concrete Units*

See Precast Concrete Units category in the Fire Resistance Directory for names of Vall Assembly — The 1 or 2 h fire-rated gypsum board/steel stud wall assembly shall be constructed be materials and in the manner specified in the individual U400 or V400 Series Wall or Partition Design to be UL Fire Resistance Directory. In addition, the wall may incorporate a head-of-wall joint system constructed as specified in the HW Series Joint Systems in the UL Fire Resistance Directory. The wall shall nclude the following construction features:

A. Steel Floor Runner - Floor runners of wall assembly shall consist of min No. 25 gauge galv steel channels sized to accommodate steel studs (Item 2C), Floor runners to be provided with min 1-1/4 in. (32 mm) flanges. Runners secured with steel fasteners spaced 12 in. (305 mm) OC

B. Studs — Steel studs to be min 3-1/2 in. wide. (89 mm) Studs cut 1/2 to 3/4 in. (13 to 19 mm) less in length than assembly height with bottom nesting in, resting on and astened to floor runner with sheet metal screws. Stud spacing not to exceed 24 in.

C. Gypsum Board* - Gypsum board installed to a min total thickness of 5/8 or 1-1/4 in. (16 or 32 mm) on each side of wall for a 1 or 2 hr rated wall, respectively. Wall to be constructed as specified in the individual U400 or V400 Series Design in the UL Fire Resistance Directory, except that a max 1 in. (25 mm) gap shall be maintained between the bottom of gypsum board and top of concrete floor.

The hourly fire rating of the joint system is equal to the hourly fire rating I. Fill, Void or Cavity Material* - Caulk or Sealant — Max separation between top of floor and bottom of g psum board is 1 in. (25 mm). Min 5/8 in. (16 mm) thickness of fill material installed on each side of the wall between the bottom of the gypsum board and the top of the concrete floor, flush with each surface

3M COMPANY — FB1000 NS, FB-2000, FB-2000+, FB-3000 WT sealant, FireDam 150+, IC 15WB+, CP 25WB+ caulk


*Bearing the UL Classification Mark Last Updated on 2005-05-18

> Design No. U905 September 30, 2010

Bearing Wall Rating - 2 HR.

Nonbearing Wall Rating — 2 HR

Load Restricted for Canadian Applications — See Guide <u>BXUV7</u>

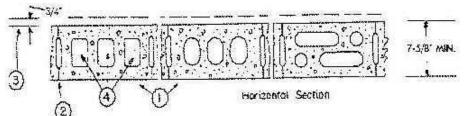

 Concrete B locks* — Various designs. Classification D-2 (2 hr). See Concrete Blocks category for list of eligible manufacturers.

2. Mortar — Blocks laid in full bed of mortar, nom. 3/8 in: thick, of not less than 2-1/4 and not more than 3-1/2 parts of dean sharp sand to 1 part Portland cement (proportioned by volume) and not more than 50 percent hydrated lime (by cement volume). Vertical joints staggered

3. Portland Cement Stucco or Gypsum Plaster — Add 1/2 hr to classification if used. Where combustible members are framed in wall, plaster or stucco must be applied on the face opposite framing to achieve a max. Classification of 1-1/2 hr. Attached to concrete blocks (Item 1)

4. Loose Masonry Fill — If all core spaces are filled with loose dry expanded slag, expanded clay or shale (Rotary Kiln Process), water repellant vermiculite miasonry fill insulation, or silicone treated perlite loose fill insulation add 2 hr to classification.

5. Foamed Plastic* — (Optional-Not Shown) — 1.4 /2 in. thick max, 4 ft wide sheathing attached to concrete

THE DOW CHEMICAL CO — Type Thermax Sheathing, Thermax Light Duty Insulation, Thermax Heavy Duty Insulation, Thermax Metal Building Board, Thermax White Finish Insulation, Thermax ci Exterior Insulation, Thermax IH Insulation, Thermax Plus Liner Panel and Thermax Heavy Duty Plus (HDP)

Bearing the UL Classification Mark

Last Updated on 2010-09-30

CONTRACTOR SHALL VERIFY ALL DIMENSIONS AND SITE CONDITIONS BEFORE PROCEEDING WITH WORK. IF ANY DISCREPANCIES, ERRORS OR OMISSIONS SHOULD BE ENCOUNTERED ON PLANS, CONTRACTOR SHALL NOTIFY ARCHITECT BEFORE ANY PART OF THE WORK IS STARTED, SO THAT PROPER CORRECTIONS BE MADE. IF ARCHITECT IS NOT NOTIFIED PRIOR TO COMMENCING OF THE WORK, THE CONTRACTOR SHALL BEAR FULL RESPONSIBILITY FOR ANY DISCREPANCIES, ERRORS OR OMISSIONS.

CHI SEAFOOD, LLC

1826 COLLINS AVE.



CHARLES H. BENSON & ASSOCIATES ARCHITECTS, P.A. architect planner interiors

1665 WASHINGTON AVE. 2nd. FLOOR MIAMI BEACH, FLORIDA 33139 Ph: 305-532-6161 * Fax: 305-532-6151 ARCHITECTURE LICENCE # AR14022 NCARB CERTIFICATE # 42,136

DRAWN BY Lilian R. Paez C.

SCALE

AS SHOWN

DATE 2-18-2013

PROJECT NUMBER


1 04-30-13 CITY COMMENTS

ISSUED FOR PERMIT

ISSUED FOR BIDDING _

DETAIL FOR U411 CLASSIFICATION

ISSUED FOR CONSTRUCTION

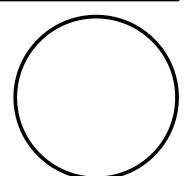



2-18-2013

<u>2-18-2013</u>

NEW RESTAURANT FOR:

Miami Beach, Fl. 33139

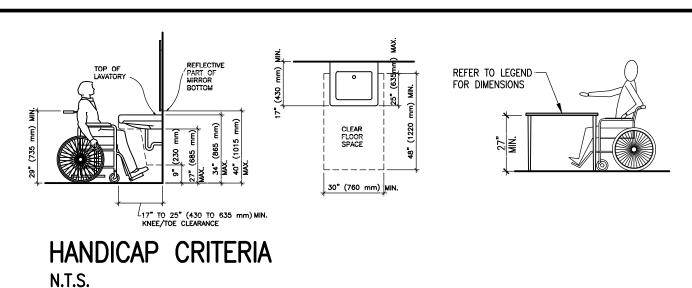

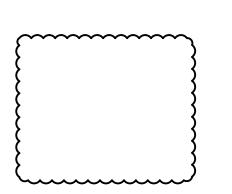

OCCUPANT LOAD B	ased on table NFP	A 1003.1
	SEATING AREA	SEATS
GROUP A-2: ASSEMBLY OCCUPANCY SUBGROUP: SMALL ASSEMBLY	SECOND LEVEL: DINING AREA THIRD LEVEL: DINING AREA BAR FOURTH LEVEL: LOUNGE AREA	\$2 53 14 \$53
	TOTAL	(202)
NUMBER OF WHEELCHAIRS BASED ON FBC CH. 226	5% OF 202	= 11

TA		t load factor NFPA 2010 Edition	
GROUP A: ASSEMBLY OCCUPANCY	AREA s.f.	AREA PER OCCUPANT	TOTAL
GROUND LEVEL: ENTRANCE AREA SECOND LEVEL:	228	15 SF PER PERSON (NET)	16
DINING AREA KITCHEN MECH. ROOM	1,213	15 SF PER PERSON (NET) 100 SF PER PERSON (NET)	3
THIRD LEVEL: DINING AREA BAR	709 160	15 SF PER PERSON (NET) 7 SF PER PERSON (NET) 100 SF PER PERSON (NET)	48 23 2
BACK BAR KITCHEN STORAGE EQUITH LEVEL:	173 570 74	100 SF PER PERSON (NET) 100 SF PER PERSON (NET)	6 1
DINING ÅREA DRY STORAGE WALK-IN COOLERS	704 218 158	15 SF PER PERSON (NET) 300 SF PER PERSON (NET) 300 SF PER PERSON (NET)	1
STORAGE	74	300 SF PER PERSON (NET) TOTAL	(230)

	PLUM	IBING FACIL	ITIES TABLE	E 403.1 FBC	PLUMBING	
OCCUPANCY		REQUI	RED		PROVII	DED
CLASIFICATION	WATER C	CLOSETS	LAVATORIES	SERVICE	WATER CLOSETS	LAVATORIES
	MALE	FEMALE		SINK		
A-2	1 per 75	1 per 75	1 per 200	1 per 500		~~~~~
ASSEMBLY (4	4	2	1	7	6
$\overline{}$						

		TAE	BLE A.7.	6 NFPA			TABLE 100	05.1 FBC	TABLE 10)19.1 FBC
FUNCTION OF SPACE	COMMON LIMIT			TRAVEL EXIT (ft)	MAXIMUN END COI LENGTH	RRIDOR	EGRESS WI OCCUPANT (OCC.	R OF EXITS LOAD: PERSONS
	unsprk.	SPRK.	unsprk.	SPRK.	unsprk.	SPRK.	LEVEL	STAIRS	REQ.	PROVIDED
ASSEMBLY	20	20	200	250	20	20	0.2	0.3	2	2
KITCHEN OR ASSEMBLY <50 (OCCUP.)		75		250		20				

12.7.9.2 UNSECURED SEATING F.F.P.C. NFPA 1 2010 EDITION

12.7.9.2.1 SEATS NOT SECURED TO THE FLOOR SHALL BE PERMITTED IN RESTAURANTS, NIGHT CLUBS AND OTHER OCCUPANCIES WHERE FASTENING SEATS MIGHT BE IMPRACTICABLE.

12.7.9.2.2 UNSECURED SEATS SHALL BE PERMITTED, PROVIDED THAT, IN THE AREA USED FOR SEATING, EXCLUDING SUCH AREAS AS DANCE FLOORS AND STAGES, THERE IS NO MORE THAN ONE SEAT FOR EACH 15 FT² OF NET FLOOR AREA, AND ADEQUATE AISLES TO REACH EXITS ARE MAINTAINED AT ALL TIMES.

GENERAL NOTES

ALL FLOOR FINISHES TO BE SLIP RESISTANT TO 0.6 STATIC COEFFICIENT OF FRICTION ON ACCESSIBLE ROUTES AND 0.8 ON Waximum Change of Elevation at all Building Ingress/Egress Doors (Including Thresholds) shall not exceed 1/2".


FAUCET NOTES: THE FORCE TO ACTIVATE CONTROLS SHALL BE NO GREATER THAN 5 Ibf ELECTRONICALLY CONTROLLED MECHANISMS ARE LEVER OPERATED, PUSH TYPE & EXAMPLES OF ACCEPTABLE DESIGNS. F SELF-CLOSING VALVES ARE USED, THE FAUCET SHALL REMAIN OPEN FOR AT LEAST 10 SECONDS

FLORIDA FIRE PREVENTION CODE (FFPC) 2010 EDITION WITH COUNTY AMMENDMENTS, WHICH INCLUDES NFPA 101, 2003 EDITION & STATE STATUTES, 2003 EDITION (ADOPTED REFERENCED PUBLICATIONS FOUND HEREIN)

HANDLES, PULLS, LATCHES, LOCKSET & OTHER OPERATING MECHANISMS AT ENTRANCE DOORS, RESTROOM & TOILET ROOM DOORS & OTHER DOORS WHICH ARE PART OF AN ACCESSIBLE ROUTE SHALL BE OPERABLE WITH ONE HAND & SHALL NOT REQUIRE TIGHT GRASPING, PINCHING OR TWISTING OF THE RIST.

ALL DOORS SHALL BE OPERATED BY A SINGLE EFFORT: EXTERIOR SWINGING DOORS: NO REQUIREMENT FOR OPENING FORCE AT THIS TIME INTERIOR SIDE-HINGED/PIVOTED-SWINGING DOORS: SHALL BE OPERABLE BY A FORCE OF NOT MORE THAN 5 Ibf SLIDING OR FOLDING DOORS:SHALL BE OPERABLE BY A FORCE OF NOT MORE THAN 5 Ibf EXIT HARDWARE: ALL EXITS SHALL BE OPERABLE FROM THE INTERIOR OF TENANT SPACE WITHOUT THE USE OF A KEY OR SPECIAL KNOWLEDGE NO MANUALLY OPERATED EDGE OR SURFACE MOUNTED FLUSH BOLTS SHALL BE USED

CONTRACTOR SHALL VERIFY ALL DIMENSIONS AND SITE CONDITIONS BEFORE PROCEEDING WITH WORK. IF ANY DISCREPANCIES, ERRORS OR OMISSIONS SHOULD BE ENCOUNTERED ON PLANS, CONTRACTOR SHALL NOTIFY ARCHITECT BEFORE ANY PART OF THE

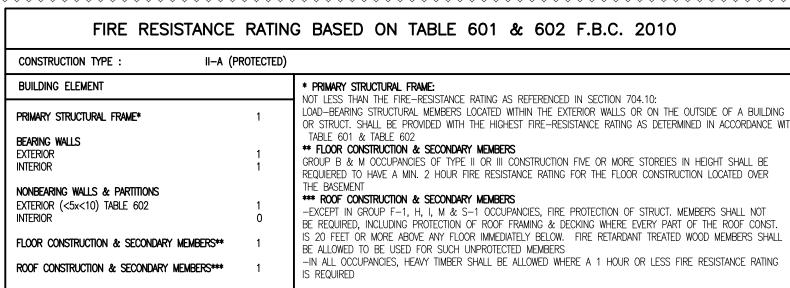

	MINIMUM INTERIOR FINISH CLASSIFICATION (FFPC)
}	OCCUPANCY EXIT ENCLOSURES LOBBIES/CORRIDORS OTHER SPACES
	ASSEMBLY A A ORB A, B OR C
E OF A BUILDING	(a) <u>CLASS A INTERIOR WALL AND CEILING FINISH.</u> FLAME SPREAD 0-25; SMOKE DEVELOPMENT 0-450. INCLUDES ANY MATERIAL
HT SHALL BE	CLASSIFIED AT 25 OR LESS ON THE FLAME SPREAD TEST SCALE AND 450 OR LESS ON THE SMOKE TEST SCALE. ANY ELEMENT THEREOF, WHEN SO TESTED
OCATED OVER	SHALL NOT CONTINUE TO PROPAGATE FIRE. (b) CLASS B INTERIOR WALL AND CEILING FINISH. FLAME SPREAD 36 75 SMOKE DEVELOPMENT OF 450 INCLUDES ANY MATERIA
SHALL NOT	FLAME SPREAD 26-75; SMOKE DEVELOPMENT 0-450. INCLUDES ANY MATERIA CLASSIFIED AT MORE THAN 25 BUT NOT MORE THAN 75 ON THE FLAME SPRE TEST SCALE AND 450 OR LESS ON THE SMOKE TEST SCALE.
ISTANCE RATING	(c) CLASS C INTERIOR WALL AND CEILING FINISH. FLAME SPREAD 76–200; SMOKE DEVELOPMENT 0–450. INCLUDES ANY MATER

MINIMU	M INTERIOR FIN	ISH CLASSIFICATIO	N (FFPC)
OCCUPANCY	EXIT ENCLOSURES	LOBBIES/CORRIDORS	OTHER SPACES
ASSEMBLY	А	A OR B	A, B OR C
a) CLASS A IN	ITERIOR WALL AND CI	EILING FINISH.	

TEST SCALE AND 450 OR LESS ON THE SMOKE TEST SCALE. ASS C INTERIOR WALL AND CEILING FINISH. LAME SPREAD 76-200; SMOKE DEVELOPMENT 0-450. INCLUDES ANY MATERIAL CLASSIFIED AT MORE THAN 75 BUT NOT MORE THAN 200 ON THE FLAME SPREAD TEST SCALE AND 450 OR LESS ON THE SMOKE TEST SCALE.

CODE REVIEW FOR APPROVED MASTER PERMIT B1000116 **EXISTING BUILDING HEIGHT:** +50'-0" TO TOP OF ROOF SLAB FROM GRADE USE & OCCUPANCY CLASSIFICATION: SEPARATED OCCUPANCY A-2 ASSEMBLY OCUPANCY S-2 ROBOTIC GARAGE


BUILDING HEIGHTS & AREAS BY INTENDED USE: A-2 4 STORIES AT 50 FEET S-2 1 STORY AT 50 FEET


CONSTRUCTION TYPE FBC SECC. 602: CONSTRUCTION TYPE IIA SEPARATION OF INDIVIDUAL OCCUPANCIES: FULL SPRINKLER SYSTEM PROVIDED

LEGEND DESCRIPTION FIRE EXTINGUISHER CABINET INSTALLED AT 60" AFF. FIRE EXTINGUISHER INSTALLED AT 60" AFF. INDOOR/OUTDOOR EMERGENCY LIGHT EM1 🗫 🗬 DUALITÉ EML-PG-W WITH 90 MIN. BATTERY BACK UP PHILIPS CHLORIDE RECESSED FUSION F1W1C PHILIPS CHLORIDE RECESSED GIMBAL, RG SERIES ISOLITE EXIT SIGN ELT-EM-R(FACE)-WH-SW-(ARROWS)-SD 120V LED ISOLITE EXIT SIGN ELT-EM-R(FACE)-WH-SC-(ARROWS)-SD ENCORE ENDURANCE CX SERIES WALL MOUNT W/BATTERY PACK 120/277 VAC, 60H INPUT, 2 MR16 LAMPS, 6" RED LETERS, UNIVERSAL ARROWS

SELF DIAGNOSTICS


DUALITE EMERGENCY/EXIT COMBO WITH

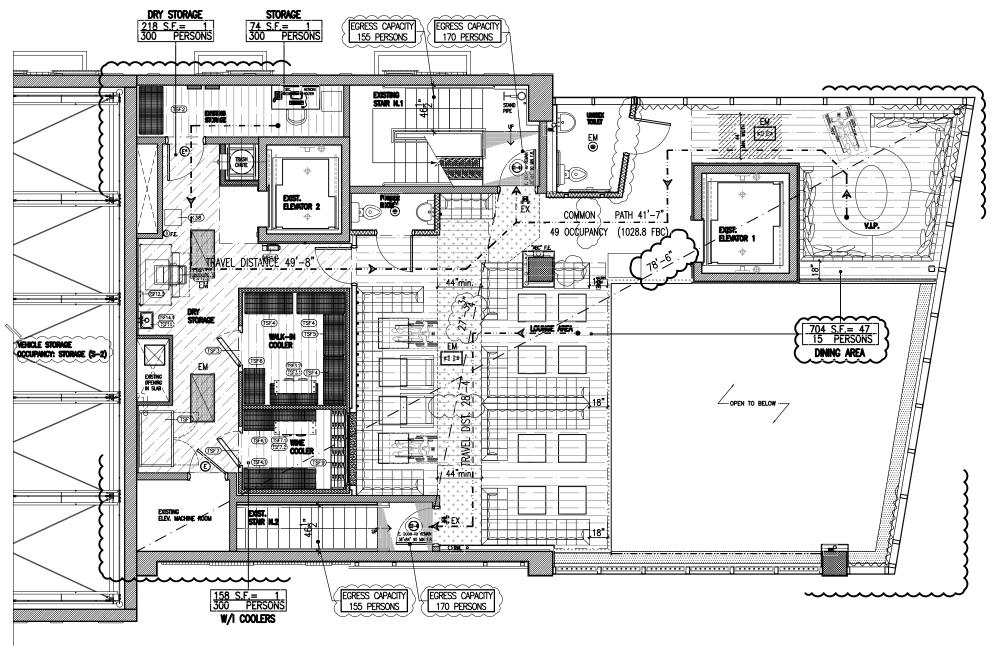

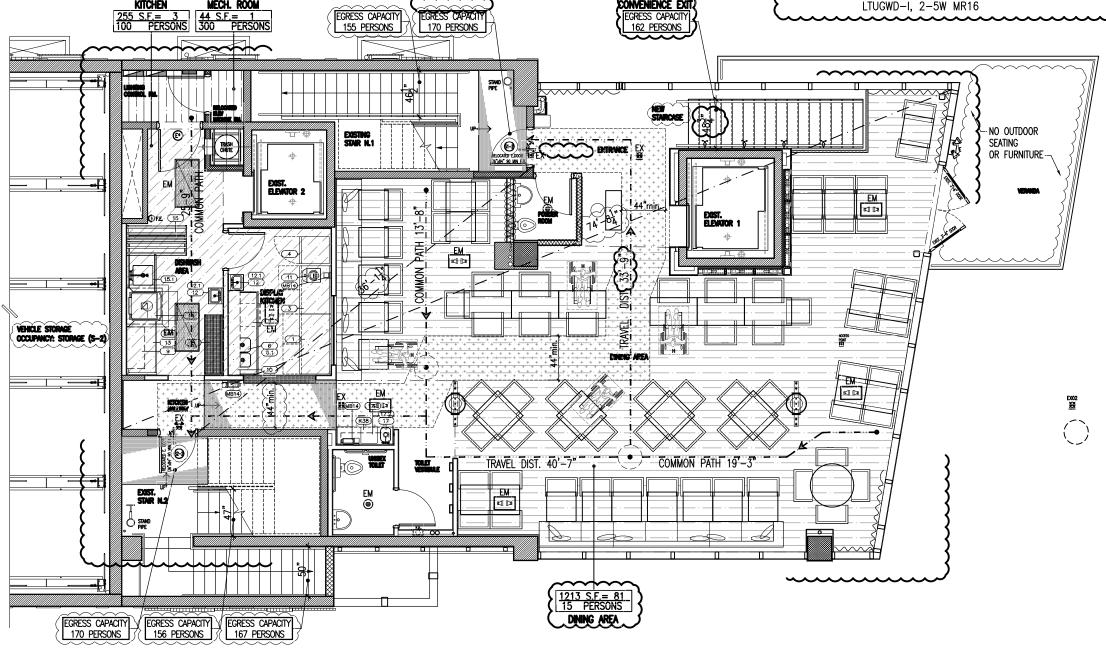


FOURTH LEVEL LIFE SAFETY PLAN SCALE: 1/8"= 1'-0"

SECOND LEVEL

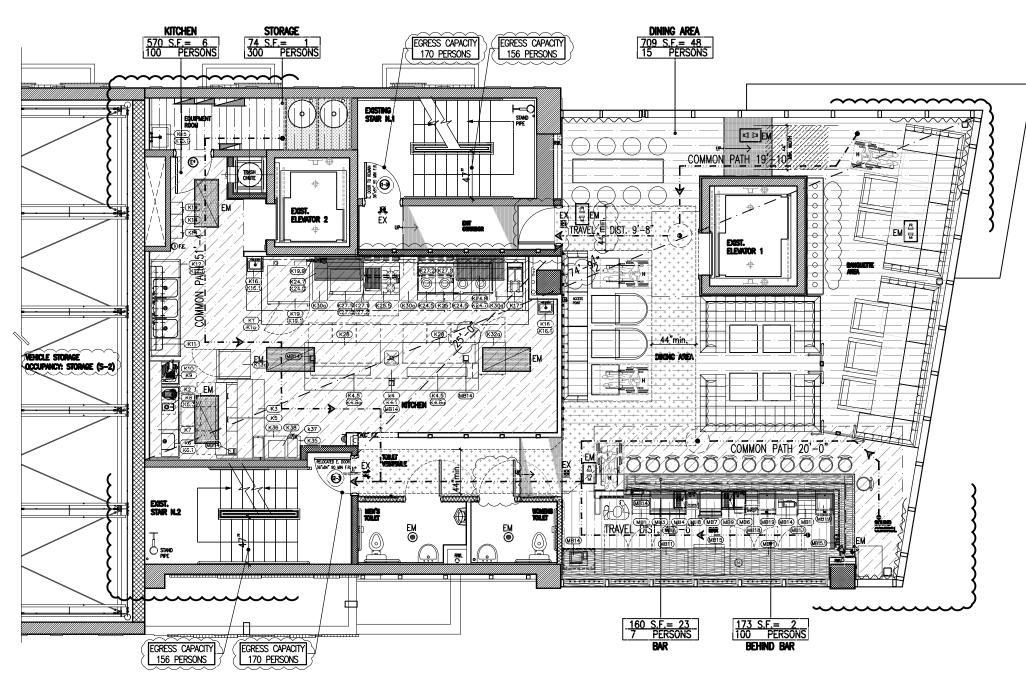

THIRD LEVEL LIFE SAFETY PLAN SCALE: 1/8"= 1'-0"

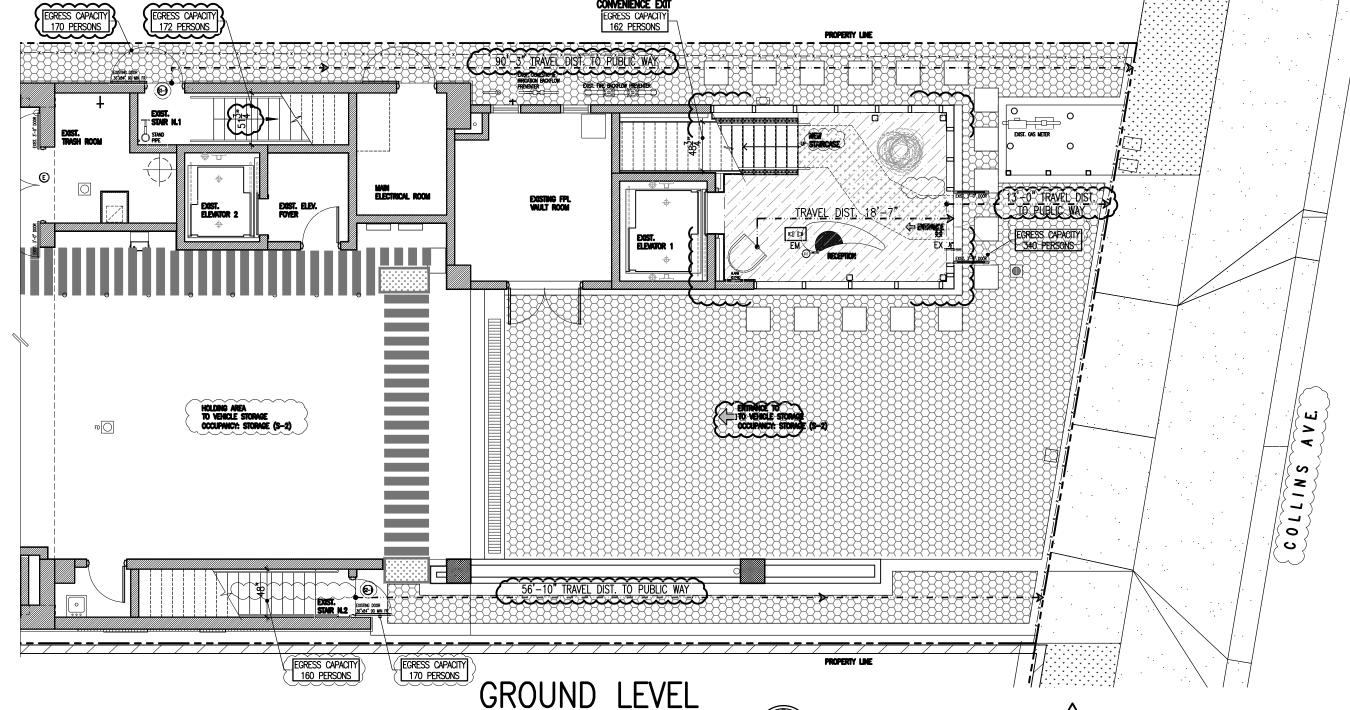

GROUND LEVEL LIFE SAFETY PLAN SCALE: 1/8"= 1'-0" NOTE
ALL EXIT STAIRS ARE 2 HR. FIRE RATED CONSTRUCTION

AND DOORS ARE 90 MIN. FIRE RATED

AS SHOWN

2 06-14-13 CITY COMMENTS: OCCUPANT LOAD, EGRESS PATH REMOTENESS, EM. & EXIT LIGHTS, EGRESS CAPACITY DOORS /1 04-30-13 CITY COMMENTS: TYPE CONST., LABEL ALL AREAS OCC. LOAD, EGRESS CAPAC.,

ISSUED FOR PERMIT

2-18-2013 ISSUED FOR BIDDING ___ <u>2-18-2013</u> ISSUED FOR CONSTRUCTION

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These drawings and copies thereof furnished by the architect are his

property they are not to be used on other work and are to be returned upon demand at the completion of work. If this drawing or any part thereof is used in any manner without the consent of the architect the

user thereof becomes indebted to the architect for full commission.

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Lilian R. Paez C. SCALE DATE

2-18-201

DRAWN BY

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