

§ 18A-11 Landscape maintenance (A) An owner is responsible to ensure that landscaping required to be planted pursuant to this chapter, or the ordinances which were in effect prior to the effective date of this chapter, is: (1) Installed in compliance with the Landscape requirements; (2) Maintained as to present a healthy, vigorous, and neat appearance free from refuse and debris; and Sufficiently fertilized and watered to maintain the plant material in a ondition healthy condition. (B) If any tree or plant dies which is being used to satisfy current landscape code requirements, such tree or plant shall be replaced with the same landscape material or an approved substitute. (C) Trees shall be pruned in the following manner: (1) All cuts shall be clean, flush and at junctions, laterals or crotches. All cuts shall be made as close as possible to the trunk or parent limb, without cutting into the branch collar or leaving a protruding stub (2) Removal of dead wood, crossing branches, weak or insignificant branches, and sucker shall be accomplished simultaneously with any reduction 3) Cutting of lateral branches that results in the removal of more than (3) Cutting of lateral branches that results in the removal of more than one-third () of all branches on on (1) side of at the shall only be allowed if required for hazard reduction or clearance pruning. (4) Lifting of branches or tree thinning shall be designed to distribute over half of the tree mass in the lower two-thirds () of the tree. (5) No more than one-third () of a tree's living canopy shall be removed within a one (1) year period () of a tree's living canopy shall be removed within a one (1) year period according to the current ANSI A300 Standards and the Landscape Manual. planting material will be maintained in a condition that meets or exceeds Florida Grade #01 and has (01) one year replacemen guarantee



workmanship. OY. Landscape Contractor is responsible for verifying plant quantities prior to bidding. Quantities shown in the plans may vary due to actual alte scale, job conditions, etc... Landscape Architect assumes no responsability for the actual plant count necessary for the successful completion of the work. OS. Landscape Contractor and his subcontractors shall be licensed and insured as required by the municipality, country, state or any toher governmental agency requiring a license or insurence in order for the Landscape Contractor to perform his work. OB. All work shall comform to Miami-Dade County's landscape ordinance Chapter 18-A. ordinance # 98-13, and any other municipal landscape ordinance in effect at the projects location.

98-13, and any other municipal landscape ordinance in effect at the projects location, includins stretest-res.

 Clandscape Contractor is required to procure and obtain any necessary permits any lacable for the succedul completion of this project. If applicable.
 Landscape are succedul completion of this project. If applicable, merr as to impede streetfront triangle of visibility to property owner or neighboors, so as to materially impede vision between a height of 3
 Landscape Contractor shall call Sunshine State One Call Center of Florida at 1-800-432-4770 (Toil Free) 48 hours before digging.
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 Landscape Contractor shall consolible for inspectinn the site and phisically observing all the site conditions proir to entering into Agreements or Contract with Owner. Landscape Contractor shall coordinate the work.
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 Landscape Contractor shall coordinate the projected for the site work.
 Landscape Contractor shall coordinate the projected phaning in the Planting Plan with the work required in necolacity and removal of trees in sheet L-1 (Existing Trees).
 One year guarantee on plan material

Sec. 30-242. - Artificial turf.

(a)Definitions . The following words, terms and phrases when used in this section, shall have the meanings ascribed to them in this section: (1)Corner Lot. A Lot located at the intersection of two streets and abutting such streets on two adjacent sides.

(2)Artificial Turf. An artificial product manufactured from synthetic materials that simulates the appearance of natural turf, grass, sod or lawn.

(b)Installation. (1)Single Family and Two-Family Districts. Within the VR, VE, IR and PS Districts, Artificial Turf shall not be permitted to be installed within a Front Yard of any Lot, or within a Street True server to be permitted to be installed within a Front Yard of any Lot, or within a Street Side Yard of a Corner Lot.
(2)Other Districts. Within all other zoning districts with the exception of the PROS Public Recreation and Open Space Use District and the GU Government Use District, Artificial Turf shall not be permitted to be installed within a Front Yard, or within a Side Yard facing a Street.


(c)Installation, Maintenance and Repair . (1)No person shall install Artificial Turf without first obtaining a permit from the Village Planning, Building and Zoning Department. (2)All Artificial Turf shall, at a minimum, be installed according to the manufacturer's

(2NI Artificial Turd shall, at a minimum, be installed according to the manufacturer's specifications. (4)All seams shall be nalied and glued, not servin, and edges shall be trimmed to fit against all regular and the regular edges to resemble a natural look. (5)If Artificial Turd is planned to be installed immediately adjacent to a seawall, the Artificial Turd shall be planed or staked behavior the seawall. A Artificial Turd is natural seawall, the Artificial Turd shall be planed or staked behavior (e.g., and the adjacent to a seawall, the Artificial (6)Artificial Turd shall be visually level, with the grain pointing in a single direction. (7)An appropriate solid barrier device (e.g., concrete mow stip), benefor board) is required to separate Artificial Turd from soil and live vegetation. (8)Procautions for installation anound existing trees, including a proper radius, shall be provided to ensure that there roots are not damaged with the installation of the base (9)All Artificial Turd shall be maintained in a green fixed to explore and shall be maintained free of dirt, animal waste, mud, stains, weeds, debris, tears, holes, and impressions. Maintenance shall hold to maintain a visually-level surface; elimination of any doors, flat or matud areas, weeds, and evalve roots; and all deges of the Artificial (10)All Artificial Turd risub te maintained in a green fixel to maintain a visually-level surface; elimination (10)All Artificial Turd must be replaced if talls into disregari with fading or holes or losse manufacturer and done so in a manner that results in a repart that blends in with the existing Artificial Turd, without any matting. (11)All Artificial Turd shall be installed on a permeable backing in order to ensure proper driange, (12)All Artificial Turd shall be installed on a permeable backing in order to ensure proper driange.

drainage.(12)AI Artificial Turf shall be of the highest quality available from a list of Village-approved manufacturers, and shall be a natural green color selected from a patette of colors approved by the Village.


LANDSCAPE LEGEND 811 Know what's belle Gall before yo It's the Law! OPEN SPACE REQUIRED/ PROVIDED ALLOWED A. SQUARE FEET OF REQUIRED OPEN SPACE, AS INDICATED ON SITE PLAN: REFER TO SITE PLAN A. NUMBER OF TREES REQUIRED PER LOT ACRE, LESS EXISTING NUMBER OF TREE MEETING MINIMUM REQUIREMENTS = TREES FRONT AND 3 BACK + 8 TREES DUE TO LOT SIZE = __13__ __15*__ B. % PALMS ALLOWED: NUMBER OF TREE PROVIDED = NA __NA___ C. % NATIVES REQUIRED: NUMBER OF TREE PROVIDED 30% = _7__ __4___ D. % DROUGHT TOLERANT AND LOW MAINTENANCE: NUMBER OF TREE PROVIDED × 50% = ___7___ ___7___ E. STREET TREES (MAXIMUM AVERAGE SPACING OF 20' O.C.) LINEAR FEET ALONG STREET / 20 = 15.11 / 20 = 4 TREES __4___ ___4___ TOTAL REQUIRED TREES 13 LOT TREES +4 STREET TREES = 11 TREES ___17___ ____19___ FLUORESCENT ORA MARKER ON BRACE I" WIDE MIN. NYLON STRAPS (3 PER TRE SHRUBS A. NUMBER OF SHRUBS REQUIRED: NUMBER OF TREES REQUIRED × 12 = __204__ ____205___ STAKES 18" B. % NATIVE SHRUBS REQUIRED : NUMBER OF SHRUBS PROVIDED X 50% = __102____139___ BELOW GRADE C. 10% OF THE SHRUBS REQUIREMENT SHALL BE LARGE SHRUBS = __20___ __21___



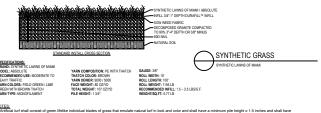


stallation, maintenance and repair



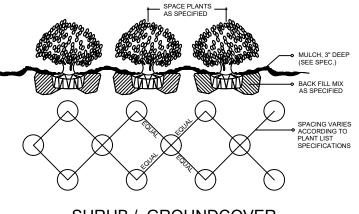

SHRUB / GROUNDCOVER SPACING PLANTING DETAIL

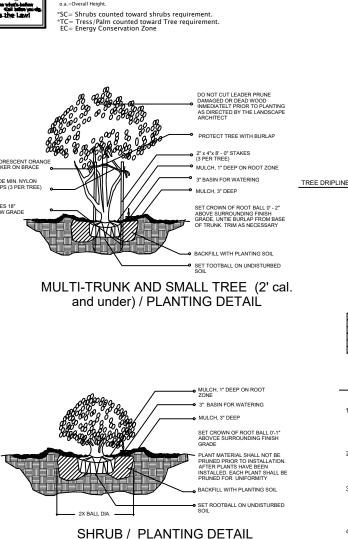



NAT.=Native specie


g.w.=Gray Wood

g.t.=Gray Trunk. c.t.=Clear Trunk.

o.c.=On Center. 3&B=Balled and Burlaped.

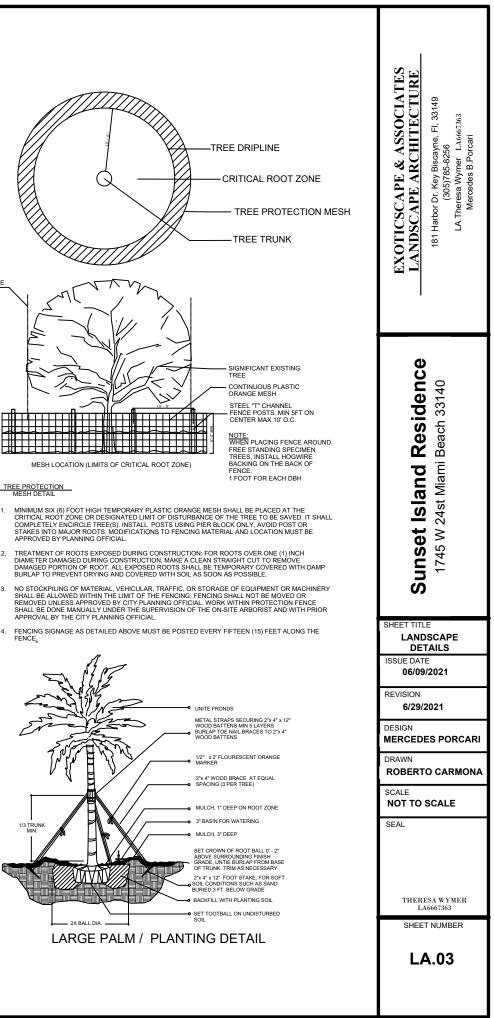

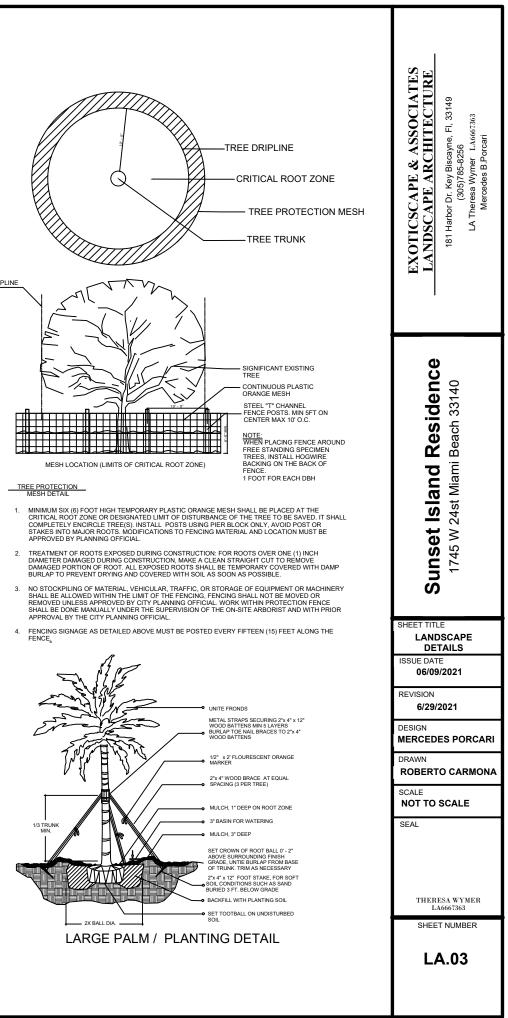

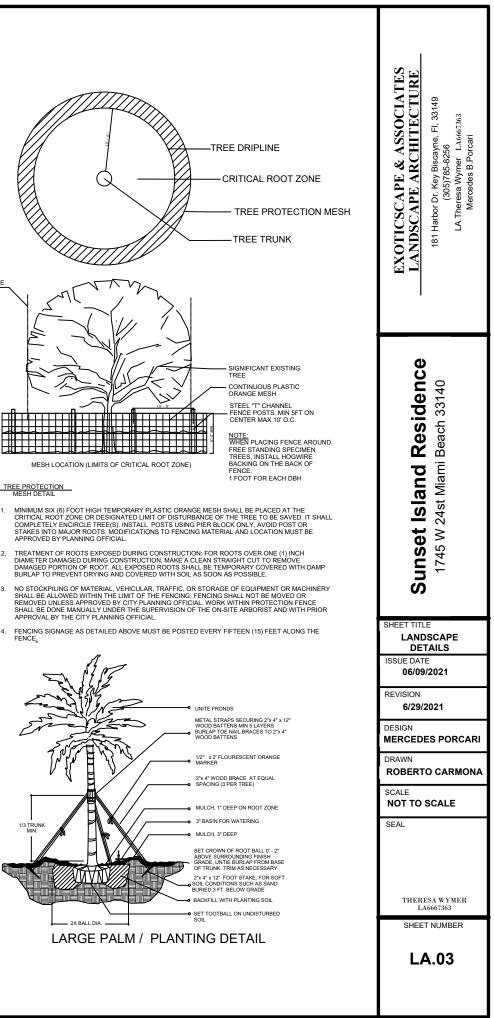

(2" cal. and over) LARGE TREE / PLANTING DETAIL

ATA A

- 2X BALL DIA.

DO NOT CUT LEADER PRUN DAMAGED OR DEAD WOOD INMEDIATELT PRIOR TO PLANTING AS DIRECTED BY THE LANDSCAPE ARCHITECT

PROTECT TREE WITH BURLAP

1" WIDE MIN. NYLON STRAPING A EQUAL SPACING (3 PER TREE)

MULCH, 1" DEEP ON ROOT ZONE

1/2" x 2' FLOURESCENT ORANGE

SET CROWN OF ROOT BALL 0' - 2"

2"x 2"x2' STAKE TOP TO BE 2" MIN BELOW FINISH GRADE

BACKEILL WITH PLANTING SOIL SET TOOTBALL ON UNDISTURBED

ABOVE SURROUNDING FINISH GRADE, UNTIE BURLAP FROM BASE OF TRUNK. TRIM AS NECESSARY

- 3" BASIN FOR WATERING

- MULCH. 3" DEEP





EXOTICSCAPE & ASSOCIATES LANDSCAPE ARCHITECTURE 181 Harbor Dr. Key Biscayne, Fl, 33149 (305)785-8256 LA Theresa Wymer LA6667363 Mercedes B.Porcari
Sunset Island Residence 1745 W 24st Miami Beach 33140
SHEET TITLE LANDSCAPE VIEWS 2 ISSUE DATE 06/09/2021 REVISION 6/29/2021 DESIGN MERCEDES PORCARI DRAWN ROBERTO CARMONA SCALE 1/16"=1'-0" SEAL THERESA WYMER LA6667363 SHEET NUMBER