CMA Design Studio, Inc.

ARCHITECTURE PLANNING INTERIOR DESIGN
232 Andalusia Avenue Suite 101 Coral Gables, Florida 33134 T: 305.448.4200

Pg.1

Hibiscus Residence
190/184 S Hibiscus Drive
Miami Beach, FL 33139
TITLE: CONTEXT LOCATION MAP


SEAL

Lynsie Christine Conn FL Architect AR99059 AA26000730

SHEET NO.:

G1.1

Neighbor Support DRB21-0667: 184-190 S. Hibiscus Drive

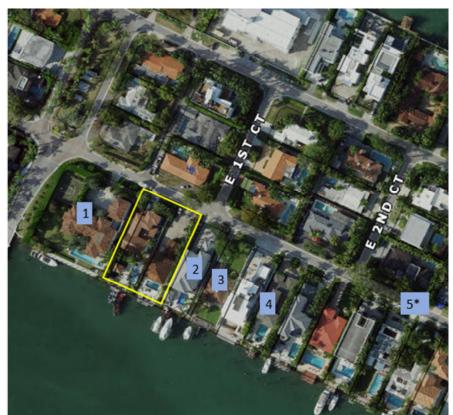

No.	Property Address	Owner	Status
1	218 S. Hibiscus Drive	Ibrahim Al Rashid	Support Letter
2	176 S. Hibiscus Drive	Jose A. Barrios	Support Letter
3	170 S. Hibiscus Drive	Jay <u>Bernkrant</u>	Support Letter
4	150 S. Hibiscus Drive	Ken Kazahaya	Support Letter
5*	1 N. Hibiscus Drive	Urike Stadler	Support Letter
*Not pictured			



City of Miami Beach

1700 Convention Center Drive, 2nd Floor

Miami Beach, Florida 33139

Re: DRB21-0667 - Single-Family Home at 184-190 S. Hibiscus Drive, Miami Beach

etter of Suppor

Dear Board Members:

I am the owner of Jobseph M. Miami Beach, Florida, which is in close proximity or abutting the above-referenced property. I had a conversation with the applicant and reviewed plans, renderings and design requests for the proposed single-family residence. The home is beautifully-designed and will be a welcome addition to the neighborhood.

Based on the foregoing, I fully support the applicant's new home and ask the Design Review Board to grant the design review approval with all associated requests.

Sincerely.

Signature

Print name

2421

Design Review Board Members

c/o Michael Belush, Chief of Planning & Zoning

Planning Department City of Miami Beach

1700 Convention Center Drive, 2nd Floor

Miami Beach, Florida 33139

Re: DRB21-0667 - Single-Family Home at 184-190 S. Hibisous Drive, Miami Beach

Letter

Dear Board Members:

BERCOW RADELL FERNAND LARKIN + TAPANES I am the owner of IN Hold COS. Miami Beath, Florida, which is in close proximity or abutting the above-referenced property. I had a convenation with the applicant and reviewed plans, renderings and design requests for the proposed single-family residence. The home is beautifully-designed and will be a welcome addition to the neighborhood.

Based on the feregoing, I fully support the applicant's new home and ask the Design Review Board to grant the design review approval with all associated requests.

Sincerely,

Signature

IN DER STADLER

July 21, 2021

Design Review Board Members % Michael Belush, Chief of Planning & Zoning Planning Department City of Miami Beach 1700 Convention Center Drive, 2nd Floor Miami Beach, FL 33139

Re: DRB21-0667 - Single-Family Home at 184-190 S. Hibiscus Drive, Miami Beach

Letter of Support

Dear Board Members

I am the owner of 150 S. Hitbiscus Dr. Miami Beach, FL, which is in close proximity to the above referenced property. I had a conversation with the applicant and reviewed plans, renderings and design requests for the proposed single-family residence. The home is beautifully designed and will be a welcome addition to the neighborhood.

Based on the foregoing, I fully and enthus lastically support the applicant's new home application and respectfully ask the Design Review Board to grant the design review approval with all associated requests.

Sincerely,

any Kazakaya

Amy Kazahaya

150 S. HIBISCUS DR. MIAMI BEACH, FL 33139 (856) 261-7004

July 27, 2021

Design Review Board Members c/o Michael Belush, Chief of Planning & Zoning Planning Department

Planning Department City of Miami Beach

City of Miami Beach 1700 Convention Center Drive, 2nd Floor

Miami Beach, Florida 33139

DRB21-0667 – Single-Family Home at 184-190 S. Hibiscus Drive, Miami Beach Letter

Dear Board Members:

Based on the foregoing, I fully support the applicant's new home and ask the Design Review Board to grant the design review approval with all associated requests.

incerely,

IBRAHIM AL-RASHID

rint nama

Pa.3

Design Review Board Members

7-22

c/o Michael Belush, Chief of Planning & Zoning Planning Department

City of Miami Beach

1700 Convention Center Drive, 2nd Floor Miami Beach, Florida 33139

Re: DRB21-0667 - Single-Family Home at 184-190 S. Hibiscus Drive, Miami Bench

Support

Dear Board Members:

I am the owner of 100 co MITATECE, Miarai Beach, Florida, which is in close proximity or abutting the above-referenced property. I had a conversation with the applicant and reviewed plans, renderings and design requests for the proposed single-family residence. The home is beautifully-designed and will be a welcome addition to the neighborhood.

Based on the feregoing, I fully support the applicant's new home and ask the Design Review Board to grant the design review approval with all associated requests.

Sincerely,

1

Signature

JAY DETHIN BAY


DRB SET 05.10.21

R1.0



N.T.S

R1.0 R1.0

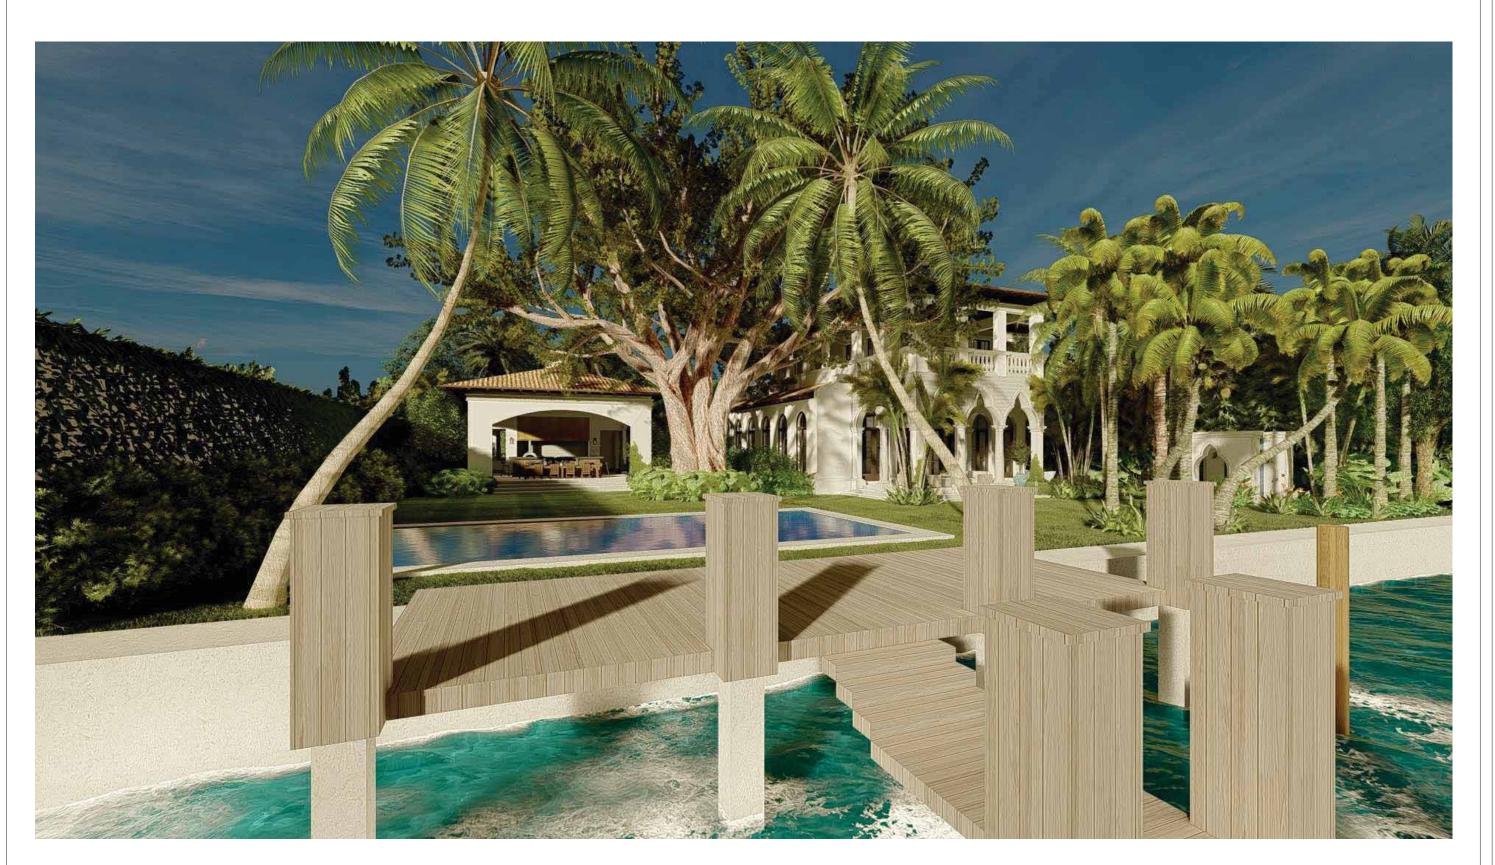

RENDERING PERSPECTIVE

N.T.S

DRB SET 05.10.21

ARCHITECTURE PLANNING INTERIOR DESIGN 232 Andalusia Avenue Suite 101 Coral Gables, Florida 33134 T: 305.448.4200 CMA Design Studio, Inc.

Hibiscus Residence
190/184 S Hibiscus Drive
Miami Beach, FL 33139
TITLE: RENDERING PERSPECTIVE

SEAL

SHEET NO.:

R7.0

R8.0

DRB SET 05.10.21



R10.0

DRB SET 05.10.21



RENDERING PERSPECTIVE

R11.0

DRB SET 05.10.21



RENDERING PERSPECTIVE

R11.0 R11.0 N.T.S

ARCHITECTURE PLANNING INTERIOR DESIGN 232 Andalusia Avenue Suite 101 Coral Gables, Florida 33134 T: 305.448.4200 CMA Design Studio, Inc.

Hibiscus Residence

TITLE: 190 S HBISCUS DR

SEAL

SHEET NO.:

G1.2

DRB SET 05.10.21



2 190 S HIBISCUS DR - EXISTING STRUCTURE





1 190 S HIBISCUS DR - EXISTING STRUCTURE




3 190 S HIBISCUS DR - EXISTING STRUCTURE

4 190 S HIBISCUS DR - EXISTING STRUCTURE

G1.2A



1 184 S HIBISCUS DR - EXISTING STRUCTURE

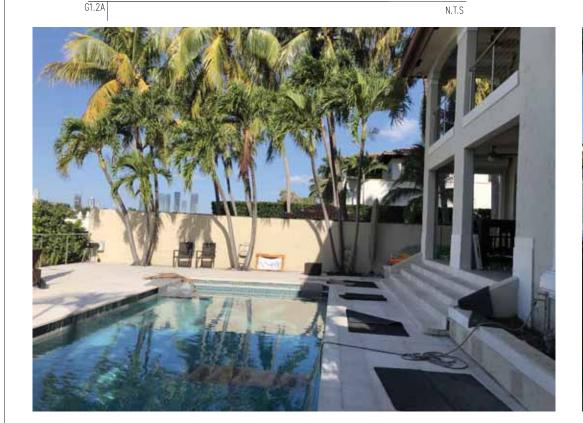

3 184 S HIBISCUS DR - EXISTING STRUCTURE




2 184 S HIBISCUS DR - EXISTING STRUCTURE





4 184 S HIBISCUS DR - EXISTING STRUCTURE

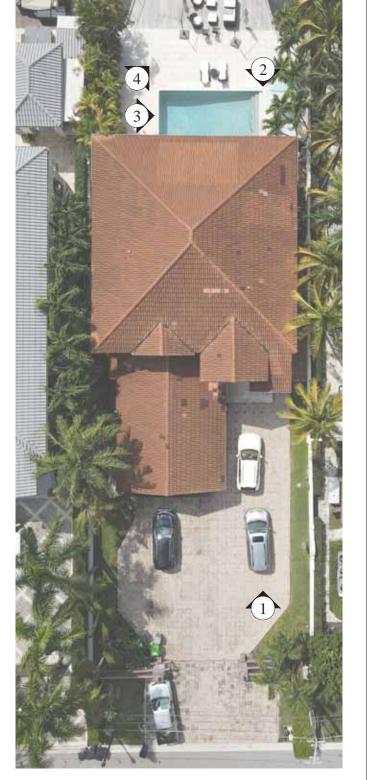

5 KEY MAP

DRB SET 05.10.21

G1.2B









1 190/184 S HIBISCUS DR - EXISTING STRUCTURE

G1.3






N.T.S



2 176 S HIBISCUS DR

N.T.S

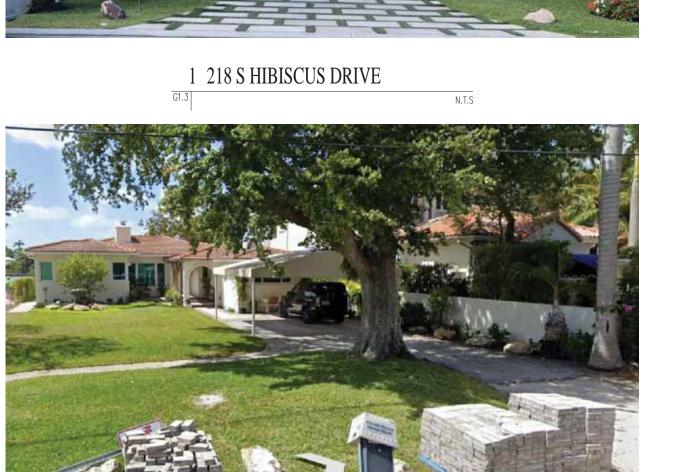

3 170 S HIBISCUS DRIVE

N.T.S

DRB SET 05.10.21

G1.3A



AERIAL VIEW



5 185 S HIBISCUS DR

G1.3 N.T.S



4 205 S HIBISCUS DRIVE

N.T.S




6 165 S HIBISCUS DRIVE

N.T.S

DRB SET 05.10.21

G1.4

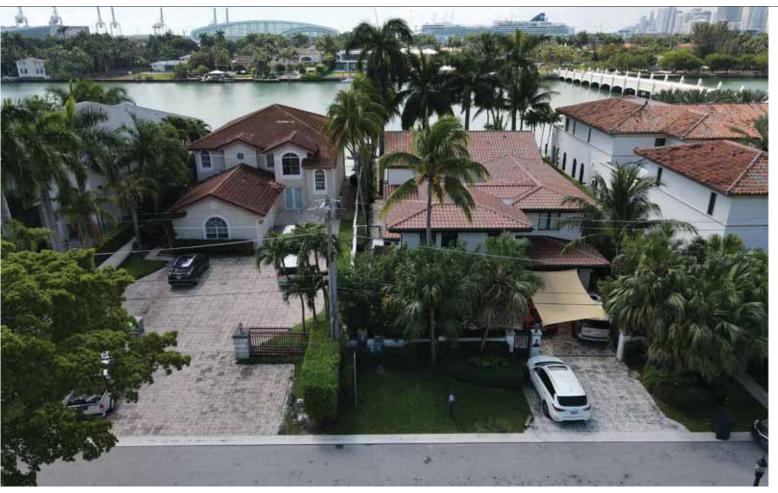

1 190/184 S HIBISCUS DRIVE EXISTING

N.T.S

2 190/184 S HIBISCUS DRIVE PROPOSED

(STREET TREES OMITTED TO SHOW HOME BEYOND)

DRB SET 05.10.21



1970 (ORIGINAL 1939 STRUCTURE)



1989

FRONT ELEVATION PROGRESSION

(190 S HIBISCUS DRIVE)



1965 (ORIGINAL 1939 STRUCTURE)



1989

1 REAR ELEVATION PROGRESSION





2021

DRB SET 05.10.21

ARCHITECTURE PLANNING INTERIOR DESIGN 232 Andalusia Avenue Suite 101 Coral Gables, Florida 33134 T: 305.448.4200 CMA Design Studio, Inc

Pg.16


Hibiscus Residence
190/184 S Hibiscus Drive
Miami Beach, FL 33139
POST 1942 MODIFICATIONS

SEAL

Lynsie Christine Conn FL Architect AR99059 AA26000730

SHEET NO.:

G1.5A

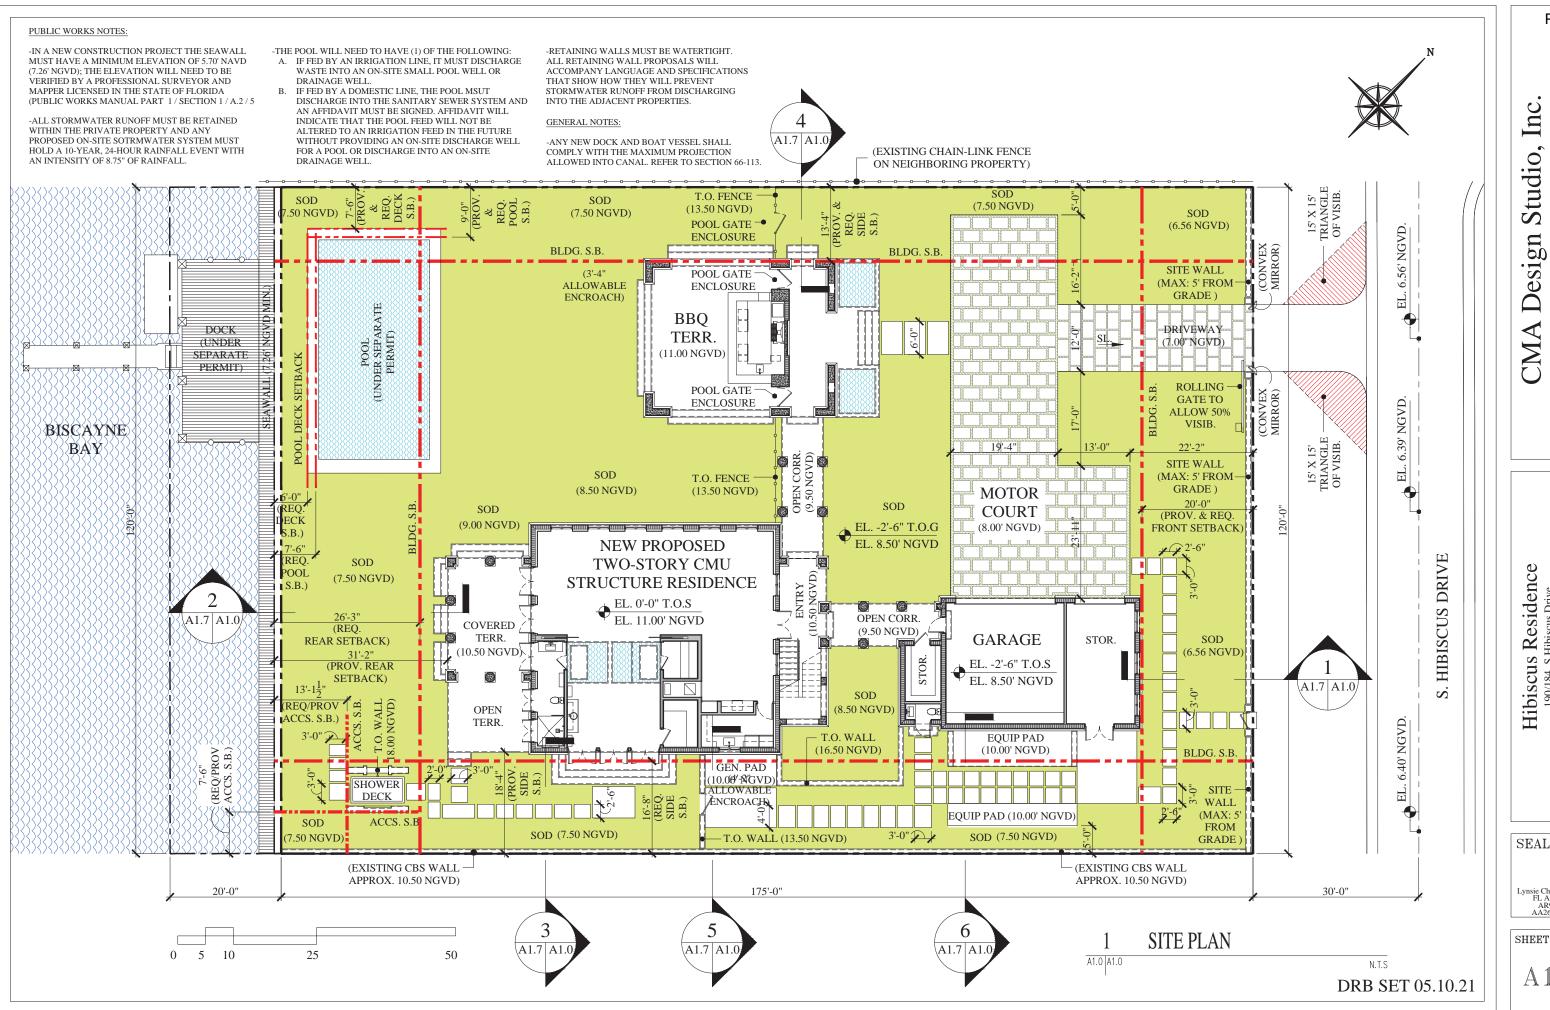

ARCHITECTURE PLANNING INTERIOR DESIGN 232 Andalusia Avenue Suite 101 Coral Gables, Florida 33134 T: 305.448.4200 CMA Design Studio, Inc

Hibiscus Residence 190/184 S Hibiscus Drive Miami Beach, FL 33139 TITLE: SITE PLAN

Lynsie Christine Conr FL Architect AR99059 AA26000730 SHEET NO.:

A1.0

ARCHITECTURE PLANNING INTERIOR DESIGN 232 Andalusia Avenue Suite 101 Coral Gables, Florida 33134 T: 305.448.4200 CMA Design Studio, Inc.

Hibiscus Residence
190/184 S Hibiscus Drive
Miami Beach, FL 33139
TITLE: FIRST FLOOR PLAN

SEAL

Lynsie Christine Conn FL Architect AR99059 AA26000730

SHEET NO.:

A2.0

ARCHITECTURE PLANNING INTERIOR DESIGN 232 Andalusia Avenue Suite 101 Coral Gables, Florida 33134 T: 305.448.4200 CMA Design Studio, Inc.

Hibiscus Residence
190/184 S Hibiscus Drive
Miami Beach, FL 33139
TITLE: SECOND FLOOR PLAN

SEAL

Lynsie Christine Conn FL Architect AR99059 AA26000730

SHEET NO.:

A2.1

ARCHITECTURE PLANNING INTERIOR DESIGN 232 Andalusia Avenue Suite 101 Coral Gables, Florida 33134 T: 305.448.4200 CMA Design Studio, Inc.


Hibiscus Residence 190/184 S Hibiscus Drive Miami Beach, FL 33139
TITLE: ROOF PLAN

SEAL

Lynsie Christine Conn FL Architect AR99059 AA26000730

SHEET NO.:

A2.2

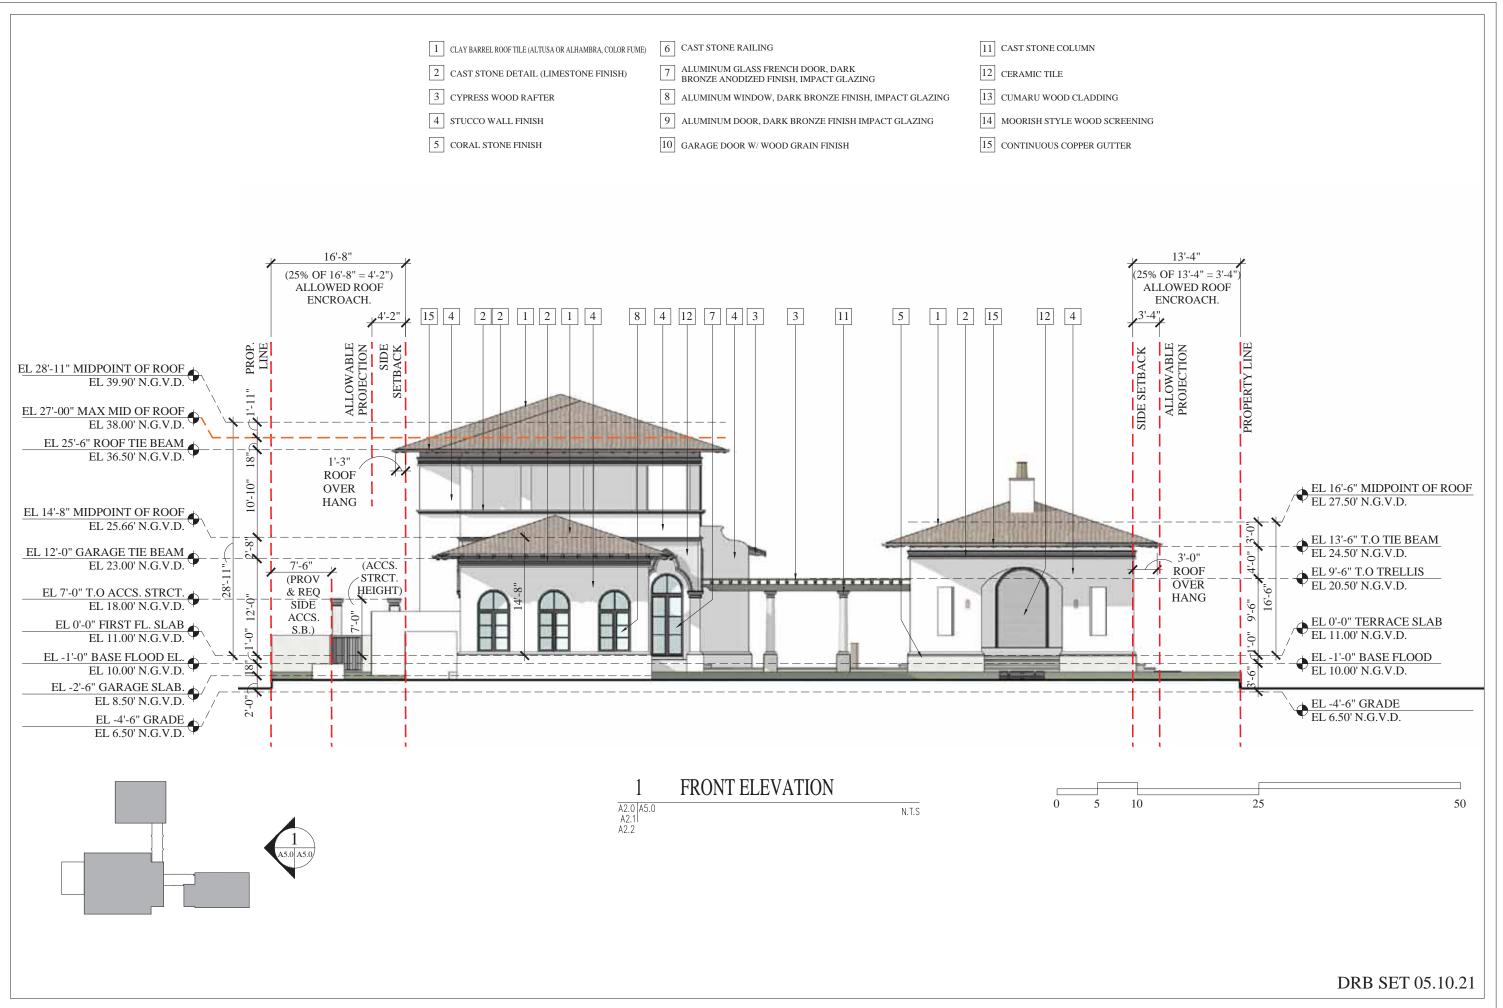

CMA Design Studio, Inc.

ARCHITECTURE PLANNING INTERIOR DESIGN
232 Andalusia Avenue Suite 101 Coral Gables, Florida 33134 T: 305.448.4200

Hibiscus Residence
190/184 S Hibiscus Drive
Miami Beach, FL 33139
TITLE: FRONT ELEVATION

SEAL

Lynsie Christine Conn FL Architect AR99059 AA26000730

SHEET NO.:

CMA Design Studio, Inc.

ARCHITECTURE PLANNING INTERIOR DESIGN
232 Andalusia Avenue Suite 101 Coral Gables, Florida 33134 T: 305.448.4200

Hibiscus Residence
190/184 S Hibiscus Drive
Miami Beach, FL 33139
REAR ELEVATION

SEAL

Lynsie Christine Conn FL Architect AR99059 AA26000730

SHEET NO.:

ARCHITECTURE PLANNING INTERIOR DESIGN 232 Andalusia Avenue Suite 101 Coral Gables, Florida 33134 T: 305.448.4200 CMA Design Studio, Inc

Hibiscus Residence 190/184 S Hibiscus Drive Miami Beach, FL 33139 SIDE ELEVATION

SEAL

Lynsie Christine Conn FL Architect AR99059 AA26000730

SHEET NO.:

ARCHITECTURE PLANNING INTERIOR DESIGN 232 Andalusia Avenue Suite 101 Coral Gables, Florida 33134 T: 305.448.4200 CMA Design Studio, Inc

Hibiscus Residence 190/184 S Hibiscus Drive Miami Beach, FL 33139 SIDE ELEVATION

SEAL

Lynsie Christine Conn FL Architect AR99059 AA26000730

SHEET NO.:

CMA Design Studio, Inc.

ARCHITECTURE PLANNING INTERIOR DESIGN
232 Andalusia Avenue Suite 101 Coral Gables, Florida 33134 T: 305.448.4200

Pg.25

Hibiscus Residence
190/184 S Hibiscus Drive
Miami Beach, FL 33139
TITLE: WAIVER DIAGRAMS

SEAL

Lynsie Christine Conn
FL Architect
AR99059
AA26000730

SHEET NO.:

A1.6

A7.0



TRUE BARREL ROOF TILE

(REDLAND CLAY, ALHAMBRA COLOR BLEND)





CORAL STONE & POOL FINISHES

A5.0 A7.0 A5.1 A5.2

ARCH. COLUMNS & ARCHES DETAIL A5.0 A7.0 A5.1 A5.2 N.T.S





4 MOORISH STYLE WOOD SCREENS

A5.0 A7.0 A5.1 A5.2

5 CAST STONE LIMESTONE FINISH

6 CERAMIC TILE FINISH

DRB SET 05.10.21

R10.0

DRB SET 05.10.21



RENDERING PERSPECTIVE

R2.0

DRB SET 05.10.21

RENDERING PERSPECTIVE R2.0 R2.0 N.T.S

R3.0



RENDERING PERSPECTIVE

R3.0 R3.0

SEAL

SHEET NO.:

DRB SET 05.10.21

R4.0



N.T.S

R4.0 R4.0

Hibiscus Residence
190/184 S Hibiscus Drive
Miami Beach, FL 33139
TITLE: RENDERING PERSPECTIVE

SEAL

SHEET NO.:

R5.0

DRB SET 05.10.21



R6.0

DRB SET 05.10.21



SEAL

SHEET NO.:

DRB SET 05.10.21

R9.0



RENDERING PERSPECTIVE

SURVEY

TITLE: 190/184

Digitally signed by

Date: 2021.03.28

21:40:52 -04'00'

By: Rolando Ortiz LS 4312

Professional Land Surveyor

& Mapper, State of Florida.

Rolando Ortiz

Rolando

Ortiz

Date: 03-24-2021


Job No.: 21-32290-B

Sketch No.: 29848-E

SHEET NO .:

DRB SET 05.10.21

G1.0

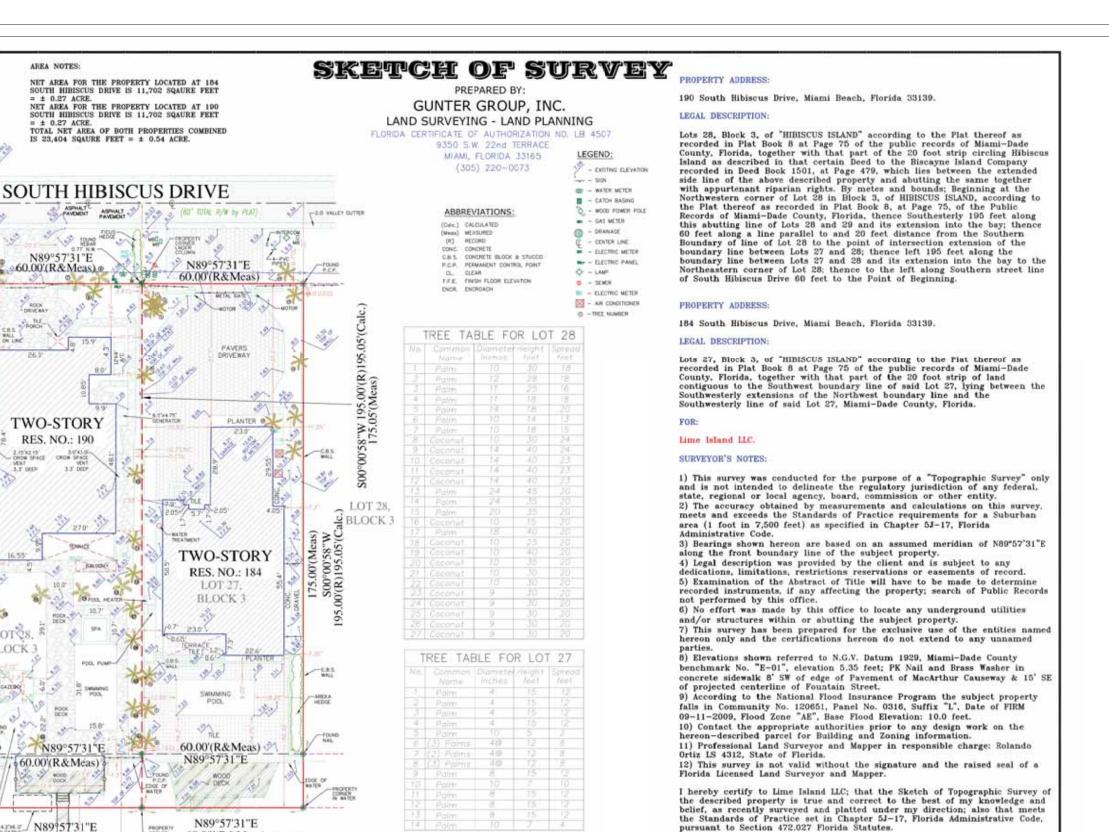

190/184 S HIBISCUS DRIVE - SURVEY

THERE ARE OTHER SHRUBS ON THE SUBJECT

PROPERTY NOT SHOWN ON THIS SURVEY.
ONLY TREES WITH A MINIMUM OF 4 INCHES
IN DIAMETER OF THE TRUNK AT 4 FEET

INFORMATIONAL PURPOSE ONLY, CONSULT A

BOTANIST, ARBORIST AND/OR LANDSCAPE ARCHITECT FOR MORE SPECIFIC INFORMATION

FROM THE GROUND ARE SHOWN ON THIS SURVEY. TREES SHOWN HEREIN ARE FOR

ON THE TREES SPECIES.

TREE NOTE:

60.00'(R&Meas)

AREA NOTES:

N89°57'31"E

60.00'(R& Meas).

TWO-STORY

RES. NO.: 190

N89°57'31"E

60.00 (R&Meas)

N89957'31"E

60.00'(R&Calc)

BISCAYNE BAY

NORTH

SCALE 1" = 20'

195.00(R)195.05(Calc.)

×

LOT 28

BLOCK

LOT 29, BLOCK 3

DENOTES STRUCTURE TO BE DEMOLISHED

REMOVE ALL INTERIOR AND EXTERIOR FLOOR FINISHES.

REMOVE ALL DROPPED CEILINGS & CEILING TREATMENTS

REMOVE ALL APPLIANCES.

REMOVE ALL MECHANICAL, ELECTRICAL AND PLUMBING FIXTURES REMOVE ALL EXTERIOR WALL FURRING AND FINISHES


REMOVE ALL EXTERIOR DOORS, AND WINDOWS

REMOVE ALL INTERIOR PARTITIONS.

G.C. TO FIELD VERIFY ALL CONDITIONS AND DIMENSIONS & NOTIFY ARCH. & STRUCTURAL ENG. OF ANY DISCRETIONS

WALKWAY OR SITE COMPONENT TO BE DEMOLISHED

DENOTES SLAB, DRIVEWAY,

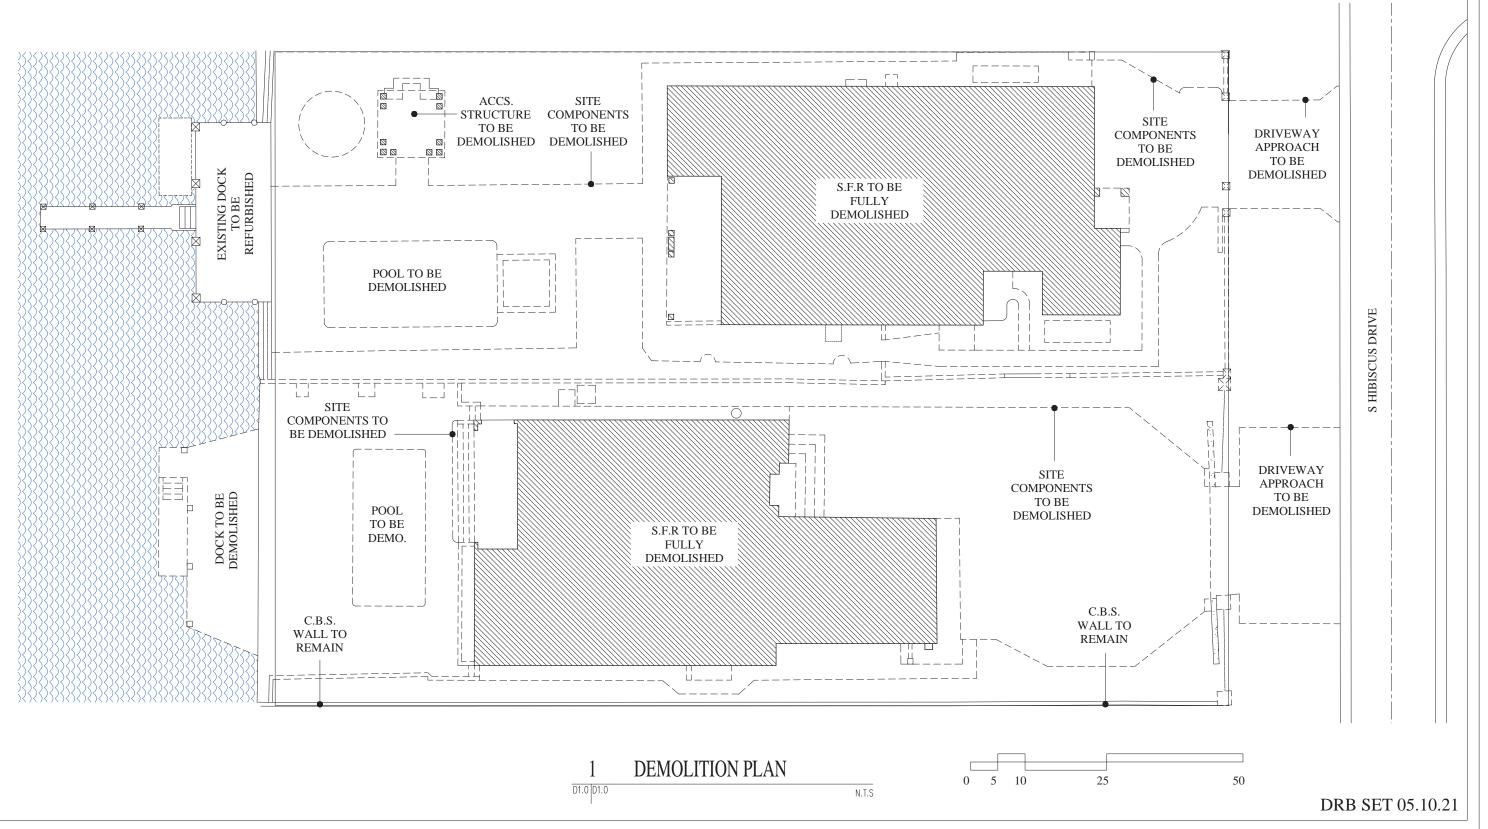

ARCHITECTURE PLANNING INTERIOR DESIGN 232 Andalusia Avenue Suite 101 Coral Gables, Florida 33134 T: 305.448.4200 CMA Design Studio, Inc

Pg.36

Hibiscus Residence
190/184 S Hibiscus Drive
Miami Beach, FL 33139
TITLE: DEMOLITION PLAN

SEAL

SHEET NO.: D1.0

©2021 THIS DRAWING IS THE PROPERTY OF CMA DESIGN STUDIO INC. AND MAY NOT BE REPRODUCED OR USED WITHOUT WRITTEN PERMISSION. CONTRACTOR SHALL VERIFY ALL DIMENSIONS AT SITE BEFORE PROCEEDING WITH WORK


A1.1

		SINGLE FAMILY RES	SIDENTIAL - ZONING DATA SHEET	
TEM #	ZONING INFORMATION			
1.	ADDRESS:	190 S HIBISCUS DRIVE,	MIAMI BEACH, FL, 33139 + 184 S HIBISCUS DRIVE, MIAMI BEACH	FL, 33139
2.	FOLIO NUMBER(S):	02-3232-006-0870, 02-32	32-006-0860	
3.	BOARD AND FILE NUMBERS:	DRB 21-0667		
4.	YEAR BUILT:	1939 & 1993	ZONING DISTRICT:	RS-3
5.	BASED FLOOD ELEVATION:	AE: 10.00' NGVD	GRADE VALUE IN NGVD:	6.39' NGVD
6.	ADJUSTED GRADE	8.20' NGVD	FREE BOARD:	+1'-0": 11.00 NGVD
7.	LOT AREA:	21,000 SF		
8.	LOT WIDTH:	120'	LOT DEPTH:	175' TO SEAWALL (OR 195')
9.	MAX LOT COVERAGE SF AND %:	6,300 SF (30%)	PROPOSED LOT COVERAGE SF AND %:	3,297 SF (15.7%)
10.	EXISTING LOT COVERAGE SF AND %:	N/A	LOT COVERAGE DEDUCTED (GARAGE-STORAGE) SF:	500 SF
11.	FRONT YARD OPEN SPACE SF. AND %:	2,392 (66.4%)	REAR YARD OPEN SPACE SF AND %:	2,495 SF (79.2%)
12.	MAX. UNIT SIZE SF. AND %:	10,500 SF (50%)	PROPOSED UNIT SIZE SF AND %:	3,757 SF (17.9%)
13.	EXISTING FIRST FLOOR UNIT SIZE:	N/A	PROPOSED FIRST FLOOR UNIT SIZE	2,507 SF
14.	EXISTING SECOND FLOOR UNIT SIZE:	N/A	PROPOSED SECOND FLOOR VOLUMETRIC UNIT SIZE SF AND %	2,126 SF (10.1%)
15.			PROPOSED SECOND FLOOR UNIT SIZE SF AND %:	1,250 SF (5.9%)
16.			PROPOSED ROOF DECK AREA SF AND & (NOTE: MAX IS 25% OF THE ENCLOSED FLOOR AREA IMMEDIATELY BELOW):	N/A

		REQUIRED	EXISTING	PROPOSED	DEFICIENCIES
17.	HEIGHT:				
	FLAT ROOF:	24'-0"	N/A	N/A	N/A
	SLOPED ROOF:	27'-0"	N/A	28'-11"	1'-11 (WAIVER REQUESTED)
18.	SETBACKS:				
19.	FRONT FIRST LEVEL:	20'-0 (MIN.)	N/A	20'-0	N/A
20.	FRONT SECOND LEVEL:	40'-0 (MIN.)	N/A	76'-11"	N/A
21.	SIDE 1 (NORTH WEST):	25% WIDTH COMBINED	N/A	13'-4"	N/A
22.	SIDE 2 (SOUTH EAST) OR (FACING STREET):	25% WIDTH COMBINED	N/A	16'-8"	N/A
23.	REAR:	15% LOT DEPTH (175'): 26'-3"	N/A	31'-2"	N/A
	ACCESSORY STRUCTURE SIDE 1:	7'-6"	N/A	7'-6"	N/A
24.	ACCESSORY STRUCTURE SIDE 2 OR FACING STREET:	7'-6"	N/A	104'-2"	N/A
25.	ACCESSORY STRUCTURE REAR:	13'-1 ½"	N/A	13'-1 ½"	N/A
26.	SUM OF SIDE YARD:	30'-0"	N/A	30'-0"	N/A
27.	LOCATED WITHIN A LOCAL HISTORIC DISTR	ICT?	NO		
28.	DESIGNATED AS AN INDIVIDUAL HISTORIC S RESIDENCE SITE?	SINGLE FAMILY	NO		
29.	DETERMINED TO BE ARCHITECTURALLY SIG	NIFICANT?	YES, DUE TO YEAR OF CONS	TRUCTION	



DRB SET 05.10.21

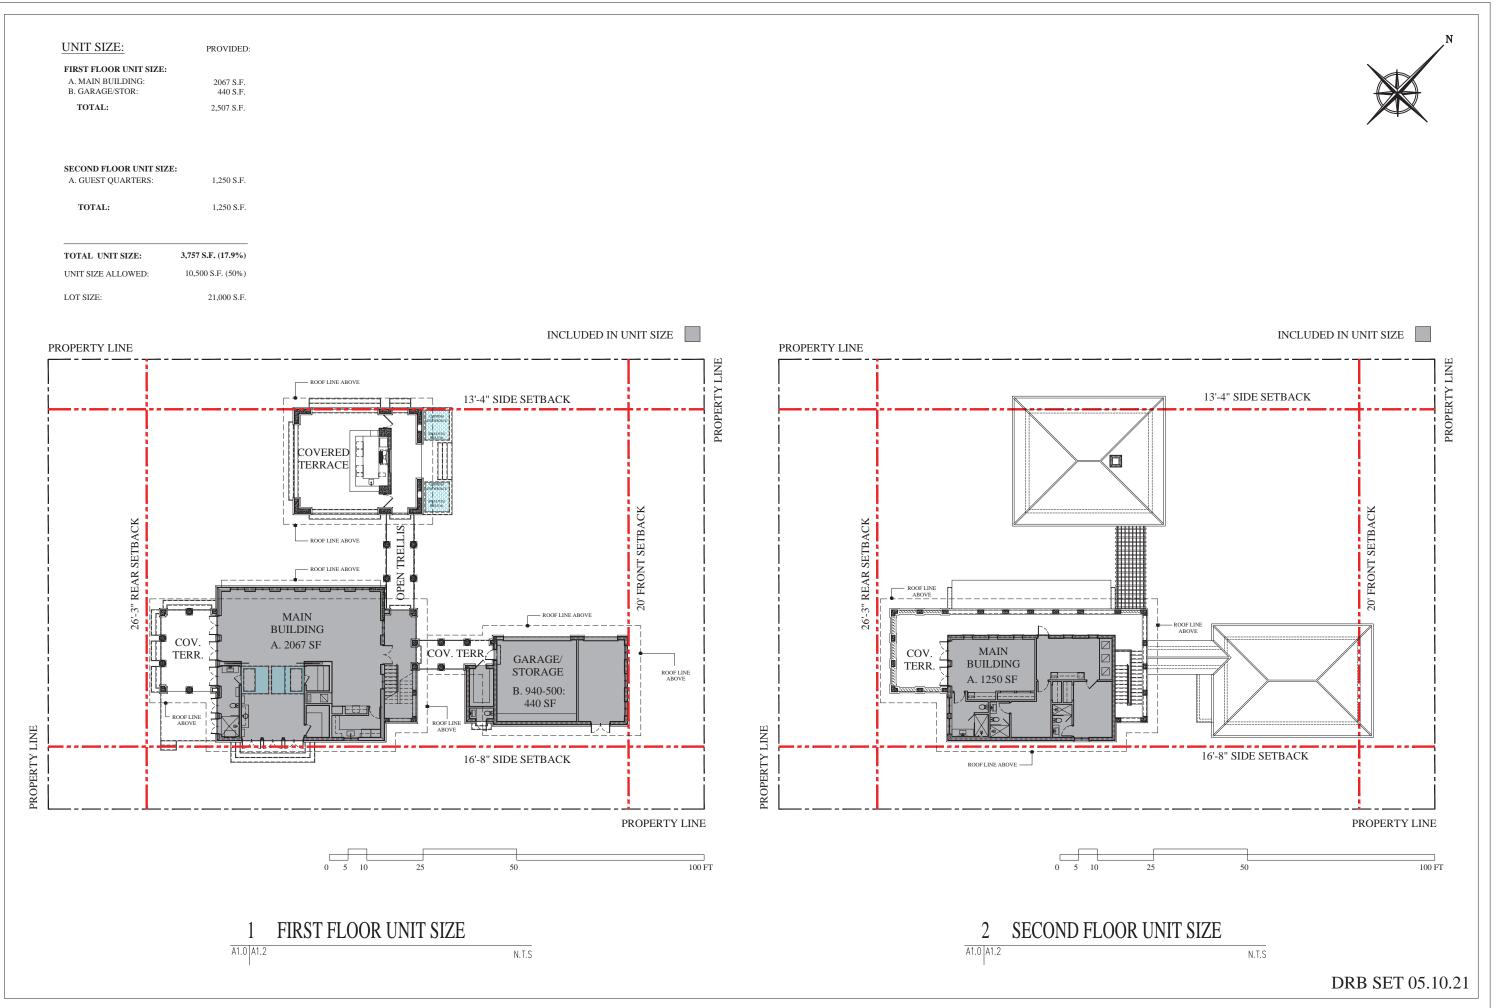

ARCHITECTURE PLANNING INTERIOR DESIGN 232 Andalusia Avenue Suite 101 Coral Gables, Florida 33134 T: 305.448.4200 CMA Design Studio, Inc

Hibiscus Residence 190/184 S Hibiscus Drive Miami Beach, FL 33139 TITLE: UNIT SIZE

SEAL


Lynsie Christine Conn FL Architect AR99059 AA26000730

SHEET NO.:

LOT COVERAGE: PROVIDED: A. MAIN BUILDING: B. GARAGE/STOR: C. COVERED TERRACE/BBQ: 440 S.F. 421 S.F. D. COVERED TERRACE.: 218 S.F. E. COVERED TERRACE.: F. ACCESSORY STRUCTURE: 80 S.F. 71 S.F. TOTAL: 3,297 S.F.

> TOTAL LOT COVERAGE: 3,297 S.F. (15.7%) LOT COVERAGE ALLOWED: 6,300 S.F. (30%)

INCLUDED IN LOT COVERAGE

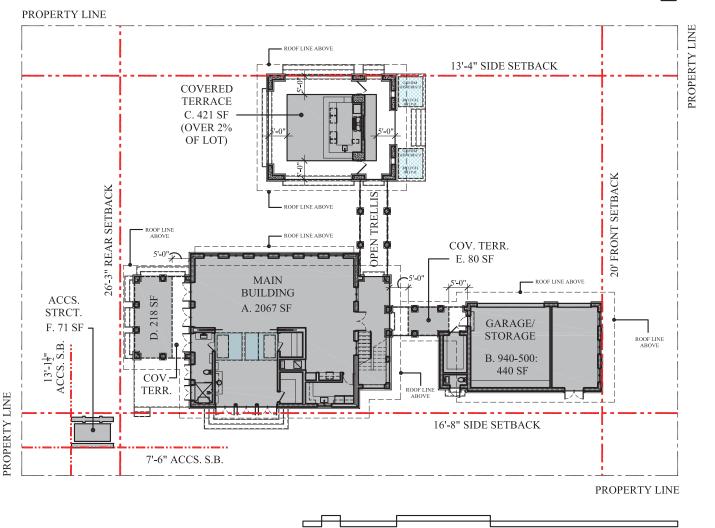



DRB SET 05.10.21

Pg.39

ARCHITECTURE PLANNING INTERIOR DESIGN 232 Andalusia Avenue Suite 101 Coral Gables, Florida 33134 T: 305.448.4200

CMA Design Studio, Inc

Hibiscus Residence
190/184 S Hibiscus Drive
Miami Beach, FL 33139
TITLE: LOT COVERAGE

SEAL Lynsie Christine Conn FL Architect AR99059 AA26000730

SHEET NO.:

CMA Design Studio, Inc.

ARCHITECTURE PLANNING INTERIOR DESIGN
232 Andalusia Avenue Suite 101 Coral Gables, Florida 33134 T: 305.448.4200

Hibiscus Residence
190/184 S Hibiscus Drive
Miami Beach, FL 33139
TITLE: AXONOMETRIC VOLUME STUDY

SEAL

SHEET NO.:

REAR YARD PERVIOUS AREAS:

(70% REQUIRED)

A. 2135 S.F. B. 360 S.F.


TOTAL PERVIOUS AREA: 2,495 S.F. (79.2%) TOTAL REAR YARD AREA: 3,150 S.F. FRONT YARD PERVIOUS AREAS: (50% REQUIRED)

A. 607 S.F. B. 1785 S.F.

TOTAL PERVIOUS AREA: 2,392 S.F. (66.4%) TOTAL FRONT YARD AREA: 3,600 S.F.

FRONT/REAR YARDS PERVIOUS AREA

POOL AREA

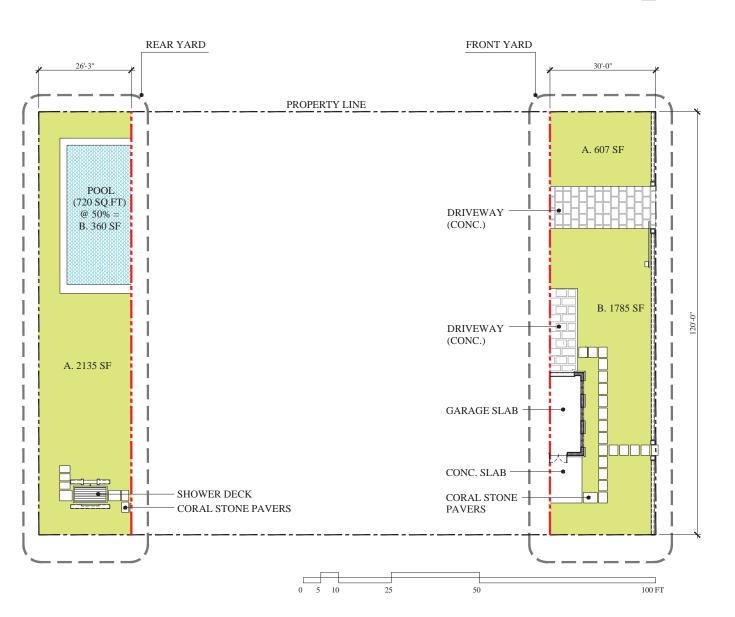

YARD OPEN SPACE A1.0 A1.5 N.T.S

DRB SET 05.10.21

Hibiscus Residence 190/184 S Hibiscus Drive Miami Beach, FL 33139
TITLE: YARD OPEN SPACE


Pg.41

ARCHITECTURE PLANNING INTERIOR DESIGN 232 Andalusia Avenue Suite 101 Coral Gables, Florida 33134 T: 305.448.4200

CMA Design Studio, Inc.

SEAL

SHEET NO.:

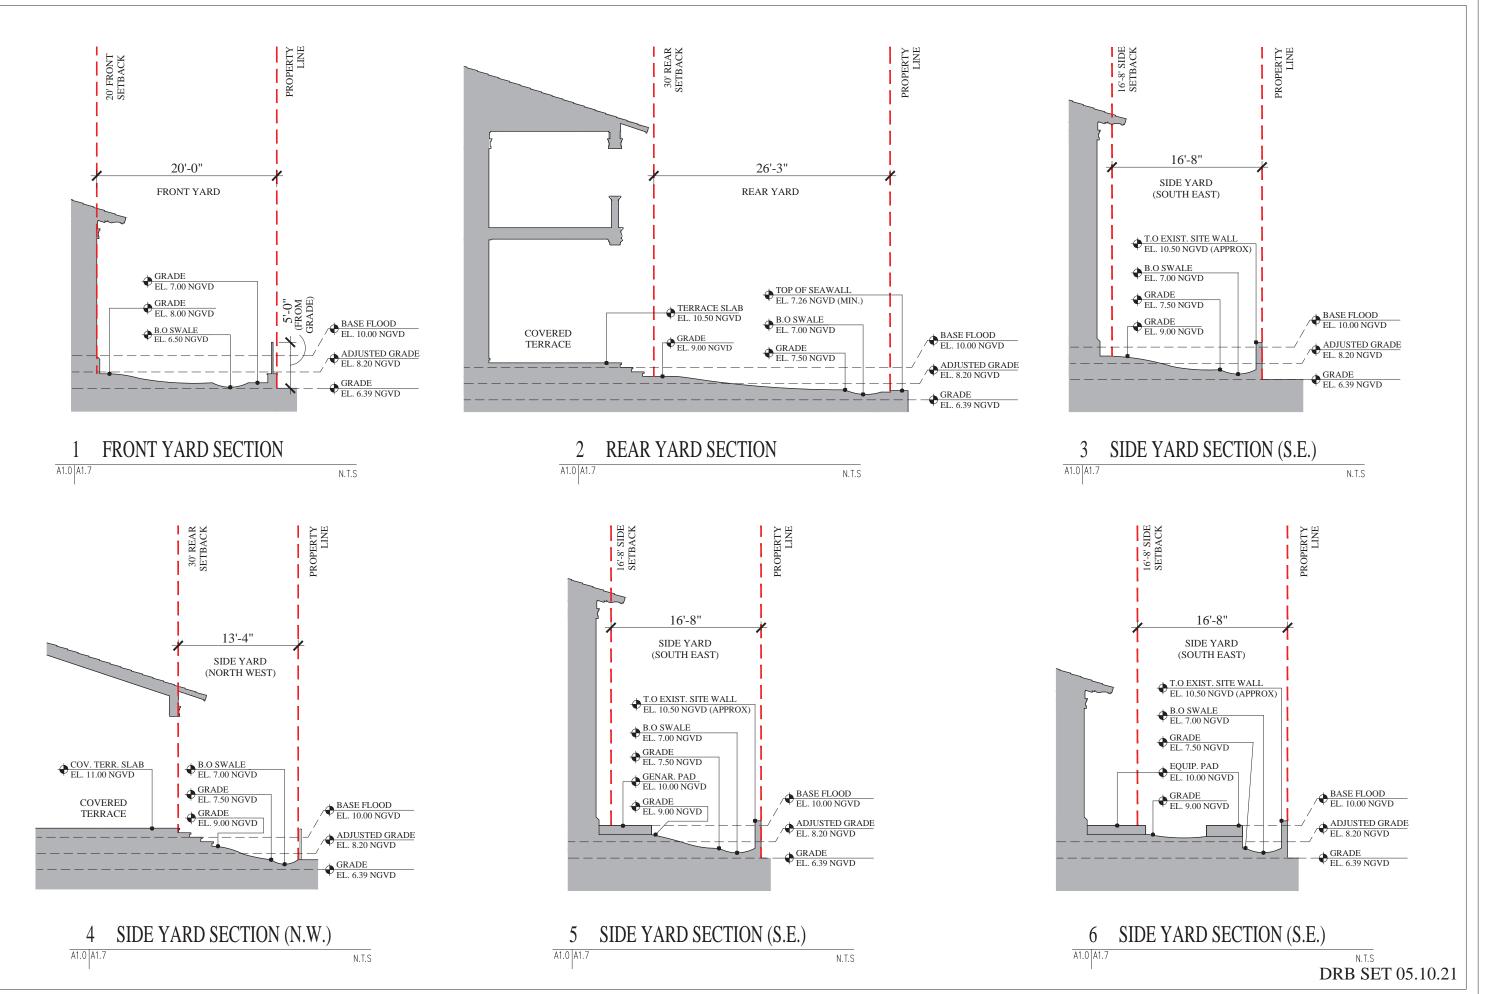


ARCHITECTURE PLANNING INTERIOR DESIGN 232 Andalusia Avenue Suite 101 Coral Gables, Florida 33134 T: 305.448.4200 CMA Design Studio, Inc.

Hibiscus Residence
190/184 S Hibiscus Drive
Miami Beach, FL 33139
: YARD SECTIONS

SEAL Lynsie Christine Conn FL Architect AR99059 AA26000730

SHEET NO.: A1.7

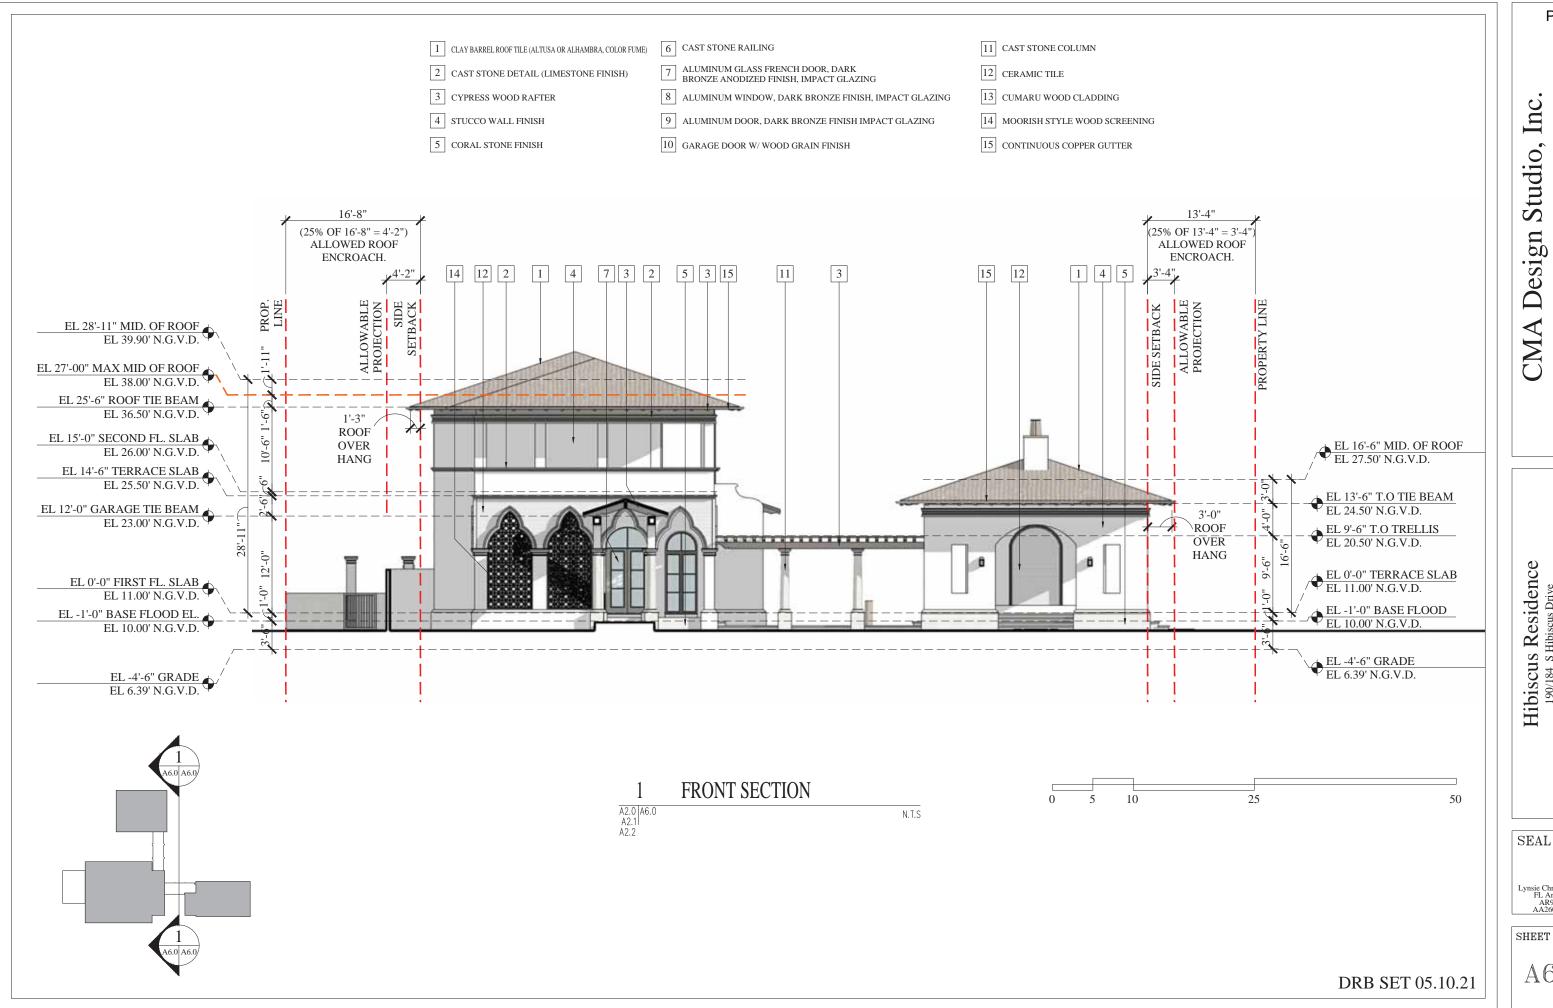


ARCHITECTURE PLANNING INTERIOR DESIGN 232 Andalusia Avenue Suite 101 Coral Gables, Florida 33134 T: 305.448.4200 CMA Design Studio, Inc

Hibiscus Residence 190/184 S Hibiscus Drive Miami Beach, FL 33139 FRONT SECTION

Lynsie Christine Conn FL Architect AR99059 AA26000730

SHEET NO.:

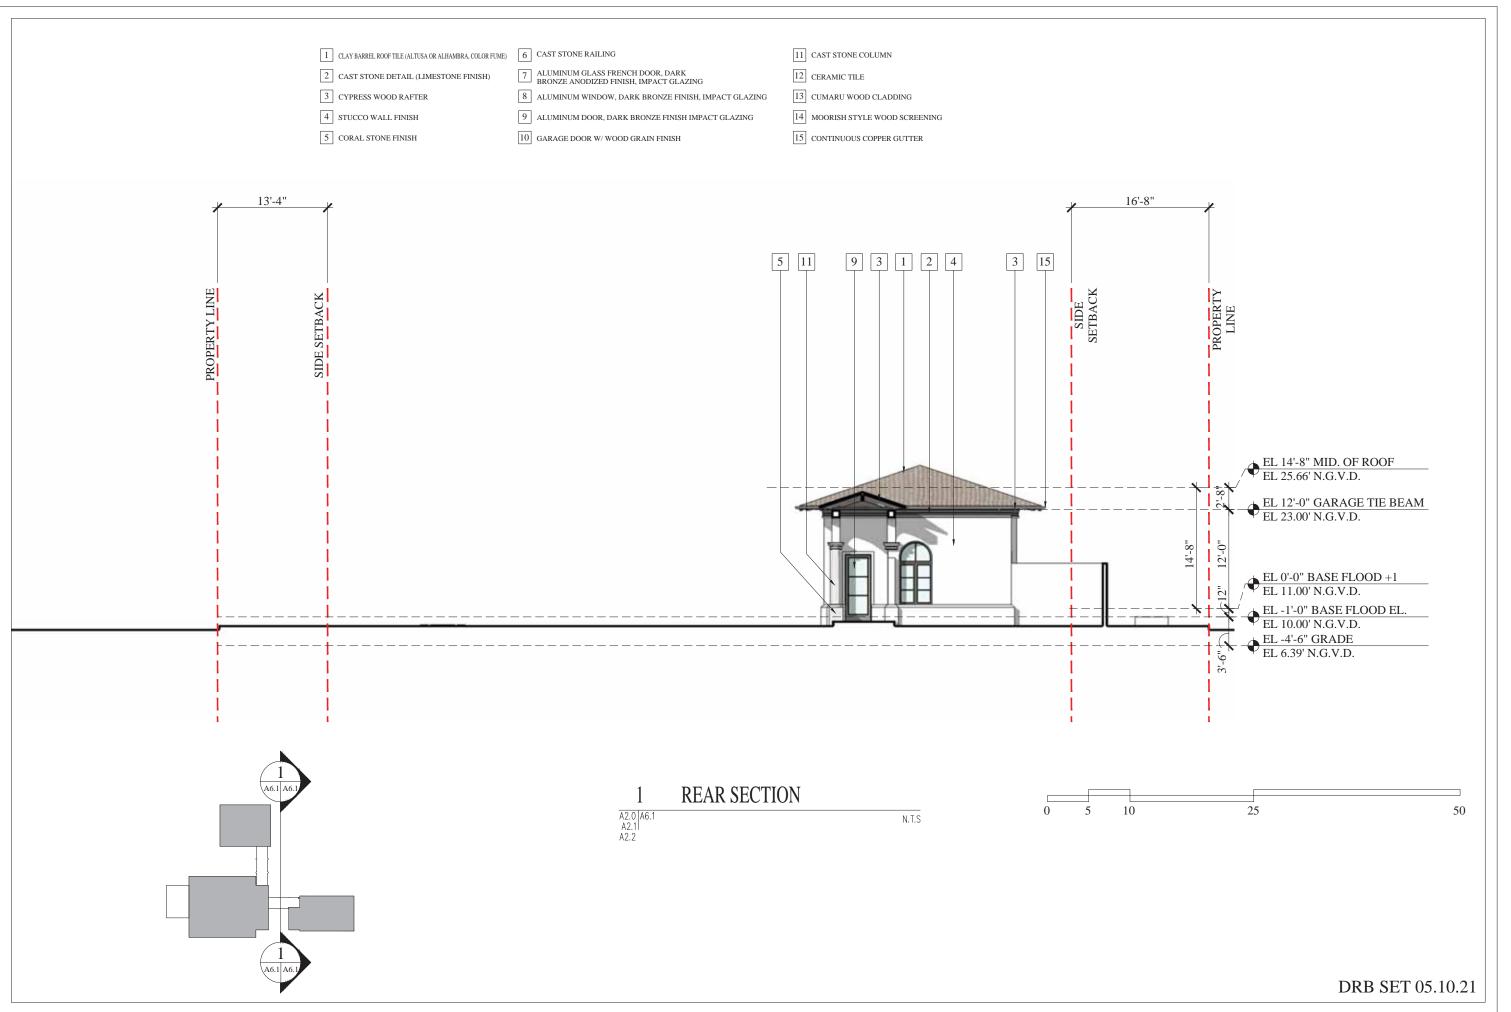


ARCHITECTURE PLANNING INTERIOR DESIGN 232 Andalusia Avenue Suite 101 Coral Gables, Florida 33134 T: 305.448.4200 CMA Design Studio, Inc.

Hibiscus Residence 190/184 S Hibiscus Drive Miami Beach, FL 33139 REAR SECTION

SEAL

SHEET NO.:

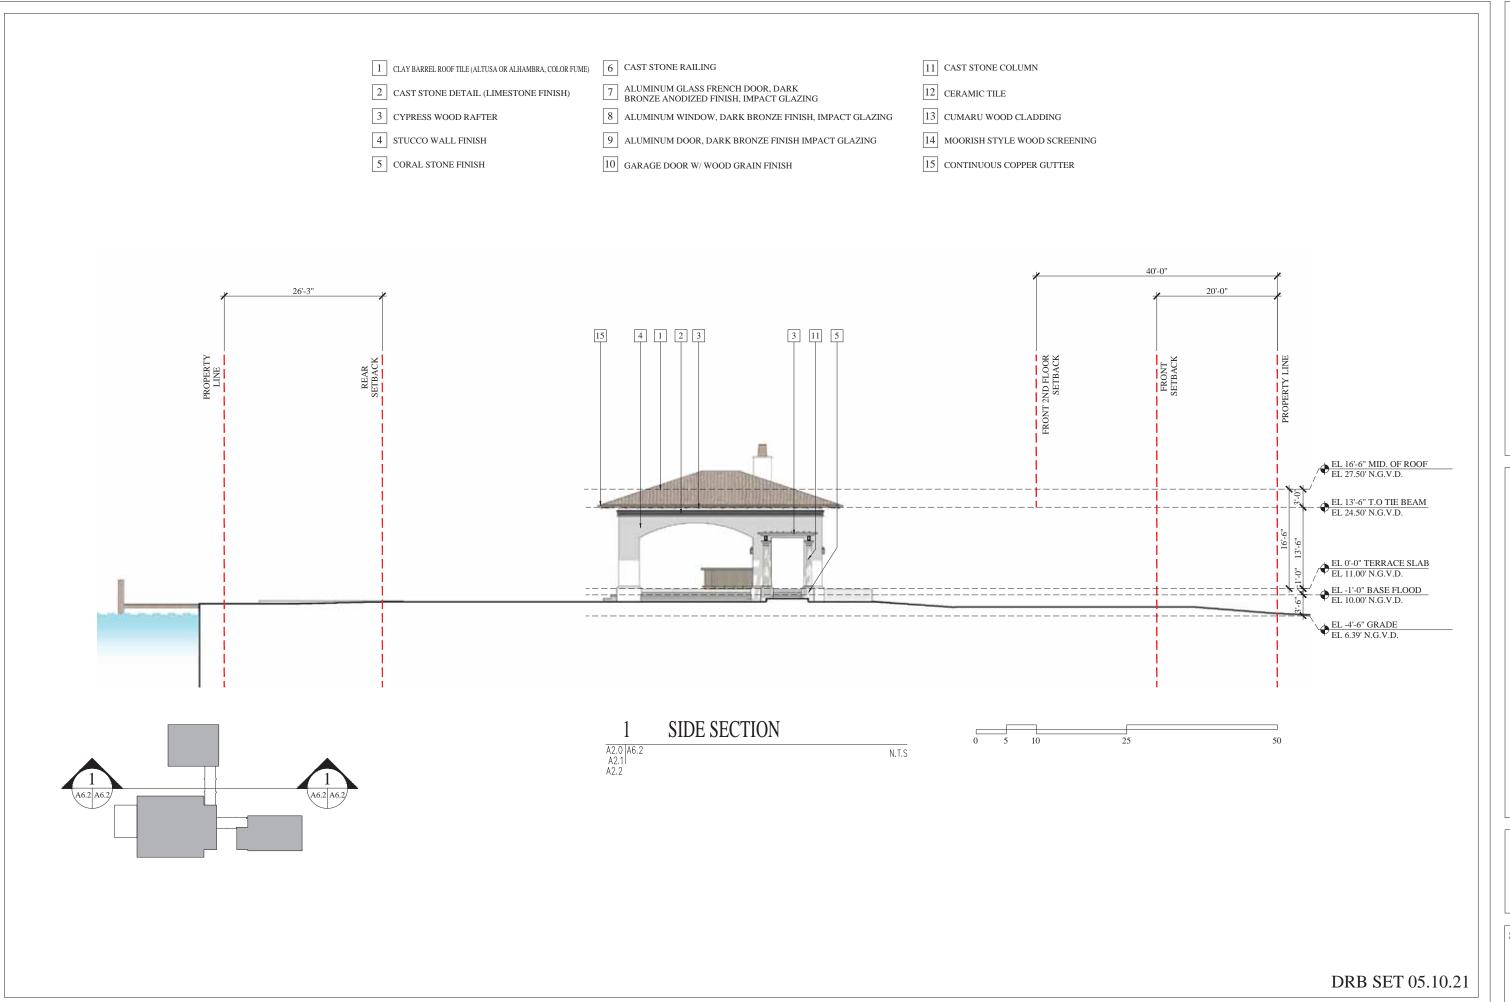


ARCHITECTURE PLANNING INTERIOR DESIGN 232 Andalusia Avenue Suite 101 Coral Gables, Florida 33134 T: 305.448.4200 CMA Design Studio, Inc.

Hibiscus Residence
190/184 S Hibiscus Drive
Miami Beach, FL 33139
SIDE SECTION

SEAL

Lynsie Christine Conn FL Architect AR99059 AA26000730

SHEET NO.:

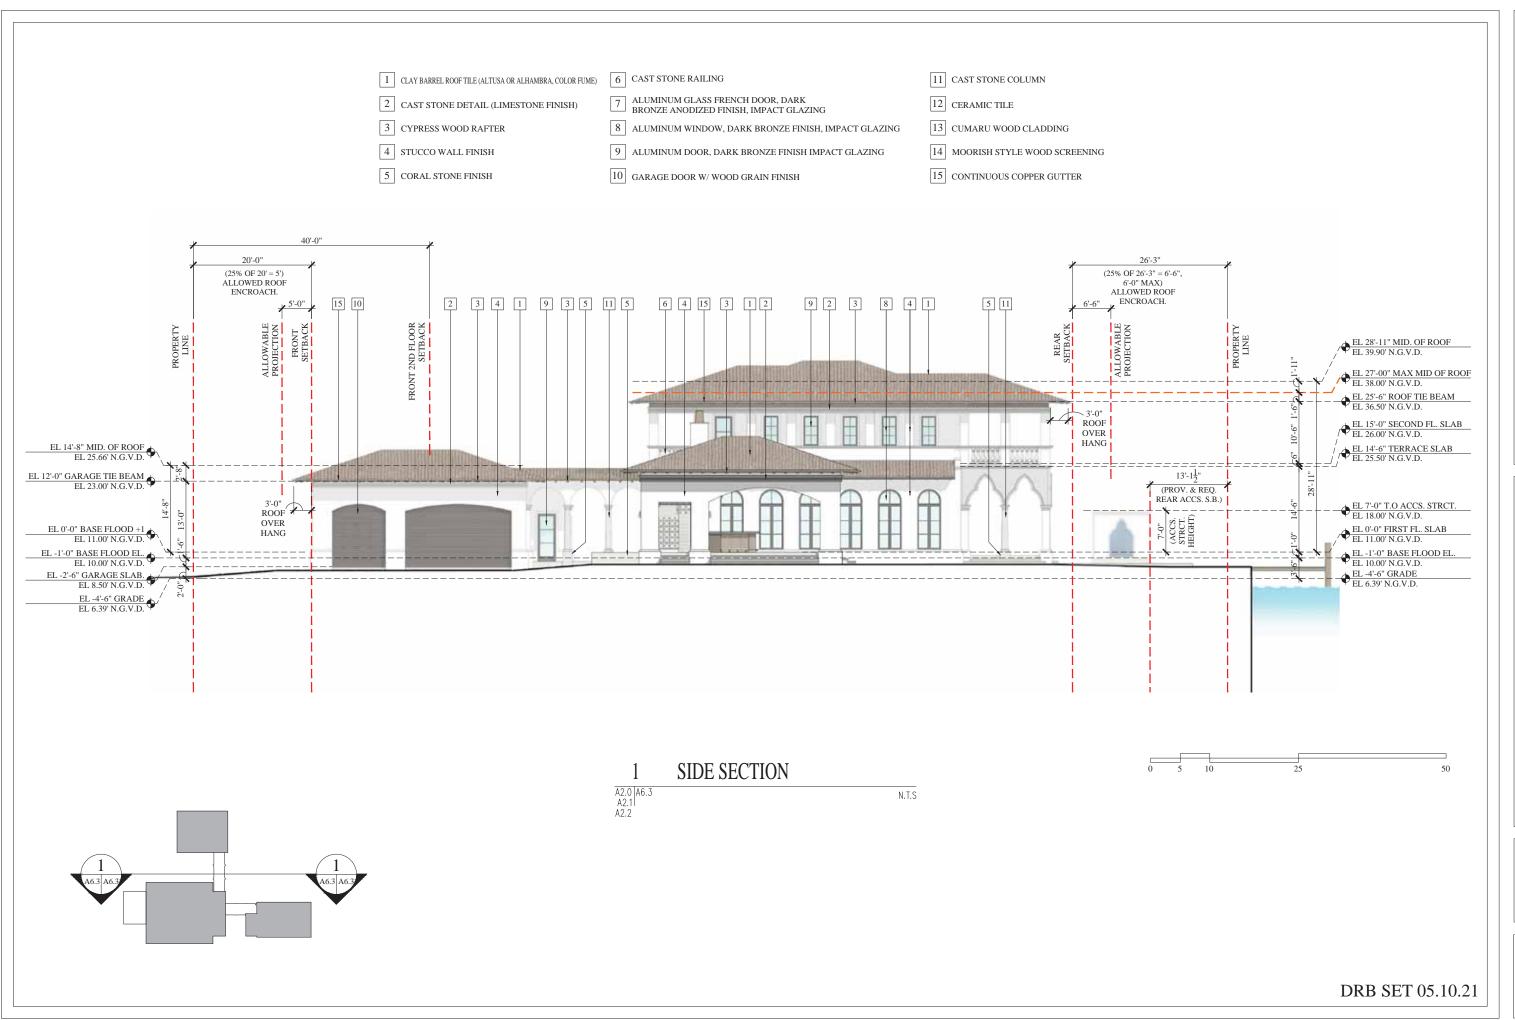

ARCHITECTURE PLANNING INTERIOR DESIGN 232 Andalusia Avenue Suite 101 Coral Gables, Florida 33134 T: 305.448.4200 CMA Design Studio, Inc

Hibiscus Residence 190/184 S Hibiscus Drive Miami Beach, FL 33139 SIDE SECTION

SEAL

Lynsie Christine Conn FL Architect AR99059 AA26000730

SHEET NO.:

THE 190 GARDEN



DATE ISSUE

03.22.2001 COORDINATION
03.26.2021 DRE DRAFT
04.05.2021 DRS Submittel











THE 190 GARDEN





	THE PERSONNELSE
DATE	ISSUE
Al'air bear	











THE 190 GARDEN












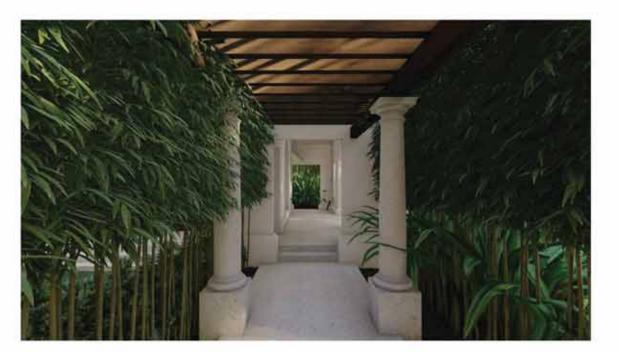

REFERENCE IMAGERY



























AND



THE PLANTING PLAN PROPOSES TO MITIGATE WITH THE FOLLOWING STRATEGY:

(15) TREES 4 IN. DBH. x 8 FT. SPR. x 16 FT. HT.

(25) TREES 2 IN. DBH. x 4 FT. SPR. x 12 FT. HT.

REFER TO SHEET L700 & L701 FOR MITIGATION TREES & PALMS SPECIES, SPECIFICATIONS, AND LAYOUT.

MITIGATION NOTES

THE PROPOSED LANDSCAPE PLAN MUST MITIGATE THE REMOVAL OF 53.5 DBH. INCHES OF TREES REMOVED AND 8 PALMS WITH A TOTAL OF:

(22) TREES 4 IN. DBH. x 8 FT. SPR. x 16 FT. HT.

OFL/

(43) TREES 2 IN. DBH. x 4 FT. SPR. x 12 FT. HT.

NO MITIGATION REQUIRED FOR REMOVAL OF INVASIVE TREES.

TOTAL REMOVALS

- O TREES REMOVED WITH A TOTAL OF O DBH. INCHES REMOVED
 21 PALMS REMOVED
 O INVASIVE TREES REMOVED

BOTANICAL NAME

TREE DISPOSITION SCHEDULE

.1	LIVISTONA CHINENSIS	CHINESE FAN PALM	10°	30	18	REMOVE	PLANT MATERIAL DOES NOT CORRESPOND WITH PROPOSED PLANT COMPOSITION
2	LIMSTONA CHINENSIS	CHINESE FAN PALM	127	28	18'	REMOVE	PLANT MATERIAL DOES NOT CORRESPOND WITH PROPOSED PLANT COMPOSITION
3	LIVISTONA CHINENSIS	CHINESE FAN PALM	11*	25	16	REMOVE	PLANT MATERIAL DOES NOT CORRESPOND WITH PROPOSED PLANT COMPOSITION
4	LIVISTONA CHINENSIS	CHINESE FAN PALM	11"	18'	18/	REMOVE	PLANT MATERIAL DOES NOT CORRESPOND WITH PROPOSED PLANT COMPOSITION
5	LIMISTONA CHINENSIS	CHINESE FAN PALM	140	187	20'	REMOVE	PLANT MATERIAL DOES NOT CORRESPOND WITH PROPOSED PLANT COMPOSITION
6	LIVISTONA CHINENSIS	CHINESE FAN PALM	10"	14"	13	REMOVE	PLANT MATERIAL DOES NOT CORRESPOND WITH PROPOSED PLANT COMPOSITION
7	LIVISTONA CHINENSIS	CHINESE FAN PALM	10*	18	15	REMOVE	PLANT MATERIAL DOES NOT CORRESPOND WITH PROPOSED PLANT COMPOSITION
8	COCOS NUCIFERA	COCONUT PALM	101	30"	24	RELOCATE	LOCATION OF PLANT MATERIAL CONFLICTS WITH CONSTRUCTION ENVELOPE.
9	COCOS NUCIFERA	COCONUT PALM	14"	40	24"	RELOCATE	LOCATION OF PLANT MATERIAL CONFLICTS WITH CONSTRUCTION ENVELOPE
10	COCOS NUCIFERA	COCONUT PALM	14"	40	23	BELOCATE	LOCATION OF PLANT MATERIAL CONFLICTS WITH CONSTRUCTION ENVELOPE
11	COCOS NUCIFERA	COCONUT PALM	14"	40	23'	RELOCATE	LOCATION OF PLANT MATERIAL CONFLICTS WITH CONSTRUCTION ENVELOPE
12	COCOS NUCIFERA	COCONUT PALM	14"	40	23	RELOCATE	LOCATION OF PLANT MATERIAL CONFLICTS WITH CONSTRUCTION ENVELOPE
13	ROYSTONEA REGIA	BOYAL PALM	24"	45"	20	RELOCATE	LOCATION OF PLANT MATERIAL CONFLICTS WITH CONSTRUCTION ENVELOPE
14	ROYSTONEA REGIA	BOYAL PALM	24"	35	20	RELOCATE	LOCATION OF PLANT MATERIAL CONFLICTS WITH CONSTRUCTION ENVELOPE
15	ROYSTONEA REGIA	ROYAL PALM	201	35	20'	RELOCATE	LOCATION OF PLANT MATERIAL CONFLICTS WITH CONSTRUCTION ENVELOPE
16	COCOS NUCIFERA	COCONUT PALM	10	15'	20'	RELOCATE	LOCATION OF PLANT MATERIAL CONFLICTS WITH CONSTRUCTION ENVELOPE
17	ROYSTONEA REGIA	BOYAL PALM	18	40	20	BELOCATE	LOCATION OF PLANT MATERIAL CONFLICTS WITH CONSTRUCTION ENVELOPE
18	COCOS NUCIFERA	COCONUT PALM	10"	25	20'	BELOCATE	LOCATION OF PLANT MATERIAL CONFLICTS WITH CONSTRUCTION ENVELOPE
19	COCOS NUCIFERA	COCONUT PALM	10"	40	20'	RELOCATE	LOCATION OF PLANT MATERIAL CONFLICTS WITH CONSTRUCTION ENVELOPE
20	COCOS NUCIFERA	COCONUT PALM	10"	35"	20'	BELOCATE	LOCATION OF PLANT MATERIAL CONFLICTS WITH CONSTRUCTION ENVELOPE
21	COCOS NUCIFERA	COCONUT PALM	10"	30	50	RELOCATE	LOCATION OF PLANT MATERIAL CONFLICTS WITH CONSTRUCTION ENVELOPE.
22	COCOS NUCIFIERA	COCONUT PALM	10"	30	20'	BELOCATE	LOCATION OF PLANT MATERIAL CONFLICTS WITH CONSTRUCTION ENVELOPE
23	COCOS NUCIFERA	COCONUT PALM	9*	30	20'	RELOCATE	LOCATION OF PLANT MATERIAL CONFLICTS WITH CONSTRUCTION ENVELOPE
24	COCOS NUCIFERA	COCONUT PALM	9"	30	:20'	RELOCATE	LOCATION OF PLANT MATERIAL CONFLICTS WITH CONSTRUCTION ENVELOPE
25	COCOS NUCIFERA	COCONUT PALM	9*	30	20"	RELOCATE	LOCATION OF PLANT MATERIAL CONFLICTS WITH CONSTRUCTION ENVELOPE
26	COCOS NUCIFERA	COCONUT PALM	9"	30	20'	RELOCATE	LOCATION OF PLANT MATERIAL CONFLICTS WITH CONSTRUCTION ENVELOPE
27	COCOS NUCIFERA	COCONUT PALM	9°	30	20'	BELOCATE	LOCATION OF PLANT MATERIAL CONFLICTS WITH CONSTRUCTION ENVELOPE
28	ADONIDIA MERRILLII	CHRISTMAS PALM	4"	15	12"	REMOVE	PLANT MATERIAL DOES NOT CORRESPOND WITH PROPOSED PLANT COMPOSITION
29	ADONIDIA MERRILLII	CHRISTMAS PALM	4"	157	12'	REMOVE	PLANT MATERIAL DOES NOT CORRESPOND WITH PROPOSED PLANT COMPOSITION
38	ADONIDIA MERRILLII	CHRISTMAS PALM	4.	15"	12	REMOVE	PLANT MATERIAL DOES NOT CORRESPOND WITH PROPOSED PLANT COMPOSITION
31	ADONIDIA MERRILLII	CHRISTMAS PALM	K.	15	12'	REMOVE	PLANT MATERIAL DOES NOT CORRESPOND WITH PROPOSED PLANT COMPOSITION
32	HYOPHORBE VERSCHAFFELTIL	SPINOLE PALM	10"	5'	2	REMOVE	PLANT MATERIAL DOES NOT CORRESPOND WITH PROPOSED PLANT COMPOSITION
33	ADONIDIA MERRILLII	CHRISTMAS PALM	4"	12"	8	REMOVE	PLANT MATERIAL DOES NOT CORRESPOND WITH PROPOSED PLANT COMPOSITION
34	ADONIDIA MEBRILLII	CHRISTMAS PALM	4"	12	8'	REMOVE	PLANT MATERIAL DOES NOT CORRESPOND WITH PROPOSED PLANT COMPOSITION
35	ADOMDIA MERRILLII	CHRISTMAS PALM	4"	12	8'	REMOVE	PLANT MATERIAL DOES NOT CORRESPOND WITH PROPOSED PLANT COMPOSITION
36	SYAGRIUS BOMANZOFFIANA	QUEEN PALM	8"	15	12"	REMOVE	PLANT MATERIAL DOES NOT CORRESPOND WITH PROPOSED PLANT COMPOSITION
37	HYOPHORBE VERSCHAFFELTII	SPINDLE PALM	10"	7	10'	REMOVE	PLANT MATERIAL DOES NOT CORRESPOND WITH PROPOSED PLANT COMPOSITION
38	SYAGRUS ROMANZOFFIANA	QUEEN PALM	8"	15	12'	REMOVE	PLANT MATERIAL DOES NOT CORRESPOND WITH PROPOSED PLANT COMPOSITION
39	SYAGRUS ROMANZOFFIANA	QUEEN PALM	8°	15'	12'	REMOVE	PLANT MATERIAL DOES NOT CORRESPOND WITH PROPOSED PLANT COMPOSITION
40	SYAGRUS BOMANZOFFIANA	QUEEN PALM	8"	15	12	REMOVE	PLANT MATERIAL DOES NOT CORRESPOND WITH PROPOSED PLANT COMPOSITION
41	HYOPHORBE VERSCHAFFELTII	SPINDLE PALM	10"	7"	41	REMOVE	PLANT MATERIAL DOES NOT CORRESPOND WITH PROPOSED PLANT COMPOSITION

DBH, HT. SPREAD ACTION NOTES



www.mielsemlandarch.com

THE 190 GARDEN

SEAL IS TYLER NIELSEN - LANSSTORY)



TREE DISPOSITION SCHEDULE

(SSUE)

89.22.2021 COOPENATION 01.36.2021 CRB DEAFT 94.05.2021 CRB Submittel

L102

landscape architects 357 cypress drive, 10 tequesta, fl 33469 561.402.9414

www.nielsenlandarch.com

THE 190 GARDEN


SEAL (S TYLER NIELSEN - LA6667067)



TREEDISPO	SITION PLAN	
DATE	ISSUE	
03 22 2021	COORDINATION	
03 26 2021	DRB DRAFT	



TREE DISPOSITION LEGEND

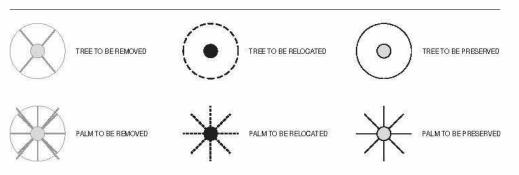

#	BOTANICAL NAME	COMMON NAME	ACTION	22	COCOS NUCIFERA	COCONUTPALM	RELOCATE
1	LIVISTO NA CHINENSIS	CHINESE FAN PALM	REMOVE	23	COCOS NUCIFERA	COCONUTPALM	RELOCATE
2	LIVISTO NA CHINENSIS	CHINESE FAN PALM	REMOVE	24	COCOS NUCIFERA	COCONUTPALM	RELOCATE
3	LIVISTO NA CHINENSIS	CHINESE FAN PALM	REMOVE	25	COCOS NUCIFERA	COCONUT PALM	RELOCATE
4	LIVISTO NA CHINENSIS	CHINESE FAN PALM	REMOVE	26	COCOS NUCIFERA	COCONUT PALM	RELOCATE
5	LIVISTO NA CHINENSIS	CHINESE FAN PALM	REMOVE	27	COCOS NUCIFERA	COCONUTPALM	RELOCATE
6	LIVISTO NA CHINENSIS	CHINESE FAN PALM	REMOVE	28	ADO NIDIA MERRILLII	CHRISTMAS PALM	REMOVE
7	LIVISTO NA CHINENSIS	CHINESE FAN PALM	REMOVE	29	ADONIDIA MERRILLII	CHRISTMAS PALM	REMOVE
8	COCOS NUCIFERA	COCONUT PALM	RELOCATE	30	ADO NIDIA MERRILLII	CHRISTMAS PALM	REMOVE
9	COCOS NUCIFERA	GOGONUT PALM	RELOCATE	31	ADONIDIA MERRILLII	CHRISTMAS PALM	REMOVE
10	COCOS NUCIFERA	COCONUT PALM	RELOCATE	32	HYOPHORBE VERSCHAFFELTII	SPINDLE PALM	REMOVE
11	COCOS NUCIFERA	COCONUT PALM	RELOCATE	33	ADO NIDIA MERRILLII	CHRISTMAS PALM	REMOVE
12	GOGOS NUCIFERA	COCONUT PALM	RELOCATE	34	ADO NIDIA MERRILLII	CHRISTMAS PALM	REMOVE
13	POYSTONEA REGIA	ROYAL PALM	RELOCATE	35	ADO NIDIA MERRILLII	CHRISTMAS PALM	REMOVE
14	POYSTONEA REGIA	ROYAL PALM	RELOCATE	36	SYAGRUS ROMANZOFFIANA	QUEEN PALM	REMOVE
15	POYSTONEA REGIA	ROYAL PALM	RELOCATE	37	HYOPHORBE VERSCHAFFELTII	SPINDLE PALM	REMOVE
16	COCOS NUCIFERA	COCONUT PALM	RELOCATE	38	SYAGRUS ROMANZOFFIANA	QUEEN PALM	REMOVE
17	ROYSTONEA REGIA	ROYAL PALM	RELOCATE	39	SYAGRUS ROMANZOFFIANA	QUEEN PALM	REMOVE
18	COCOS NUCIFERA	COCONUT PALM	RELOCATE	40	SYAGRUS ROMANZOFFIANA	QUEEN PALM	REMOVE
19	COCOS NUCIFERA	GOCONUT PALM	RELOCATE	41	HYOPHORBE VERSCHAFFELTII	SPINDLE PALM	REMOVE
20	COCOS NUCIFERA	COCONUT PALM	RELOCATE			mts-ssc st-standiscu-sc (138)	
21	COCOS NUCIFERA	GOGONUT PALM	RELOCATE				



PRE-CAST PAVER

NATURAL FLAMED FINISH: DIMENSIONS: TOO SOURCE:



DOMINICAN CORAL STONE

NATURAL COLOR: FINISH: BRUSHED DIMENSIONS: TEO SOURCE:



RICE ROCK GRAVEL

WHITE COLOR: ANGULAR FINISH: DIMENSIONS: 3/8 IN. SOURCE: YARDCO



BASALT STONE VENEER

COLOR: NATURAL FINISH: RACKED DIMENSIONS: TEO SOURCE TBD




PERUVIAN BEACH PEBBLES

COLOR: GRAY FINISH: NATURAL DIMENSIONS: RE: DETAILS SOURCE: YARDOO



IPE

COLOR: NATURAL FINISH: TBD DIMENSIONS: 1 IN. x 8 IN. SOURCE: TEO

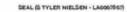


THE 190 GARDEN



MATERIALS REFERENCES DATE ISSUE


03.22.2021 COORDINATION 03.26.2021 GRIEDRAFT 04.06.2021 GRIE Salement

SOALE AS NOTED

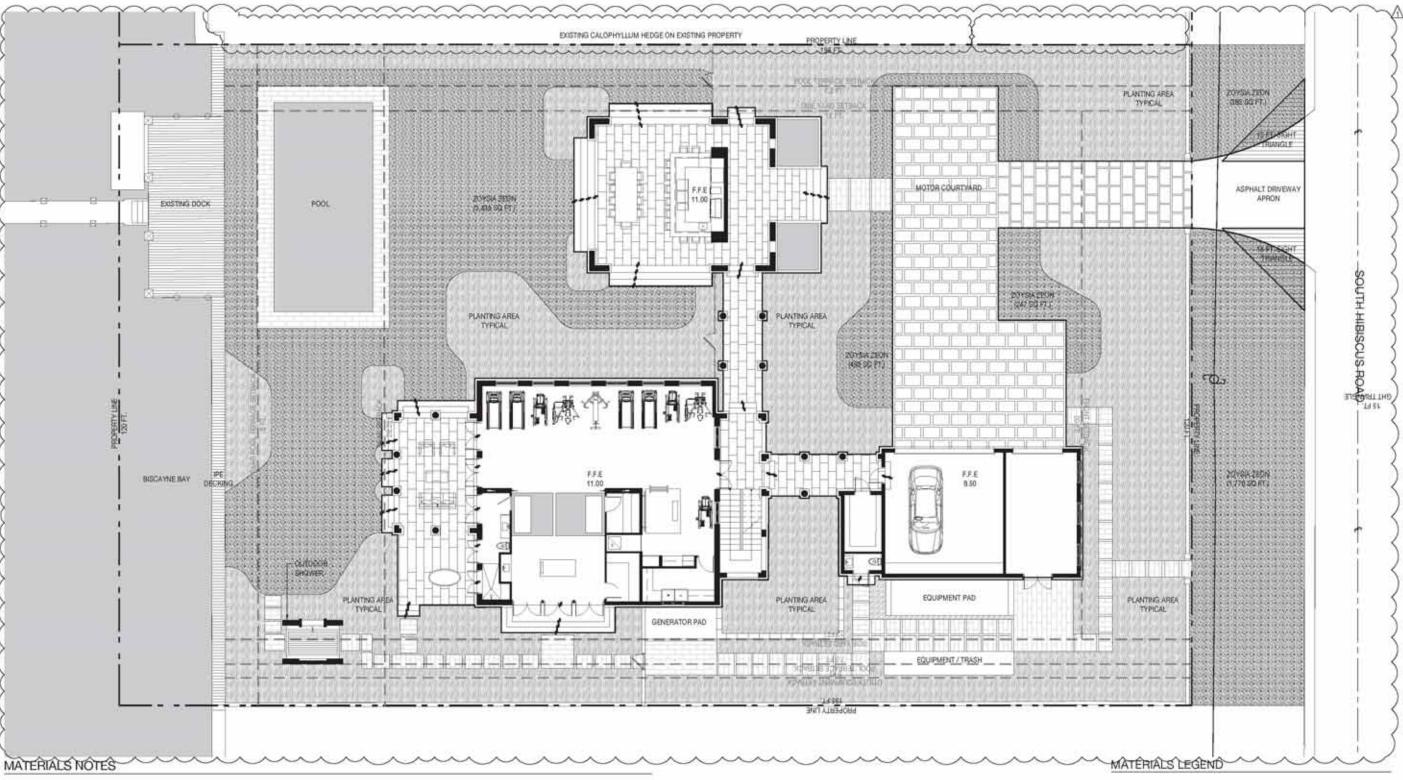

- CONTRACTOR TO VERIFY ALL QUANTITIES, IN CASE OF ANY DISCREPANCIES, GRAPHICALLY SHOWN MATERIAL QUANTITIES SHALL TAKE PRECEDENCE.
- ALL CONSTRUCTION AND MATERIALS NOT SPECIFICALLY ADDRESSED IN THE CONTRACT DOCUMENTS OR SPECIFICATIONS SHALL BE IN ACCORDANCE WITH LOCAL, STATE AND FEDERAL JURISDICTIONS AND GOVERNING BIDDIES/AGENCIES STANDARDS.
- THE CONTRACTOR SHALL PROVIDE A FULL-SCALE MOCKUP AND RECEIVE APPROVAL FROM THE LANDSCAPE ARCHITECT FOR ALL SYSTEMS BEFORE BEGINNING CONSTRUCTION OF PAVEMENT.
- 4. EXPANSION JOINTS SHALL BE PROVIDED WHERE FLATWORK MEETS VERTICAL STRUCTURES, SUCH AS WALLS, CURBS, STEPS, AND OTHER HARDSCAPE ELEMENTS. EXPANSION JOINTS SHALL ALSO BE PROVIDED AT MATERIAL CHANGES. EXPANSION JOINT MATERIALS/METHODS SHALL BE SUBMITTED TO THE LANDSCAPE ARCHITECT FOR REVIEW AND APPROVAL PRIOR TO INSTALLATION.
- 6. CONTROL JOINTS SHOULD BE SPACED NO GREATER THAN TEN (10) LINEAR FEET MAXIMUM, UNLESS OTHERWISE SPECIFIED. EXPANSION JOINTS. SHOULD BE SPACED NO GREATER THAN FORTY (40) LINEAR FEET MAXIMUM, UNLESS OTHERWISE SPECIFIED. CONTRACTOR SHALL ADVISE ON OTHER

- JOINTS AS NEEDED TO MINIMIZE CRACKING, THIS INFORMATION SHALL BE SUBMITTED TO THE LANDSCAPE ARCHITECT FOR REVIEW AND APPROVAL PRIOR TO INSTALLATION.
- CONTROL JOINTS SHALL BE PROVIDED AS SPECIFIED IN THE CONTRACT DOCUMENTS. CONTROL JOINT MATERIALS, METHODS AND RECOMMENDATIONS ON ADDITIONAL CONTROL JOINTS TO MINIMIZE. CRACKING SHALL BE SUBMITTED TO THE LANDSCAPE ARCHITECT FOR REVIEW AND APPROVAL.
- ALL STEPS SHALL HAVE TWELVE (12) INCH TREADS AND SIX (6) INCH RISERS, UNLESS OTHERWISE SPECIFIED.
- 8. HOLD TOP OF WALLS AND FENCES LEVEL, UNLESS OTHERWISE SPECIFIED.
- CONTRACTOR SHALL NOT INSTALL WORK LOCATED ON TOP OF ARCHITECTURAL STRUCTURES WITHOUT FIRST REVIEWING ARCHITECTURAL DRAWINGS.
- SAMPLES OF SPECIFIED MATERIALS SHALL BE SUBMITTED TO THE LANDSCAPE ARCHITECT FOR REVIEW AND APPROVAL PRIOR TO ORDERING FOR JOB.

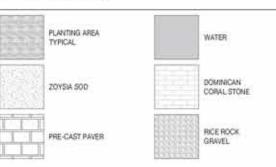



was triel outlandarch.com

190 GARDEN

THE

SEAL (S TYLER NIELSEN - LAGGGTOGT)



05.03.2021 MATERIALS PLAN

EIATE ISSUE

81.22.2021 COORDINATION

93.24.2021 ORB DRAFT

94.09.2021 ORB SUBMITTAL

96.03.2021 REVISION ()



357 cypress drive, 10 tequesta, fl 33469 561.402.9414

www.nielsenlandarch.com

190 GARDE Ξ

SEAL (STYLER NIELSEN - LA6667067)



GRADING PLAN

ISSUE COORDINATION 03 22 2021 03 26 2021 04 05 2021 DRB DRAFT DRB Søbmittal

SPOT ELEVATION

DIRECTION OF WATER FLOW

GRADING NOTES

- VERIFY EXISTING ELEVATIONS PRIOF TO STARTING WORK, NOTIFY LANDSCAPE ARCHITECT OF ANY DISOREPANCIES. EXISTING AND PROPOSED GRADES ARE BASED ON SURVEY DOCUMENTS PREPARED BY
- CONTRACTOR SHALL VERIFY THE PLACEMENT OF FLATWORK PENETRATIONS TO ENSURE COORDINATION OF SURFACE FIXTURES, SUCH AS DRAINS AND LIGHTS NOTIFY GENERAL CONTRACTOR AND LANDSCAPE ARCHITECT OF DISCREPANCIES PRIOR TO CONSTRUCTION OF FLATWORK.
- THE CONTRACTOR SHALL REFER TO 3. THE ARCHITECTURAL DRAWINGS TO VERIFY FINISHED FLOOR ELEVATIONS. THE GENERAL CONTRACTOR AND LANDSCAPE ARCHITECT SHALL BE NOTIFIED IF THERE ARE ANY

DISCREPANCIES PRIOR TO CONSTRUCTION.

- THE CONTRACTOR SHALL REFER TO THE CIVIL ENGINEERING DRAWINGS TO VERIFY UTILITY AND OTHER DRAIN LOCATIONS. THE GENERAL CONTRACTOR AND LANDSCAPE ARCHITECT SHALL BE NOTIFIED OF ANY DISCREPANCIES PRIOR TO CONSTRUCTION
- PROPOSED ELEVATIONS INDICATED ON DRAWINGS ARE FINISHED GRADE ELEVATIONS. THE CONTRACTOR SHALL DIRECT ROUGH GRADE WORK TO ALLOW FOR SUFFICIENT TOPSOIL AND OTHER FINISHED CONDITIONS AS DESCRIBED IN THE CONTRACT DOCUMENTS.
- ALL FINISHED GRADES SHALL MEET AND BLEND SMOOTHLY WITH EXISTING GRADES AT THE PROJECT LIMIT.

- ALL FINISHED GRADES SHALL BE WITHOUT LOW SPOTS OR POCKETS. CONTRACTOR SHALL SET FLOW LINES ACCURATELY AND PROVIDE A MINIMUM OF TWO (2) PERCENT OR MAXIMUM OF FIFTY (50) PERCENT, UNI ESS OTHERWISE NOTED
- ALL FINISHED GRADES SHALL PRESENT SMOOTH TRANSITIONS BETWEEN TOES AND TOPS OF SLOPES.
- THE MAXIMUM SLOPE OF SOD TO BE 3:1 IN AREAS DESIGNATED AS " LAWN," UNLESS OTHERWISE NOTED.
- ALL MANHOLES, VALVE BOXES, UTILITY BOXES AND PEDESTALS, AND OTHER APPURTENANCES SHALL BE ADJUSTED TO FINISH GRADE IN ACCORDANCE WITH THE LOCAL, STATE AND FEDERAL JURISDICTIONS AND GOVERNING BODIES/AGENCIES OR UTILITY RULES

AND REGULATIONS, UNLESS OTHERWISE NOTED.

- SOIL COMPACTION BENEATH PAVEMENTS, STEPS, WALLS AND LIGHT FOUNDATIONS SHALL BE 95% PROCTOR DENSITY MINIMUM, UNLESS OTHERWISE SPECIFIED.
- 12. GRADING AND EXCAVATION WORK SHALL BE COMPLETED DURING DRY WEATHER CONDITIONS.
- THE CONTRACTOR SHALL REMOVE AND STOCKPILE TO PSOIL FOR REUSE ON-SITE, SOIL SHALL BE SCREENED TO REMOVE ROCKS AND BOULDERS.
- IF STRUCTURAL SOIL IS FOUND ON-SITE, THE CONTRACTOR SHALL
- THE CONTRACTOR SHALL PREVENT SOIL LOSS TO WIND AND WATER

EROSION

- 16. THE CONTRACTOR SHALL PROVIDE POSITIVE DRAINAGE AWAY FROM ALL
- THE GENERAL CONTRACTOR SHALL INSTALL & MAINTAIN TEMPORARY DRAINAGE DEVICES DURING CONSTRUCTION.
- THE CONTRACTOR SHALL VERIFY ALL CONTROL POINTS, FINISH FLOOR ELEVATIONS & PROPOSED SPOT ELEVATIONS WITH LANDSCAPE ARCHITECT PRIOR TO FORMWORK INSTALLATION.
- 19. SPECIFICATIONS DELINEATED IN GEO-TECH REPORT TAKE PRECEDENCE OVER GRADING PLAN DRAWINGS. INFORM LANDSCAPE ARCHITECT OF DISCREPANCIES.

GRADING LEGEND

CONTOUR LINE 1 FT. INTERVAL

SHALLOW RETENTION

0.00 +

357 cypress drive, 10 tequesta, fl 33469 561.402.9414 www.nielsenlandarch.com

SEAL (S TYLER NIELSEN - LA6667067)



LAYOUT PLAN

DATE ISSUE

03 22 2021 COOR DINATION 03 26 2021 DRB DRAFT 04 05 2021 DRB Submittal

> → NORTH → - . L500

LAYOUT NOTES

- LAYOUT AND VERIFY DIMENSIONS
 PRIOR TO CONSTRUCTION. NOTIFY
 LANDSCAPE ARCHITECT OF ANY
 DISCREPANCIES. LANDSCAPE
 ARCHITECT TO REVIEW AND APPROVE
 ALL LAYOUTS CONTAINED IN THE
 CONSTRUCTION DOCUMENTS PRIOR
 TO CONSTRUCTION.
- WRITTEN DIMENSIONS SHALL TAKE PRECEDENCE OVER SCALED DIMENSIONS. DO NOT SCALE DIMENSIONS FROM REDUCED DRAWINGS.
- DIMENSIONS REFERRED TO AS
 "EQUAL" INDICATE SPACING WHICH IS
 EQUIDISTANT MEASURED TO THE
 CENTERLINES.
- MEASUREMENTS ARE TO THE FINISHED FACE OF BUILDINGS, WALLS, OR OTHER FIXED SITE IMPROVEMENTS. DIMENSIONS TO

CENTERLINES ARE IDENTIFIED AS SUCH...

- INSTALL INTERSECTING ELEMENTS AT 90-DEGREE ANGLES, UNLESS OTHERWISE INDICATED. MAINTAIN HORIZONTAL ALIGNMENT OF ADJACENT ELEMENTS AS INDICATED IN CONTRACT DOCUMENTS.
- SPECIAL CONSIDERATION IS GIVEN TO THE DESIGN AND INTENDED RELATIONSHIP BETWEEN ARCHITECTURE, PLANTING AREAS AND PAVING SYSTEMS. PAVEMENT JOINTING, PAVERS, STONE, FINISHES AND GRADES HAVE BEEN STRICTLY COORDINATED IN THE CONTRACT DOCUMENTS. CONSTRUCTION OF THESE SYSTEMS SHALL BE STRICTLY COORDINATED.

- PLANT MATERIAL IS TO BE HEALTHY SPECIMENS FREE FROM DISEASE OR DAMAGE, AND IS TO BE MAINTAINED IN EXCELLENT CONDITION WHILE ON THE JOBSITE. LANDSCAPE ARCHITECT SHALL INSPECT PLANT MATERIAL UPON ARRIVAL TO JOBSITE AND WILL REJECT PLANT MATERIAL THAT DOES NOT MEET THE STANDARDS DESCRIBED WITHIN THE CONTRACT DOCUMENTS.
- 2. THE LANDSCAPE ARCHITECT WILL PERIODICALLY INSPECT PLANT MATERIAL STOCKPILED AND/OR PLANTED ON SITE DURING THE COURSE OF CONSTRUCTION. PLANT MATERIAL NOT MEETING THE STANDARDS CONTAINED WITHIN CONTRACT DOCUMENTS SHALL BE REPLACED AT NO COST TO THE OWNER.
- 3. PROVIDE MATCHING SIZES AND FORMS FOR EACH PLANT OF THE SAME SPECIES UNLESS OTHERWISE INDICATED.
- 4. CONTRACTOR TO VERIFY ALL QUANTITIES. IN CASE OF DISCREPANCIES, GRAPHICALLY SHOWN QUANTITIES SHALL TAKE PRECEDENCE.
- 5. ALL MATERIALS USED SHALL CONFORM TO THE GUIDELINES ESTABLISHED BY THE CURRENT AMERICAN STANDARDS FOR NURSERY STOCK, PUBLISHED BY THE AMERICAN ASSOCIATION OF NURSERYMEN.
- 6. ALL PLANT MATERIAL SHALL BE INSTALLED PLUMB AND PER THE SPECIFICATIONS CONTAINED WITHIN THE CONTRACT DOCUMENTS. ANY NECESSARY STAKING AND/OR OTHER SUPPORTS MATERIALS/METHODS SHALL BE SUBMITTED TO THE LANDSCAPE ARCHITECT FOR REVIEW AND APPROVAL PRIOR TO INSTALLATION.
- 7. THE CONTRACTOR SHALL PRUNE EXISTING AND/OR NEW TREES ONLY PER LANDSCAPE ARCHITECT DIRECTION.
- 8. THE CONTRACTOR SHALL STAKE THE LOCATIONS OF ALL TREES AND B&B SHRUBS FOR LANDSCAPE ARCHITECT REVIEW AND APPROVAL, PRIOR TO INSTALLATION.
- 9. ALL ROOT-WRAPPING MATERIALS THAT ARE NOT BIO-DEGRADABLE SHALL BE REMOVED FROM THE ROOT BALL. ROOT BALLS SHALL BE FREE OF WEEDS.
- 10. SPECIFIED PLANT MATERIAL SIZES SHALL BE CONSIDERED MINIMUM SIZES.
- 11. FINISH GRADE OF PLANTING BEDS SHALL BE ONE (1) INCH BELOW ADJACENT FLATWORK, UNLESS SPECIFIED OTHERWISE.
- 12. MULCH OR PLANTING BED DRESSING SHALL BE PLACED IN ALL PLANTING AREAS AS SPECIFIED. MULCH OR PLANTING BED DRESSING SHALL NOT BE PLACED WITHIN SIX (6) INCHES OF TREE TRUNKS. MULCHING SHOULD BE REPEATED ANNUALLY DURING THE AUTUMN TO A THREE (3) INCH DEPTH.
- 13. ALL PLANT MATERIAL SHOULD RECEIVE AN ORGANIC FERTILIZER IN LIMITED APPLICATION FOLLOWING INSTALLATION. TYPE AND APPLICATION RATE AND METHOD OF APPLICATION TO BE SPECIFIED BY THE CONTRACTOR AND APPROVED BY THE LANDSCAPE ARCHITECT.
- 14. EXCESS FERTILIZER SHALL BE DISPOSED OF PROPERLY OFF-SITE. IT SHALL NOT BE DISPOSED OF IN STORM DRAINS AND/OR DRYWELLS.
- 15. STOCKPILED PLANT MATERIAL TO BE PLACED IN THE SHADE AND PROPERLY HAND-WATERED UNTIL PLANTED.
- 16. MINI-NUGGET TYPE DECORATIVE BARK MULCH WILL BE USED TO RETURN NUTRIENTS TO THE SOIL, REDUCE MAINTENANCE AND MINIMIZE EVAPORATION FOR AREAS APPROXIMATE TO THE RESIDENCE. LARGER SHREDDED BARK MULCH WILL BE USED FOR STEEP AREAS SO SLOUGHING IS LESS LIKELY TO OCCUR.
- 17. PRESERVE & PROTECT ALL EXISTING VEGETATION INDICATED TO REMAIN AT ALL TIMES.
- 18. ALL VEGETATION PROPOSED FOR OUTSIDE THE BUILDING ENVELOPE TO BE NATIVE UNLESS OTHERWISE NOTED. PLANTING THAT OCCURS OUTSIDE THE BUILDING ENVELOPE IS FOR RESTORATION PURPOSES ONLY OR IS SPECIFIC TO UTILITIES RESTORATION.
- 19. SIX (6) INCH PLANT MIX SHALL BE PROVIDED FOR ALL LAWN, TURF, AND NATIVE PLANTING ZONES. 18 INCH PLANT MIX SHALL BE PROVIDED FOR ALL PERENNIAL PLANTING BEDS UNLESS OTHERWISE NOTED.
- 20. ALL PLANT MATERIAL SHALL BE FLORIDA GRADE #1 OR BETTER AS OUTLINED IN GRADES AND STANDARDS FOR NURSERY PLANTS, PARTS I AND II OF THE LATEST EDITION, PUBLISHED BY THE FLORIDA DEPARTMENT OF AGRICULTRE AND CONSUMER SERVICES.

CITY OF MIAMI BEACH LANDSCAPE LEGEND

	CITY OF MIAMI BEACH		
	LANDSCAPE LEGEND		
	INFORMATION REQUIRED TO BE PERMANENTLY AFFIXED TO PLANS Zoning District $RS-3$ Lot Area $23,400$ Acre	s54	_
	OPEN SPACE	REQUIRED/ ALLOWED	PROVIDE
A.	Square feet of required Open Space as indicated on site plan: Lot Area = 23,400 s.f.x 09 % = 2,106 s.f.	2,106	10,198
B.	Square feet of parking lot open space required as indicated on site plan:	APRICA:	35 de 1855 de
	Number of parking spaces NA x 10 s.f. parking space =	NA	NA
C.	Total square feet of landscaped open space required: A+B=	2,106	10,198
	LAWN AREA CALCULATION		
A.	Square feet of landscaped open space required	2,106	10,198
B.	Maximum lawn area (sod) permitted= $50 \text{%} \times 10,198$	5,099	3,611
	TREES		
Α.	Number of trees required per lot or net lot acre, less existing number of		
	trees meeting minimum requirements= 42 _trees x $_{$	23	26
B.	% Natives required: Number of trees provided x 30% =	8	11
C.	% Low maintenance / drought and salt tolerant required:	10	00
20	Number of trees provided x 50%=	13	26
D.	Street Trees (maximum average spacing of 20' o.c.) 120 linear feet along street divided by 20'=	6	6
E.	Street tree species allowed directly beneath power lines: (maximum average spacing of 20' o.c.):		/ (. .
	120 linear feet along street divided by 20'=	6	6
	CUPURC		201
	SHRUBS	0.40	0.50
	Number of shrubs required: Sum of lot and street trees required x 12=	348	353
B.	% Native shrubs required: Number of shrubs provided x 50%=	177	191
	LARGE SHRUBS OR SMALL TREES		
	Number of large shrubs or small trees required: Number of required shrubs		70
A.			
	x 10%= % Native large shrubs or small trees required: Number of large shrubs or	35	73

PLANTING SCHEDULE

ADD		DOTANICAL NAME	COMMONINAME	SPECIFICATIONS						
		BOTANICAL NAME	COMMON NAME	SPECIFICATIONS						
TREES	Care	Landanana	DOWNERDUSE							
CHA	3	CALLIANDRA HAEMATOCEPHALA	POWDERPUFF	FG. 4 IN. DBH / 16 FT. OA. / SINGLE LEADER STANDARD						
PAQ	1	PACHIRA AQUATICA	WATER CHESTNUT	FG. 8-10 IN. DBH 18 FT. OA.						
GSA	1	GUAIACUM SANCTUM	LIGNUM VITAE	SPECIMEN COLLECTED 12 FT. HT. X 12 FT. SP.						
CRO	2	CLUSIA ROSEA	AUTOGRAPH TREE	200 GAL. SPECIMEN MULTI-TRUNK						
CBR	12	CALOPHYLLUM BRASILIENSE	SAME	FG. 16 FT. HT. 4 IN. DBH / SINGLE LEADER STANDARD						
MFR	6	MYRCIANTHES FRAGRANS	SIMPSON STOPPER	SINGLE LEADER STANDARD / 4 IN. DBH 16 FT. HT.						
FAU	1	FICUS AUREA	STRANGLER FIG	COLLECTED SPECIMEN 36 IN. DBH MIN. 30 FT. HT. OA.						
PALM	S			_						
PDA	4	PHOENIX DACTYLIFERA 'MEDJOOL'	DATE PALM	20 FT. CT.						
VAR	14	VEITCHIA ARECINA	MONTGOMERY PALM	FG. TRIPLE 30 FT. OA.						
SPA	16	SABAL PALMMETO	SABAL PALM	REGENERATED 12-16 FT. GW.						
PRO	21	PHOENIX ROEBELENII	PYGMY DATE PALM	FG. TRIPLE 9-12 FT. OA.						
UNDE	RSTORY T	REES & SHRUBS								
BB	7~~~	PIMENTA RACEMOSA	BAY RUM	45 GAL. 10 FT. HT. BUSH						
CC	9	CAPPARIS CYNOPHALLOPHORA		1 ZO 13A						
RM	\sim	RHAPIS MULTIFIDA	FINGER PALM	45 GAL.						
CP	5	AGLAIA ODORATA	CHINESE PERFUME TREE	25 GAL. BUSH						
JW.	18	ACALYPHA WILKESIANA 'JAVA WHITE'	COPPERLEAF	7 GAL						
PL	125	PSYCHOTRIA LIGUSTRIFOLIA	BAHAMA WILD COFFEE	7 GAL.						
AP	125	ALPINIA PURPURATA	RED GINGER	15 GAL.						
CE	57	CONOCARPÚS ERECTUS	GREEN BUTTONWOOD	25 GAL. BUSH						
ACCE	NTS									
Al	61	ALCANTAREA IMPERIALIS	BROMELIAD	15 GAL.						
PG	37	PHILODENDRON GIGANTEUM	SAME	7 GAL.						
HR	7	HELICONIA ROSTRATA	LOBSTER CLAW HELICONIA	15 GAL. 6-8 FT. HT.						
PR	13	PHILODENDRON 'RON WEEKS HYBRID'	SAME	7 GAL.						
GC	26	PHILODENDRON 'GREEN CONGO'	SAME	7 GAL.						
PM	5	PHILODENDRON MCDOWELL	SAME	7 GAL.						
	NDCOVER		1	· · · · · · · · · · · · · · · · · · ·						
LM	1,394	LIRIOPE MUSCARI	LILYTURF	3 GAL. 18 IN. O.C.						
BM	248	PHILODENDRON 'BURLE MARX'	SAME	3 GAL. 18 IN. O.C.						
VINES										
BI	12	BOUGAINVILLEA 'IMPERIAL THAI DELIGHT'	SAME	25 GAL. TRELLIS						
BAMB	5000		1220 1200 1200							
BA	26	BAMBUSA MALINGENSIS	SEABREEZE BAMBOO	25 GAL. 20 FT. OA.						
MISC.	500000									
A STATE OF THE STATE OF	CUARTED CONTROL TO THE CONTROL	TO BE REPLACED WITH ZOYSIA 'ZEON'								
/ L_ O		CHITECT TO HAVE \$2000 WHOLESALE ACCEN								

RELOCATED SHCEDULE

#	BOTANICAL NAME	COMMON NAME	DBH.	HT.	SPREAD	ACTION	NOTES
8	COCOS NUCIFERA	COCONUT PALM	10"	30'	24'	RELOCATE	LOCATION OF PLANT MATERIAL CONFLICTS WITH CONSTRUCTION ENVELOPE
9	COCOS NUCIFERA	COCONUT PALM	14"	40'	24'	RELOCATE	LOCATION OF PLANT MATERIAL CONFLICTS WITH CONSTRUCTION ENVELOPE
10	COCOS NUCIFERA	COCONUT PALM	14"	40'	23'	RELOCATE	LOCATION OF PLANT MATERIAL CONFLICTS WITH CONSTRUCTION ENVELOPE
11	COCOS NUCIFERA	COCONUT PALM	14"	40'	23'	RELOCATE	LOCATION OF PLANT MATERIAL CONFLICTS WITH CONSTRUCTION ENVELOPE
12	COCOS NUCIFERA	COCONUT PALM	14"	40'	23'	RELOCATE	LOCATION OF PLANT MATERIAL CONFLICTS WITH CONSTRUCTION ENVELOPE
13	ROYSTONEA REGIA	ROYAL PALM	24"	45'	20'	RELOCATE	LOCATION OF PLANT MATERIAL CONFLICTS WITH CONSTRUCTION ENVELOPE
14	ROYSTONEA REGIA	ROYAL PALM	24"	35'	20'	RELOCATE	LOCATION OF PLANT MATERIAL CONFLICTS WITH CONSTRUCTION ENVELOPE
15	ROYSTONEA REGIA	ROYAL PALM	20"	35'	20'	RELOCATE	LOCATION OF PLANT MATERIAL CONFLICTS WITH CONSTRUCTION ENVELOPE
16	COCOS NUCIFERA	COCONUT PALM	10"	15'	20'	RELOCATE	LOCATION OF PLANT MATERIAL CONFLICTS WITH CONSTRUCTION ENVELOPE
17	ROYSTONEA REGIA	ROYAL PALM	18"	40'	20'	RELOCATE	LOCATION OF PLANT MATERIAL CONFLICTS WITH CONSTRUCTION ENVELOPE
18	COCOS NUCIFERA	COCONUT PALM	10"	25'	20'	RELOCATE	LOCATION OF PLANT MATERIAL CONFLICTS WITH CONSTRUCTION ENVELOPE
19	COCOS NUCIFERA	COCONUT PALM	10"	40'	20'	RELOCATE	LOCATION OF PLANT MATERIAL CONFLICTS WITH CONSTRUCTION ENVELOPE
20	COCOS NUCIFERA	COCONUT PALM	10"	35'	201	RELOCATE	LOCATION OF PLANT MATERIAL CONFLICTS WITH CONSTRUCTION ENVELOPE
21	COCOS NUCIFERA	COCONUT PALM	10"	30'	20'	RELOCATE	LOCATION OF PLANT MATERIAL CONFLICTS WITH CONSTRUCTION ENVELOPE
22	COCOS NUCIFERA	COCONUT PALM	10"	30'	20'	RELOCATE	LOCATION OF PLANT MATERIAL CONFLICTS WITH CONSTRUCTION ENVELOPE
23	COCOS NUCIFERA	COCONUT PALM	9"	30'	20'	RELOCATE	LOCATION OF PLANT MATERIAL CONFLICTS WITH CONSTRUCTION ENVELOPE
24	COCOS NUCIFERA	COCONUT PALM	9"	30'	20'	RELOCATE	LOCATION OF PLANT MATERIAL CONFLICTS WITH CONSTRUCTION ENVELOPE
25	COCOS NUCIFERA	COCONUT PALM	9"	30'	20'	RELOCATE	LOCATION OF PLANT MATERIAL CONFLICTS WITH CONSTRUCTION ENVELOPE
26	COCOS NUCIFERA	COCONUT PALM	9"	30'	20'	RELOCATE	LOCATION OF PLANT MATERIAL CONFLICTS WITH CONSTRUCTION ENVELOPE
27	COCOS NUCIFERA	COCONUT PALM	9"	30'	20'	RELOCATE	LOCATION OF PLANT MATERIAL CONFLICTS WITH CONSTRUCTION ENVELOPE



PLANTING SCHEDULE & NOTES

DATE ISSUE

03.22.2021 COORDINATION
03.26.2021 DRB DRAFT
04.05.2021 DRB SUBMITTAL
05.03.2021 REVISION 1

L700














DATE	(SSLIE
03.22.2001	COORDINATIO
03.26.2021	ORB DIVAFT
04.06.2021	DRE Submittel





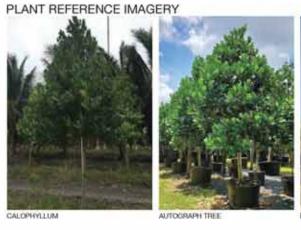

























































PYGMY DATE PALM

PLANTING SCHEDULE

TREES

MER

FAU

PALMS

ABR. QUANTITY | BOTANICAL NAME

CALLIANDRA HAEMATOCEPHALA

CALOPHYLLUM BRASILIENSE

PHOENIX DAGTYLIFERA 'MEDJOOL'

MYRCIANTHES ERAGRANS

PACHIRA AQUATICA

CLUSIA ROSEA

FIGUS AUREA

16 SABAL PALMMETO

PRO 21 PHOENIX POEBELENII

VEITCHIA ARECINA

GUAIACUM SANCTUM

RELOCATED SHCEDULE

COMMON NAME

COCONUTPALM

COCONUTPALM

COCONUTPALM

COCONUTPALM

COCONUTPALM

ROYAL PALM

BOYAL PALM

BOYAL PALM

ROYAL PALM

COCONUTPALM

BOTANICAL NAME

8 COCOS NUCIFERA

9 COCOS NUCIFERA

10 COCOS NUCIFERA

11 COCOS NUCIFERA

12 COCOS NUCIFERA

13 ROYSTONEA REGIA

15 ROYSTONEA REGIA

16 COCOS NUCIFERA

17 ROYSTONEA REGIA

18 COCOS NUCIFERA

19 COCOS NUCIFERA

20 COCOS NUCIFERA 21 COCOS NUCIFERA

22 COCOS NUCIFERA 23 COCOS NUCIFERA

24 COCOS NUCIFERA

25 COCOS NUCIFERA

26 COCOS NUCIFERA

27 COCOS NUCIFERA

14 BOYSTONEA BEGIA

357 cypress drive, 10 tequesta, fl 33469 561.402.9414

www.nielsenlandarch.com

SEAL (S TYLER NIELSEN - LA6667067)



TREE& PAL	M PLANTING PLAN	
DATE	ISSUE	
03 22 2021	COORDINATION	

03 26 2021 DRB DRAFT 04 05 2021 DRB Submittal

ACTION

RELOCATE

RELOCATE

RELOCATE

RELOCATE

RELOCATE

RELOCATE

BELOCATE

RELOCATE

RELOCATE

RELOCATE

RELOCATE

RELOCATE

RELOCATE RELOCATE

RELOCATE

RELOCATE

RELOCATE

RELOCATE

RELOCATE

RELOCATE



PLANTING LEGEND



RELOCATED TREE





EXISTING TREE







PROPOSED TREE

357 cypress drive, 10 tequesta, £1 33469 561,402,9414

was tielestlandards.com

THE 190 GARDEN

SEAL (S TYLER NIELSEN - LAGGG70GY)



NOTERISTOR	Y PLANTING PLAN
ATE	(884.)E
22 2021	COORDINATION

03.26.2021 ORB DRAFT 04.09.2021 ORB SLBMTTAL 06.03.2021 REVISION 1

ABR. QUANTITY BOTANICAL NAME

LM 1,394 LIRIOPE MUSCARI

GROUNDCOVERS

VINES

BAMBOO

BA 26

7 HELICONIA ROSTRATA

PHILODENDRON 'RON WEEKS HYBRID' PHILODENDRON 'GREEN CONGO' PHILODENDRON MCDOWELL

BOUGAINVILLEA 'IMPERIAL THAI DELIGHT'

PHILODENDRON 'BURLE MARX'

BAMBUSA MALINGENSIS

L703

PLANTING SCHEDULE

	ABR.	QUANTITY	BOTANICAL NAME
	UNDERSTORY TREES & SHRUBS		
Λ	BB.		PIMENTA RACEMOSA
4	CC	. 9	CAPPARIS CYNOPHALLOPHORA
	RM	6	FIFIAPIS MULTIFIDA
	CP	. 6	AGLAIA ODORATA
	JUL	18	ACALYPHA WILKESIANA JAVA WHITE
	PL.	125	PSYCHOTRIA LIGUSTRIFOLIA
	Ap	125	ALPINIA PURPURATA
	CE	67	CONOCAMPUS ERECTUS
	ACCENTS		
	Al	61	ALCANTAREA IMPERIALIS
	PG	37	PHILODENDRON GIGANTEUM

PROPOSED VINE	
PROPOSED GROUNDCOVER	

PLANTING LEGEND





EXISTING PALM



PROPOSED PALM





PROPOSED VINE

TYP

PROPOSED SHRUB / ACCENT







