

121 NORTH HIBISCUS DRIVE RESIDENCE

CABANA AND LANDSCAPE RE-SUBMITTAL

DRB PRESENTATION . MAY 4, 2021





VIEW FROM FRONT YARD

A-37

121 NORTH HIBISCUS DRIVE RESIDENCE









SITE LOCATION

121 NORTH HIBISCUS DRIVE RESIDENCE

121 NORTH HIBISCUS DRIVE . MIAMI BEACH . FLORIDA

STUDIO



A-





	Neighbor provided Support I	etter Multiple Me	etings to Address Concer
No.	Property Address	Owner	
1.	131 N Hibiscus Dr	Roger A. Schultz	Support Letter
2.	101 N Hibiscus Dr.	V I Hibiscus 4445 LLC –	Attn. Juan P Loumiet Esq.
3.	91 N Hibiscus Dr.	Douglas Walker	Support Letter
4.	17 N Hibiscus Dr.	George Wallner	Support Letter

NEIGHBORHOOD OUTREACH DIAGRAM

121 NORTH HIBISCUS DRIVE RESIDENCE



March 29, 2021
Design Review Board Members c/o Michael Belush, Chief of Planning & Zoning Planning Departmen: City of Miami Beach 1700 Convention Center Drive, 2nd Floor Miami Beach, Florida 33139
Re: Single-Family Home at 121 N Hibiscus Drive, Miami Beach DRB21-0637 Letter of Support
Dear Board Members:
I am the owner of <u>131 N. Hibiscus Drive</u> , Miami Beach, Florida, which is in close proximity or abutting the above-referenced property. I had a conversation with the applicant and reviewed plans and renderings for the proposed single-family residence. The home is beautifully-designed and will be a welcome addition to the neighborhood.
Based on the foregoing, I fully support the applicant's new home and ask the Design Review Board to grant the design review approval with all associated requests.
Sincerely,
Signature
Roger A John He

March 22, 2021

Design Review Board Members

c/o Michael Belush, Chief of Planning & Zoning Planning Department City of Miami Beach 1700 Convention Center Drive, 2nd Floor Miami Beach, Florida 33139

Re: Single-Family Home at 121 N Hibiscus Drive, Miami Beach DRB21-0637 Letter of Support

Dear Board Members:

I am the owner of 17 N. Hibiscus Drive, Miami Beach, Florida, which is in close proximity or abutting the above-referenced property. I had a conversation with the applicant and reviewed plans and renderings for the proposed single-family residence. The home is beautifully-designed and will be a welcome addition to the neighborhood.

Based on the foregoing, I fully support the applicant's new home and ask the Design Review Board to grant the design review approval with all associated requests.

Sincerely,

Print name

George Wallner

03 24, 2021

Design Review Board Members

c/o Michael Belush, Chief of Planning & Zoning Planning Department City of Miami Beach 1700 Convention Center Drive, 2nd Floor Miami Beach, Florida 33139

Re: Single-Family Home at 121 N Hibiscus Drive, Miami Beach DRB21-0637 Letter of Support

Dear Board Members:

Based on the foregoing, I fully support the applicant's new home and ask the Design Review Board to grant the design review approval with all associated requests.

Sincerely

Sionature

D. CHRIS WALKER

Print name

NEIGHBOR'S LETTERS OF SUPPORT

121 NORTH HIBISCUS DRIVE RESIDENCE





PRIOR SUBMITTAL

VIEW FROM BISCAYNE BAY

121 NORTH HIBISCUS DRIVE RESIDENCE






PROPOSED REVISION

VIEW FROM BISCAYNE BAY

121 NORTH HIBISCUS DRIVE RESIDENCE



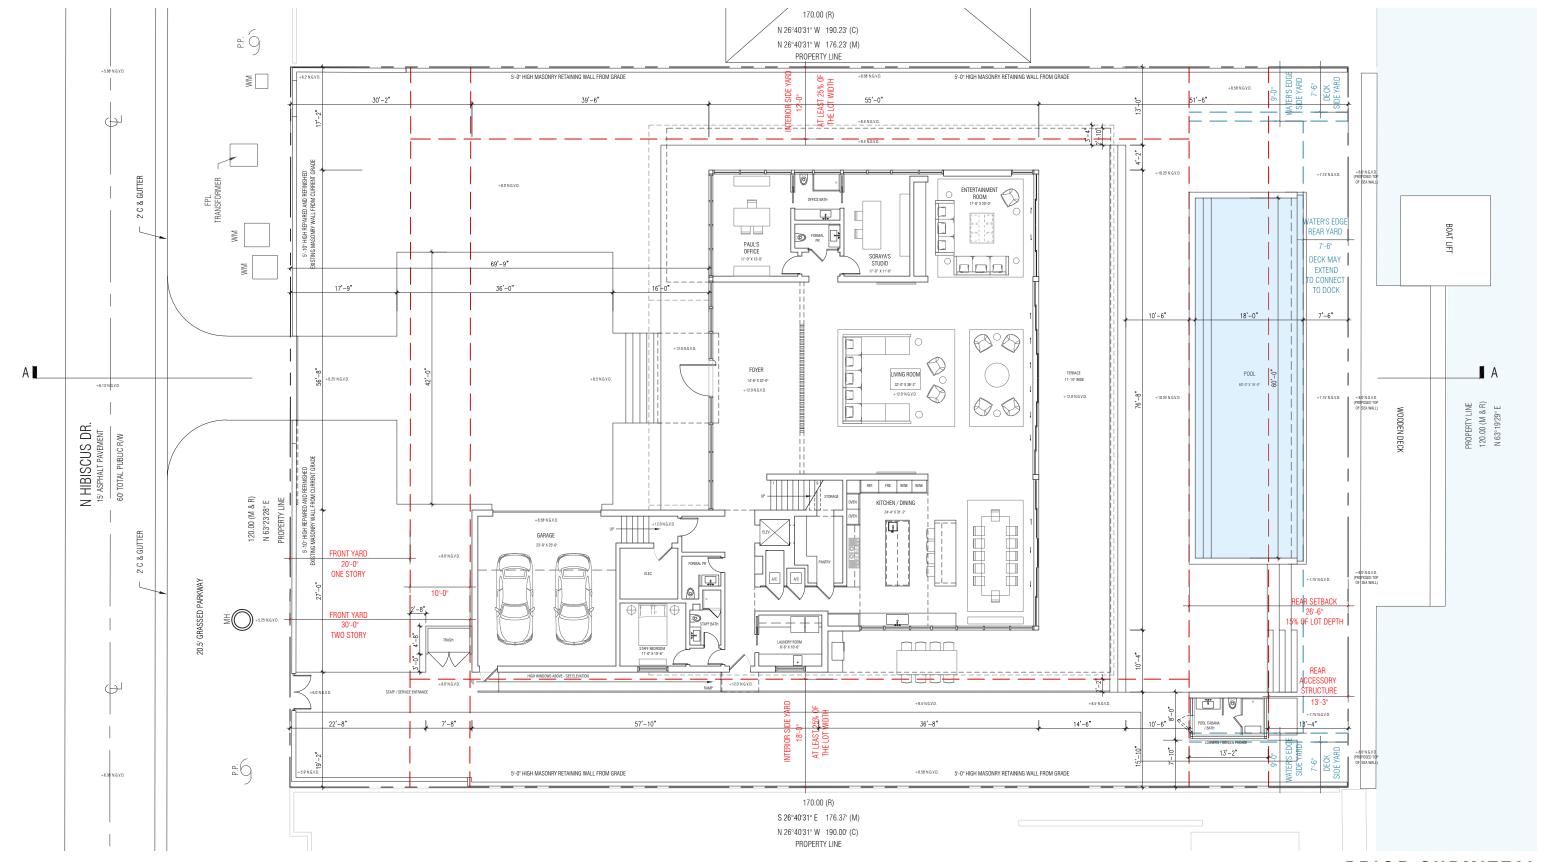

PRIOR SUBMITTAL


GROUND FLOOR PLAN
SCALE: 1/16"=1'-0"

A-28

5' 10' 25' 50'

121 NORTH HIBISCUS DRIVE RESIDENCE



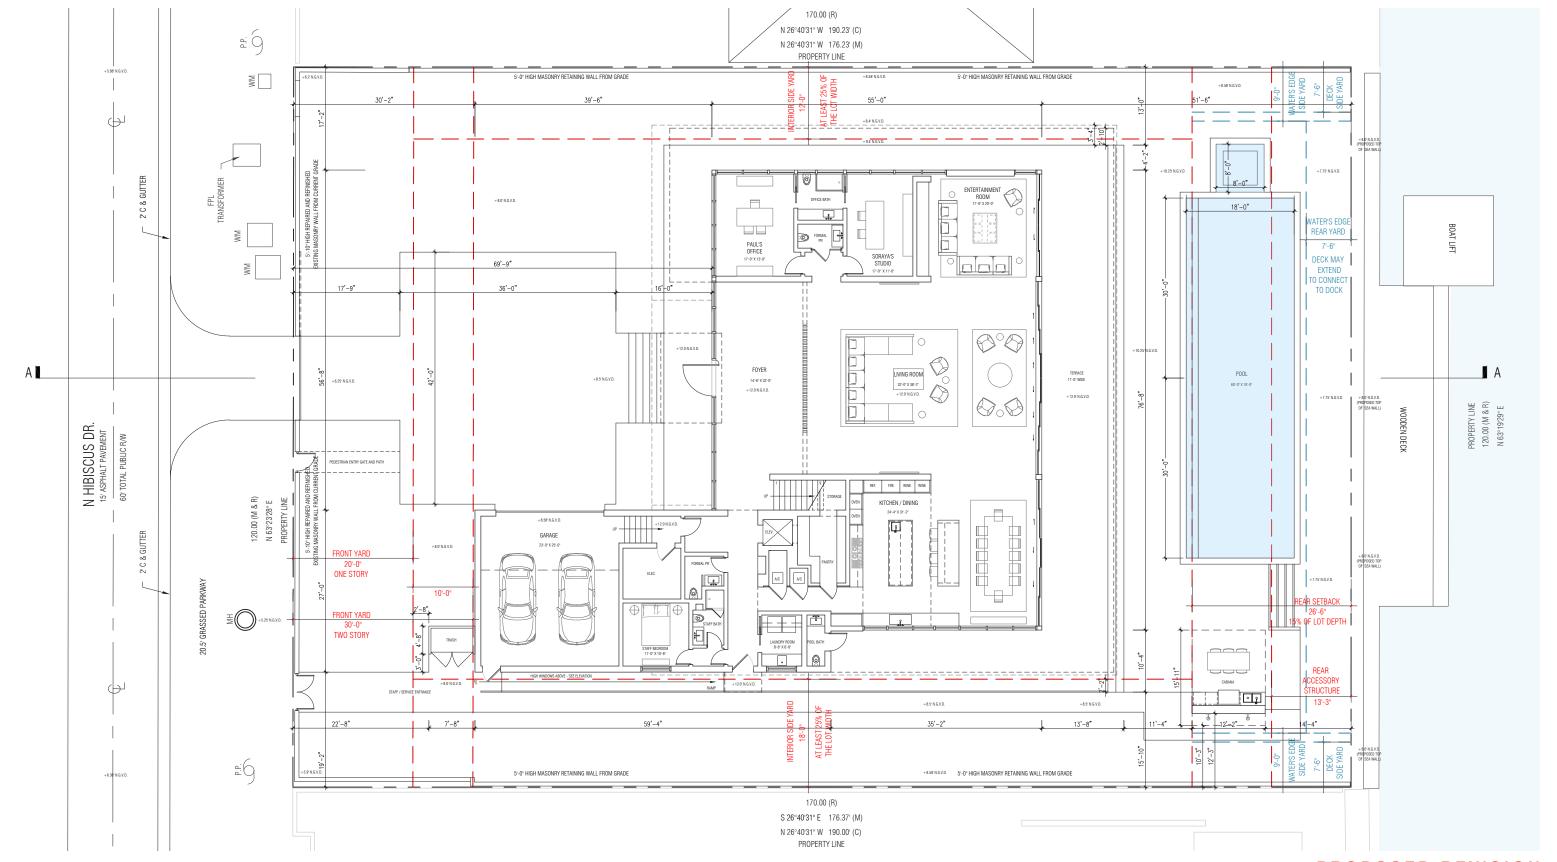


PROPOSED REVISION

GROUND FLOOR PLAN SCALE: 1/16" = 1'-0"

5' 10' 25' 50'

121 NORTH HIBISCUS DRIVE RESIDENCE



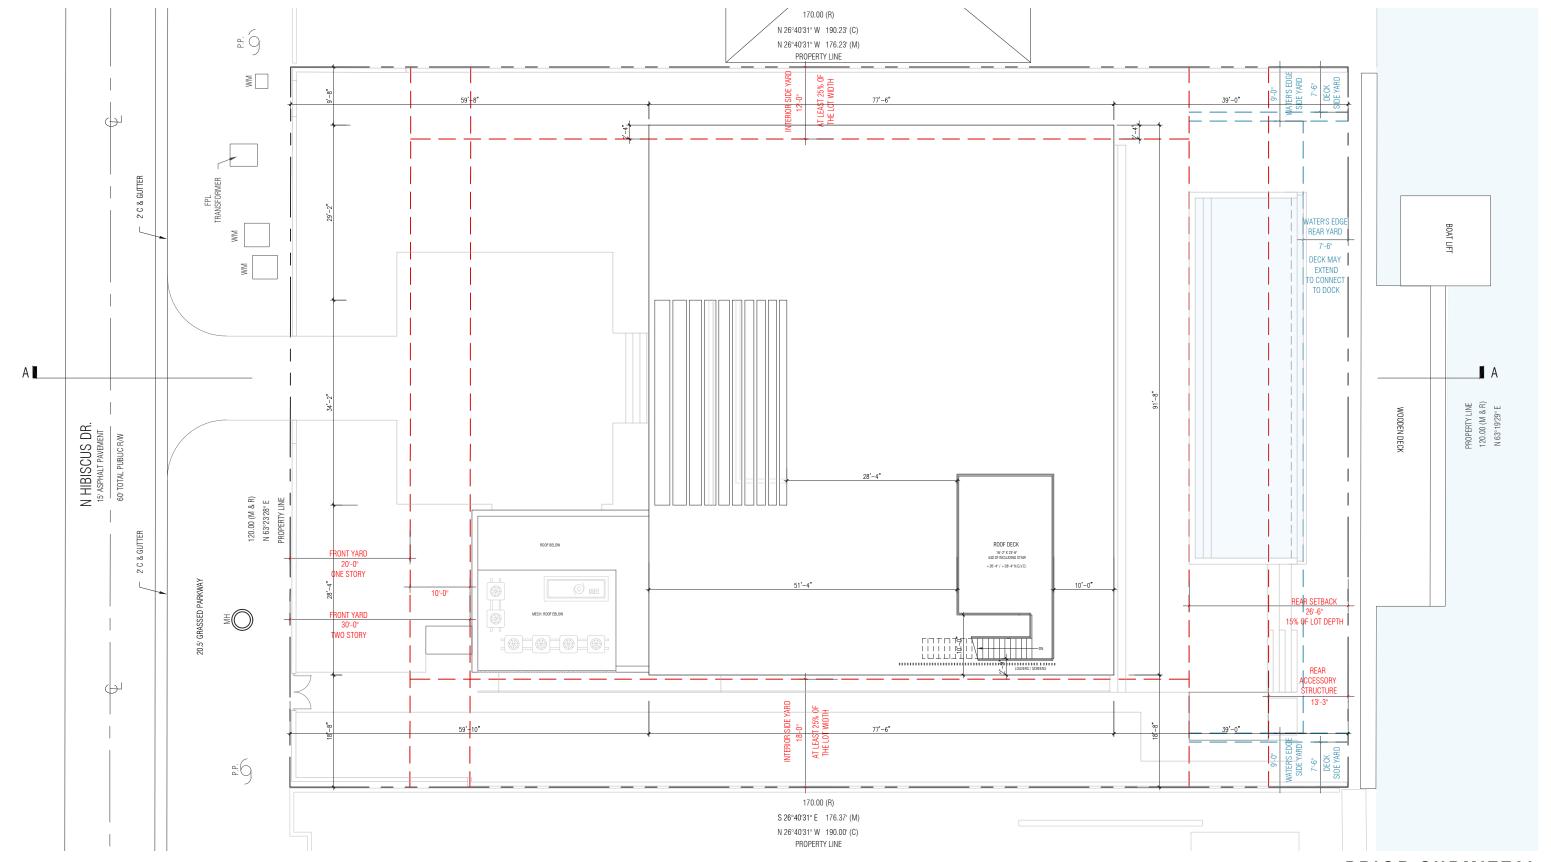


PRIOR SUBMITTAL

ROOF FLOOR PLAN

1 2 1 NORTH HIBISCUS DRIVE RESIDENCE 12 1 NORTH HIBISCUS DRIVE . MIAMI BEACH . FLORIDA



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PROPOSED REVISION

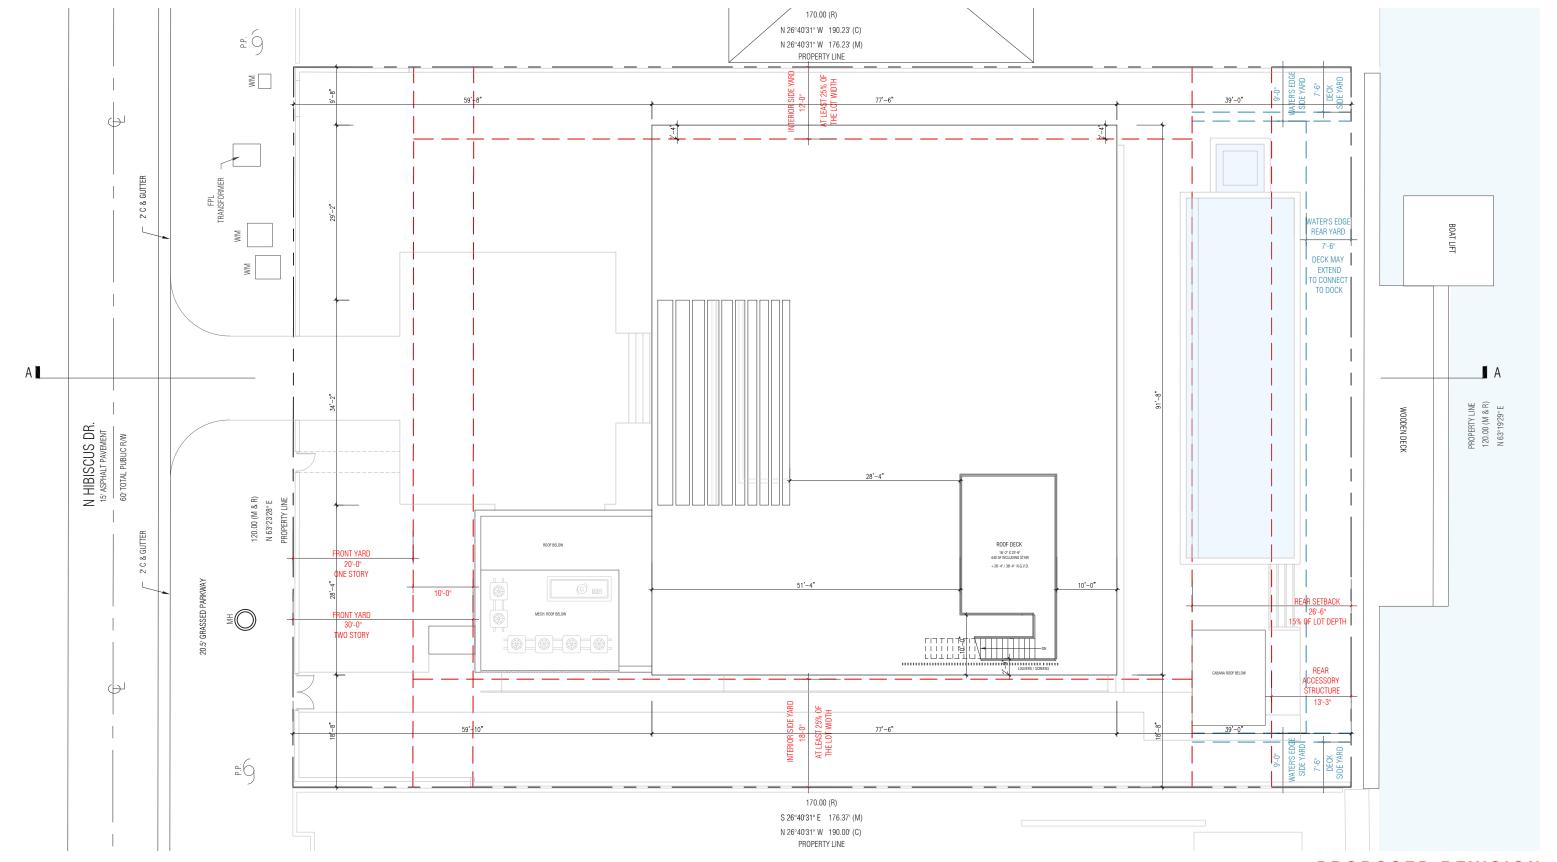
ROOF FLOOR PLAN
SCALE: 1/16"=1'-0"

5' 10' 25' 50'

TOUZET STUDIO

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121 NORTH HIBISCUS DRIVE RESIDENCE

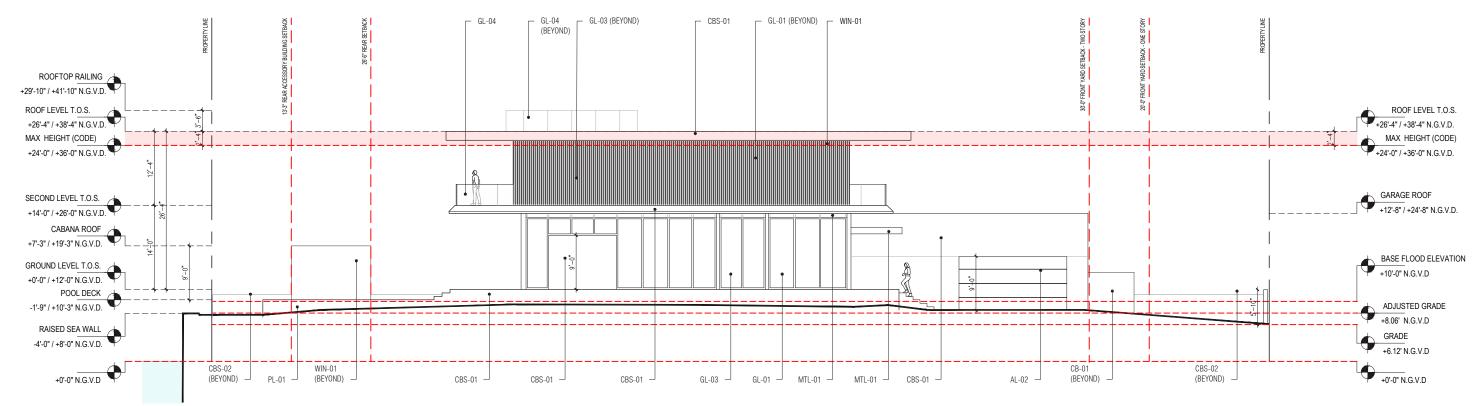

- AL-01 ROOF / TRELLIS MEMBERS TO BE FINISHED IN LIGHT GRAY KYNAR, OR EQUIV. FINISH
- AL-02 SPECIALTY GARAGE DOOR
- C-01 CAST-IN-PLACE ARCHITECTURAL CONCRETE
- CBS-01 EXTERIOR CEMENT PLASTER ON REINFORCED CONCRETE MASONRY WALL SMOOTH FINISH AND PAINT COLOR TBD
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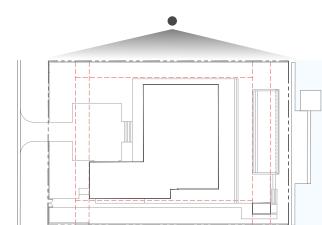
121 NORTH HIBISCUS DRIVE . MIAMI BEACH . FLORIDA

121 NORTH HIBISCUS DRIVE RESIDENCE

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GL-02 IMPACT-RATED, ALUMINUM OUTSWING ENTRANCE DOORS - FINISH TO MATCH GL-01

- GL-03 IMPACT-RATED, LIGHT TINTED CUSTOM FRIT OR FROSTED LAMINATED GLASS ON ALUMINUM FRAMING SYSTEM FINISH TO MATCH GL-01
- ${\tt GL-04} \qquad {\tt TEMPERED GLASS GUARDRAIL SYSTEM WITH ALUMINUM RAIL SHOE, HEIGHT 42" A.F.F.}$
- MTL-01 BRAKE METAL OVER STEEL STRUCTURAL ELEMENTS LIGHT KYNAR FINISH, TBD.
- PL-01 IN-GROUND POOL, PEBBLEFINA CIELO BLUE OR EQUIVALENT FINISH
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- SST-01 STAINLESS STEEL JAKOB CABLE GUARDRAIL/HANDRAIL SYSTEM, HEIGHT 42" A.F.F.
- WIN-01 CUSTOM, FINISHED ALUMINUM "PERSIANAS" WITH TWO COAT KYNAR 500 FINISH TO MATCH GL-01




PRIOR SUBMITTAL

WEST ELEVATION
SCALE: 1/16"=1'-0"

SCALE: 1/10 = 1 - 025'
50'



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TOUZET

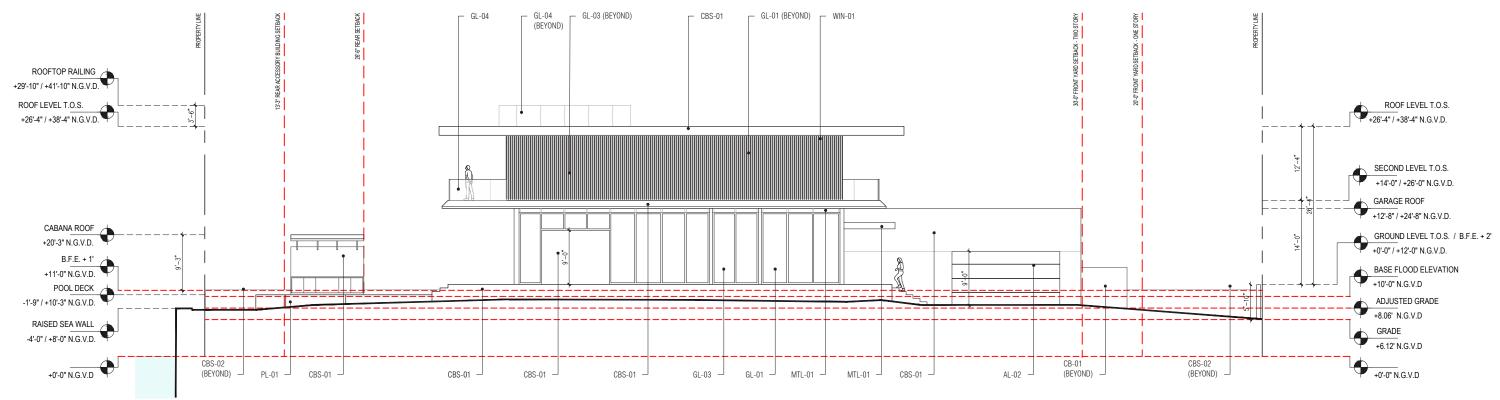STUDIO

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121 NORTH HIBISCUS DRIVE RESIDENCE


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PROPOSED REVISION

WEST ELEVATION
SCALE: 1/16"=1'-0"

5' 10' 25' 50'



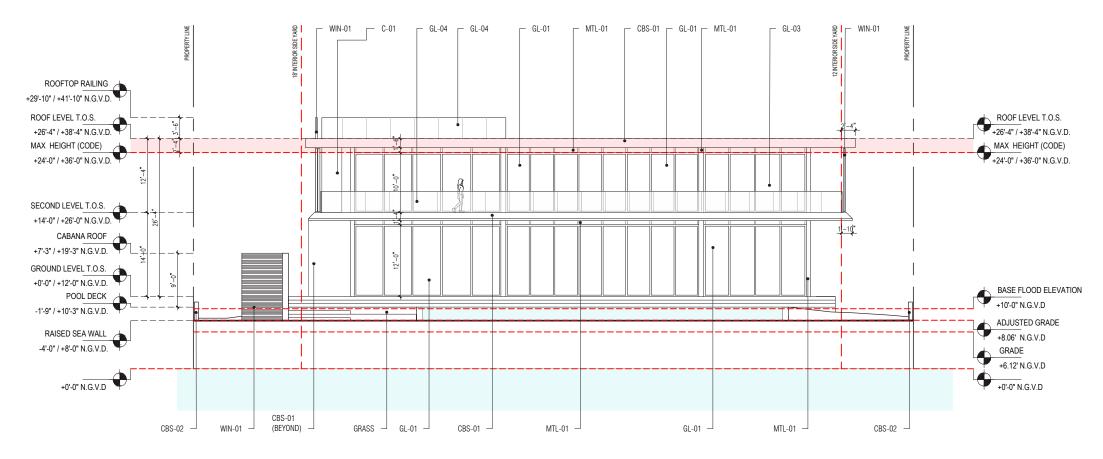


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PRIOR SUBMITTAL

NORTH ELEVATION

A-34

SCALE: 1/16"=1'-0"

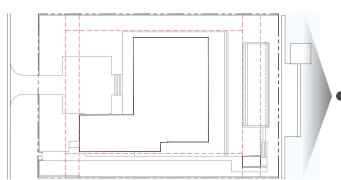

121 NORTH HIBISCUS DRIVE RESIDENCE






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121 NORTH HIBISCUS DRIVE . MIAMI BEACH . FLORIDA

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PROPOSED REVISION

NORTH ELEVATION

SCALE: 1/16" = 1'-0"

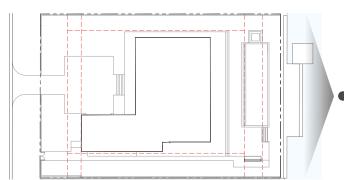




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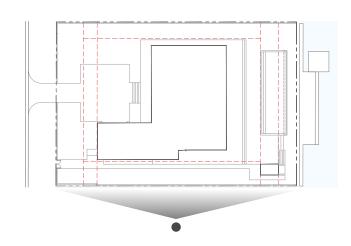
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PRIOR SUBMITTAL


EAST ELEVATION SCALE: 1/16"=1'-0"

SCALE: 1/16" = 1'-0"

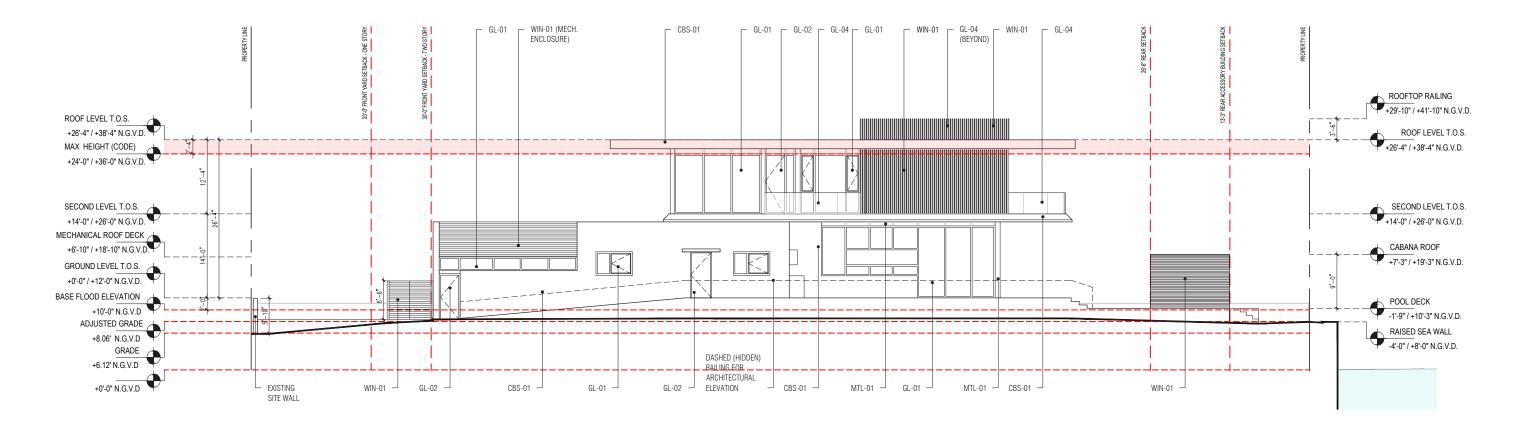10'
25'
50'


121 NORTH HIBISCUS DRIVE RESIDENCE



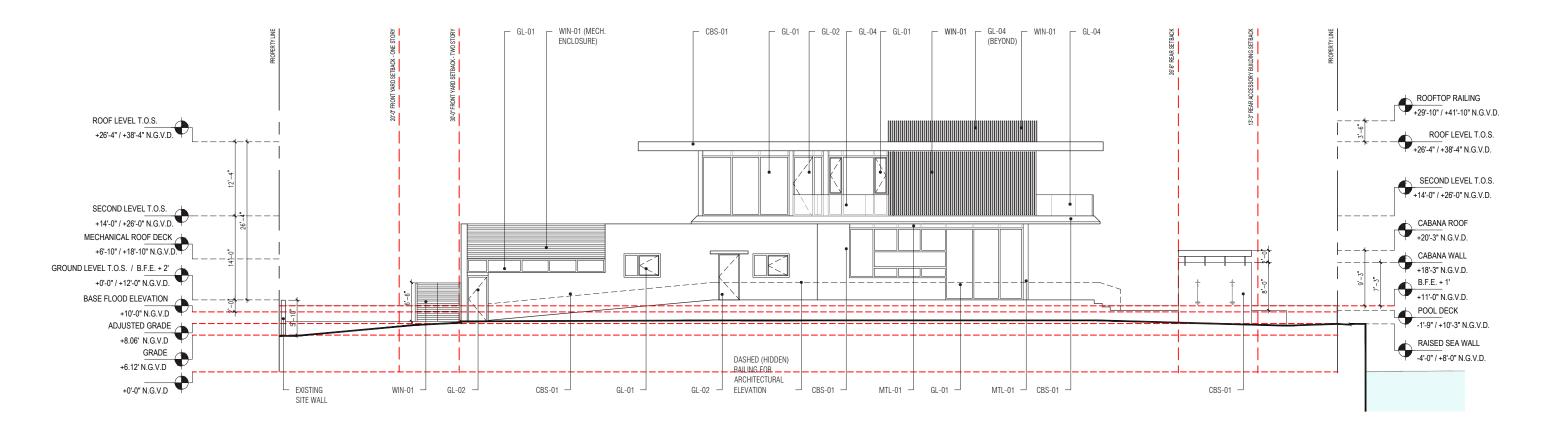

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PROPOSED REVISION

EAST ELEVATION

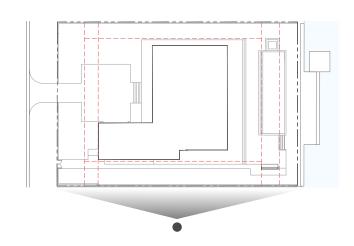
SCALE: 1/16" = 1'-0"



MIAMI BEACH . DRB PRESENTATION . 04 MAY 2021

121 NORTH HIBISCUS DRIVE RESIDENCE




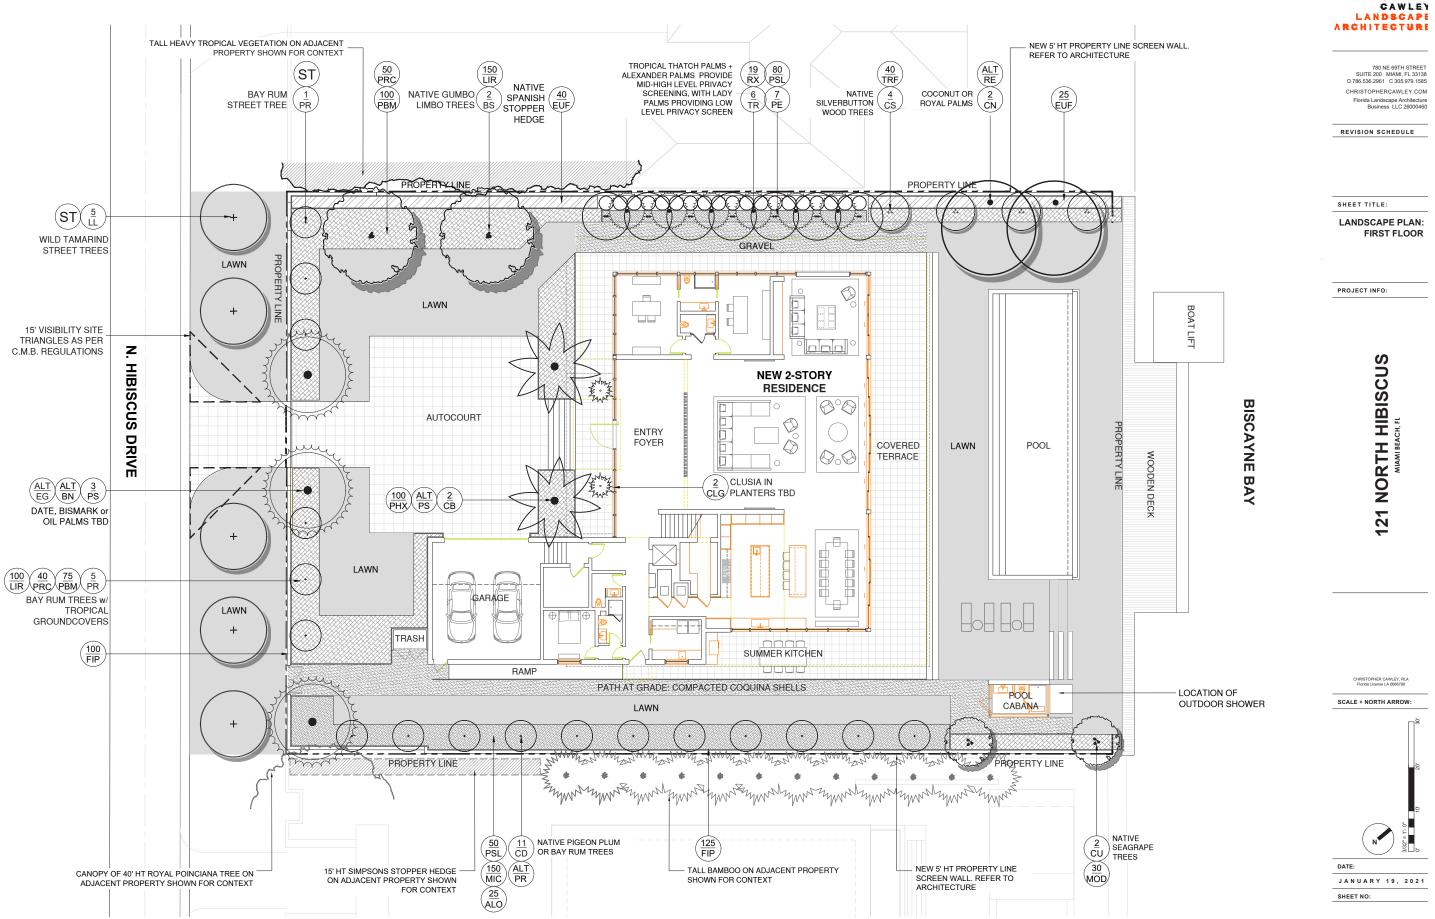

L2.0

PRIOR SUBMITTAL

CHRISTOPHEF

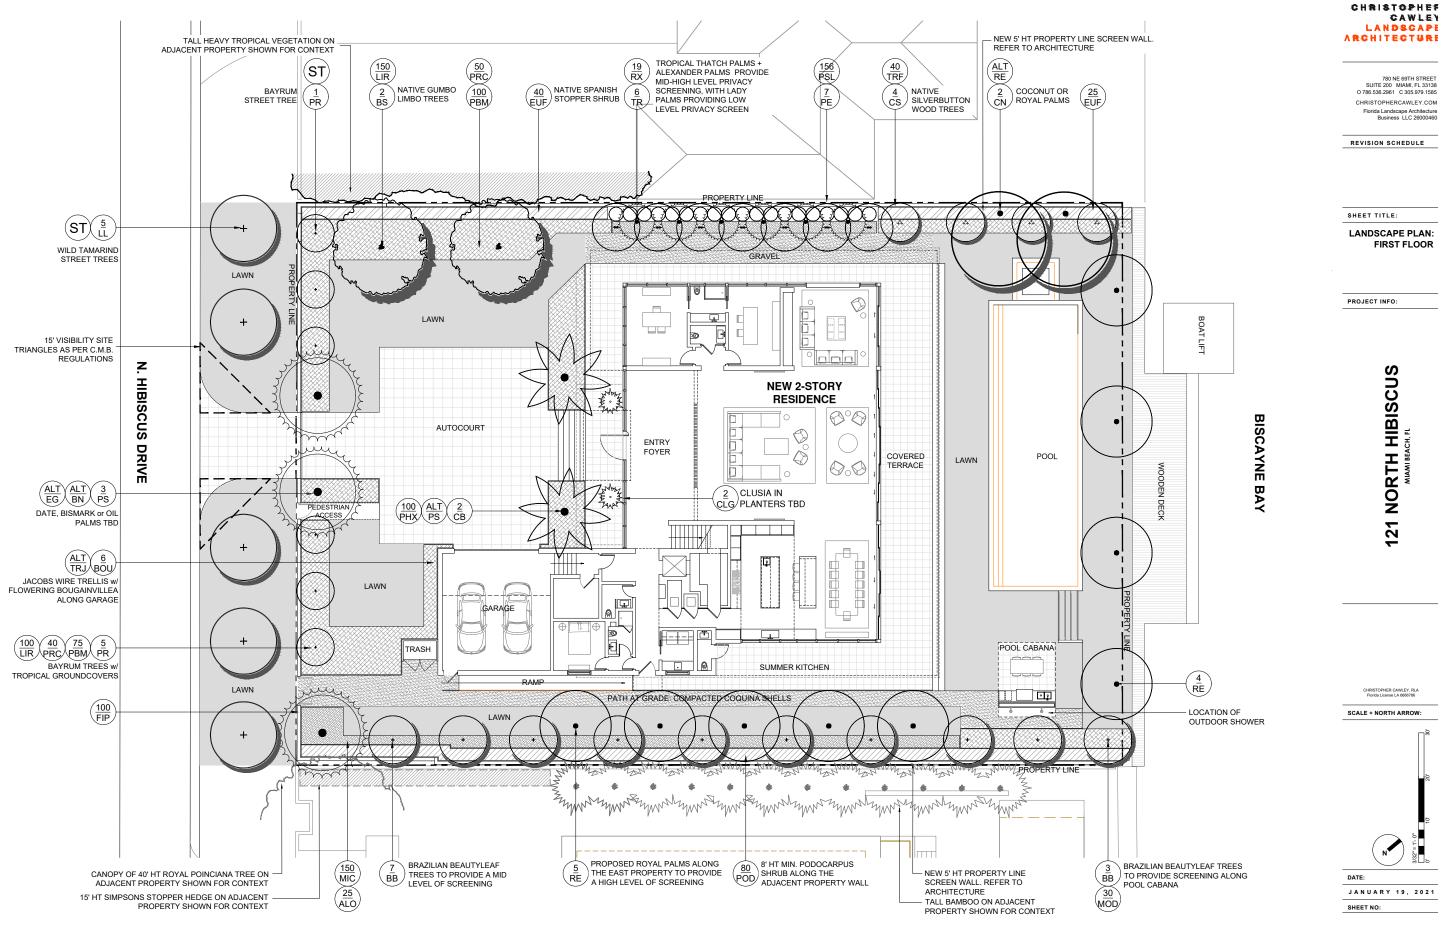

CHRISTOPHEF CAWLEY LANDSCAPE RCHITECTURE

780 NE 69TH STREET SUITE 200 MIAMI, FL 33138 O 786.536.2961 C 305.979.1585 CHRISTOPHERCAWLEY.COM Florida Landscape Architecture Business LLC 26000460

REVISION SCHEDULE

SHEET TITLE:

LANDSCAPE PLAN: FIRST FLOOR RENDERING

PROJECT INFO:

121 NORTH HIBISCUS

CHRISTOPHER CAW Florida License LA 6

SCALE + NORTH ARROW:



DATE:

JANUARY 19, 2021 SHEET NO:

780 NE 69TH STREET SUITE 200 MIAMI, FL 33138 O 786.536.2961 C 305.979.1585 CHRISTOPHERCAWLEY.COM Florida Landscape Architecture Business LLC 26000460

REVISION SCHEDULE


SHEET TITLE:

EAST ELEVATION RENDERING

PROJECT INFO:

121 NORTH HIBISCUS

CHRISTOPHER CAWLEY, RLA Florida License LA 6866786 SCALE + NORTH ARROW:

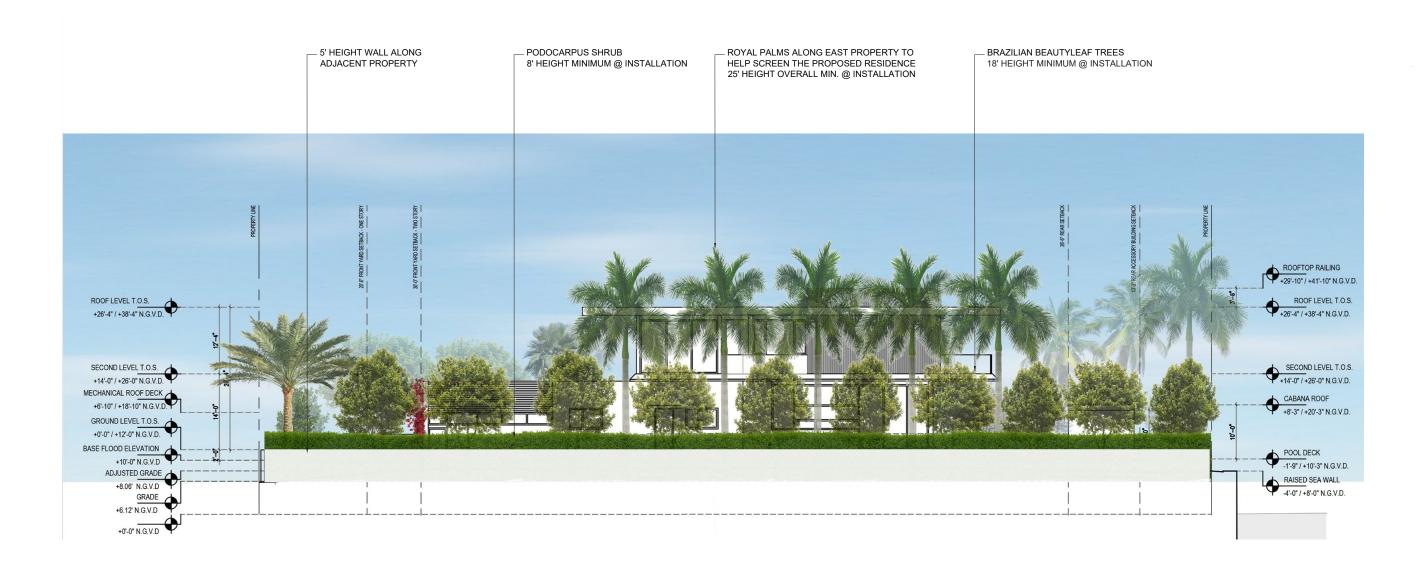

EAST ELEVATION RENDERING

1/8"=1'-


DATE:

JANUARY 19, 2021 SHEET NO:

Proposed Modification of Conditions

- 2. A revised landscape plan, prepared by a Professional Landscape Architect, registered in the State of Florida, and corresponding plans shall be submitted to and approved by staff. The species, type, quantity, dimensions, spacing, location and overall height of all plant material shall be clearly delineated and subject to the review and approval of staff. At a minimum, such plans shall comply with Chapter 26-Landscape Requirements of the Miami Beach Code and shall incorporate the following:
 - a. The landscape design shall include 18' minimum height Brazilian Beautyleaf trees dispersed along the east side property line, in a manner to be reviewed and approved by staff consistent with the Design Review Criteria and/or the directions from the Board.
 - b. The landscape design shall include an 8' minimum height Spanish stopper podocarpus hedge along the entire east side property line, in a manner to be reviewed and approved by staff consistent with the Design Review Criteria and/or the directions from the Board
 - c. The proposed two (2) large seagrape trees three (3) 18' minimum height Brazilian Beautyleaf trees by the cabana are to remain in order to screen cabana from neighbor, in a manner to be reviewed and approved by staff consistent with the Design Review Criteria and/or the directions from the Board.

PROPOSED MODIFICATION OF CONDITIONS

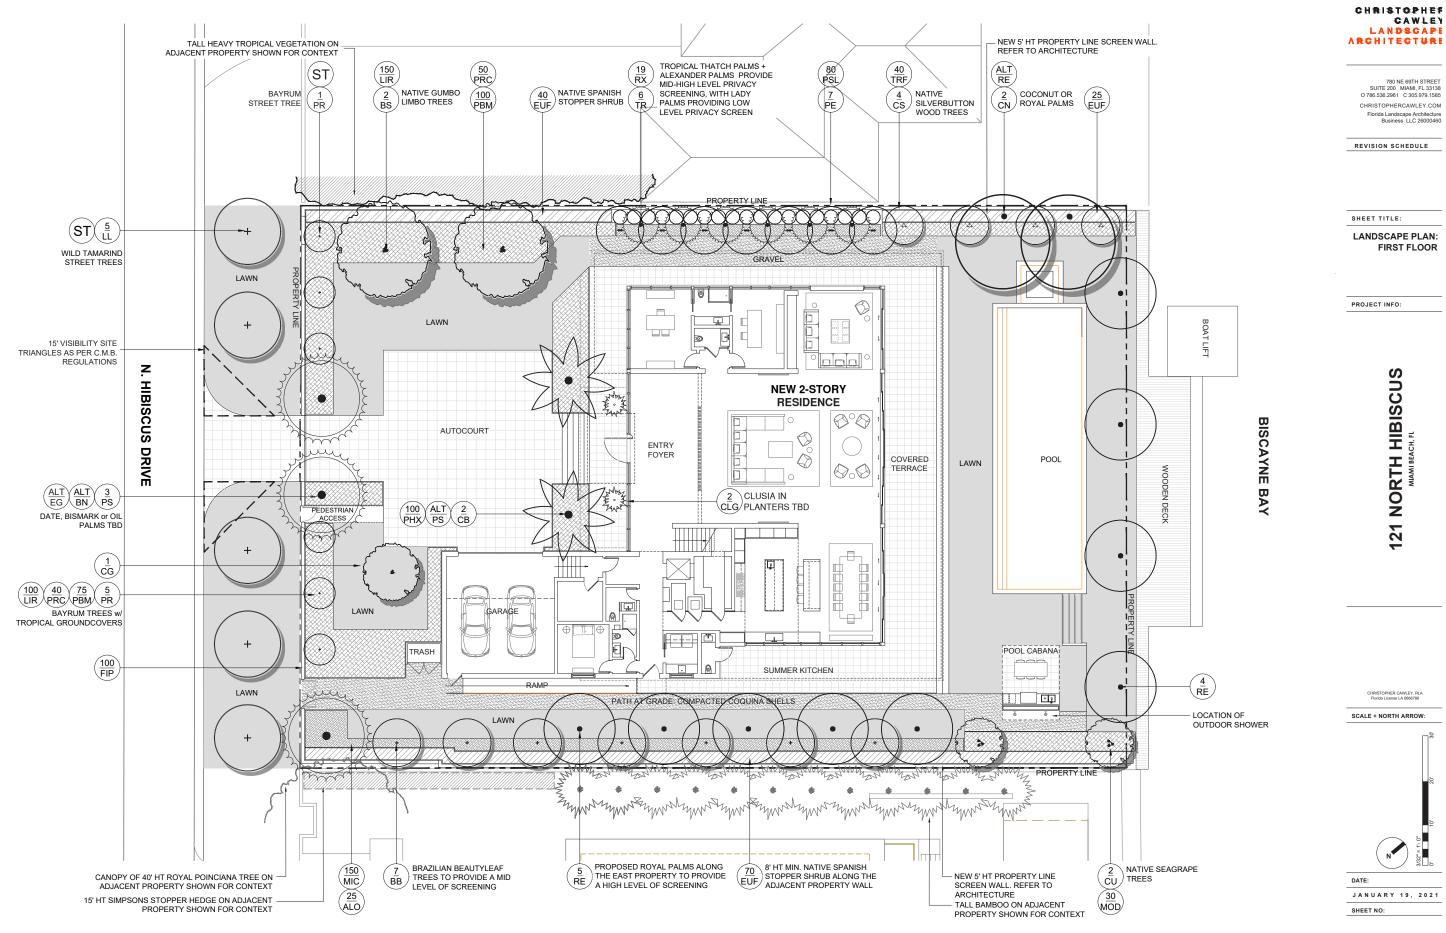

CHRISTOPHEF CAWLEY LANDSCAPE RCHITECTURE

780 NE 69TH STREET SUITE 200 MIAMI, FL 33138 O 786.536.2961 C 305.979.1585 CHRISTOPHERCAWLEY.COM Florida Landscape Architecture Business LLC 26000460

REVISION SCHEDULE

SHEET TITLE:

LANDSCAPE PLAN: FIRST FLOOR RENDERING

PROJECT INFO:

121 NORTH HIBISCUS

CHRISTOPHER CAW Florida License LA 6

SCALE + NORTH ARROW:



DATE:

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780 NE 69TH STREET SUITE 200 MIAMI, FL 33138 O 786.536.2961 C 305.979.1585 CHRISTOPHERCAWLEY.COM Florida Landscape Architecture Business LLC 26000460

REVISION SCHEDULE

SHEET TITLE:

EAST ELEVATION RENDERING

PROJECT INFO:

121 NORTH HIBISCUS



EAST ELEVATION RENDERING

DATE:

JANUARY 19, 2021 SHEET NO:

SINGLE FAMILY RESIDENTIAL - ZONING DATA SHEET

ITEM #	Zoning Information					
1	Address:	121 North Hibiscus Drive, Miami Beach, FL 33139				
2	Folio number(s):	02-3232-006-0540				
3	Board and file numbers :	DRB21-0637				
4	Year built:	Original Structure : 1931 Substantial Additions : 1947, 1948, 1949, 1950, 1954 & 1958 Major Renovations : 1995	Zoning District:	RS-3		
5	Base Flood Elevation:	10' N.G.V.D.	Grade value in NGVD:	6.12' N.G.V.D.		
6	Adjusted grade (Flood+Grade/2):	8.06' N.G.V.D.	Free board:	2'		
7	Lot Area:	21,157 SF				
8	Lot width:	120' (M)	Lot Depth:	176.37' (M)		
9	Max Lot Coverage SF and %:	6,347 SF - 30%	Proposed Lot Coverage SF and %:	6,200 SF / 29.3%		
10	Existing Lot Coverage SF and %:	6,338 SF - 29.9% (w/o courtyard) / 6,850 SF - 32.3% *approx. based off survey	Lot coverage deducted (garage-storage) SF:	500 SF		
11	Front Yard Open Space SF and %:	1,922 SF / 79.3%	Rear Yard Open Space SF and %:	2,302 / 72.3%		
12	Max Unit Size SF and %:	10,578 SF / 50%	Proposed Unit Size SF and %:	8,886 SF / 42%		
13	Existing First Floor Unit Size:	5.470 SF * approx. based off survey	Proposed First Floor Unit Size:	5,028 SF (Including Accessory Building)		
14	Existing Second Floor Unit Size	5.470 SF				
15		* approx. based off survey	Proposed Second Floor Unit Size SF and %:	3,858 SF		
16			Proposed Roof Deck Area SF and % (Note: Maximum is 25% of the enclosed floor area immediately below):	440 SF (Including Stair)		
			5	5 6		

		Required	Existing	Proposed	Deficiencies	
17	Height:	24' - Flat Roof		26'-4"	Height waiver of 2'-4"	
18	Setbacks:					
19	Front First level:	20'-0"		22'-7"		
20	Front Second level:	30'-0"		69'-9"		
21	Side 1:	12'-0"		17'-2"		
22	Side 2 or (facing street):	18'-0"		19'-2"		
23	Rear:	26'-6" (15% of Lot Depth)		51'-6"		
	Accessory Structure Side 1:	7'-6"		7'-10"		
24	Accessory Structure Side 2 or (facing					
	street):	N/A				
25	Accessory Structure Rear:	13'-3" (Half of Rear Setback)		13'-4"		
26		30'-0" (At Least 25% of the				
	Sum of Side yard :	Lot Width)		17'-2" + 19'-2" = 36'-4"		
27	Located within a Local Historic District?			No		
28	Designated as an individual Historic Single Family Residence Site?			No		
29	Determined to be Architecturally Significant?			No - As per DRB20-0630		

121 NORTH HIBISCUS DRIVE RESIDENCE

121 NORTH HIBISCUS DRIVE . MIAMI BEACH . FLORIDA



PRIOR SUBMITTAL ZONING DATA SHEET

SINGLE FAMILY RESIDENTIAL - ZONING DATA SHEET

ITEM #	Zoning Information			
1	Address:	121 North Hibiscus Drive, M	iami Beach, FL 33139	
2	Folio number(s):	02-3232-006-0540		
3	Board and file numbers :	DRB21-0637		
4	Year built:	Original Structure: 1931 Substantial Additions: 1947, 1948, 1949, 1950, 1954 & 1958 Major Renovations: 1995	Zoning District:	RS-3
5	Base Flood Elevation:	10' N.G.V.D.	Grade value in NGVD:	6.12' N.G.V.D.
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8	Lot width:	120' (M)	Lot Depth:	176.37' (M)
9	Max Lot Coverage SF and %:	6,347 SF - 30%	Proposed Lot Coverage SF and %:	6,204 SF / 29.3%
10	Existing Lot Coverage SF and %:	6,338 SF - 29.9% (w/o courtyard) / 6,850 SF - 32.3% *approx. based off survey	Lot coverage deducted (garage-storage) SF:	500 SF
11	Front Yard Open Space SF and %:	1,922 SF / 79.3%	Rear Yard Open Space SF and %:	2,236 SF / 70.3%
12	Max Unit Size SF and %:	10,578 SF / 50%	Proposed Unit Size SF and %:	8,781 SF / 41.5%
13	Existing First Floor Unit Size:	* approx. based off survey	Proposed First Floor Unit Size:	4,923 SF
14	Existing Second Floor Unit Size	5.470 SF		
15		* approx. based off survey	Proposed Second Floor Unit Size SF and %:	3,858 SF
16			Proposed Roof Deck Area SF and % (Note: Maximum is 25% of the enclosed floor area	AAO CE (Including Civil)
			immediately below):	440 SF (Including Stair)

		Required	Existing	Proposed	Deficiencies	
17					Height waiver of 2'-4"	
	Height:	24' - Flat Roof			Approved by DRB on 4/6/21	
18	Setbacks:					
19	Front First level:	20'-0"		22'-7"		
20	Front Second level:	30'-0"		69'-9"		
21	Side 1:	12'-0"		17'-2"		
22	Side 2 or (facing street):	18'-0"		19'-2"		
23	Rear:	26'-6" (15% of Lot Depth)		51'-6"		
	Accessory Structure Side 1:	7'-6"		12'-3"		
24	Accessory Structure Side 2 or (facing					
	street):	N/A				
25		13'-3" (Half of Rear				
	Accessory Structure Rear:	Setback)		14'-4"		
26		30'-0" (At Least 25% of the				
	Sum of Side yard :	Lot Width)		17'-2" + 19'-2" = 36'-4"		
27	Located within a Local Historic District?			No		
28	Designated as an individual Historic Single Family Residence Site?		No			
29	Determined to be Architecturally Significant?			No - As per DRB20-0630		

121 NORTH HIBISCUS DRIVE RESIDENCE


121 NORTH HIBISCUS DRIVE . MIAMI BEACH . FLORIDA



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PROPOSED REVISION

ZONING DATA SHEET

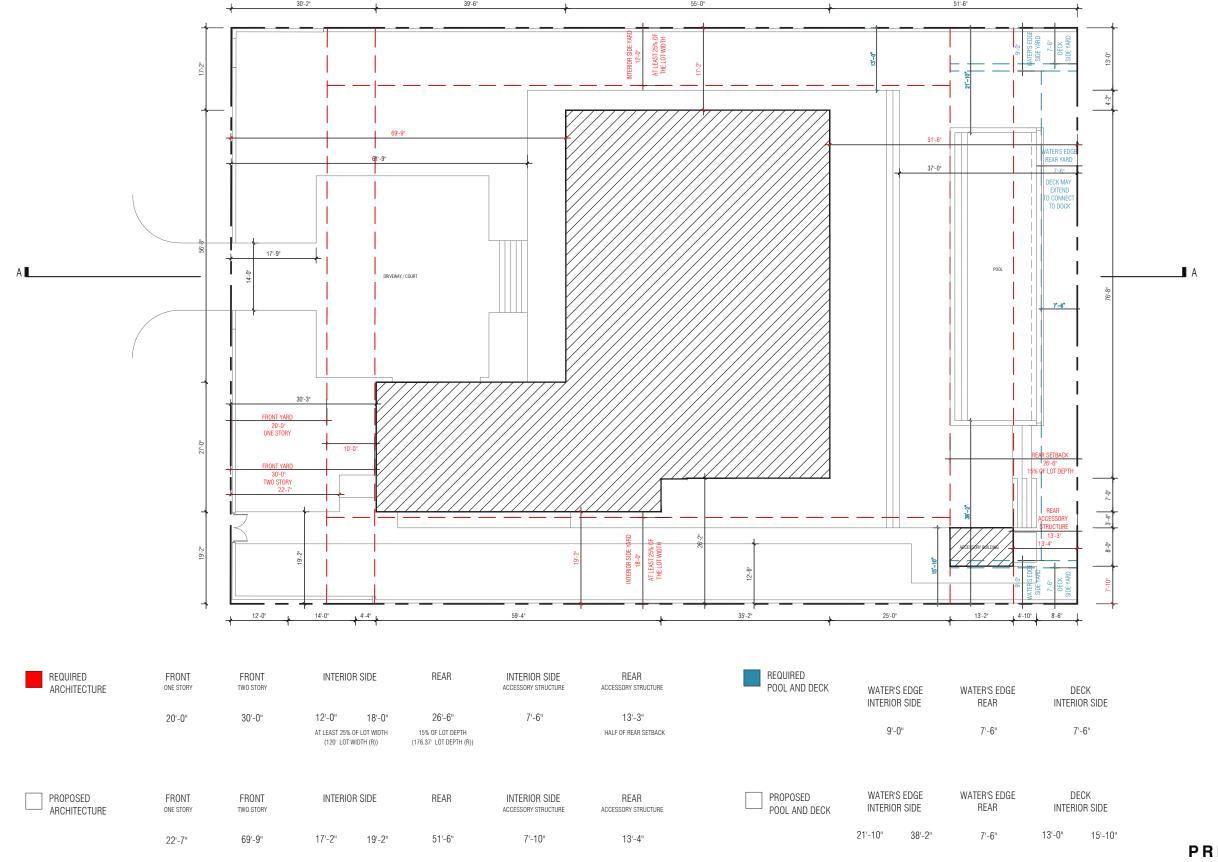


PRIOR SUBMITTAL

SETBACK DIAGRAM - GROUND FLOOR

SCALE: 1" = 20'-0"

121 NORTH HIBISCUS DRIVE RESIDENCE



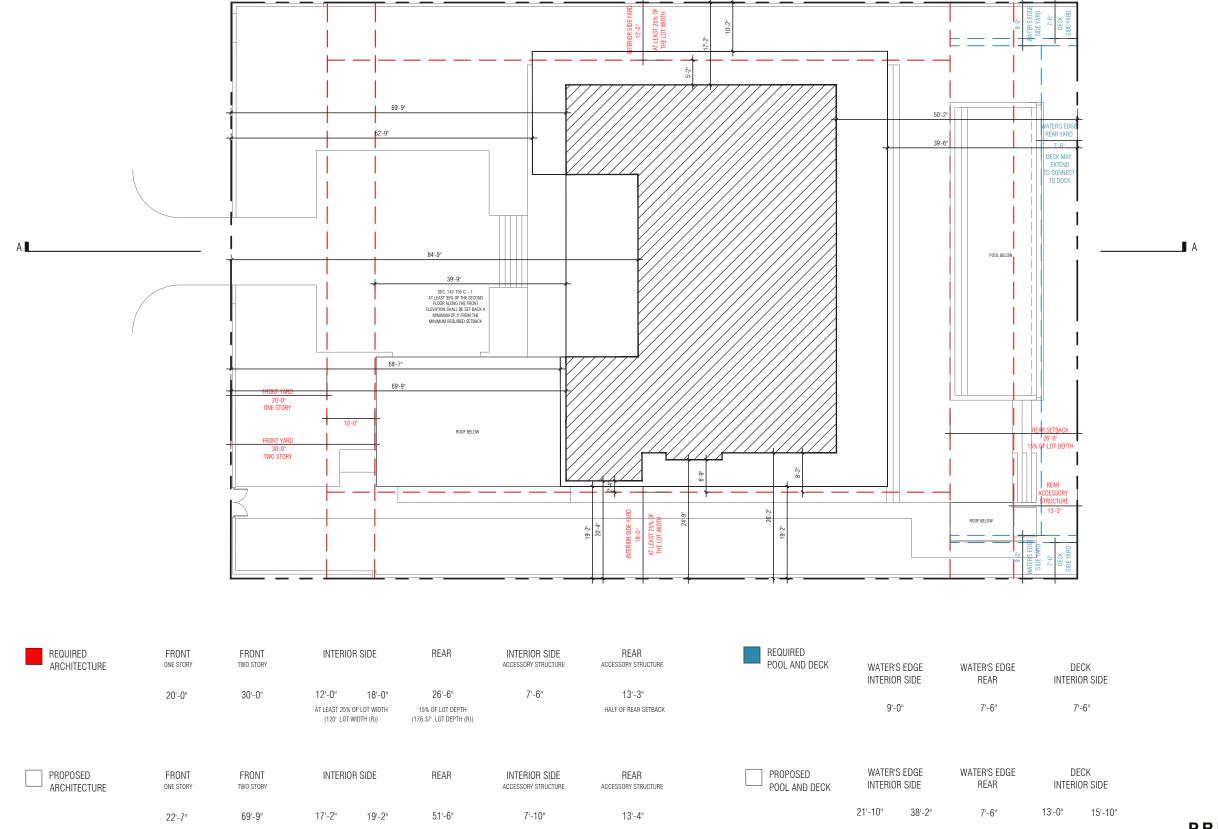

PRIOR SUBMITTAL

SETBACK DIAGRAM - SECOND FLOOR


SCALE: 1" = 20'-0"

5' 10' 25' 50'

1

121 NORTH HIBISCUS DRIVE RESIDENCE



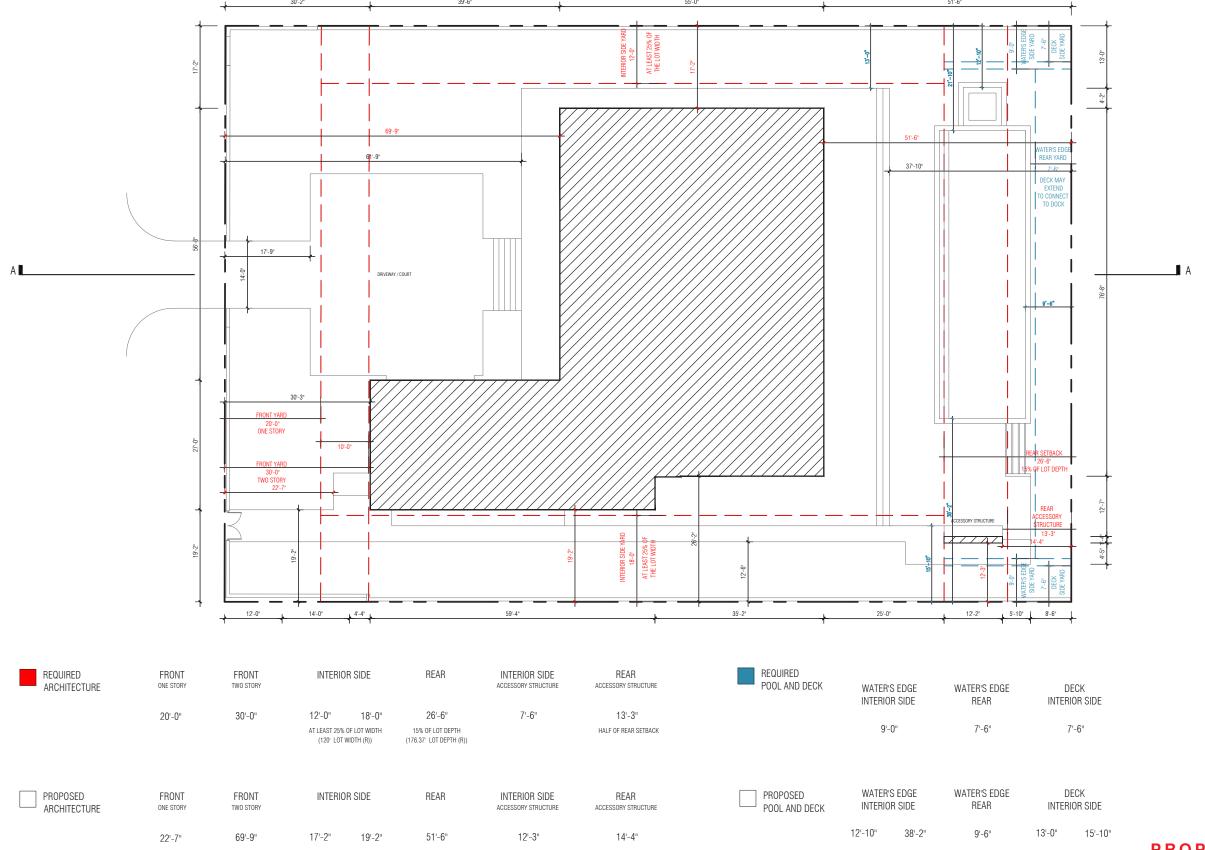

PROPOSED REVISION

SETBACK DIAGRAM - GROUND FLOOR

SCALE: 1" = 20'-0"


121 NORTH HIBISCUS DRIVE . MIAMI BEACH . FLORIDA

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121 NORTH HIBISCUS DRIVE RESIDENCE

A-4.R



UNIT SIZE

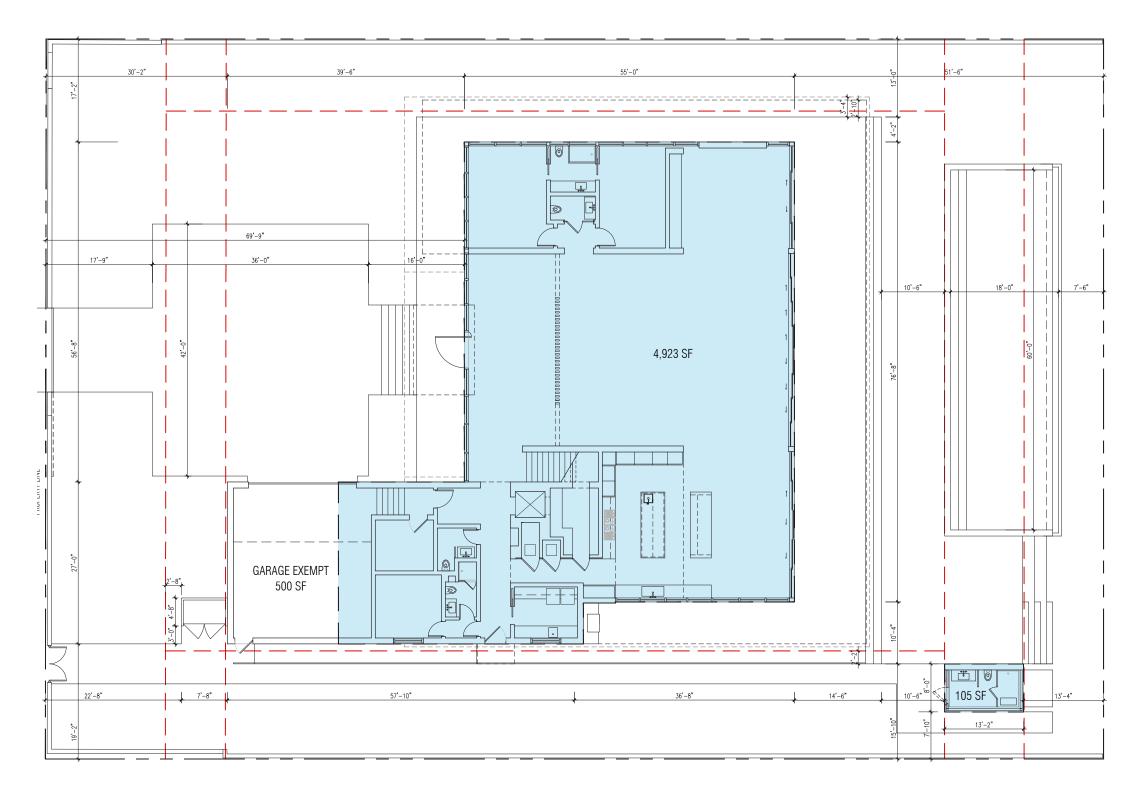ALLOWABLE GROUND LEVEL GROUND LEVEL **GROUND LEVEL** SECOND LEVEL TOTAL UNIT SIZE ACCESSORY BUILDING GARAGE EXEMPT AREA **UNIT SIZE** 500 SF 10,578 SF 5,028 SF 105 SF 3,858 SF 8,886 SF 50% OF NET LOT AREA (21,157 SF) (INCL. ACCESSORY BUILDING) 42% OF LOT AREA (21,157 SF)

PRIOR SUBMITTAL

PROPOSED DIAGRAMS - UNIT SIZE - GROUND LEVEL


SCALE: 1/16" = 1'-0"

50' 50' 61



121 NORTH HIBISCUS DRIVE RESIDENCE



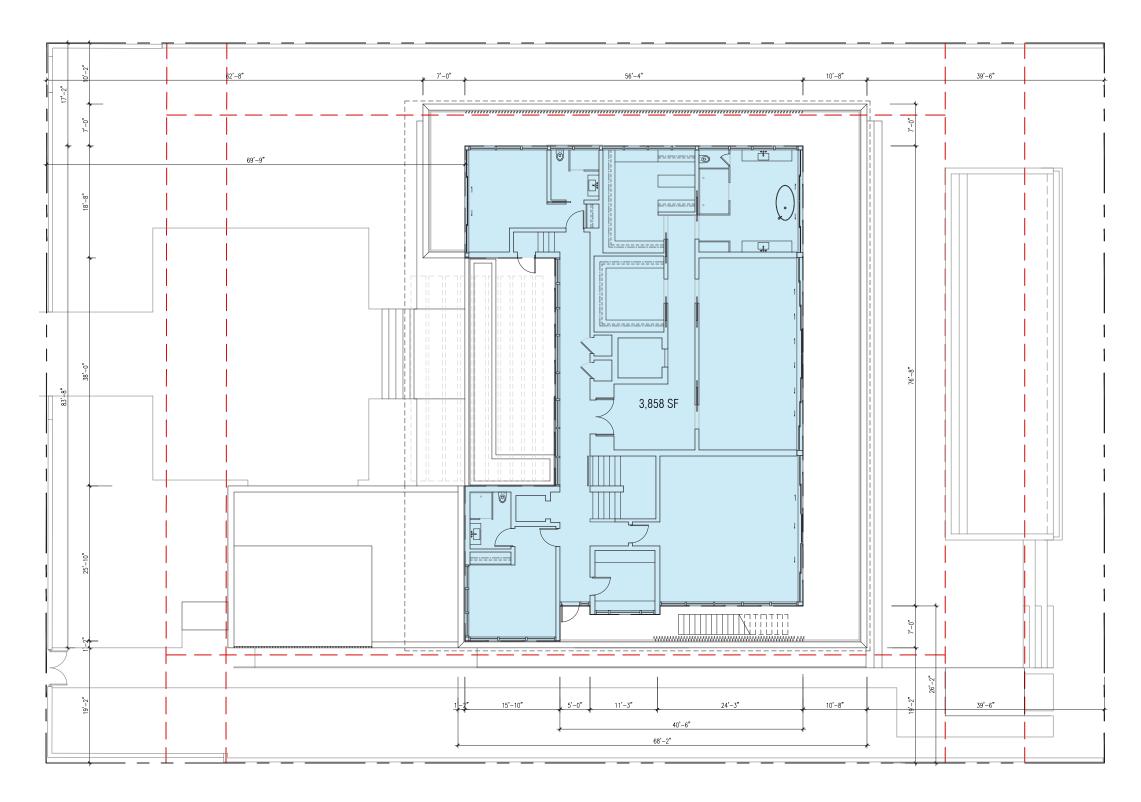

UNIT SIZE

ALLOWABLE GROUND LEVEL GROUND LEVEL **GROUND LEVEL** SECOND LEVEL TOTAL UNIT SIZE ACCESSORY BUILDING GARAGE EXEMPT AREA **UNIT SIZE** 105 SF 500 SF 3,858 SF 10,578 SF 5,028 SF 8,886 SF 50% OF NET LOT AREA (21,157 SF) (INCL. ACCESSORY BUILDING) 42% OF LOT AREA (21,157 SF)


PRIOR SUBMITTAL

PROPOSED DIAGRAMS - UNIT SIZE - SECOND LEVEL SCALE: 1/16" = 1'-0"



121 NORTH HIBISCUS DRIVE RESIDENCE



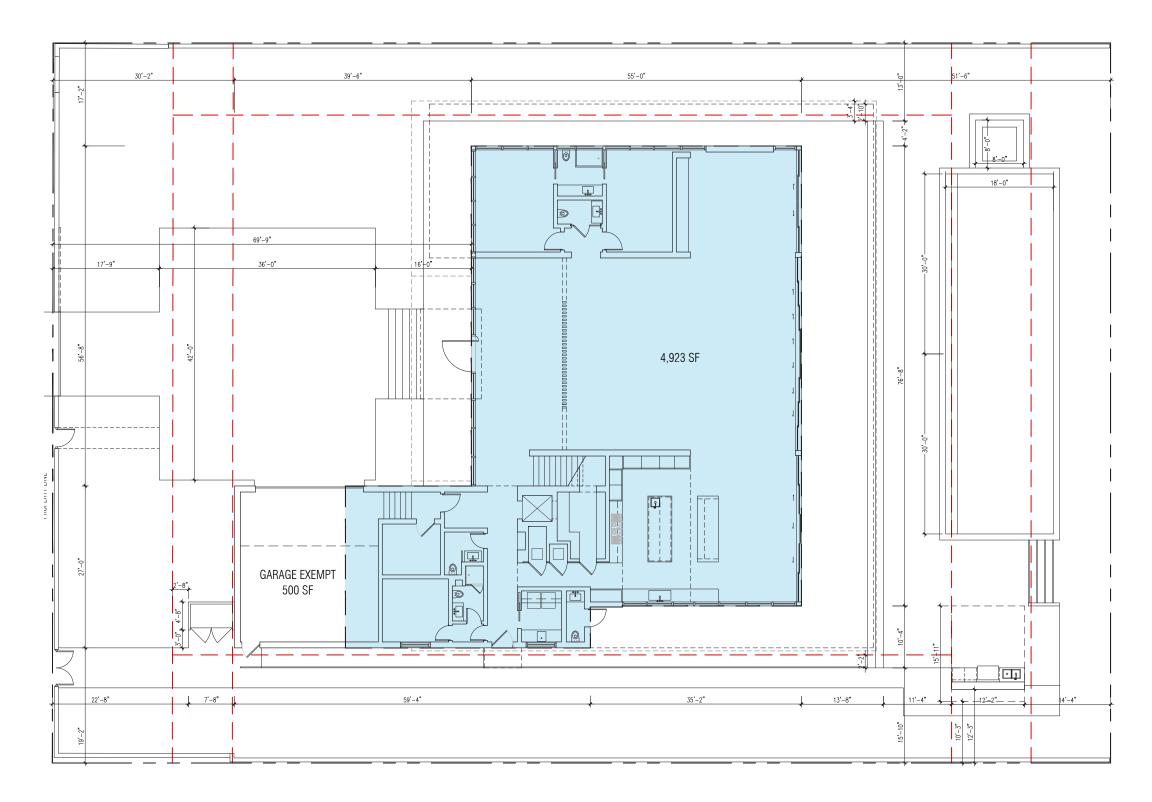

UNIT SIZE

ALLOWABLE GROUND LEVEL GROUND LEVEL **GROUND LEVEL** SECOND LEVEL TOTAL UNIT SIZE ACCESSORY BUILDING GARAGE EXEMPT AREA **UNIT SIZE** 500 SF 10,578 SF 4,923 SF 0 SF 3,858 SF 8,781 SF 50% OF NET LOT AREA (21,157 SF) (INCL. ACCESSORY BUILDING) 41.5% OF LOT AREA (21,157 SF)


PROPOSED REVISION

PROPOSED DIAGRAMS - UNIT SIZE - GROUND LEVEL SCALE: 1/16"=1'-0"



121 NORTH HIBISCUS DRIVE RESIDENCE



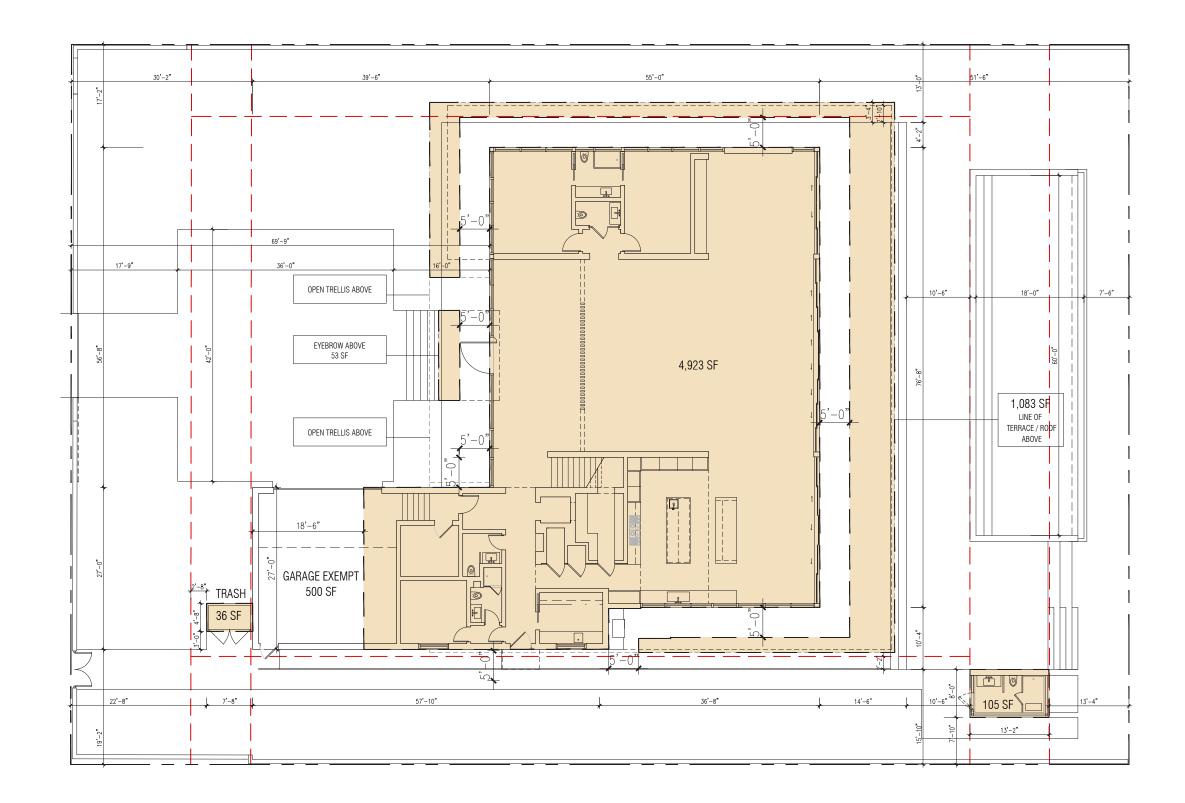

LOT COVERAGE

LOT AREA

MAX LOT COVERAGE

ALLOWED

21,157 SF

6,347 SF - 30%

PROVIDED 6,200 SF - 29.3%

LOT COVERAGE

121 NORTH HIBISCUS DRIVE RESIDENCE

121 NORTH HIBISCUS DRIVE . MIAMI BEACH . FLORIDA




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PRIOR SUBMITTAL

PROPOSED DIAGRAMS - LOT COVERAGE

SCALE: 1/16"=1'-0"

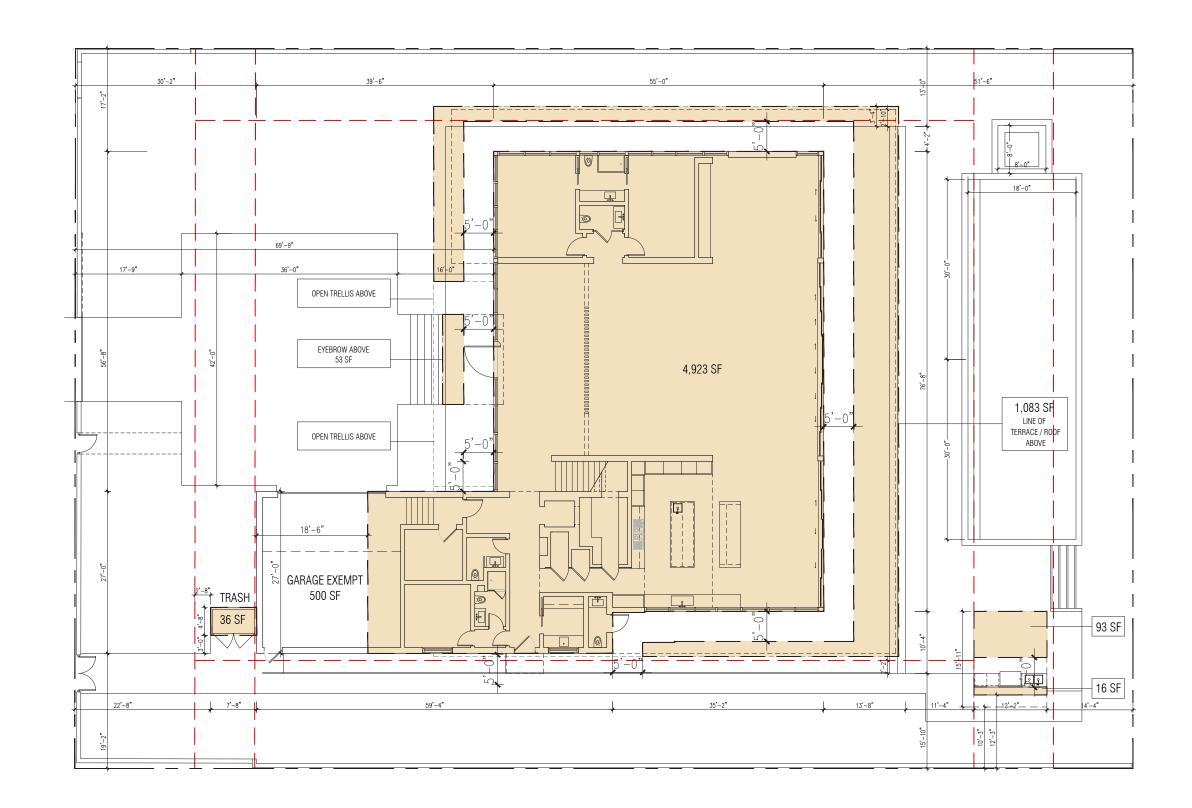

LOT COVERAGE

LOT AREA

MAX LOT COVERAGE ALLOWED

21,157 SF 6,347 SF - 30%

PROVIDED 6,204 SF - 29.3%

LOT COVERAGE

121 NORTH HIBISCUS DRIVE RESIDENCE

121 NORTH HIBISCUS DRIVE . MIAMI BEACH . FLORIDA




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PROPOSED REVISION

PROPOSED DIAGRAMS - LOT COVERAGE

SCALE: 1/16"=1'-0"

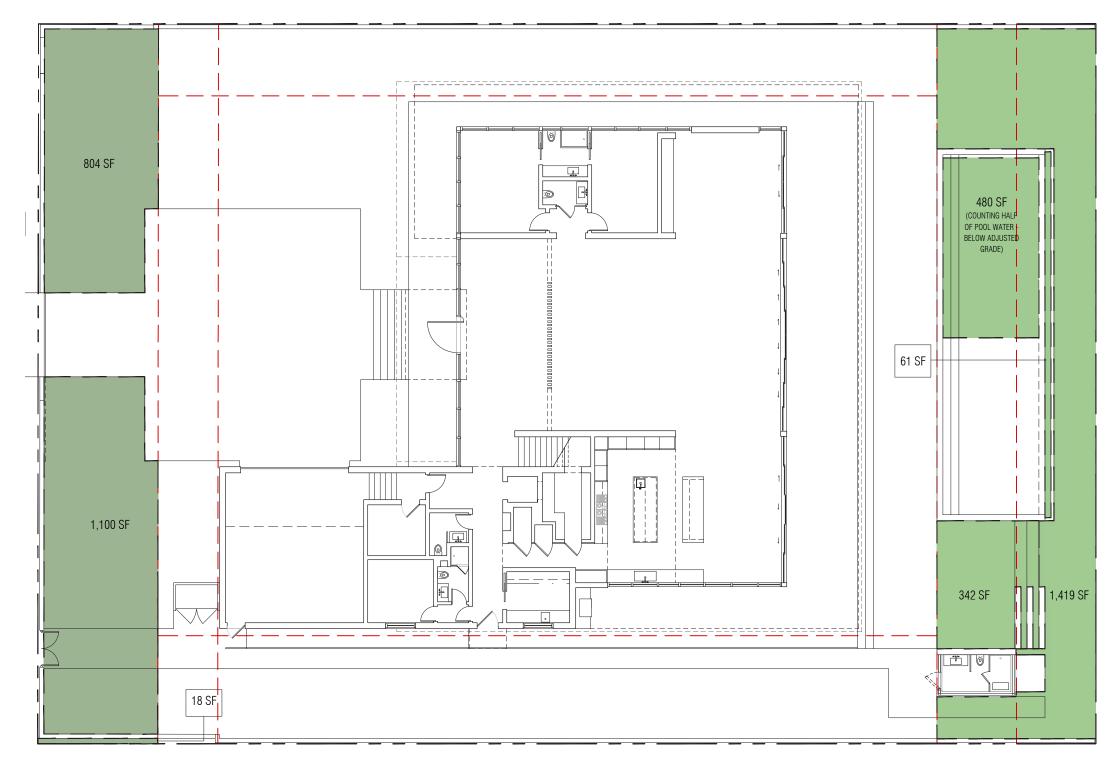

OPEN SPACE

RS-3 YARD AREA OPEN SPACE REQUIRED OPEN SPACE PROVIDED

FRONT 2,400 SF 1,200 SF - 50% 1,922 SF - 79.3%

REAR 3,180 SF 2,226 SF - 70% 2,302 SF - 72.3%

121 NORTH HIBISCUS DRIVE RESIDENCE

121 NORTH HIBISCUS DRIVE . MIAMI BEACH . FLORIDA




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PRIOR SUBMITTAL

PROPOSED DIAGRAMS - OPEN SPACE

SCALE: 1/16"=1'-0"

5' 10' 25' 50'

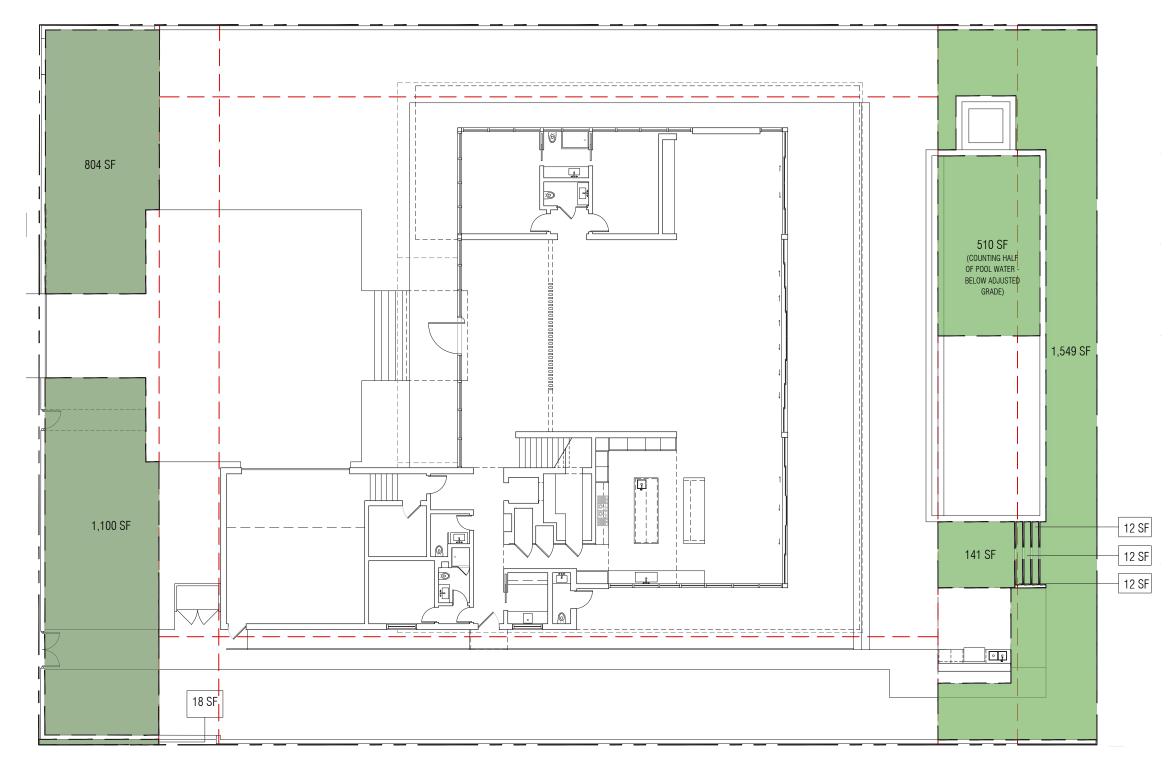

OPEN SPACE

RS-3 YARD AREA OPEN SPACE REQUIRED OPEN SPACE PROVIDED

FRONT 2,400 SF 1,200 SF - 50% 1,922 SF - 79.3%

REAR 3,180 SF 2,226 SF - 70% 2,236 SF - 70.3%

121 NORTH HIBISCUS DRIVE RESIDENCE

121 NORTH HIBISCUS DRIVE . MIAMI BEACH . FLORIDA



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PROPOSED REVISION

PROPOSED DIAGRAMS - OPEN SPACE

SCALE: 1/16" = 1'-0"

5' 10' 25' 50'

780 NE 69TH STREET SUITE 200 MIAMI, FL 33138 O 786.536.2961 C 305.979.1585 CHRISTOPHERCAWLEY.COM Florida Landscape Architecture Business LLC 26000460

REVISION SCHEDULE

SHEET TITLE:


EXISTING TREE SURVEY + DISPOSITION PLAN

PROJECT INFO:

121 NORTH HIBISCUS

CHRISTOPHER CAWLEY


SCALE + NORTH ARROW:

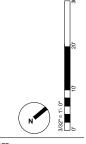


DATE:

JANUARY 19, 2021 SHEET NO:

L1.0

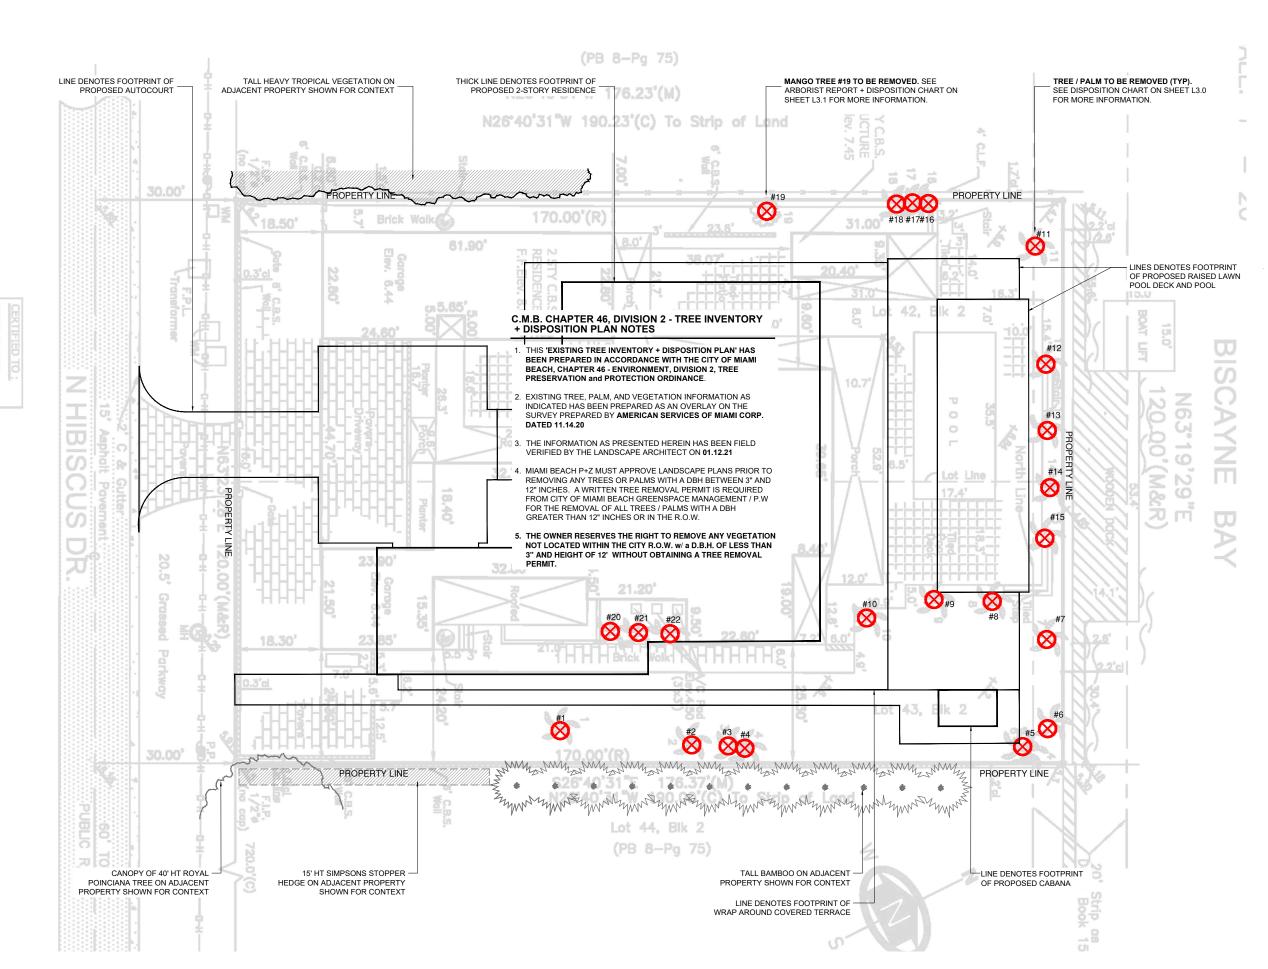

CHRISTOPHER CAWLEY LANDSCAPE

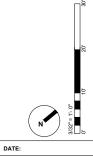

SHEET NO:


CHRISTOPHER

ALL FOLLOWING SHEETS PREVIOUSLY APPROVED FOR REFERENCE ONLY

SKETCH OF BOUNDARY SURVEY

SCALE: 1" = 20'

BISCAYNE BAY

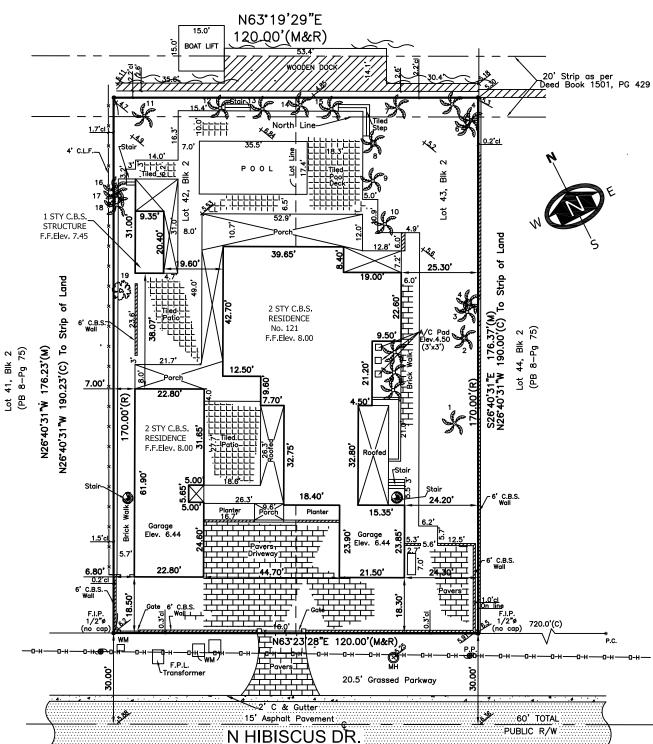

CERTIFIED TO:

No.	TREE NAME	BOTANICAL NAME	D.B.H.	HEIGHT	SPREAD
1-2	ROYAL PALM	ROYSTONIA ELATA	1.7'	50'	50'
3	ROYAL PALM	ROYSTONIA ELATA	2.0'	50'	50'
4	ROYAL PALM	ROYSTONIA ELATA	1.5'	50'	50'
5	ROYAL PALM	ROYSTONIA ELATA	0.5	25'	8'
6-9	COCONUT	COCOS NUCIFERA	1.0'	30'	30'
10	COCONUT	COCOS NUCIFERA	1.8'	50'	50'
12-15	COCONUT	COCOS NUCIFERA	0.5'	25'	8'
16	ROYAL PALM	ROYSTONIA ELATA	1.3'	50'	50'
17	MANGO TREE	MANGIFERA INDICA	2.0'	50'	50'

LOCATION MAP SCALE: NTS



SITE PICTURE



ABREVIATION (IF ANY APPLIED)

SURVEYOR'S LEGEND (IF ANY APPLIED)

	BOUNDARY LINE		CATCH BASIN
\blacksquare	STRUCTURE (BLDG.)	0	MANHOLE
=	CONCRETE BLOCK WALL	0.E.	OVERHEAD ELECT
	METAL FENCE	•	POWER POLE
	WOODEN FENCE	ф	LIGHT POLE
	CHAIN LINK FENCE	£	HANDICAP SPACE
	WOOD DECK/DOCK	Or	
***********	ASPHALTED AREAS	ъ	FIRE HYDRANT

CONCRETE BRICKS OR PAVERS

FIRE HYDRANT EASEMENT LINE ■ WATER VALVE tv TV-CABLE BOX

ROOFED AREAS WM WATER METER WATER (EDGE OF WATER) CONC. LIGHT POL

ENCROACHMENTS AND OTHER POINTS OF INTEREST:

JOB NUMBER: 20-1046 DATE OF SURVEY: NOVEMBER 14,2020 FOLIO NUMBER: 02-3232-006-0540

SITE ADDRESS: 121 N HIBISCUS DR , MIAMI BEACH, FL. 33139

HE SUBJECT PROPERTY IS WITHIN A FLOOD ZONE AE (SEE NOTE 1 FRE NO PLATTED UTIL. FASEMENT ON THE SUBJECT PROPERTY

JOB SPECIFIC SURVEYOR NOTES

- THE PROPERTY DESCRIBED ON THIS SURVEY <u>DOES LIE</u> WITHIN A SPECIAL HAZARD AREA AS DEFINED BY THE FEDERAL EMERGENCY MANAGEMENT AGENCY; THE PROPERTY LIES WITHIN A FLOOD ZONE "<u>AE</u>" OF THE FLOOD INSURANCE RATE MAP IDENTIFIED AS COMMUNITY PANEL No. <u>120651-316L</u>, WITH AN EFFECTIVE DATE OF SEPTEMBER 11, 2009. <u>BASE FLOOD ELEVATION OF 10.00 FEET</u> (NGVD)
- 2 LAND AREA OF SUBJECT PROPERTY: 21,000 SF (+/-) AS PER PUBLIC RECORDS/ 21,157 SF (+/-) (CALCULATED)
- 3 ELEVATIONS ARE BASED ON THE NATIONAL GEODETIC VERTICAL DATUM (NGVD) OF 1929, AS PER MIAMI DADE COUNTY BENCH MARK No. D-175, WITH AN ELEVATION OF 7.69
- ♠ BEARINGS SHOWN HEREON ARE BASED ON AN ASSUME MERIDIAN OF N.00°07'12"W., BEING THE RECORDED BEARING FOR THE CENTERLINE OF WEST PALM MIDWAY., AS SHOWN ON PLAT BOOK 8 AT PAGE 75 OF THE PUBLIC RECORD OF MIAMI DADE COUNTY FLORIDA.

GENERAL SURVEYOR NOTES:
NOT VALID WITHOUT THE SIGNATURE AND RAISED SEAL OF A FLORIDA LICENSED SURVEYOR AND MAPPER

THE SHOWN LEGAL DESCRIPTION USED TO PERFORM THIS BOUNDARY SURVEY WAS PROVIDED BY THE CLIENT.

SURVEY IS BASED ON RECORDED INFORMATION PROVIDED BY CLIENT. NO SPECIFIC SEARCH OF THE PUBLIC RECORD HAS BEEN MADE BY OUR OFFICE.

UNLESS OTHERWISE NOTED. AN EXAMINATION OF THE ABSTRACT OF TITLE WAS NOT DONE BY THE SIGNING SURVEYOR TO DETERMINE WHICH INSTRUMENTS. IF ANY ARE AFFECTING THE SUBJECT PROPERTY

THIS SURVEY IS EXCLUSIVELY FOR THE USE OF THE PARTIES TO WHOM IT WAS CERTIFIED

PURSUANT TO RULE 5J-17 OF THE FLORIDA ADMINISTRATIVE CODE THE EXPECTED USE OF LAND IS SUBURBAN, THE MINIMUM RELATIVE DISTANCE ACCURACY FOR THIS TYPE OF SURVEY IS 1 FOOT IN 7.500 FEET. THE ACCURACY OBTAINED BY MEASUREMENT AND CALCULATIONS OF CLOSED GEOMETRIC FIGURES WAS FOUND TO EXCEED THIS REQUIREMENT

THERE ARE NO VISIBLE, ABOVE GROUND ENCROACHMENTS (a) BY THE IMPROVEMENTS OF THE SUBJECT PROPERTY UPON ADJOINING PROPERTIES, STREETS OR ALLEYS, OR (b) BY THE IMPROVEMENTS OF THE ADJOINING PROPERTIES, STREETS OR ALLEYS UPON THE SUBJECT PROPERTY OTHER THAN THOSE SHOWN ON THIS BOUNDARY SURVEY

THERE ARE NO VISIBLE EASEMENTS OR RIGHT-OF-WAY OF WHICH THE UNDERSIGNED HAS BEEN ADVISED OTHER THAN THOSE SHOWN ON THIS SURVEY.

THE MAP OF SURVEY IS INTENDED TO BE DISPLAYED AT THE SHOWN GRAPHIC SCALE IN ENGLISH UNITS OF MEASUREMENT. IN SOME CASES GRAPHIC REPRESENTATION HAVE BEEN EXAGERATED TO MORE CLEARLY ILLUSTRATE A PARTICULAR AREA WHERE DIMENSIONS SHALL HAVE PREFERENCE OVER GRAPHIC LOCATION

THE FLEATIONS (IF ANY) OF WELL-IDENTIFIED FEATURES AS DEPICTED ON THIS SURVEY AND MAP WERE MEASURED TO AN ESTIMATED VERTICAL POSITIONAL ACCURACY OF X₁₀ FOOT FOR NATURAL GROUND SURFACES AND $\frac{1}{100}$ FOOT FOR HARDSCAPE SURFACES, INCLUDING PAVEMENT, CURBS, SIDEWALKS AND OTHER MANMADE STRUCTURES.

THE SURVEYOR MAKES NO REPRESENTATION AS TO OWNERSHIP, POSSESSION OR OCCUPATION OF THE SUBJECT PROPERTY BY ANY ENTITY OR INDIVIDUAL

ANY FEMA ELOOD ZONE INFORMATION PROVIDED ON THIS SURVEY IS FOR INFORMATIONAL PURPOSE ONLY AND IT WAS OBTAINED AT WWW.FEMA.COM.

IF YOU ARE READING THIS BOUNDARY SURVEY IN AN ELECTRONIC FORMAT, THE INFORMATION CONTAINED ON THIS DOCUMENT IS ONLY VALID IF THIS DOCUMENT IS ELECTRONICALLY SIGNED AS SPECIFIED IN CHAPTER 5J-17.062 (3) OF THE FLORIDA ADMINISTRATIVE CODE. IF THIS DOCUMENT IS IN PAPER FORMAT, IT IS NOT VALID WITHOUT THE SIGNATURE AND ORIGINAL RAISED SEAL OF THE PROFESSIONAL LAND SURVEYOR AND MAPPER OF RECORD.

LEGAL DESCRIPTION:

LOT 42 AND 43. BLOCK 2. HIBISCUS ISLAND. ACCORDING TO THE MAP OR PINT THEREOF AS RECORDED IN PLAT BOOK 8, PAGE 75, PUBLIC RECORDS OF MIAMI-DADE COUNTY, FLORIDA; ALSO ALL THAT PART OF 20 FT. STRIP OF LAND CONVEYED BY THE TRUSTEES OF THE INTERNAL IMPROVEMENT FUND TO THE BISCAYNE BAY ISLAND COMPANY BY DEED DATED SEPTEMBE 14, 1932, AND RECORDED IN DEED BOOK 1501, PAGE 479, OF THE PUBLIC RECORDS OF DADE COUNTY, FLORIDA, WHICH LIES NORTHEASTERLY AND CONTIGUOUS TO THE NORTHEASTERL BOUNDARY LINES OF LOTS 42 AND 43 OF BLOCK 2, OF HIBISCUS ISLAND, ACCORDING TO THE PLAT THEREOF RECORDED IN PLOT BOOK 8, PAGE 75, OF THE PUBLIC RECORDS OF DADE COUNTY, FLORIDA, AND BETWEEN THE NORTHWESTERLY LINE OF LOT 42 OF BLOCK 2 OF THE AFORESAID SUBDIVISION EXTENDED NORTHEASTERLY INTO BISCAYNE BAY AND THE SOUTHEASTERLY LINE OF LOT 43, BLOCK 2, OF THE AFORESAID SUBDIVISION EXTENDED NORTHEASTERLY INTO BISCAYNE BAY, TOGETHER WITH RIPARIAN AND/OR LITTORAL RIGHTS.


WE HEREBY CERTIFY THAT THIS BOUNDARY AND TOPOGRAPHICAL SURVEY AND THE SURVEY MAP RESULTING THEREFROM WAS PERFORMED UNDER MY SUPERVISION AND/OR DIRECTION AND IS TRUE AND CORRECT TO THE BEST OF MY KNOWLEDGE AND BELIEF AND FURTHER, THAT SAID "BOUNDARY AND TOPOGRAPHICAL SURVEY" MEETS THE INTENT OF THE APPLICABLE PROVISIONS OF THE "STANDARDS OF PRACTICE FOR LAND SURVEYING IN THE STATE OF FLORIDA", PURSUANT TO RULE 53-17 OF THE FLORIDA ADMINISTRATIVE CODE AND ITS IMPLEMENTING LAW, CHAPTER 472.027 FO THE FLORIDA STATUTES.



American Services of Miami, Consulting Engineers . Planners . Surveyors

> 3195 PONCE DE LEON BLVD, SUITE 200 CORAL GABLES, FL 33134 PHONE: (305)598-5101 FAX: (305)598-8627



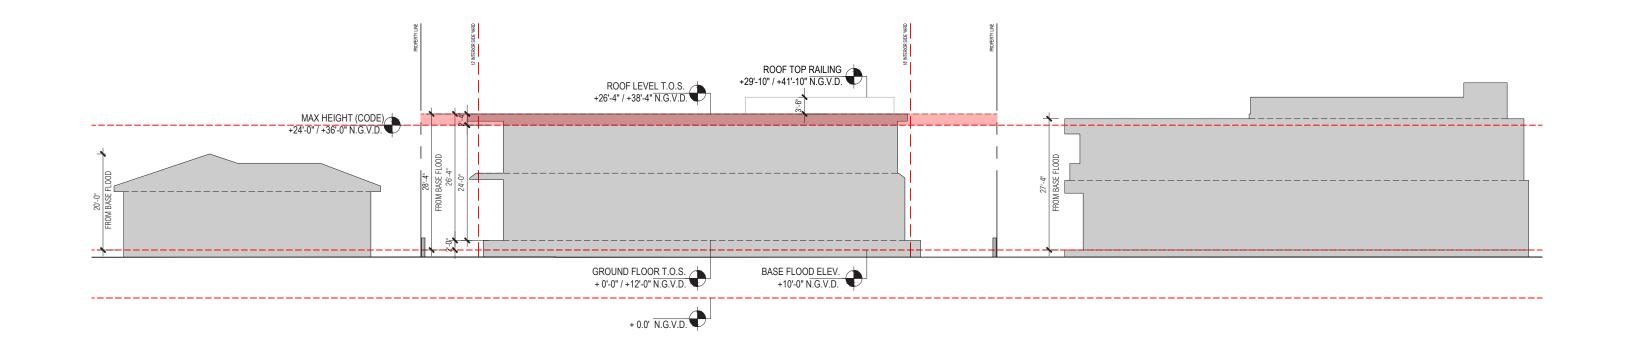

121 NORTH HIBISCUS DRIVE RESIDENCE


121 NORTH HIBISCUS DRIVE . MIAMI BEACH . FLORIDA

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WAIVER DIAGRAM

SCALE: 1" = 20'-0"

5' 10' 25' 50'

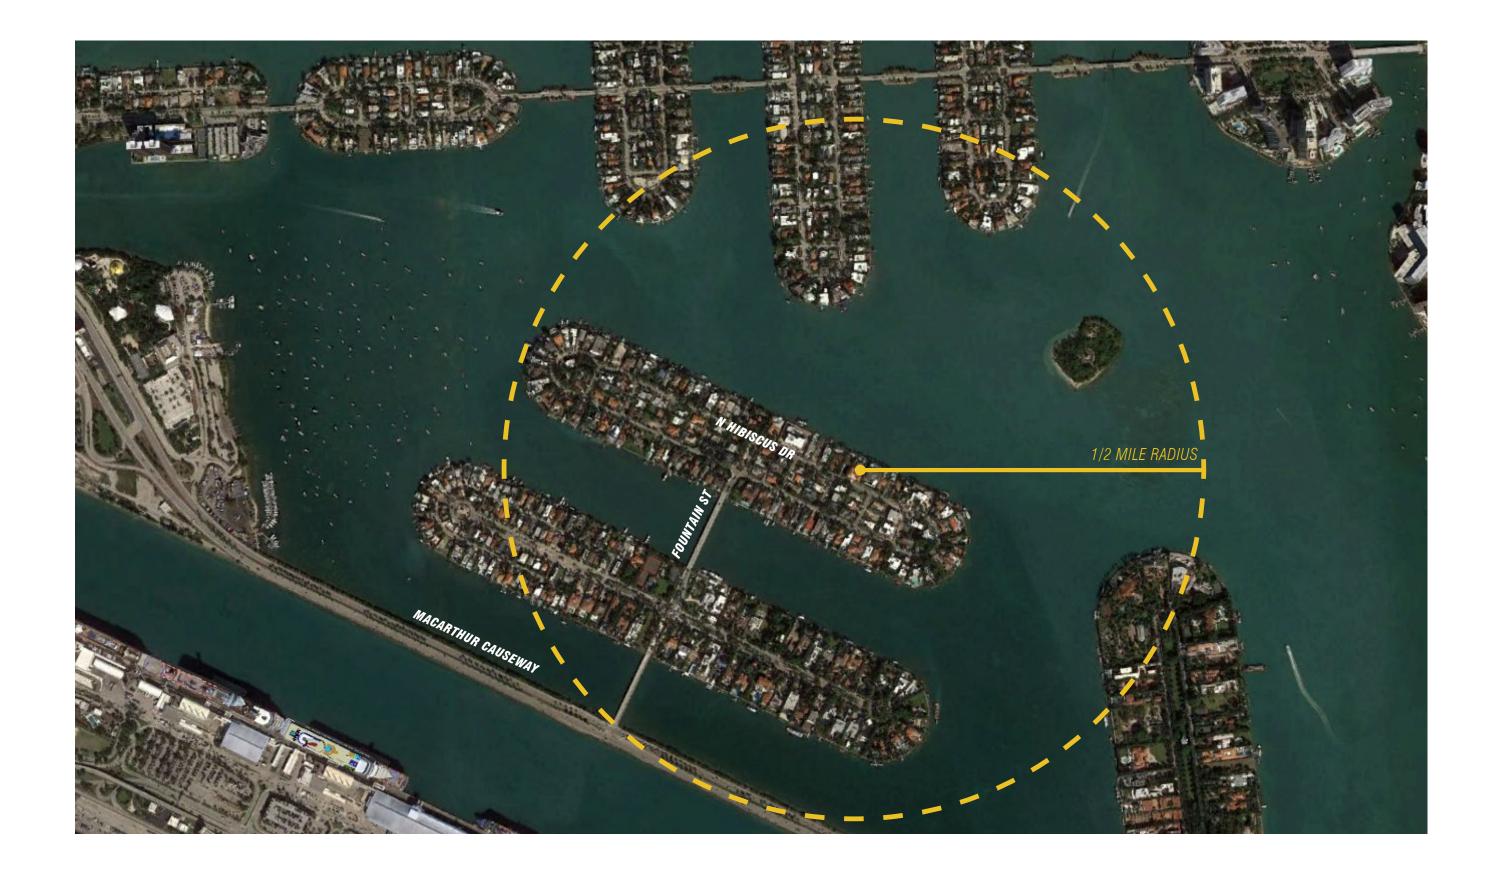



CONTEXT LOCATION PLAN

121 NORTH HIBISCUS DRIVE RESIDENCE





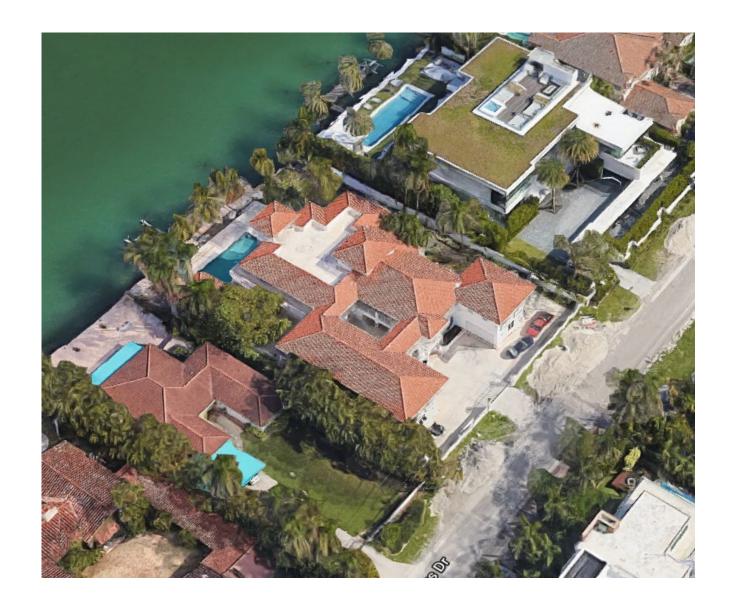

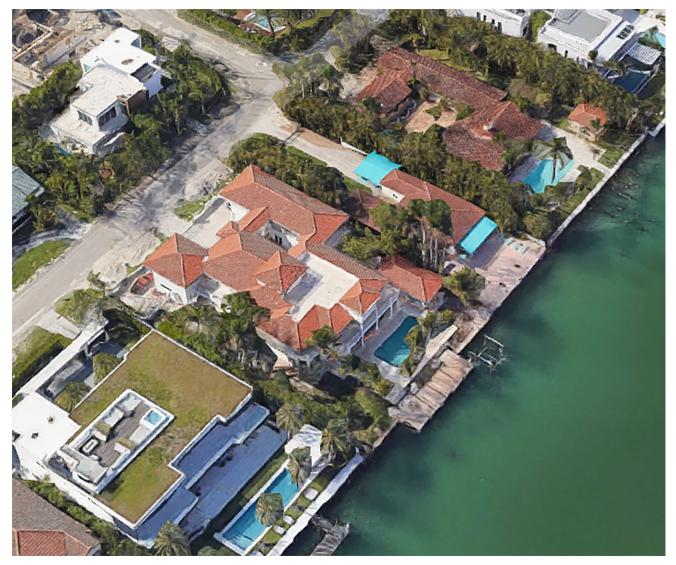

SITE LOCATION

121 NORTH HIBISCUS DRIVE RESIDENCE







SITE LOCATION


121 NORTH HIBISCUS DRIVE RESIDENCE










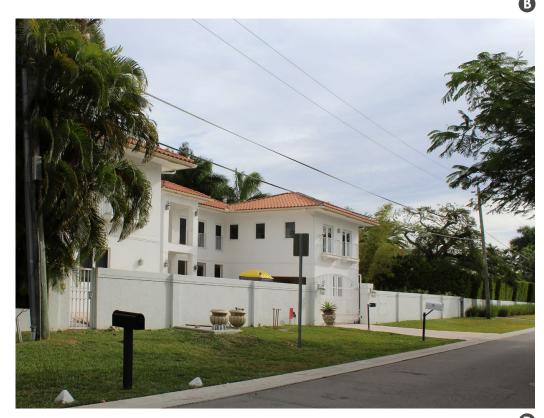

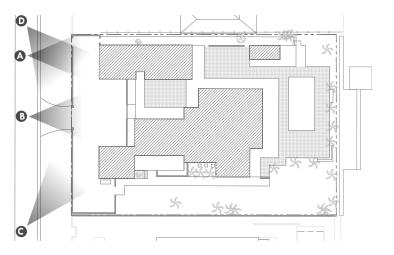

SITE PHOTOS - EXISTING STRUCTURE - FRONT


121 NORTH HIBISCUS DRIVE RESIDENCE










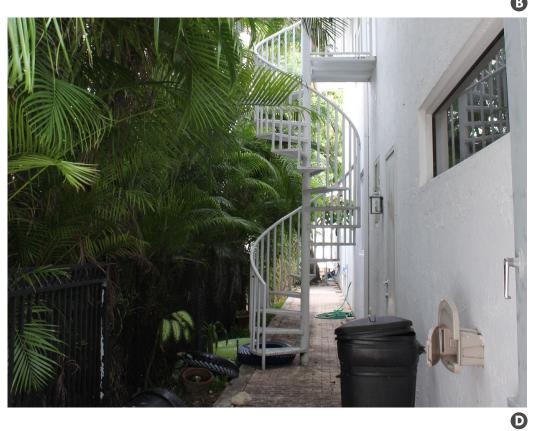

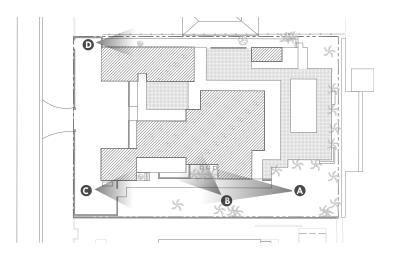


SITE PHOTOS - EXISTING STRUCTURE - SIDE

121 NORTH HIBISCUS DRIVE RESIDENCE








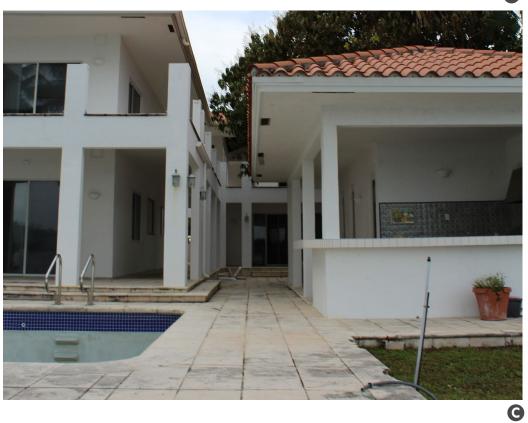



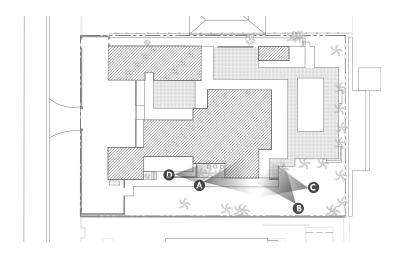

SITE PHOTOS - EXISTING STRUCTURE - REAR

121 NORTH HIBISCUS DRIVE RESIDENCE












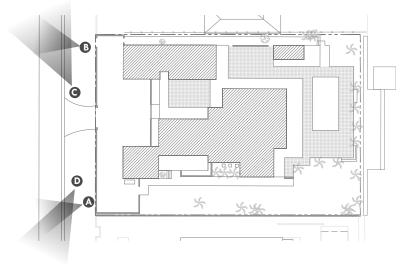

SITE PHOTOS - SURROUNDING PROPERTY


121 NORTH HIBISCUS DRIVE RESIDENCE

121 NORTH HIBISCUS DRIVE . MIAMI BEACH . FLORIDA



G



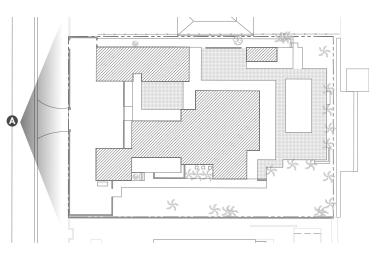


EXISTING ELEVATION SOUTH

121 NORTH HIBISCUS DRIVE RESIDENCE






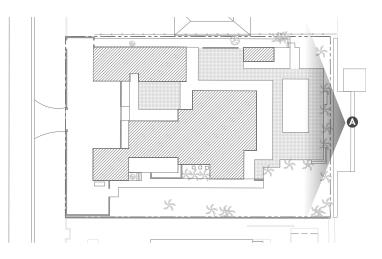

EXISTING ELEVATION NORTH

121 NORTH HIBISCUS DRIVE RESIDENCE



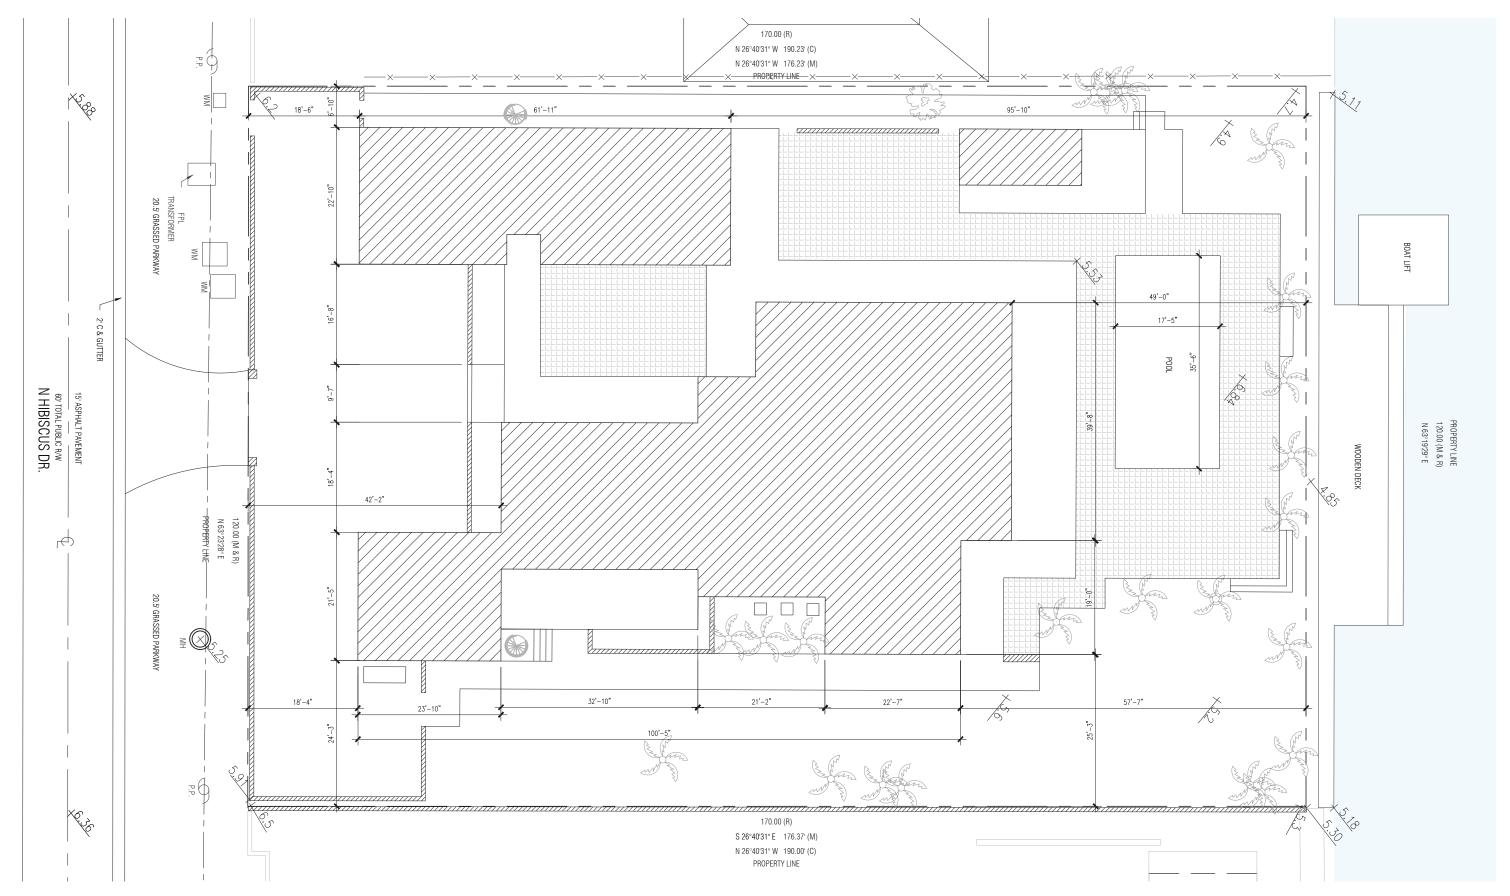

121 NORTH HIBISCUS DRIVE RESIDENCE

121 NORTH HIBISCUS DRIVE . MIAMI BEACH . FLORIDA

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EXISTING CONDITIONS PLAN SCALE: 1/16" = 1'-0"

5' 10' 25' 50'



SOUTH ELEVATION


EXISTING CONDITIONS ELEVATION

SCALE: 1/8" = 1'-0"

121 NORTH HIBISCUS DRIVE . MIAMI BEACH . FLORIDA

121 NORTH HIBISCUS DRIVE RESIDENCE



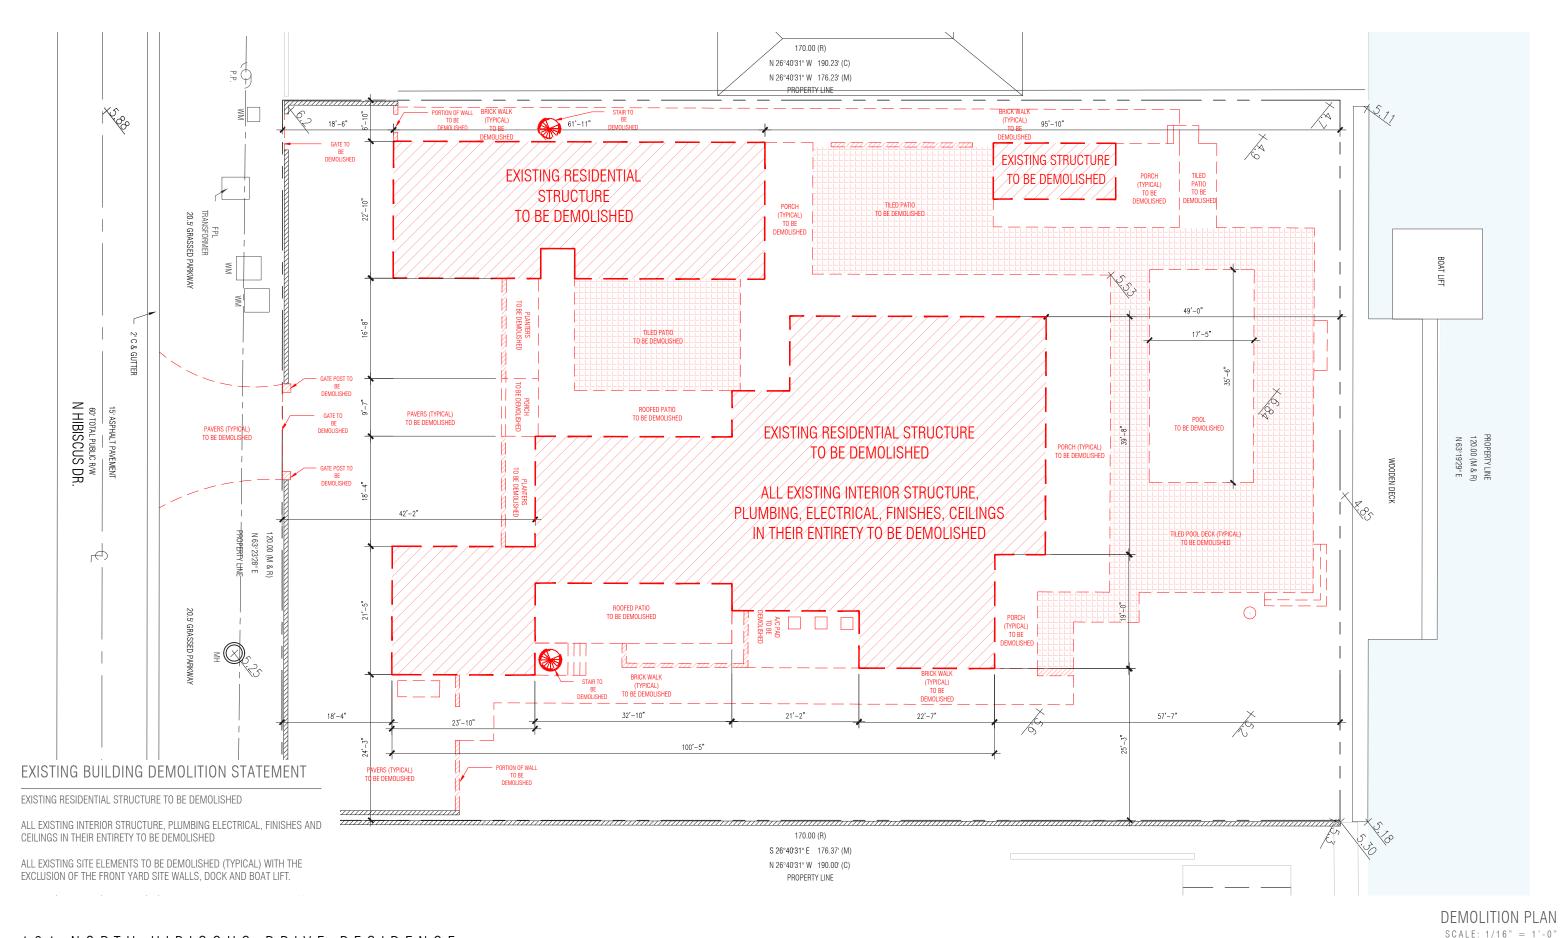


121 NORTH HIBISCUS DRIVE RESIDENCE

121 NORTH HIBISCUS DRIVE . MIAMI BEACH . FLORIDA



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Δ_1

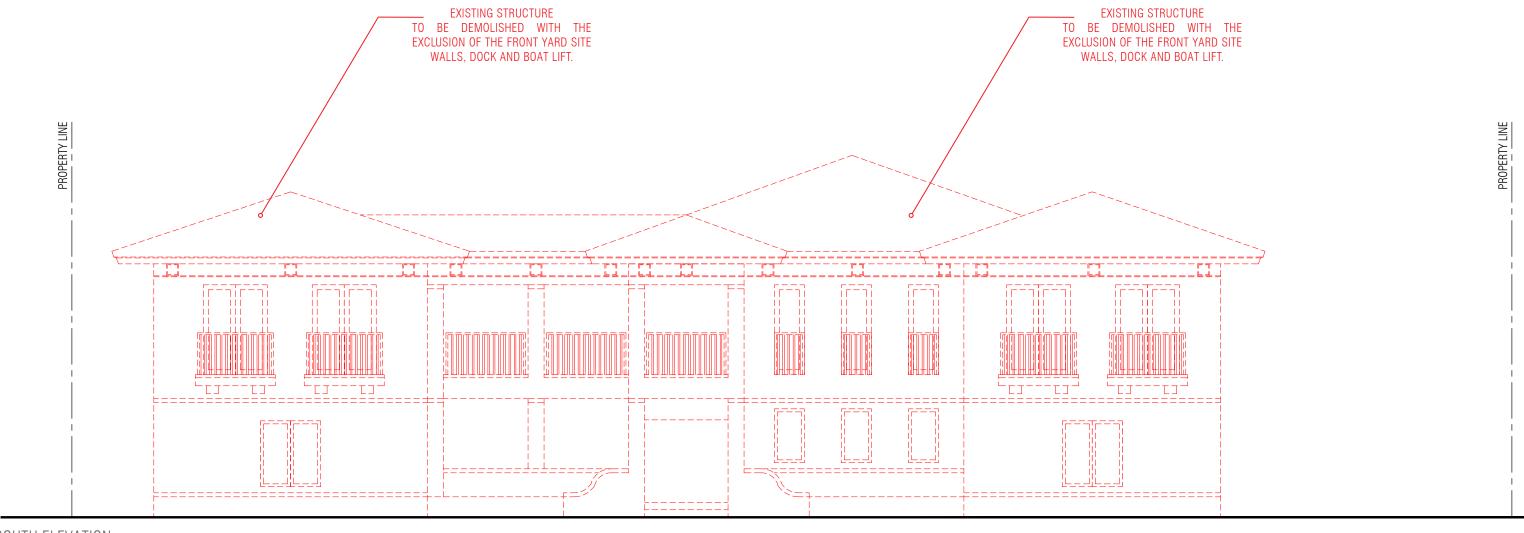


SOUTH ELEVATION


DEMOLITION ELEVATION

SCALE: 1/8" = 1'-0"

121 NORTH HIBISCUS DRIVE RESIDENCE



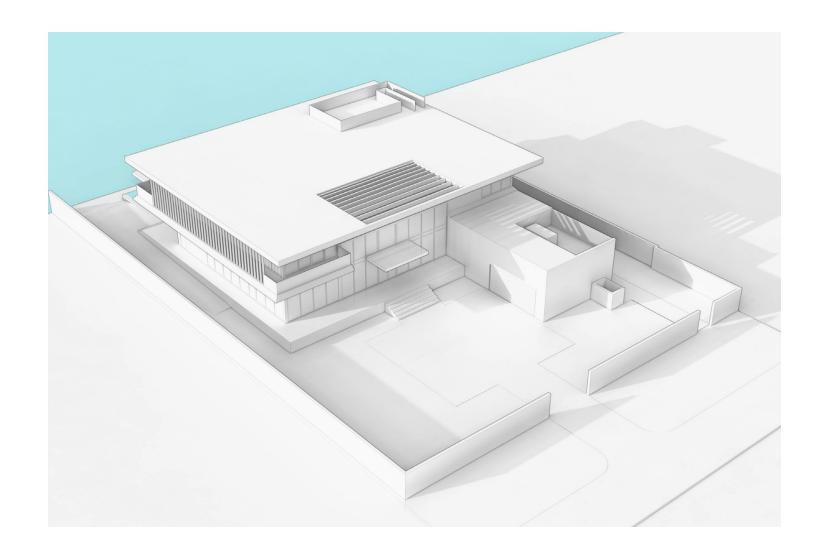


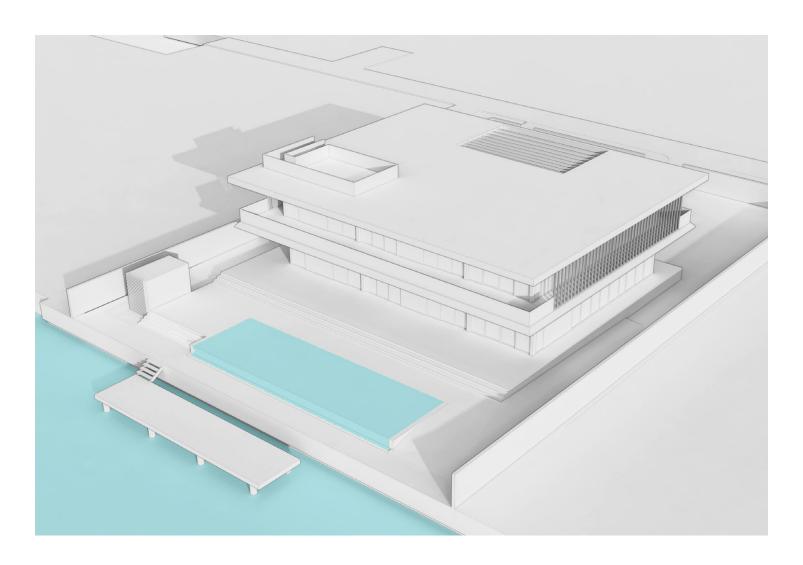

PROPOSED AXONOMETRICS

121 NORTH HIBISCUS DRIVE RESIDENCE




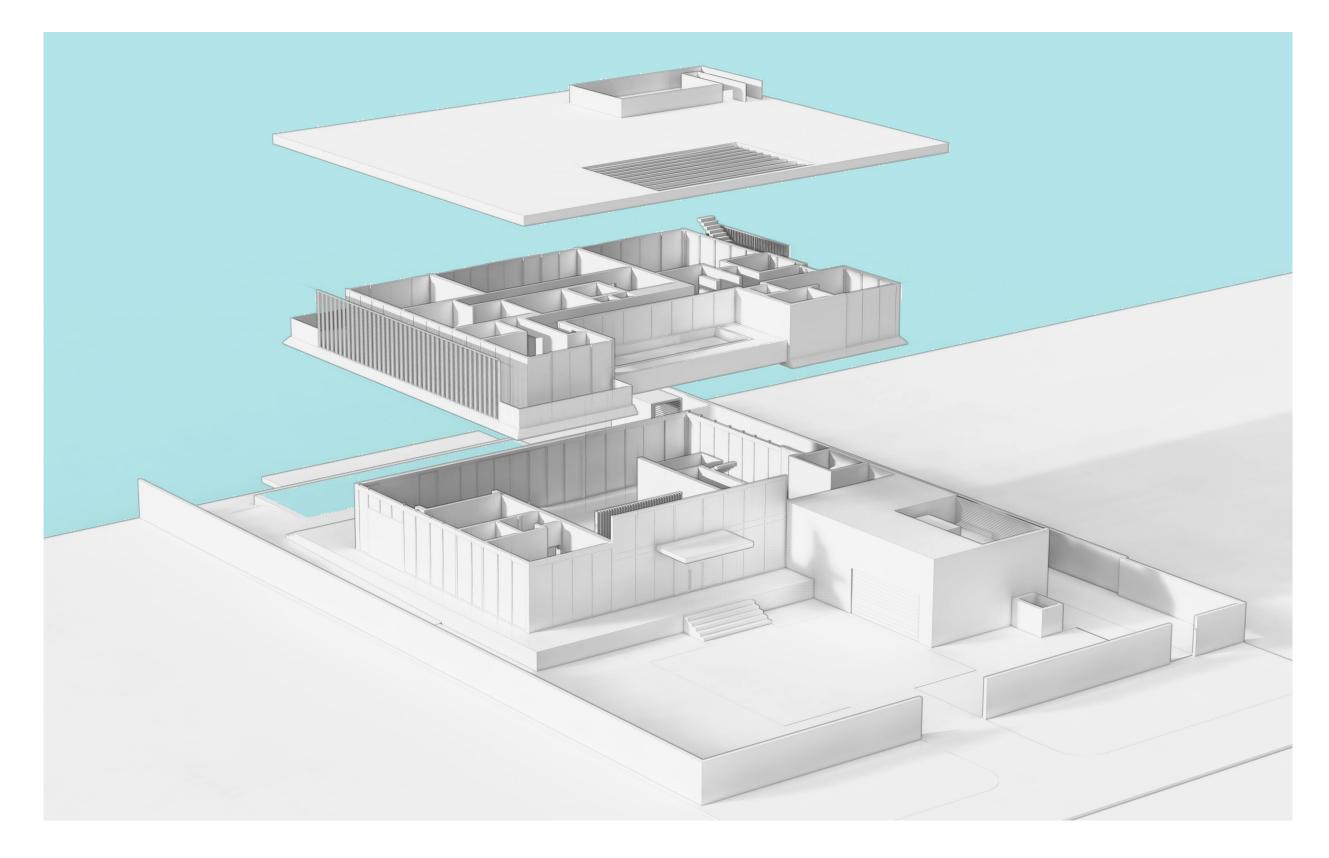

PROPOSED EXPLODED AXONOMETRICS

121 NORTH HIBISCUS DRIVE RESIDENCE



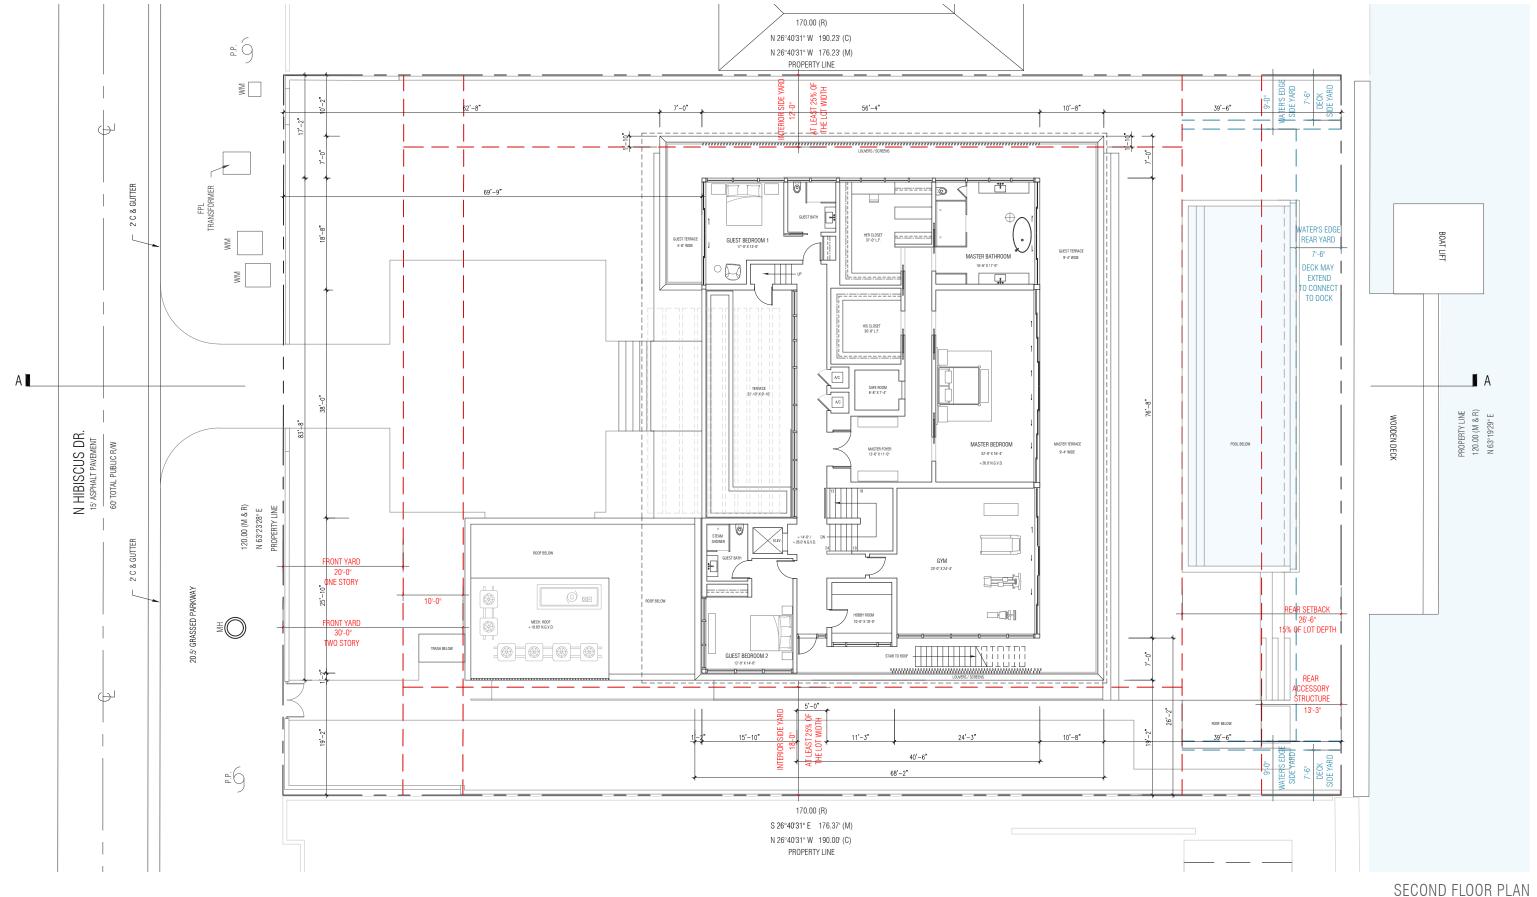

121 NORTH HIBISCUS DRIVE RESIDENCE

121 NORTH HIBISCUS DRIVE . MIAMI BEACH . FLORIDA

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SECUND FLOUR PLAN SCALE: 1/16"=1'-0"

0' 5' 10' 25' 50'











WIN-01 AL-01 GL-04 CBS-01 GL-01

AL-01	R00F	/ TRELLIS MEMBERS TO BE FINISHED IN LIGHT GRAY KYNAR. OR EQUIV. FINISH	
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AL-02 SPECIALTY GARAGE DOOR

C-01 CAST-IN-PLACE ARCHITECTURAL CONCRETE

CBS-01 EXTERIOR CEMENT PLASTER ON REINFORCED CONCRETE MASONRY WALL SMOOTH FINISH AND PAINT - COLOR TBD

CBS-02 EXTERIOR CEMENT PLASTER ON SITE RETAINING WALL SMOOTH FINISH AND PAINT - COLOR TBD

GL-01 IMPACT-RATED, LIGHT TINTED LAMINATED GLASS IN ALUMINUM WINDOW WALL SYSTEM, SLIDING DOOR SYSTEM, AND FIXED SYSTEM - LIGHT KYNAR FINISH, TBD.

GL-02 IMPACT-RATED, ALUMINUM OUTSWING ENTRANCE DOORS - FINISH TO MATCH GL-01

GL-03 IMPACT-RATED, LIGHT TINTED CUSTOM FRIT OR FROSTED LAMINATED GLASS ON ALUMINUM FRAMING SYSTEM - FINISH TO MATCH GL-01

GL-04 TEMPERED GLASS GUARDRAIL SYSTEM WITH ALUMINUM RAIL SHOE, HEIGHT 42" A.F.F.

MTL-01 BRAKE METAL OVER STEEL STRUCTURAL ELEMENTS - LIGHT KYNAR FINISH, TBD.

PL-01 IN-GROUND POOL, PEBBLEFINA - CIELO BLUE OR EQUIVALENT FINISH

PL-02 POOL TILE - INFINITY EDGE


SST-01 STAINLESS STEEL JAKOB CABLE GUARDRAIL/HANDRAIL SYSTEM, HEIGHT 42" A.F.F.

WIN-01 CUSTOM, FINISHED ALUMINUM "PERSIANAS" WITH TWO COAT KYNAR 500 FINISH TO MATCH GL-01

MATERIALS AND TEXTURES

121 NORTH HIBISCUS DRIVE RESIDENCE




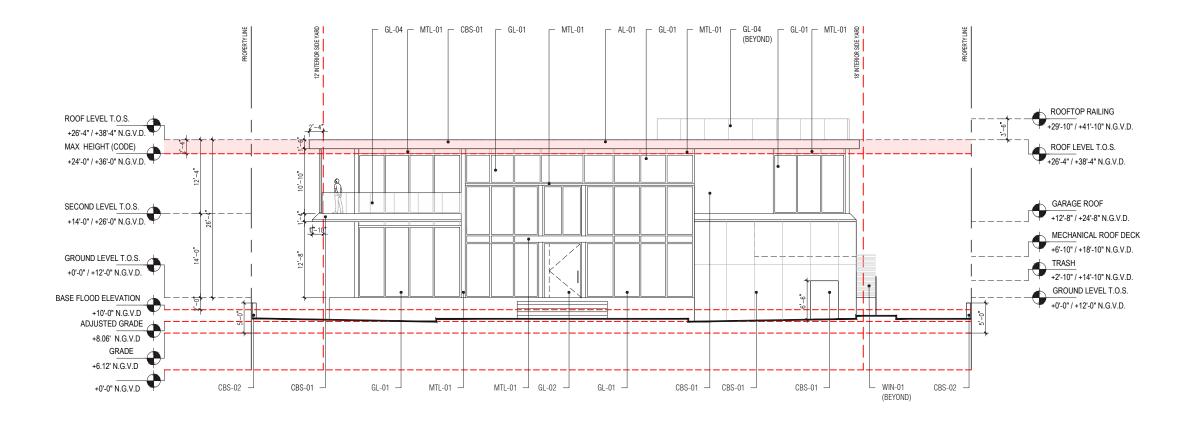

MATERIAL LEGEND

- AL-01 ROOF / TRELLIS MEMBERS TO BE FINISHED IN LIGHT GRAY KYNAR, OR EQUIV. FINISH
- AL-02 SPECIALTY GARAGE DOOR
- C-01 CAST-IN-PLACE ARCHITECTURAL CONCRETE
- CBS-01 EXTERIOR CEMENT PLASTER ON REINFORCED CONCRETE MASONRY WALL SMOOTH FINISH AND PAINT COLOR TBD
- CBS-02 EXTERIOR CEMENT PLASTER ON SITE RETAINING WALL SMOOTH FINISH AND PAINT COLOR TBD
- GL-01 IMPACT-RATED, LIGHT TINTED LAMINATED GLASS IN ALUMINUM WINDOW WALL SYSTEM, SLIDING DOOR SYSTEM, AND FIXED SYSTEM LIGHT KYNAR FINISH, TBD.
- GL-02 IMPACT-RATED, ALUMINUM OUTSWING ENTRANCE DOORS FINISH TO MATCH GL-01

- GL-03 IMPACT-RATED, LIGHT TINTED CUSTOM FRIT OR FROSTED LAMINATED GLASS ON ALUMINUM FRAMING SYSTEM FINISH TO MATCH GL-01
- ${\tt GL-04} \qquad {\tt TEMPERED GLASS GUARDRAIL SYSTEM WITH ALUMINUM RAIL SH0E, HEIGHT 42" A.F.F.}$
- MTL-01 BRAKE METAL OVER STEEL STRUCTURAL ELEMENTS LIGHT KYNAR FINISH, TBD.
- PL-01 IN-GROUND POOL, PEBBLEFINA CIELO BLUE OR EQUIVALENT FINISH
- PL-02 POOL TILE INFINITY EDGE
- SST-01 STAINLESS STEEL JAKOB CABLE GUARDRAIL/HANDRAIL SYSTEM, HEIGHT 42" A.F.F.
- WIN-01 CUSTOM, FINISHED ALUMINUM "PERSIANAS" WITH TWO COAT KYNAR 500 FINISH TO MATCH GL-01

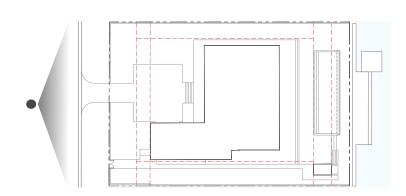


SOUTH ELEVATION

SCALE: 1/16"=1'-0"

0' 5' 10' 25'

121 NORTH HIBISCUS DRIVE RESIDENCE



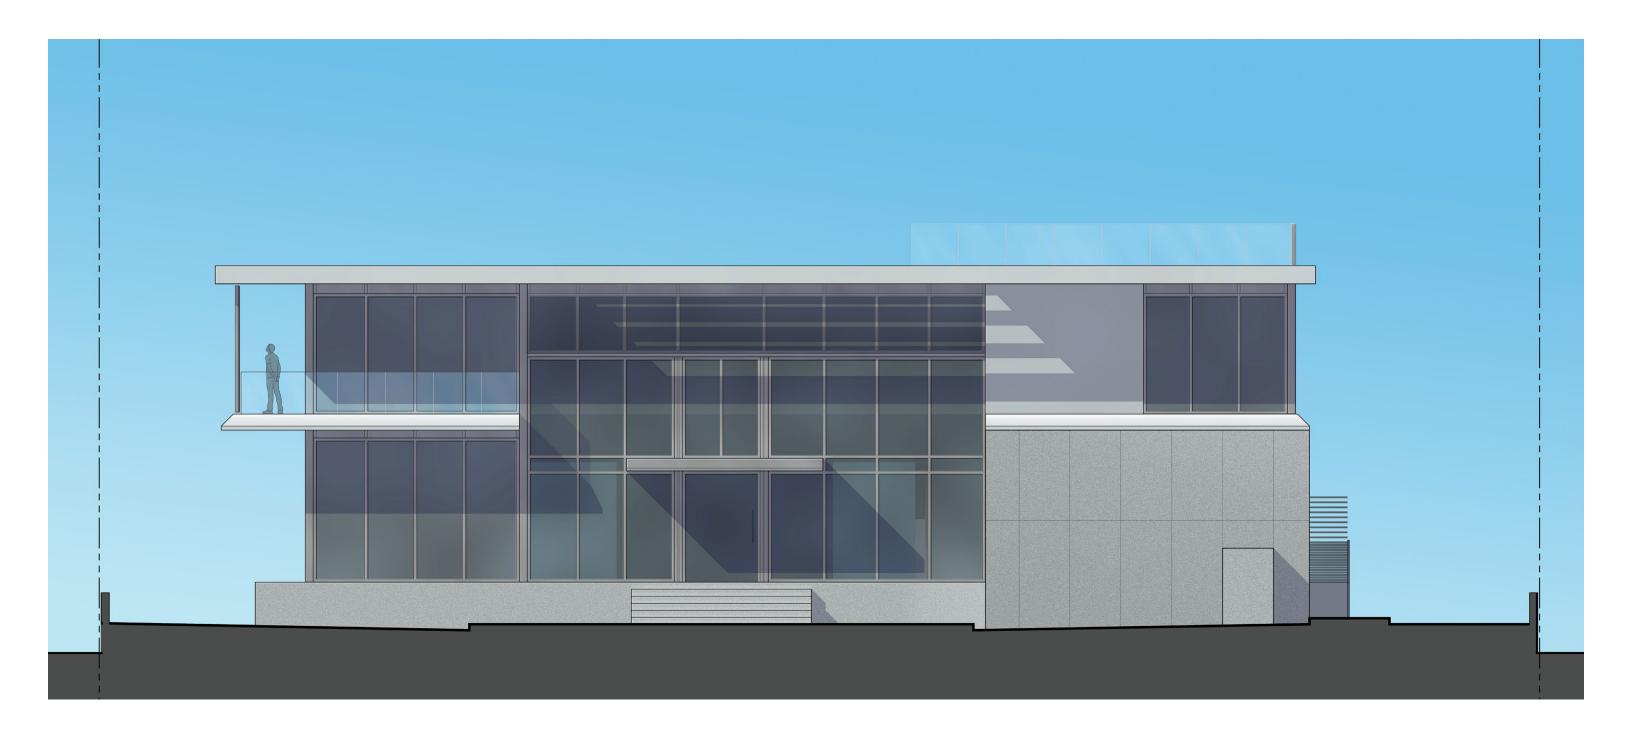


SOUTH ELEVATION - RENDERED

SCALE: 1/8"=1'-0"

1 2 1 NORTH HIBISCUS DRIVE RESIDENCE
121 NORTH HIBISCUS DRIVE . MIAMI BEACH . FLORIDA



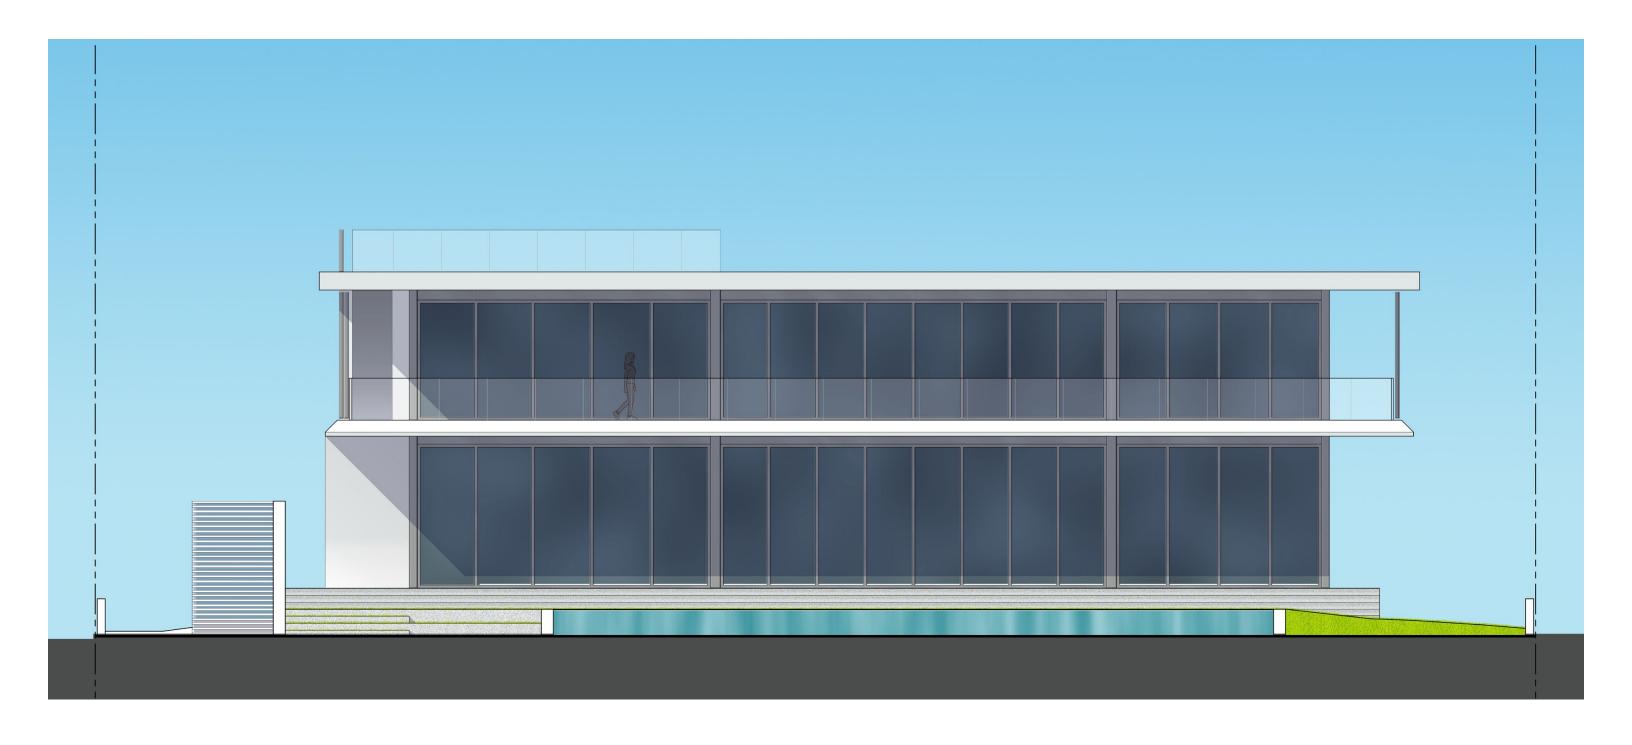

NORTH ELEVATION - RENDERED

SCALE: 1/8"=1'-0"


121 NORTH HIBISCUS DRIVE RESIDENCE

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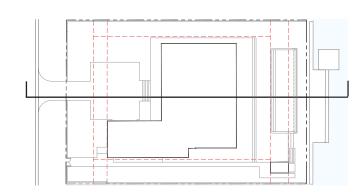
MATERIAL LEGEND

- AL-01 ROOF / TRELLIS MEMBERS TO BE FINISHED IN LIGHT GRAY KYNAR, OR EQUIV. FINISH
- AL-02 SPECIALTY GARAGE DOOR
- C-01 CAST-IN-PLACE ARCHITECTURAL CONCRETE
- CBS-01 EXTERIOR CEMENT PLASTER ON REINFORCED CONCRETE MASONRY WALL SMOOTH FINISH AND PAINT COLOR TBD
- CBS-02 EXTERIOR CEMENT PLASTER ON SITE RETAINING WALL SMOOTH FINISH AND PAINT COLOR TBD
- GL-01 IMPACT-RATED, LIGHT TINTED LAMINATED GLASS IN ALUMINUM WINDOW WALL SYSTEM, SLIDING DOOR SYSTEM, AND FIXED SYSTEM LIGHT KYNAR FINISH, TBD.
- ${\tt GL-02} \qquad {\tt IMPACT-RATED, ALUMINUM OUTSWING ENTRANCE DOORS FINISH TO MATCH GL-01}$

121 NORTH HIBISCUS DRIVE . MIAMI BEACH . FLORIDA

121 NORTH HIBISCUS DRIVE RESIDENCE

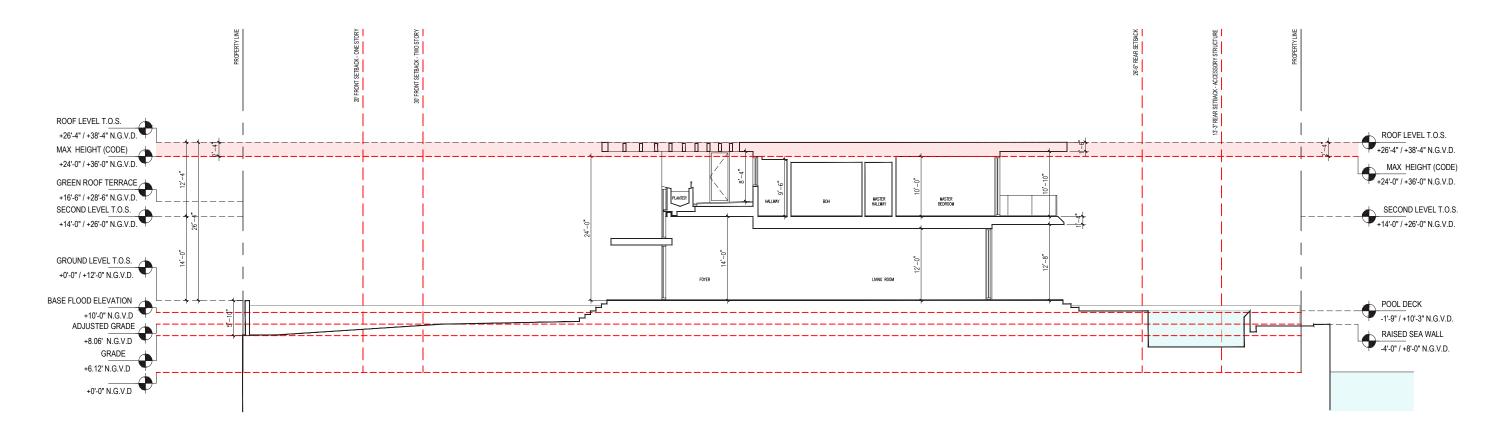- GL-03 IMPACT-RATED, LIGHT TINTED CUSTOM FRIT OR FROSTED LAMINATED GLASS ON ALUMINUM FRAMING SYSTEM FINISH TO MATCH GL-01
- ${\tt GL-04} \qquad {\tt TEMPERED GLASS GUARDRAIL SYSTEM WITH ALUMINUM RAIL SHOE, HEIGHT 42" A.F.F.}$
- MTL-01 BRAKE METAL OVER STEEL STRUCTURAL ELEMENTS LIGHT KYNAR FINISH, TBD.
- PL-01 IN-GROUND POOL, PEBBLEFINA CIELO BLUE OR EQUIVALENT FINISH
- PL-02 POOL TILE INFINITY EDGE
- SST-01 STAINLESS STEEL JAKOB CABLE GUARDRAIL/HANDRAIL SYSTEM, HEIGHT 42" A.F.F.
- WIN-01 CUSTOM, FINISHED ALUMINUM "PERSIANAS" WITH TWO COAT KYNAR 500 FINISH TO MATCH GL-01




SECTION - TRANSVERSE

SCALE: 1/16"=1'-0"
10' 25' 50'



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YARD SECTION - FRONT

SCALE: 3/32" = 1'-0"

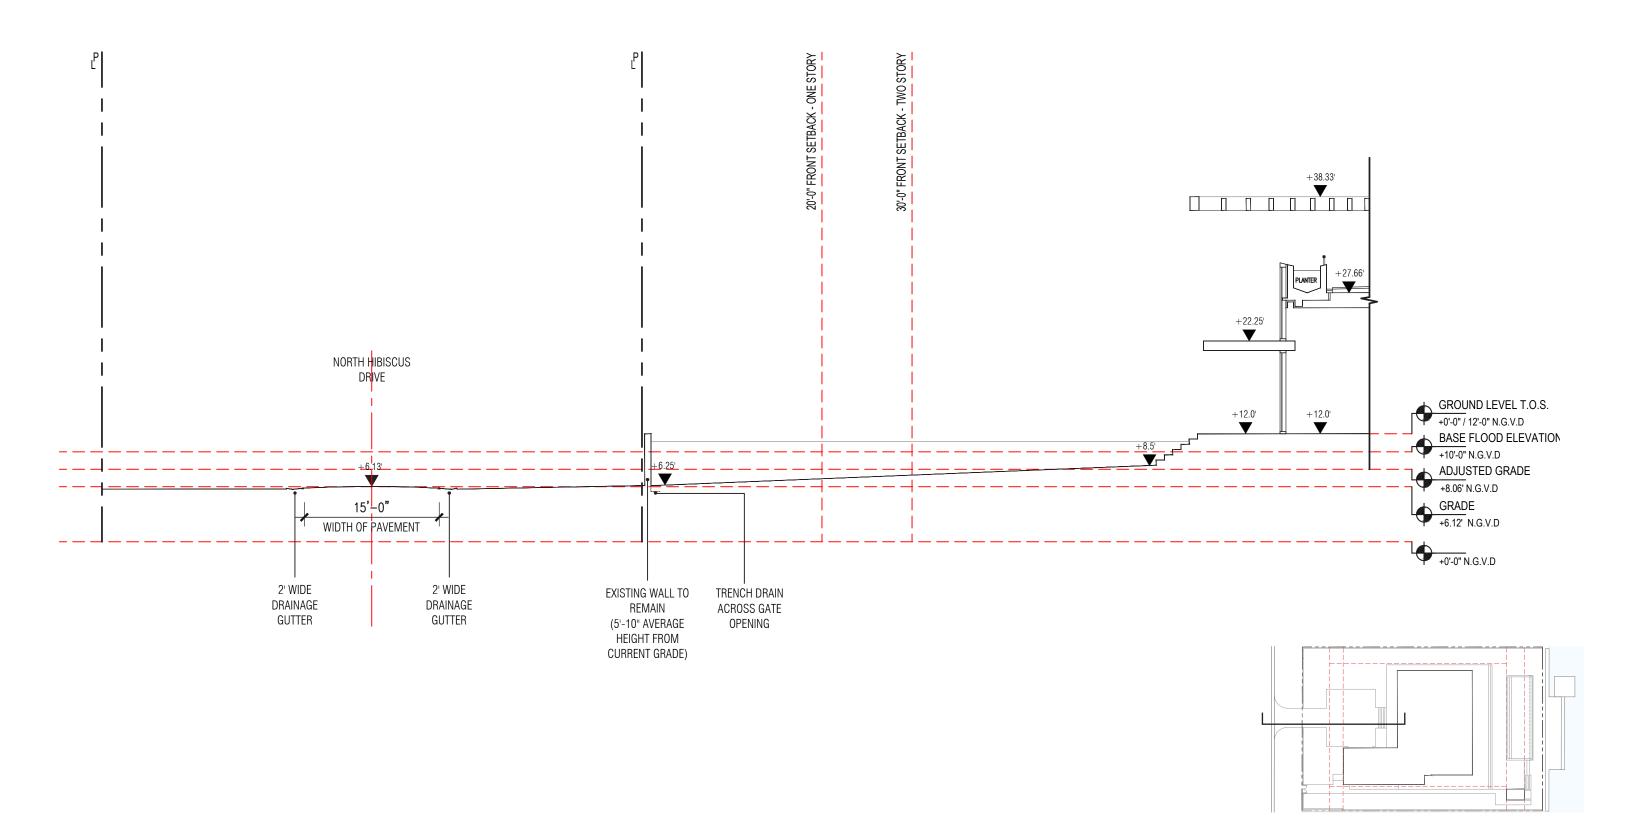
121 NORTH HIBISCUS DRIVE RESIDENCE


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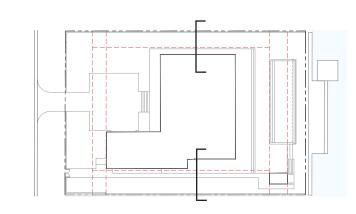
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EAST SIDE YARD WEST SIDE YARD





FROM GRADE

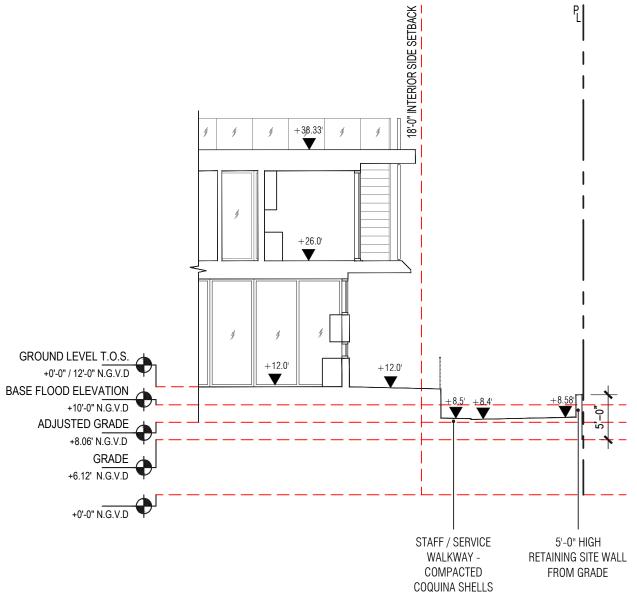


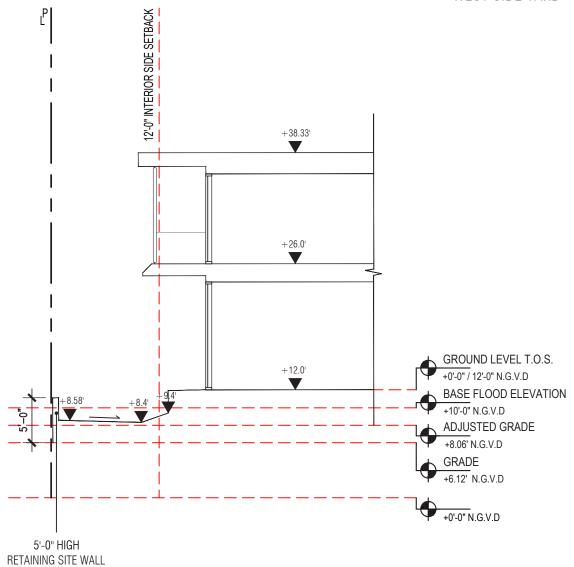
YARD SECTION - SIDES

SCALE: 3/32" = 1'-0"

121 NORTH HIBISCUS DRIVE RESIDENCE



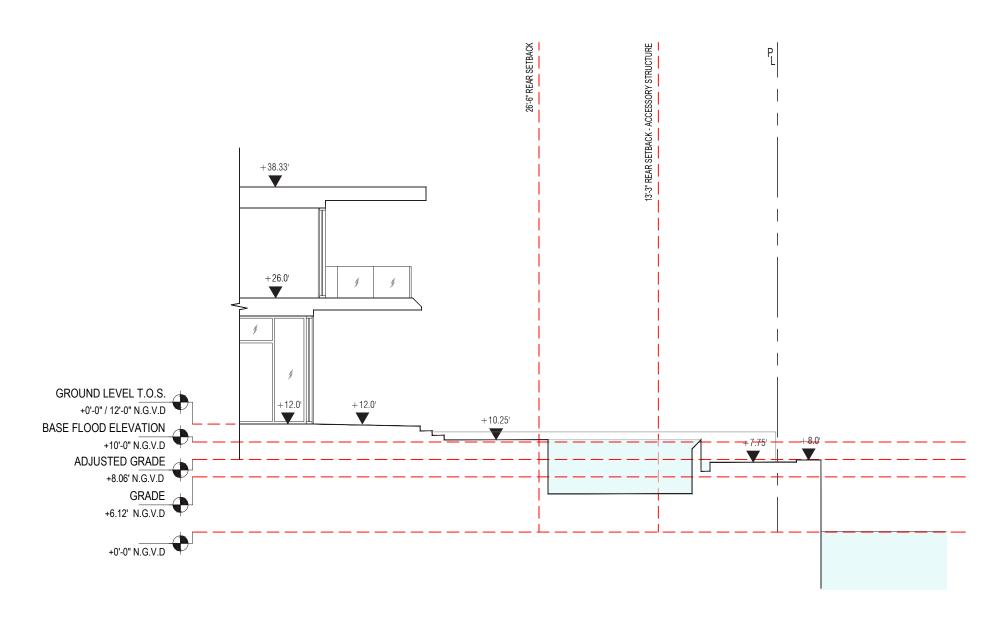

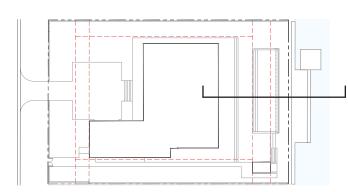

YARD SECTION - REAR

SCALE: 3/32"=1'-0"

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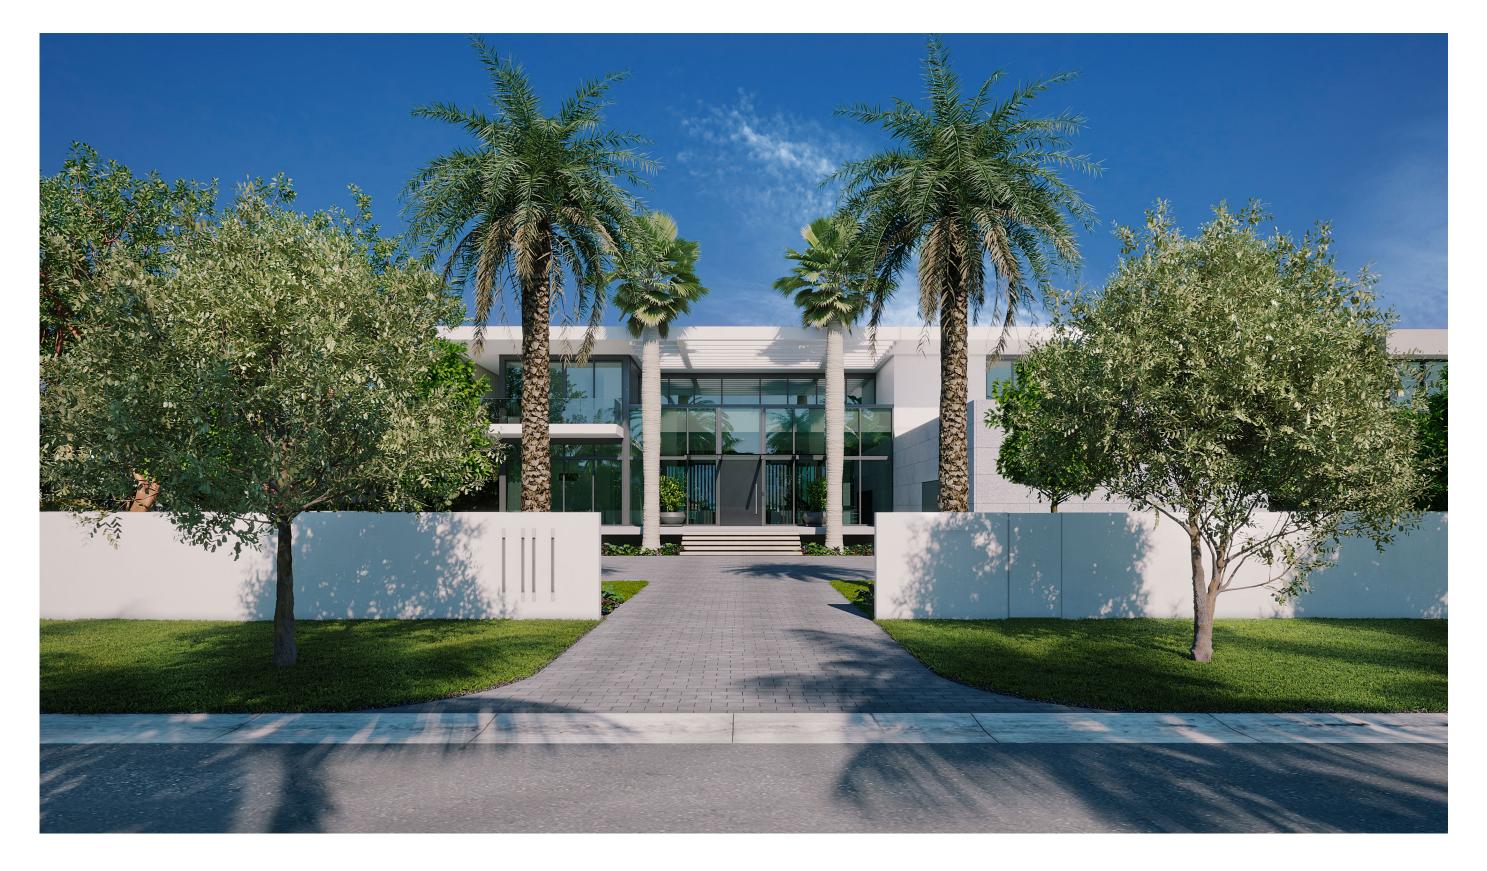


VIEW FROM NORTH HIBISCUS DRIVE

A-37

121 NORTH HIBISCUS DRIVE RESIDENCE





VIEW FROM NORTH HIBISCUS DRIVE

121 NORTH HIBISCUS DRIVE RESIDENCE

