# ALSABBAGH RESIDENCE FINAL SUBMITTAL JANUARY 4, 2021

### ALSABBAGH RESIDENCE

DESIGN REVIEW BOARD FINAL SUBMITTAL JANUARY 4, 2021 REV. APRIL 5, 2021

AR00150

REFREIGHEN IN THE BANKHOL ARE OWNED IN A PERCENT POLICY MED ROCKET THE TWO RE O'S SECRET AND SECRET THE TWO RE O'S SECRET AND SECRET THE TWO RE O'S PERCENT AND SECRET THE TWO RE O'S PERCENT AND SECRET THE TWO RE O'S THE CHIEF, WHITE DAMBGOS ON THE ED DAWNED THE CHIEF, WHITE DAMBGOS ON THE ED DAWNED THE CHIEF, WANTEN OR FOR THE ED DAWNED ON THE WANTEN OR FOR THE DAWNED ON THE ED DAWNED O'S THE DAWNED OF THE DAWNED ON THE ED DAWNED O'S THE DAWNED OF THE DAWNED ON THE DAWNED ON THE THE DAWNED OF THE DAWNED ON THE DAWNED ON THE DAWNED ON THE THE DAWNED ON THE DAWNED ON THE DAWNED ON THE DAWNED ON THE THE DAWNED ON THE DAWNED ON THE DAWNED ON THE DAWNED ON THE THE DAWNED ON THE DAWNED ON THE DAWNED ON THE DAWNED ON THE THE DAWNED ON THE DAWNED ON THE DAWNED ON THE DAWNED ON THE THE DAWNED ON THE DAWNED ON THE DAWNED ON THE DAWNED ON THE THE DAWNED ON THE DAWNED O





BBAGH RESIDENCE 4625 ALTON ROAD IAMI BEACH, FL 33140

REVISIONS	04/05/2021				
	-				
25		21	.:		


NEST - 2025
NEST -

A-001




#### SCOPE OF WORK

- 1. DESCRIPTION OF WORK: NEW CONSTRUCTION 2 STORY SINGLE FAMILY RESIDENCE
- 2. SCOPE OF WORK INCLUDES:
  - DEMOLITION OF EXISTING SINGLE FAMILY RESIDENCE
  - 2 NEW CONSTRUCTION 2 STORY CMU BLOCK SINGLE FAMILY RESIDENCE

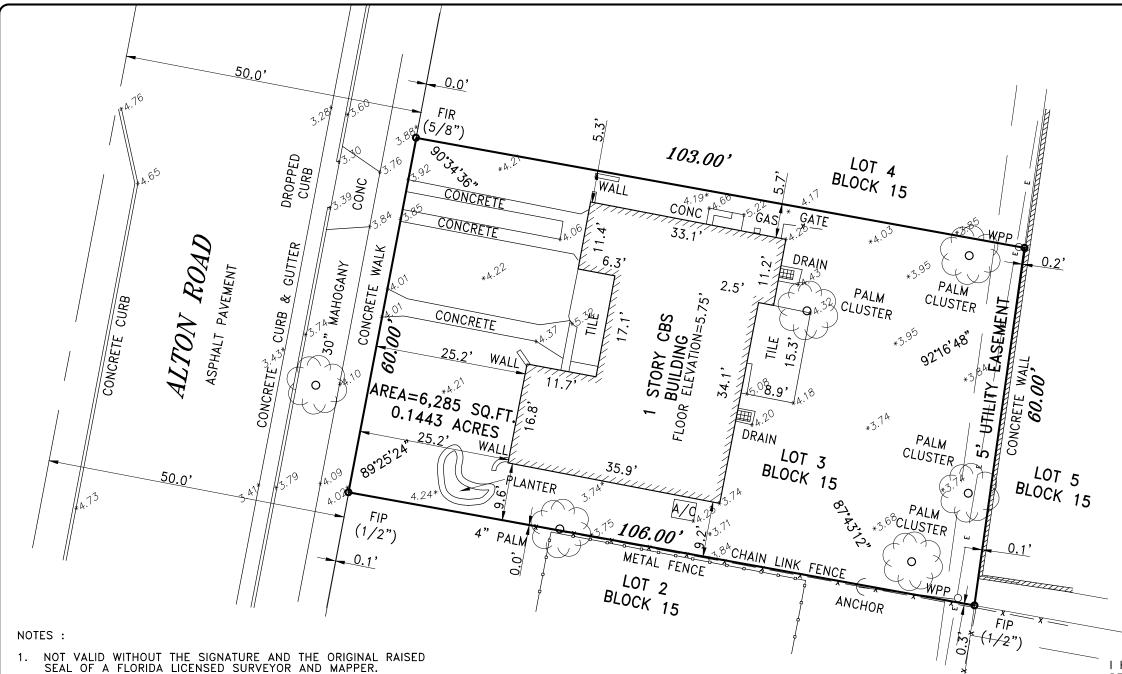

#### SKETCH OF SURVEY

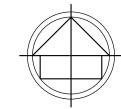

#### LEGEND:

SNC

CKD CHECKED BY CONC CONCRETE DWN DRAWN BY

FB/PG FIELD BOOK AND PAGE SIR SET IRON ROD & CAP #6448

SET NAIL AND CAP #6448

FIR FOUND IRON ROD FIP FOUND IRON PIPE FNC FOUND NAIL AND CAP

FND FOUND NAIL & DISC

P.B. PLAT BOOK M/D.C.R. MIAMI/DADE COUNTY RECORDS

WPP WOOD POWER POLE

CHAIN LINK/ WOOD FENCE -X-

**ELEV ELEVATION** 

CBS CONCRETE BLOCK STRUCTURE -E-OVERHEAD UTILITY WIRES

A/C AIR CONDITIONER

CO CLEAN OUT NTS NOT TO SCALE

RADIUS

ARC DISTANCE Δ CENTRAL ANGLE

7.59 **ELEVATION** 

I HEREBY CERTIFY THAT THE "SKETCH OF SURVEY" OF THE HEREON DESCRIBED PROPERTY IS TRUE AND CORRECT TO THE BEST OF MY KNOWLEDGE AND BELIEF AS SURVEYED IN THE FIELD UNDER MY DIRECTION IN OCTOBER, 2020. I FURTHER CERTIFY THAT THIS SURVEY MEETS THE STANDARDS OF PRACTICE FOR SURVEYING IN THE STATE OF FLORIDA ACCORDING TO CHAPTER 5J-17 OF THE FLORIDA ADMINISTRATIVE CODE. PURSUANT TO SECTION 472.027, FLORIDA STATUTES. THERE ARE NO ABOVE GROUND ENCROACHMENTS OTHER THAN THOSE SHOWN HEREON, SUBJECT TO THE QUALIFICATIONS NOTED HEREON.

FOR THE FIRM, BY: -----

RICHARD E. COUSINS

PROFESSIONAL SURVEYOR AND MAPPER

SURVEY DATE: 10/29/20 FLORIDA REGISTRATION NO. 4188

- LANDS SHOWN HEREON WERE NOT ABSTRACTED FOR RIGHTS-OF-WAY, EASEMENTS, OWNERSHIP, OR OTHER INSTRUMENTS OF RECORD.
- THIS SURVEY WAS DONE SOLELY FOR BOUNDARY PURPOSES AND DOES NOT DEPICT THE JURISDICTION OF ANY MUNICIPAL, STATE, FEDERAL OR OTHER ENTITIES. 3.
- THE LAND DESCRIPTION SHOWN HEREON WAS PROVIDED BY THE CLIENT.
- UNDERGROUND IMPROVEMENTS NOT SHOWN.
- ELEVATIONS SHOWN HEREON ARE BASED ON THE NATIONAL GEODETIC VERTICAL DATUM OF 1929 (NGVD29).
- BENCHMARK DESCRIPTION : MIAMI/DADE COUNTY BM # D-132-R ELEVATION = 8.23' (NGVD29)

#### LAND DESCRIPTION:

LOT 3, BLOCK 15 OF "NAUTILUS ADDITION OF MIAMI BEACH SHORE CO." ACCORDING TO THE PLAT THEREOF, AS RECORDED IN PLAT BOOK 8, PAGE 130 OF THE PUBLIC RECORDS OF MIAMI/DADE COUNTY, FLORIDA.

#### COUSINS SURVEYORS & ASSOCIATES, INC.



3921 SW 47TH AVENUE, SUITE 1011 DAVIE, FLORIDA 33314 CERTIFICATE OF AUTHORIZATION: LB # 6448 PHONE (954)689-7766 FAX (954)689-7799 PROJECT NUMBER: 9372-20

CLIENT:

**NEST PLANS** 


REVISIONS	DATE	FB/PG	DWN	CKD
BOUNDARY & IMPROVEMENTS SURVEY	10/29/20	SKETCH	АМ	REC
ADDED SITE AREA	12/28/20		АМ	REC
		·		

PROPERTY ADDRESS 4625 ALTON ROAD


SCALE: 1"= 16'

SHEET 1 OF 1

DESIGN REVIEW BOARD FINAL SUBMITTAL JANUARY 4, 2021 REV. APRIL 5, 2021

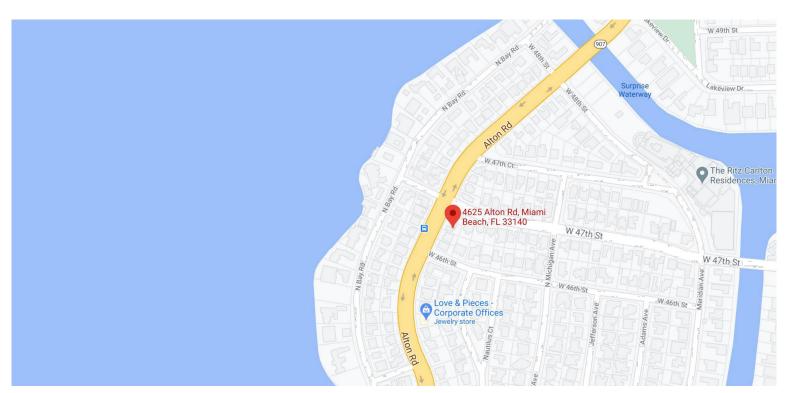

CITY MAP

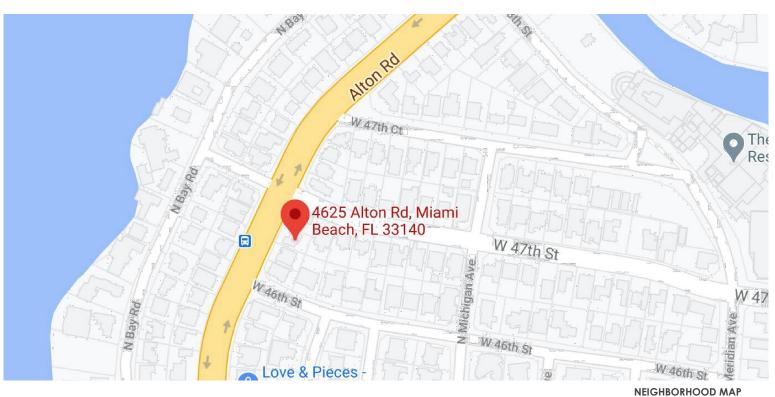

#### **SHEET INDEX**

#### SHEET NUMBER SHEET TITLE

A-001	COVER SHEET
	SURVEY
A-002	INDEX / SITE LOCATION
A-003	FRONT RENDERING
A-004	REAR RENDERING
A-005	AXONOMETRICS
A-006	AXONOMETRICS
A-007	AXONOMETRICS
A-008	AXONOMETRICS
A-009	EXISTING SITE PHOTOS
A-010	AERIAL VIEWS SITE/CONTEXT
A-011	NEIGHBORHOOD
A-012	STREET VIEWS
A-013	SITE CONTEXT
A-014	EXISTING LOT COVERAGE / DEMOLITION PLAN
A-015	ZONING DATA SHEET
A-016	ZONING SETBACK DIAGRAM
A-020	SITE PLAN
A-021	FAR UNIT SIZING DIAGRAM FIRST FLOOR
A-022	FAR UNIT SIZING DIAGRAM SECOND FLOOR
A-023	LOT COVERAGE
A-024	FRONT AND REAR LANDSCAPE COVERAGE
A-025	VOLUME DIAGRAM
A-101	FIRST FLOOR PLAN
A-102	SECOND FLOOR PLAN
A-103	ROOF PLAN
A-201	FRONT ELEVATION
A-202	SIDE ELEVATION
A-203	REAR ELEVATION
A-204	SIDE ELEVATION
A-301	SECTION
A-302	SECTION
A-401	FRONT AND REAR YARD SETBACK SECTIONS
A-402	FRONT AND REAR YARD SETBACK SECTIONS
A-403	SIDE YARD SETBACK SECTIONS
A-501	MATERIAL BOARD
L-1	EXISTING LANDSCAPE CONDITIONS
L-2	LANDSCAPE PLAN

SPRINKLER PLAN

R0015085

PRÉMICE TO BE LOFT CAN BRECE CALLED SE COLEZ A PRÉMICE TO BE LOFT CAN BRECE CALLED SE COLEZ A PRÉMICE THE MANGE COLEZ A PRÉMICE THE MANGE CONTROL MANGE CAN BRECH THE MANGE THE



ALSABBAGH RESIDENCE 4625 ALTON ROAD MIAMI BEACH, FL 33140

NEST - 2025		REVISIONS
	-	04/05/2021
01/04/2021		
Drawn by:		
Checked		

Drawing No.

DESIGN REVIEW BOARD FINAL SUBMITTAL JANUARY 4, 2021 REV. APRIL 5, 2021



POWILDON TO HE STORE ON HERE EACH DE POLYCE PROPERTY TO HE STORE ON HERE EACH DE STORE THE STORE OF THE STORE



ARCHITECTURE & NTERIOR DESIGN 501 E Oakland Park Blvd. Ste 203 ort Lauderdale | Florida 33306 | s4.529.9000 | nestplans.com

ABBAGH RESIDENCE 4625 ALTON ROAD NAMI BEACH, FL 33140

REVISIONS
1 04/05/2021

JOB NO:
NEST - 203
NEST - 204
NEST - 205
NES



DESIGN REVIEW BOARD FINAL SUBMITTAL JANUARY 4, 2021 REV. APRIL 5, 2021

AR001508

FREGET OF HE GREE, AND WREE CALLED FOLK OF METAL OF HE GREE, AND HE CORNELION WILL DESCRIPTION OF METAL OF META



ARCHITECTURE & NTERIOR DESIGN
601 E Oakland Park Blvd, Ste 203
ort Lauderdale | Fiorida 33306
54.529.9000 | nestplans.com

SABBAGH RESIDENCI 4625 ALTON ROAD MIAMI BEACH, FL 33140


REVISIONS

1 04/05/2021

Job No:
NEST - 2025
Date:
01/04/2021
Drawn by:
SAR
Checked



**DESIGN REVIEW BOARD FINAL SUBMITTAL** 

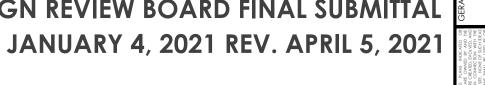





DESIGN REVIEW BOARD FINAL SUBMITTAL JANUARY 4, 2021 REV. APRIL 5, 2021

AR001508



LSABBAGH RESIDEN 4625 ALTON ROAD MIAMI BFACH FI 33140

2025 REVISIONS
1 04/05/2021
1 04/05/2021
1 by:

DESIGN KENTEN BOY



DESIGN REVIEW BOARD FINAL SUBMITTAL JANUARY 4, 2021 REV. APRIL 5, 2021



TACHER OF AN ANY WEST OF A CANDER OF ANY AND AN CONSCIOUR WITH THE CERE OF AND ANY CONSCIOUR WITH THE CERE OF AND ANY CONSCIOUR WITH THE CERE OF AND ANY CONSCIOUR WITH THE CERE OF ANY CONSCIOUR WITH THE CERE OF ANY CONSCIOUR CONSCIOUR AND ANY CONSCIOUR CON



ARCHITECTURE & NTERIOR DESIGN
601 E Oakland Park Blvd, Ste 203 ort Lauderdale | Florida 33306
64.529.9000 | nestplans.com

ABBAGH RESIDENCE 4625 ALTON ROAD MAMI BEACH, FL 33140

REVISIONS
1 04/05/2021

JOB NO:
NEST - 2025
NEST - 2025
Date:
01/04/2021
Drawn by:
SAR

Drawing No.

DESIGN REVIEW BOARD FINAL SUBMITTAL JANUARY 4, 2021 REV. APRIL 5, 2021

AR001508





**ABBAGH RESIDENCI** 4625 ALTON ROAD NAMI BEACH, FL 33140

REVISIONS
1 04/05/2021

NEST - 202.
NEST - 202.
Date:
01/04/202
SAR
Checked

Drawing No. **A-008** 



# Dec 7, 2020 10:07:38 AM 1127E 4633 Allin Prad

1- FRONT VIEW




2- WEST SIDE



**3- SOUTH REAR VIEW** 



**4- SOUTH REAR VIEW** 

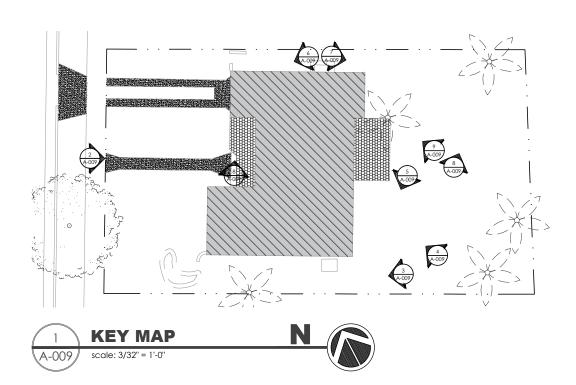



5- EAST SIDE VIEW



6- EAST SIDE VIEW

### **ALSABBAGH RESIDENCE**

DESIGN REVIEW BOARD FINAL SUBMITTAL JANUARY 4, 2021 REV. APRIL 5, 2021



9- SOUTH REAR VIEW



8- REAR YARD VIEW



7- FRONT ENTRANCE VIEW

PERSONAL DE RECORDO NO PERSONAL DE PROPEZA DE LA COMPANZA DEL COMPANZA



ALSABBAGH RESIDENCE 4625 ALTON ROAD MIAMI BEACH, FL 33140

REVISIONS	04/05/2021					
	l					
Job No: NEST - 2025	Date:	01/04/2021	Drawn by:	SAR	Checked	by: GB
DESIC	I NE	REV	IEW	/ BC	AR	D

Drawing No.

A-009

DESIGN REVIEW BOARD FINAL SUBMITTAL JANUARY 4, 2021 REV. APRIL 5, 2021









NW AERIAL

**SW AERIAL** 

**AERIAL VIEW / SITE CONTEXT** 

TION OF AN INTERNAL O

ALL BIRD, A RANGAGEMENT AND TANKS INDUCTED THE RESERVENCE OF THE ROYAL RESERVENCE WINCE OF THE ROYAL RESERVENCE WINCE OF THE ROYAL RESERVENCE WINCE OF THE ROYAL RESERVENCE OF



ALSABBAGH RESIDENCE 4625 ALTON ROAD MIAMI BEACH, FL 33140

REVISIONS	04/05/2021					
	-					
Job No: NEST - 2025	Date:	01/04/2021	Drawn by:	SAR	Checked	by: GB
DESIC	SN I	REV	IEW	/ BC	AR	D
		-				

Drawing No.

A-010

#### **NEIGHBORHOOD PHOTOS**

### ALSABBAGH RESIDENCE

DESIGN REVIEW BOARD FINAL SUBMITTAL

JANUARY 4, 2021 REV. APRIL 5, 2021



**4634 ALTON ROAD** 



4650 ALTON ROAD



4700 ALTON ROAD




4701 ALTON ROAD



4628 ALTON ROAD



SHEET TITLE

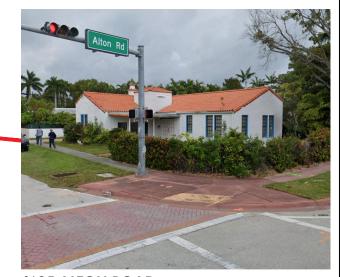

4635 ALTON ROAD



**4618 ALTON ROAD** 



4610 ALTON ROAD



4601 ALTON ROAD



4615 ALTON ROAD

	REVISIONS	1 04/05/2021						
	Job No: NEST - 2025	Date:	01/04/2021	Drawn by:	SAR	Checked	by: GB	
	DESIC	SN I	REV	IEW	BC	AR	D.	
		Dro	wir	ng	No.			
NO.	A	<b>/</b> -	.(	)	1	,	1	

ARCHITECTURE & INTERIOR DESIGN

ALSABBAGH RESIDENCE 4625 ALTON ROAD MIAMI BEACH, FL 33140

**DESIGN REVIEW BOARD FINAL SUBMITTAL** JANUARY 4, 2021 REV. APRIL 5, 2021

## ALSABBAGH RESIDENCE

#### **EXISTING**



4635 ALTON ROAD



4625 ALTON ROAD



4615 ALTON ROAD



4601 ALTON ROAD

#### **PROPOSED**



4635 ALTON ROAD



**4625 ALTON ROAD** 



**4615 ALTON ROAD** 



4601 ALTON ROAD

**SITE CONTEXT STREET VIEWS** 








ALSABBAGH RESIDENCE 4625 ALTON ROAD MIAMI BEACH, FL 33140

.025		REVISIONS	
	-	04/05/2021	
2021			
by:			
pg			

DESIGN REVIEW BOARD FINAL SUBMITTAL JANUARY 4, 2021 REV. APRIL 5, 2021

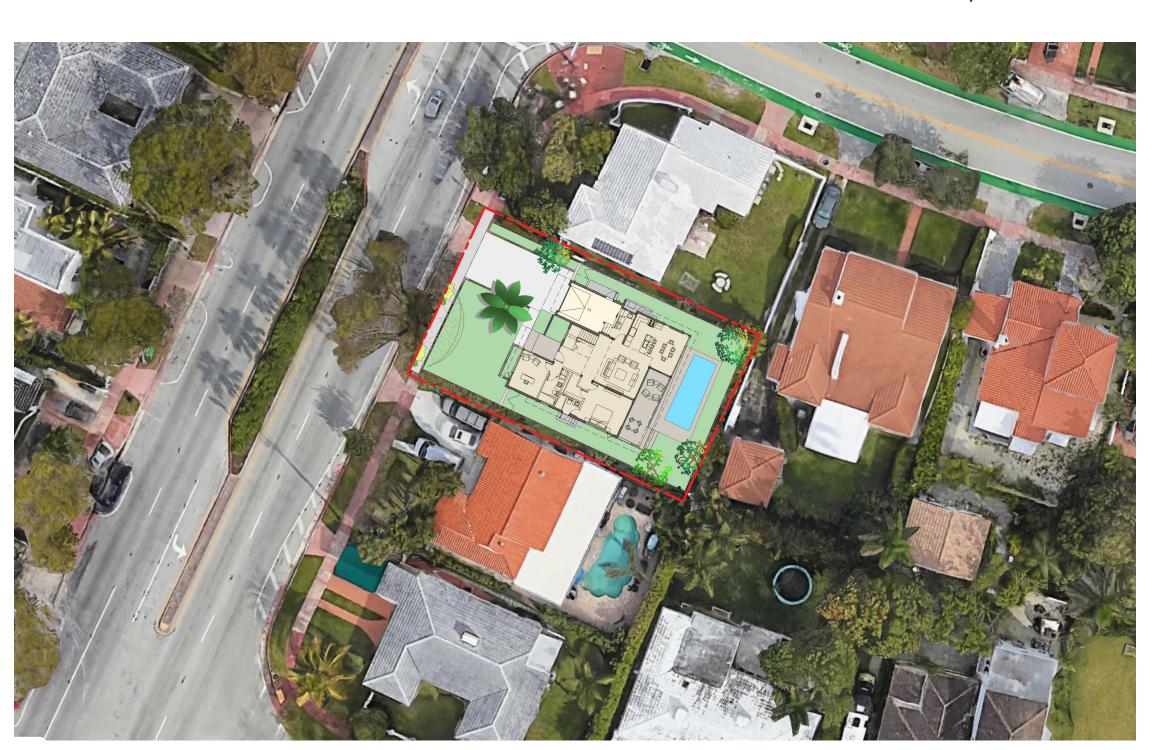





AR0015085

ARRANCHMENT OF DAYS IN TASK INCARD OF THE STATE OF THE ST






ABBAGH RESIDENC 4625 ALTON ROAD AIAMI BEACH, FL 33140

11.2025 REVISIONS ret: 04/05/2021 04/2

DESIGN REVIEW B

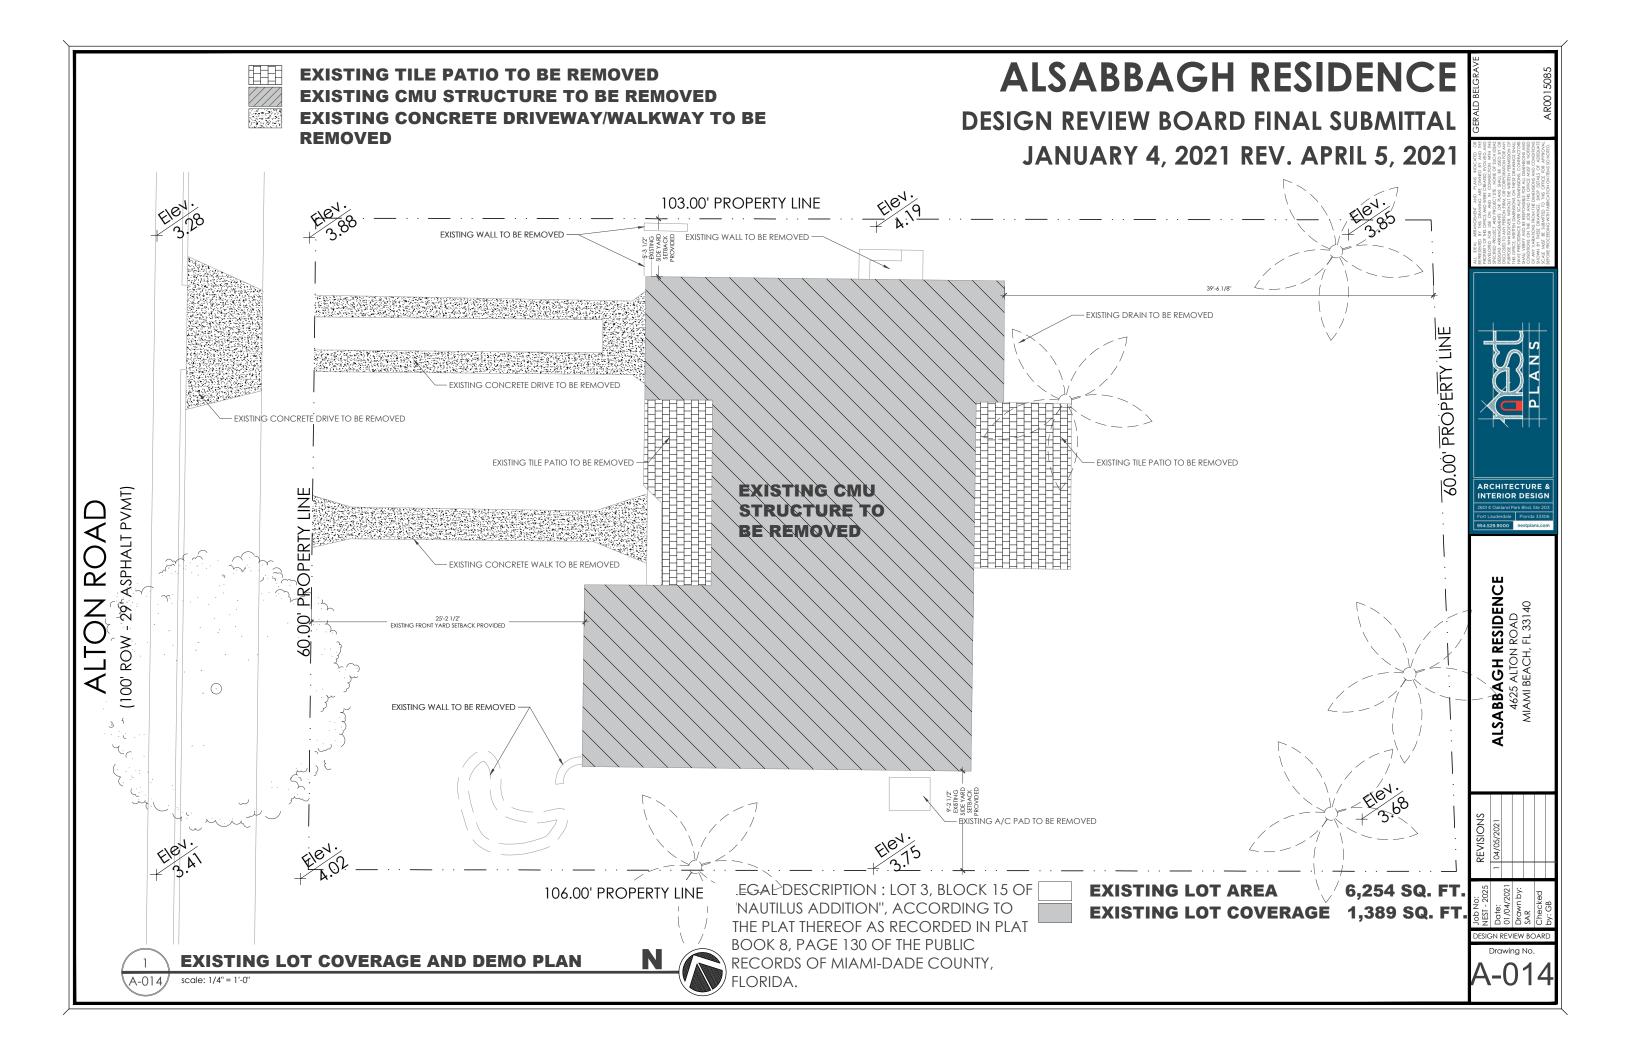

# DESIGN REVIEW BOARD FINAL SUBMITTAL JANUARY 4, 2021 REV. APRIL 5, 2021

ITEM #	Zoning Information									
1	Address:	4625 ALTON ROAD MIA	ıMI BEACH FLORIDA 33140							
2	Folio number(s):	02-3222-014-1470								
3	Board and file numbers :	DBR20-0619								
4	Year built:	1936	Zoning District:		RS-4					
5	Based Flood Elevation:	8.0' NGVD	Grade value in NGVD	:	4.01' NGVD					
5	Adjusted grade (Flood+Grade/2):	6.005'	Free board:		9.00'					
7	Lot Area:	6,254 SQ. FT.								
3	Lot width:	60.0'	Lot Depth:		104.24'					
1	Max Lot Coverage SF and %:	1,876 SQ. FT. / 30.0%	Proposed Lot Coverag	ge SF and %:	1,674 SQ. FT. / 26.89					
.0	Existing Lot Coverage SF and %:	1,389 SQ. FT. / 22.2%	Lot coverage deducte	d (garage-storage) SF:	1,574 SQ. FT. / 25.29					
.1	Front Yard Open Space SF and %:	1,200 SQ. FT. / 100%	Rear Yard Open Spac	e SF and %:	1,200 SQ. FT. / 100%					
12	Max Unit Size SF and %:	3,127 SQ. FT. / 50%	Proposed Unit Size S	Fand %:	2,836 SQ. FT. /45.3%					
.3	Existing First Floor Unit Size:	1,389 SQ. FT. / 22.2%	Proposed First Floor	Unit Size:	1,574 SQ. FT. / 25.29					
.5	Existing Second Floor Unit Size	N/A	SF and % (Note: to exfloor of the main hor		1,281 SQ. FT. / 66.8% 950 SQ. FT. / 59.2%					
.6			Proposed Roof Deck Maximum is 25% of t area immediately be	N/A						
		Required	Existing	Proposed	Deficiencies					
.7	Height:	24'	12'	23'-11"						
.8	Setbacks:									
9	Front First level:	30'	25'-2"	30'-3 1/4"						
0	Front Second level:	35'	N/A	36'-11 1/4"						
1	Side 1:	7'-6"	5'-3 1/2"	7'-6 3/4"						
2	Side 2 or (facing street):	7'-6"	9'-2 1/2	7'-7"						
!3	Rear:	20'-0"	39'-4 1/22"	20'-1"						
	Accessory Structure Side 1:		N/A	N/A						
4	Accessory Structure Side 2 or (facing street) :		N/A	N/A						
5	Accessory Structure Rear:		N/A	N/A						
6	Sum of Side yard :	15'-0"	14'-5"	15'-1 3/4"						
7	Located within a Local Historic Dist	tri ct?		NO						
8	Designated as an individual Histor	ric Single Family Reside		NO						
9	Determined to be Architecturally Si	gnificant?		YES	-					
lotes	:									

IL DECA, AMMICARRIM DE UNA RECORDE DE MERITOR EN TRES DE LA CONTRICACIÓN DE LA CONTRICACI





ALSABBAGH RESIDENCE 4625 ALTON ROAD MIAMI BEACH, FL 33140


REVISIONS
1 04/05/2021


NEST - 2025
NEST - 2025
Date:
01/04/2021
Drawn by:
SAR
Checked


Drawing No.

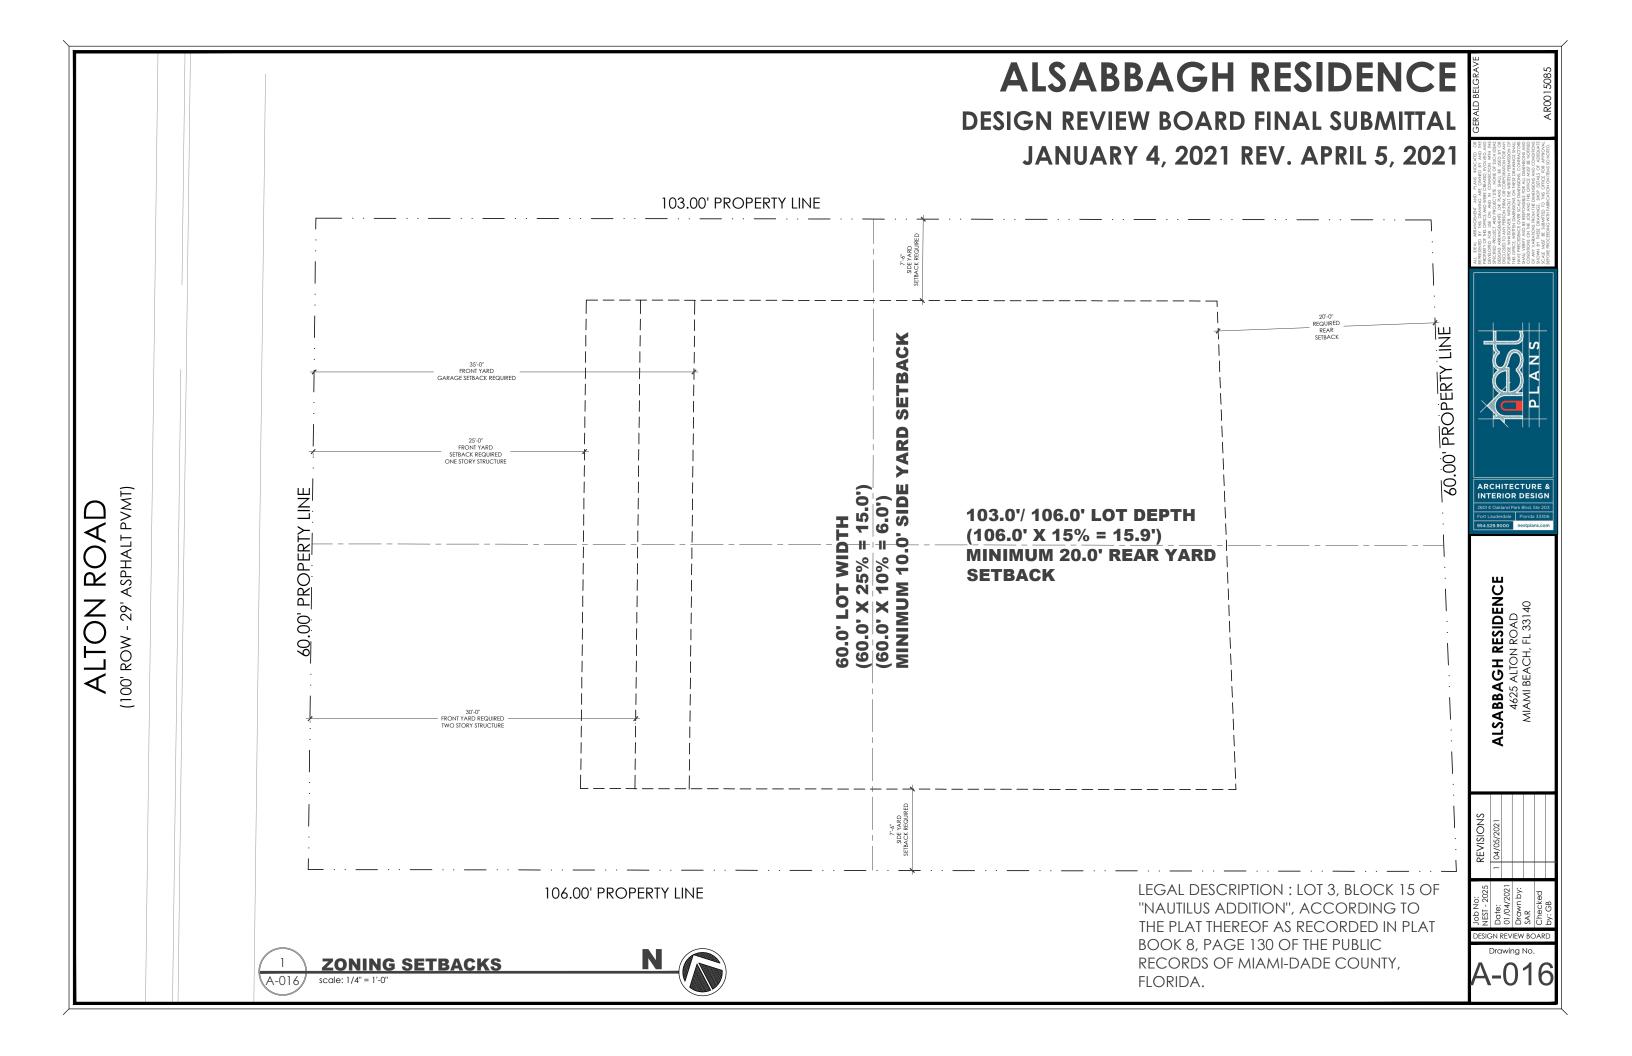


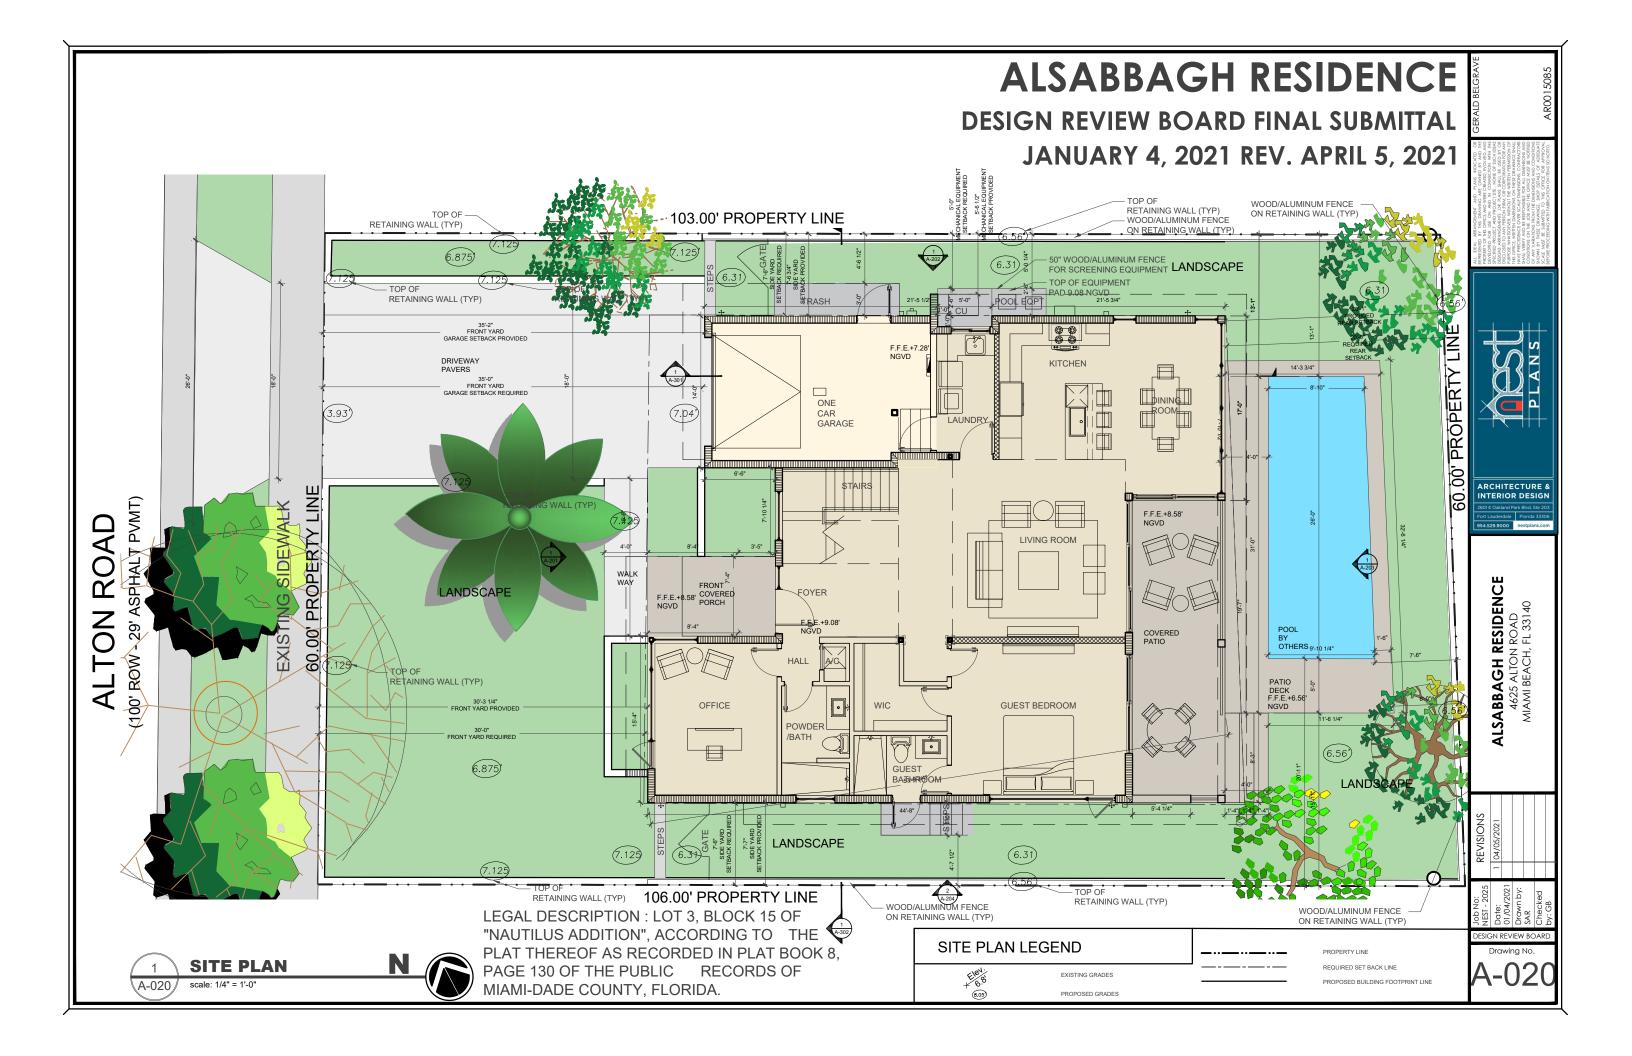

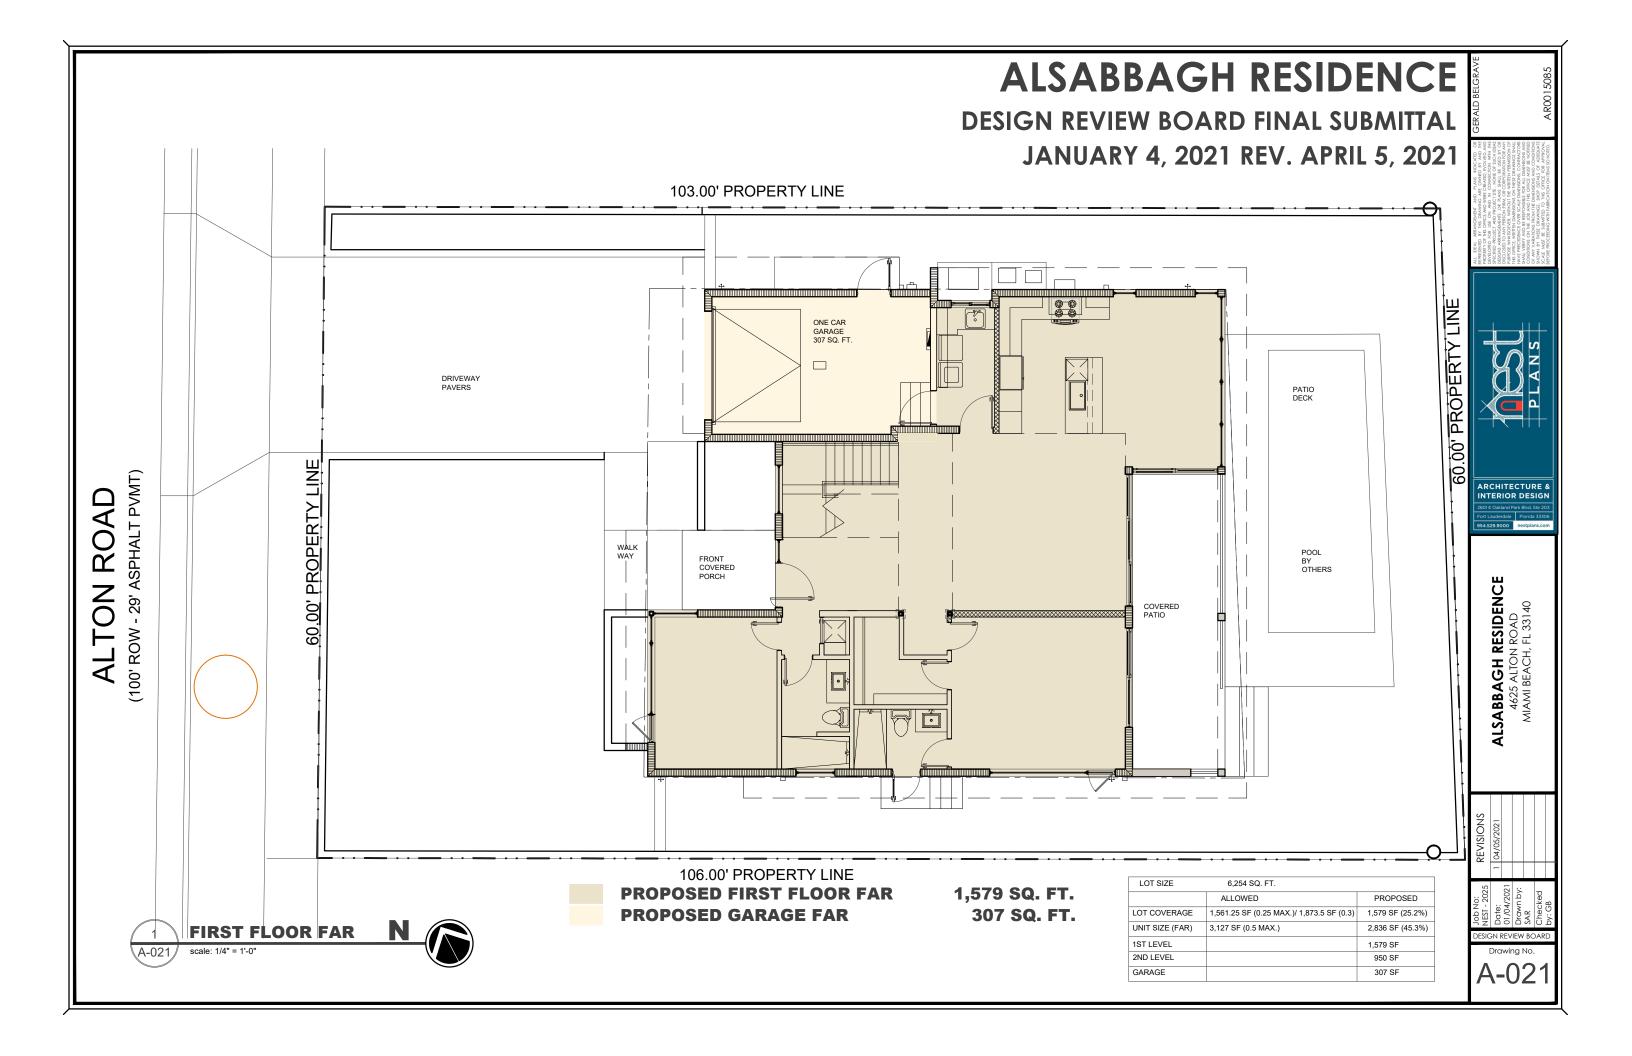

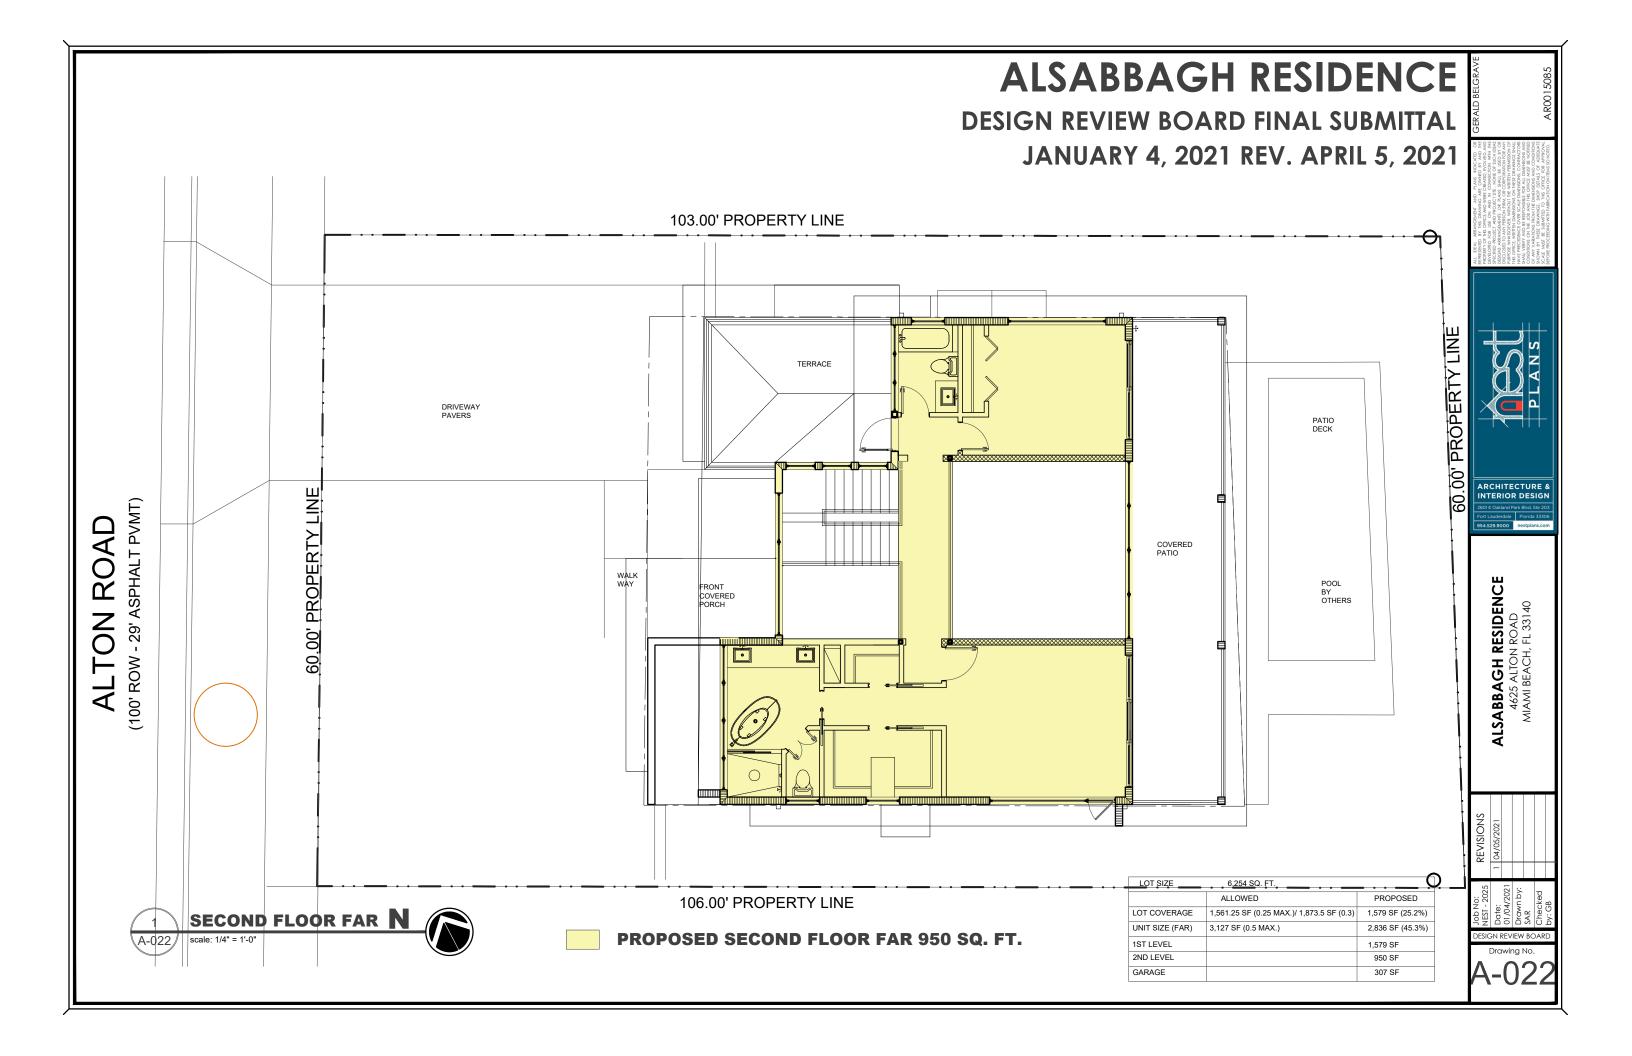

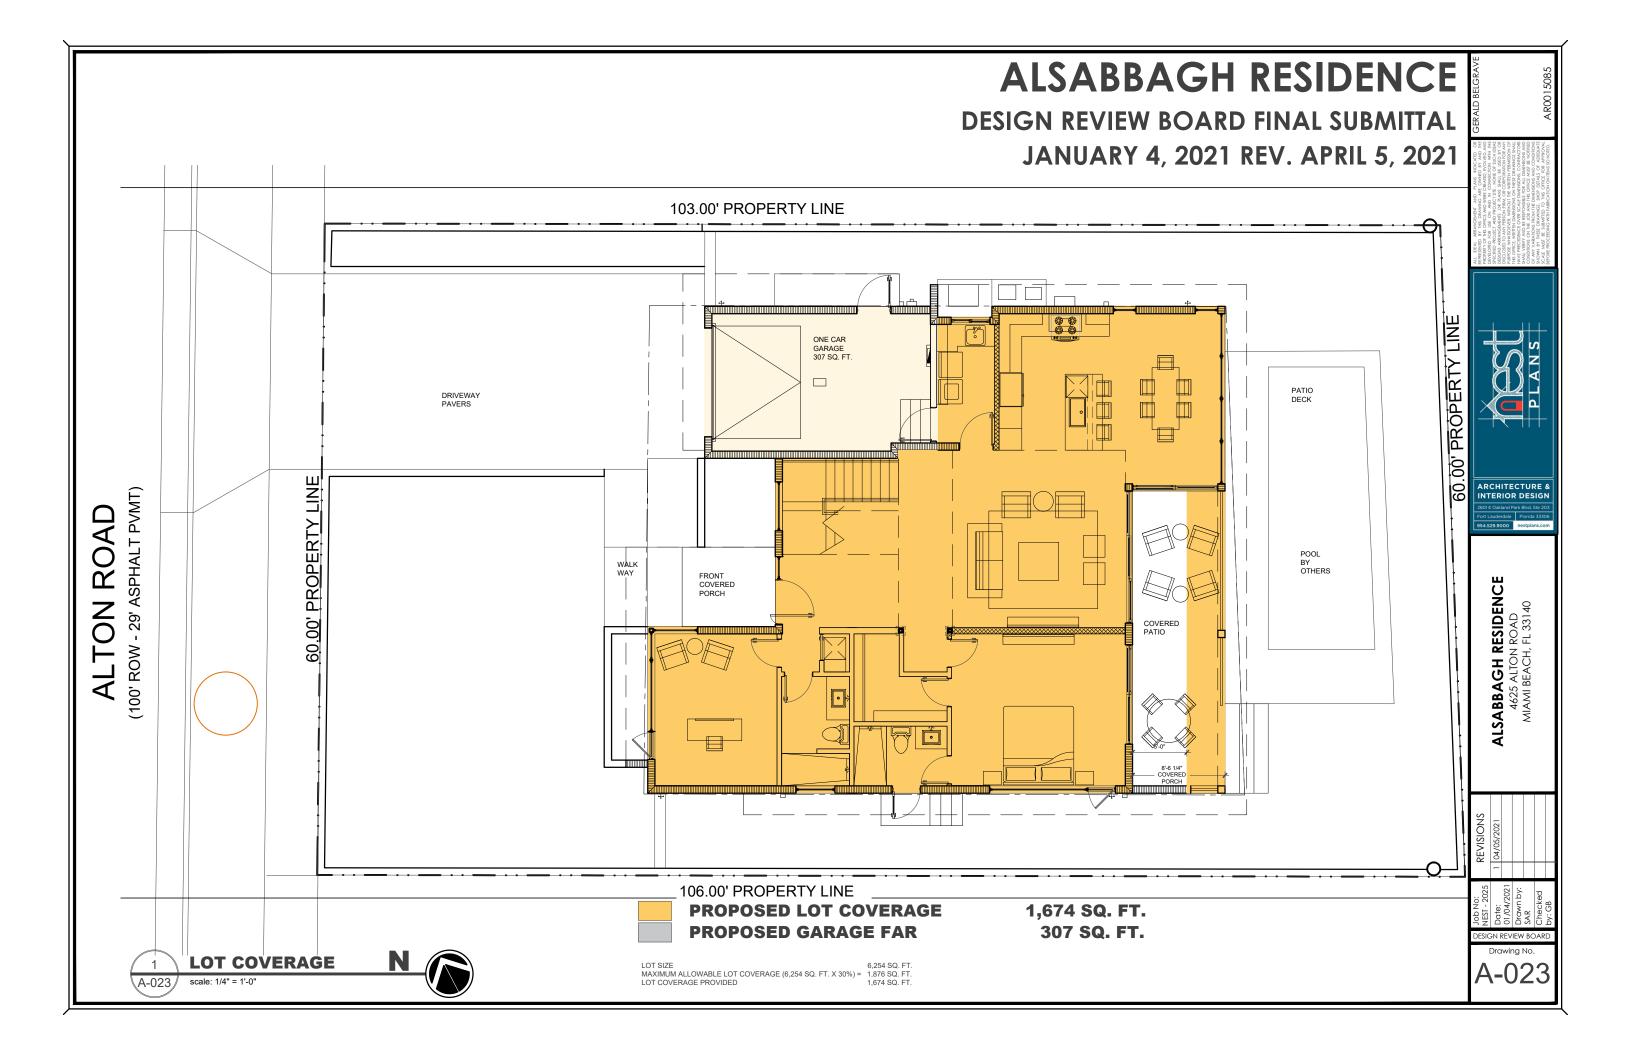

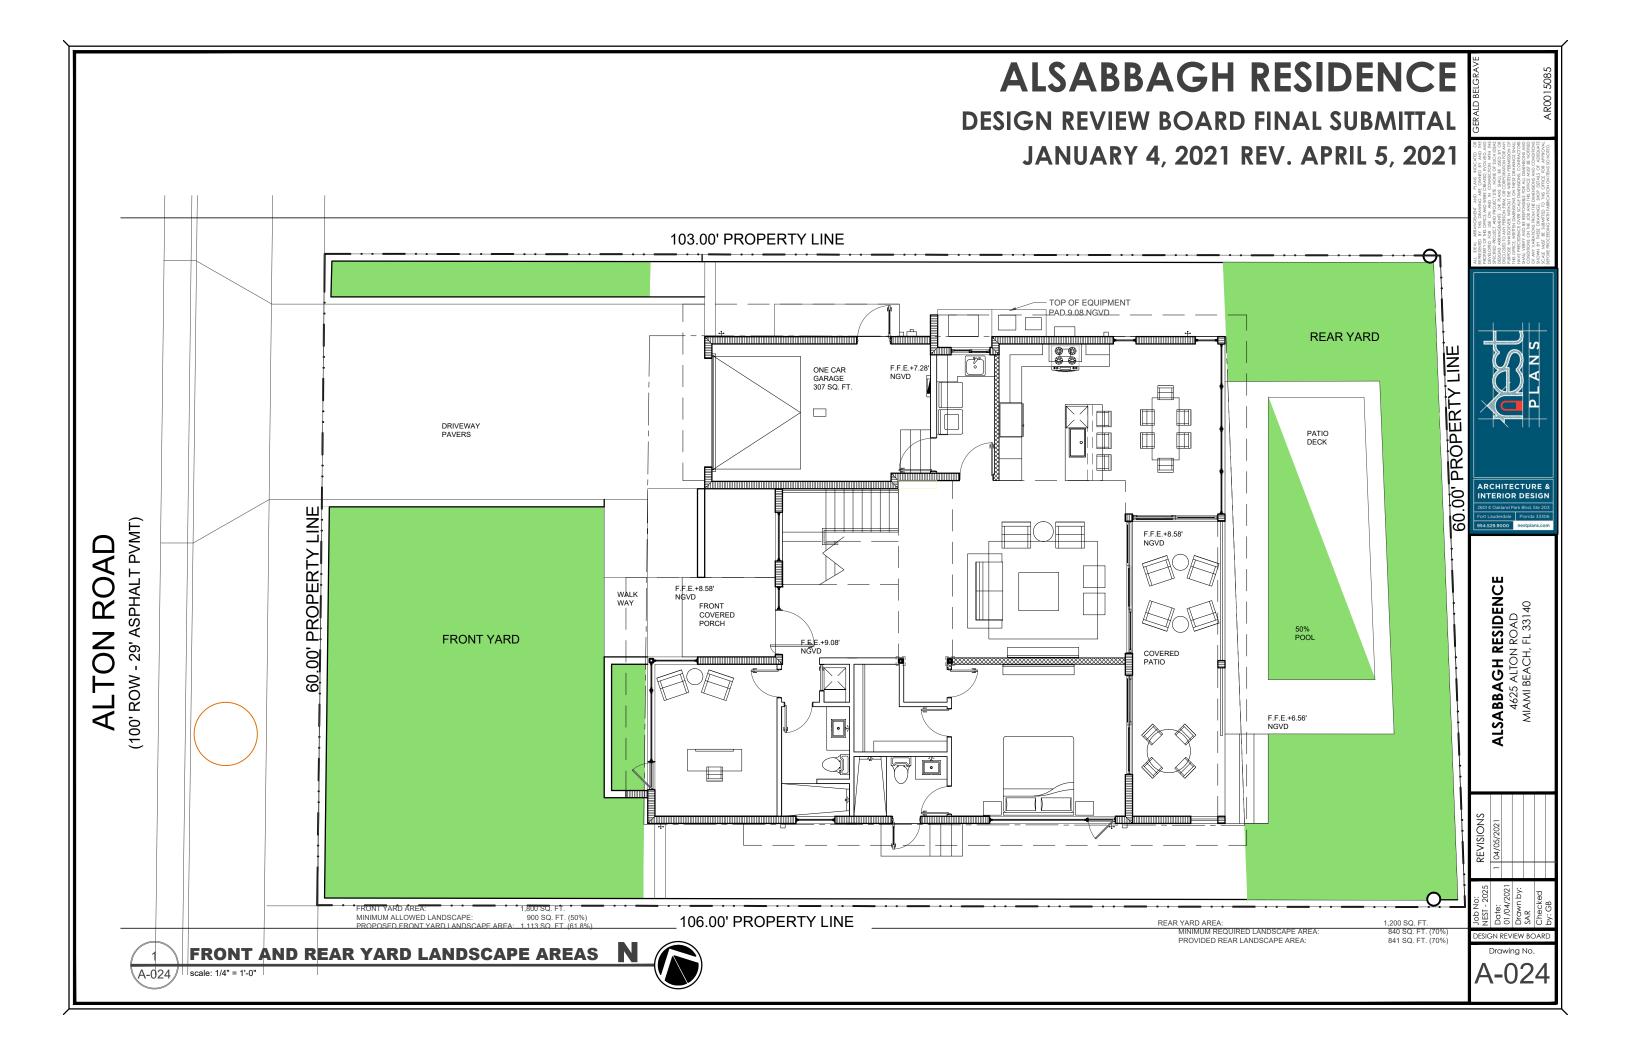

DESIGN REVIEW BOARD FINAL SUBMITTAL JANUARY 4, 2021 REV. APRIL 5, 2021

RO015085

AREACE DOS LEG NAD IN CONTROL AREACED ON THE AREACED ON THE CANADA IN CONTROL CANADA CONTROL CONTROL CANADA CANA



ARCHITECTURE & INTERIOR DESIGN

2601E Oakland Park Blvd. Ste 203
Fort Lauderdale Florida 33306
954.529.9000 eestplans.com

ALSABBAGH RESIDENCE 4625 ALTON ROAD MIAMI BEACH, FL 33140


ALSABBA

No: REVISIONS e: 1 04/05/2021 evan by: Reved GB

DESIGN REVIEW BOA

Drawing No

A-025

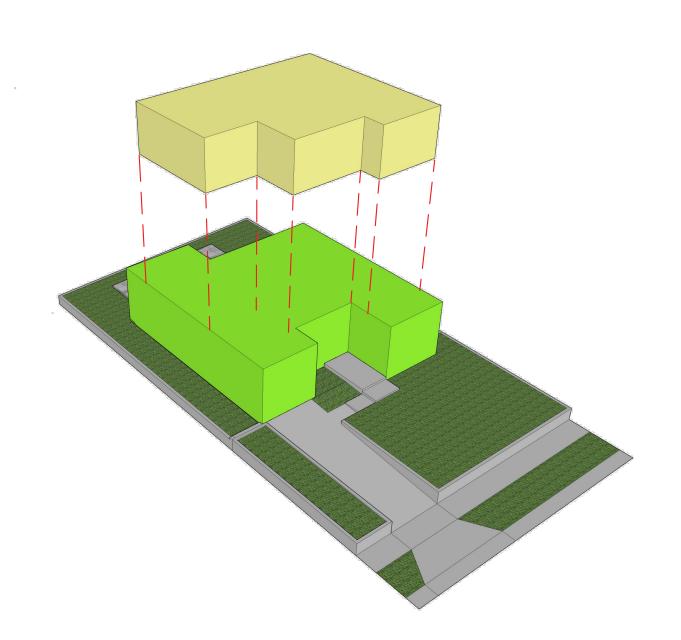

PHYSICAL VOLUME OF SECOND FLOOR 1,249 SQ. FT. (66.2%)


70 % OF GROUND FLOOR - 1,918 X 70% = 1,343 SQ. FT. MAXIMUM ALLOWABLE


PHYSICAL VOLUME OF GROUND FLOOR 1,886 SQ. FT. (100.0%)


**VOLUMETRIC DIAGRAM** 


RELEVANT CODE INFORMATION:


FOR TWO STORIES HOMES WITH OVERALL LOT COVERAGE OF 25% GREATER, PHYSICAL COLUMN OF THE SECOND FLOOR SHALL NOT EXCEED 75% OF THE FIRST FLOOR, INCLUSIVE OF ANY ENCLOSED PARKING STRUCTURE. (142-105 (b)

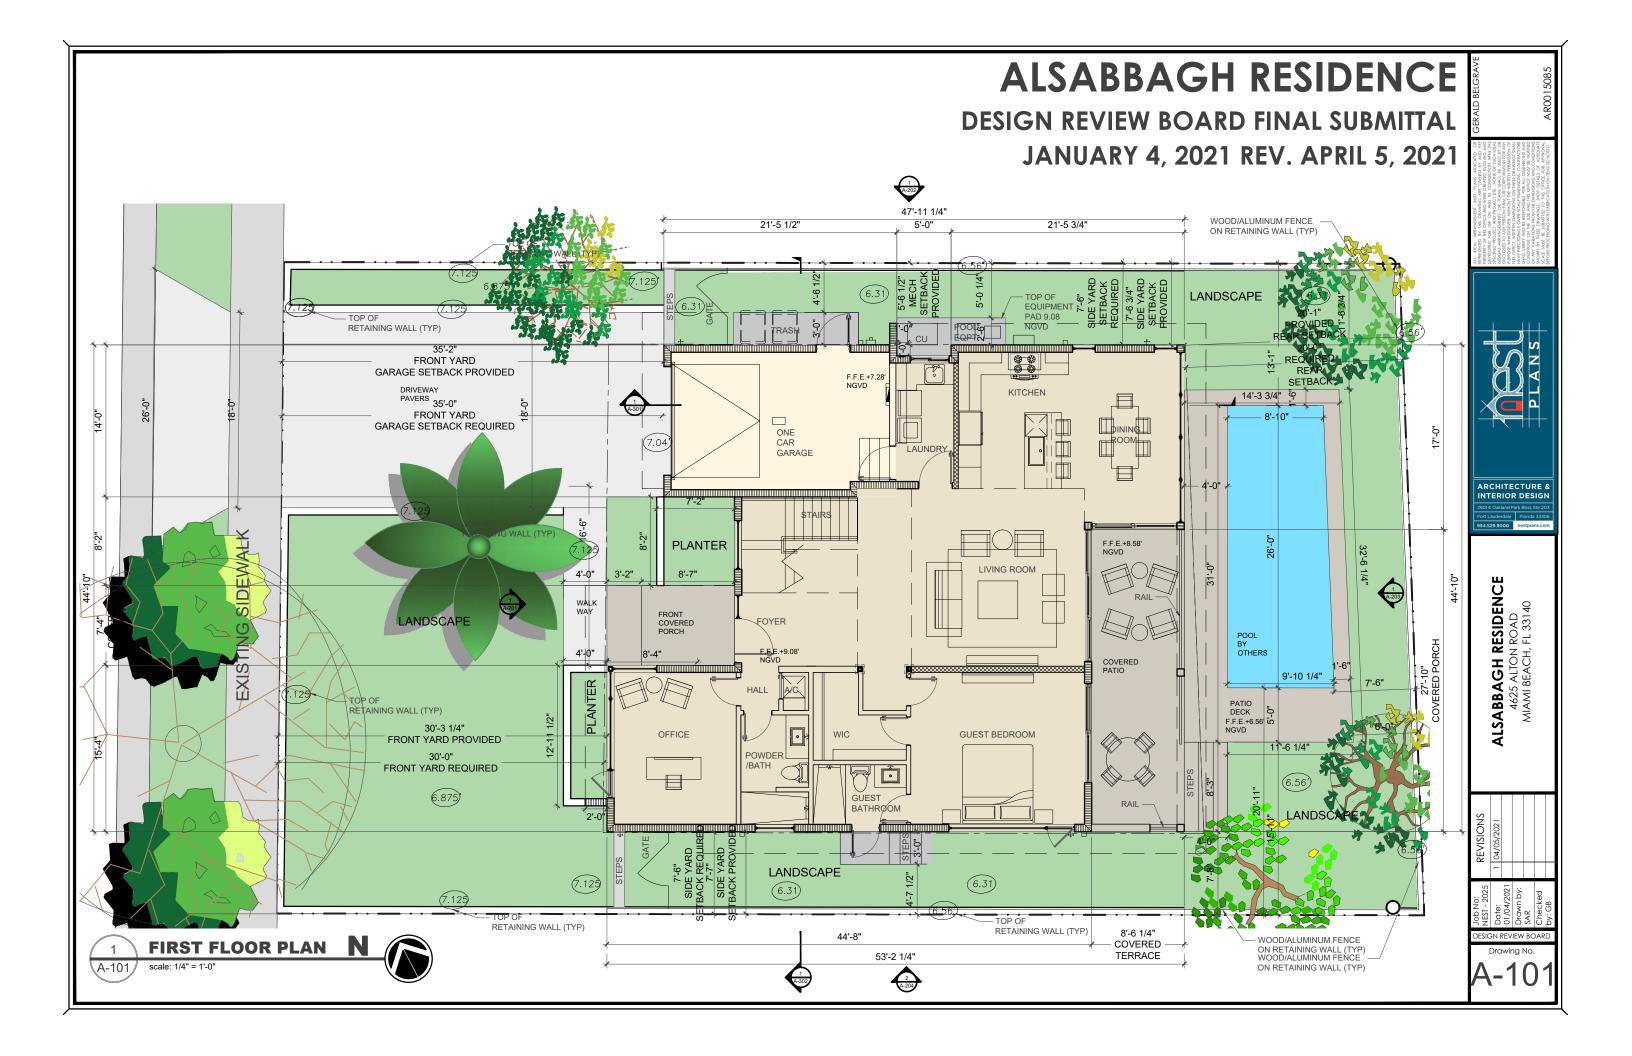


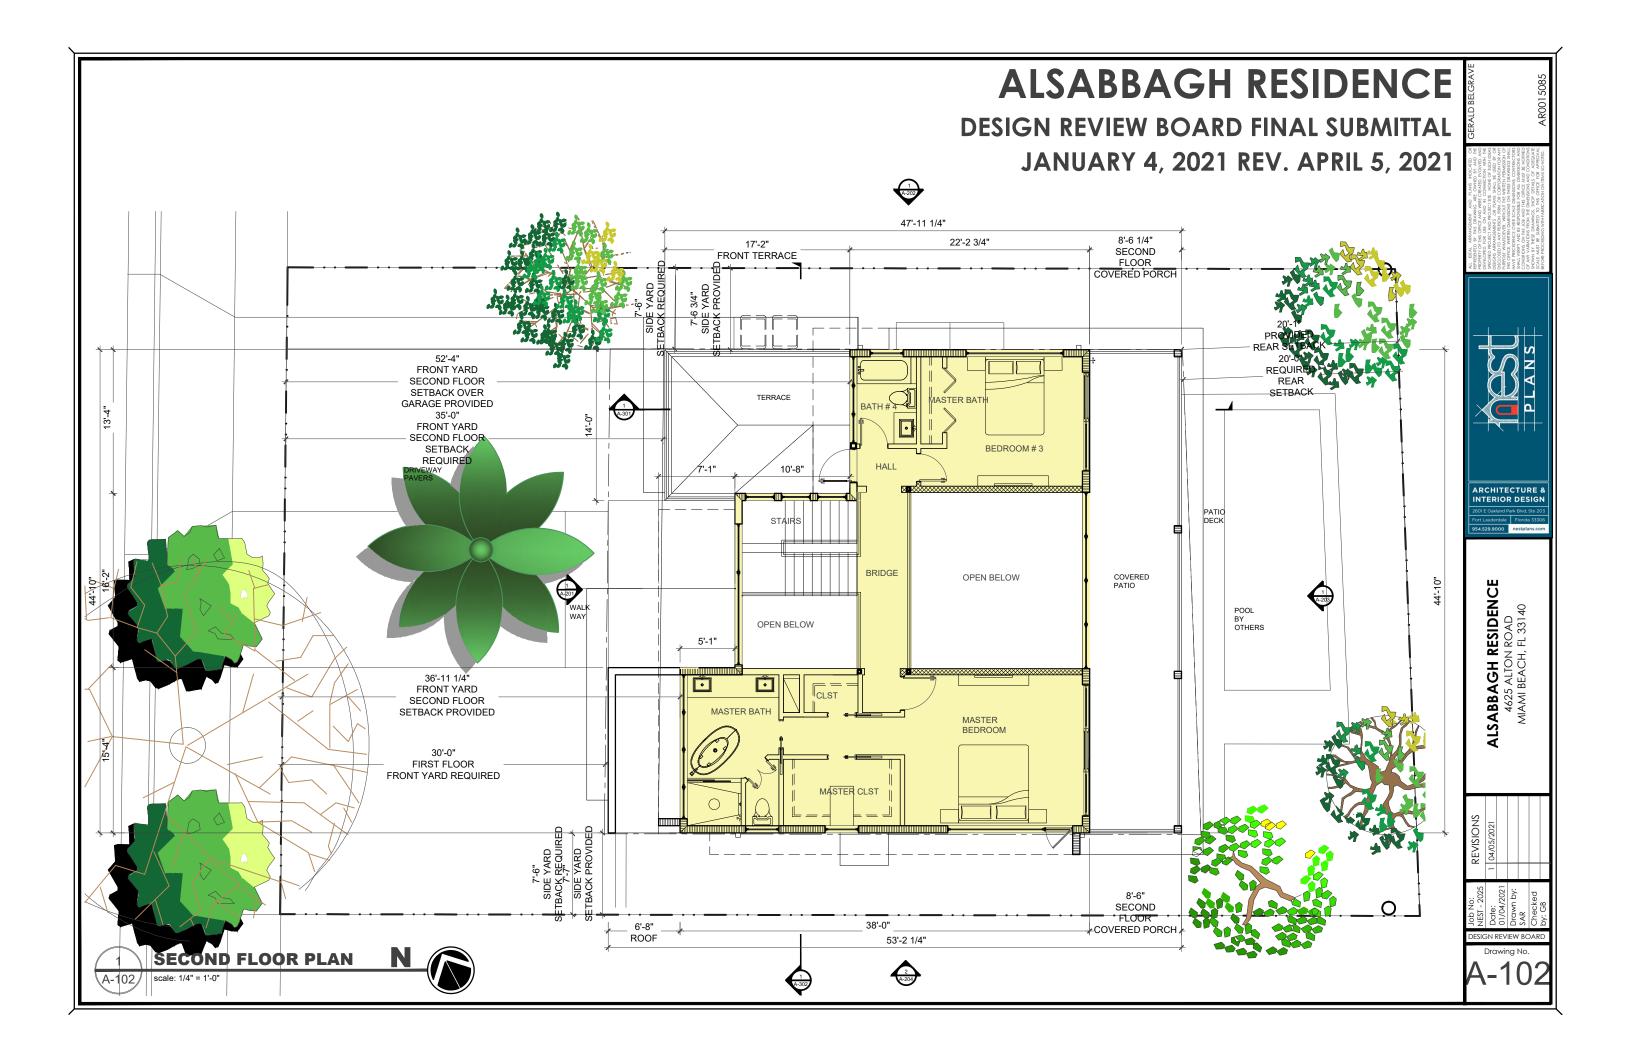


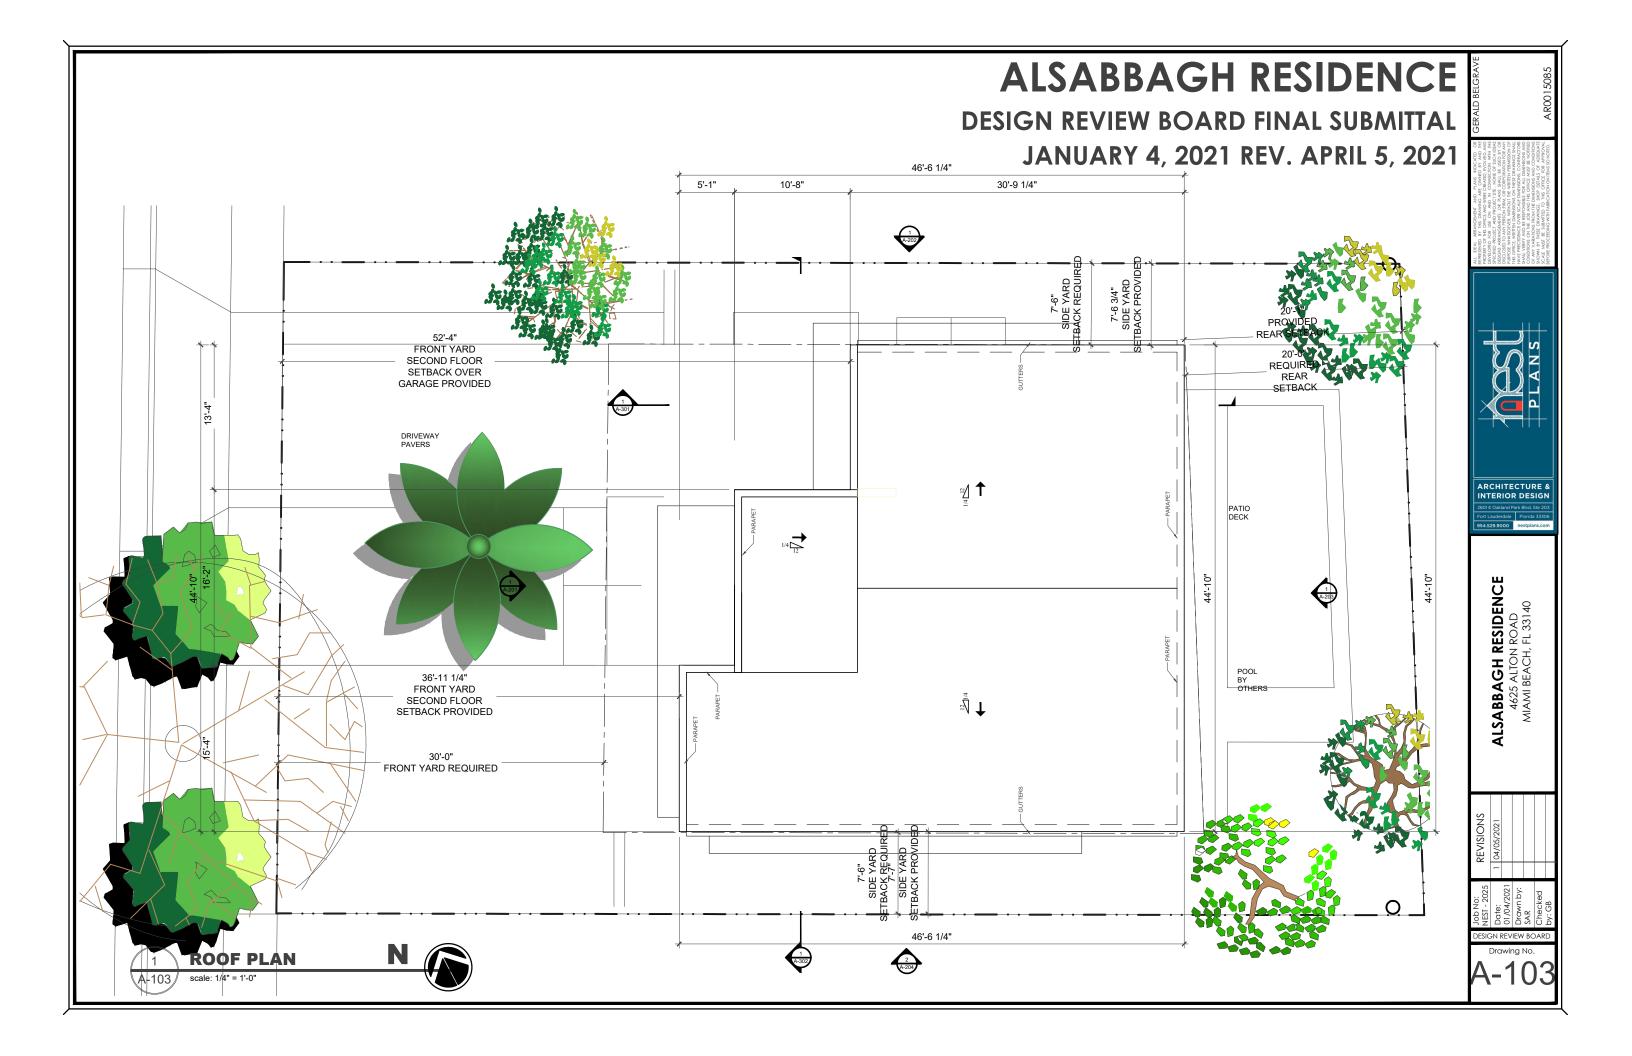

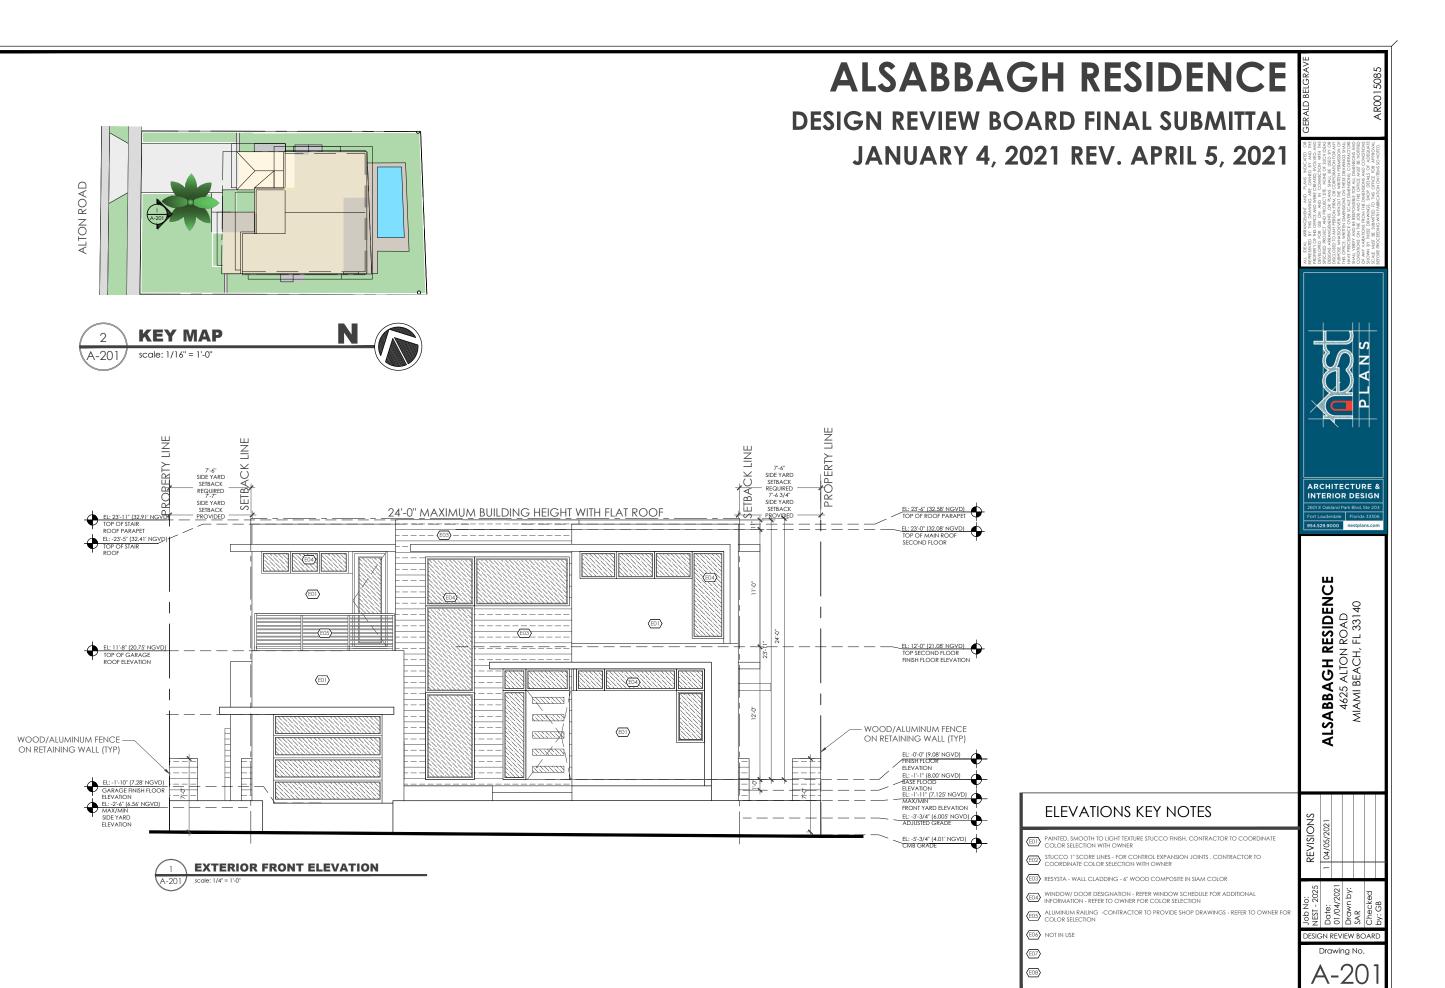


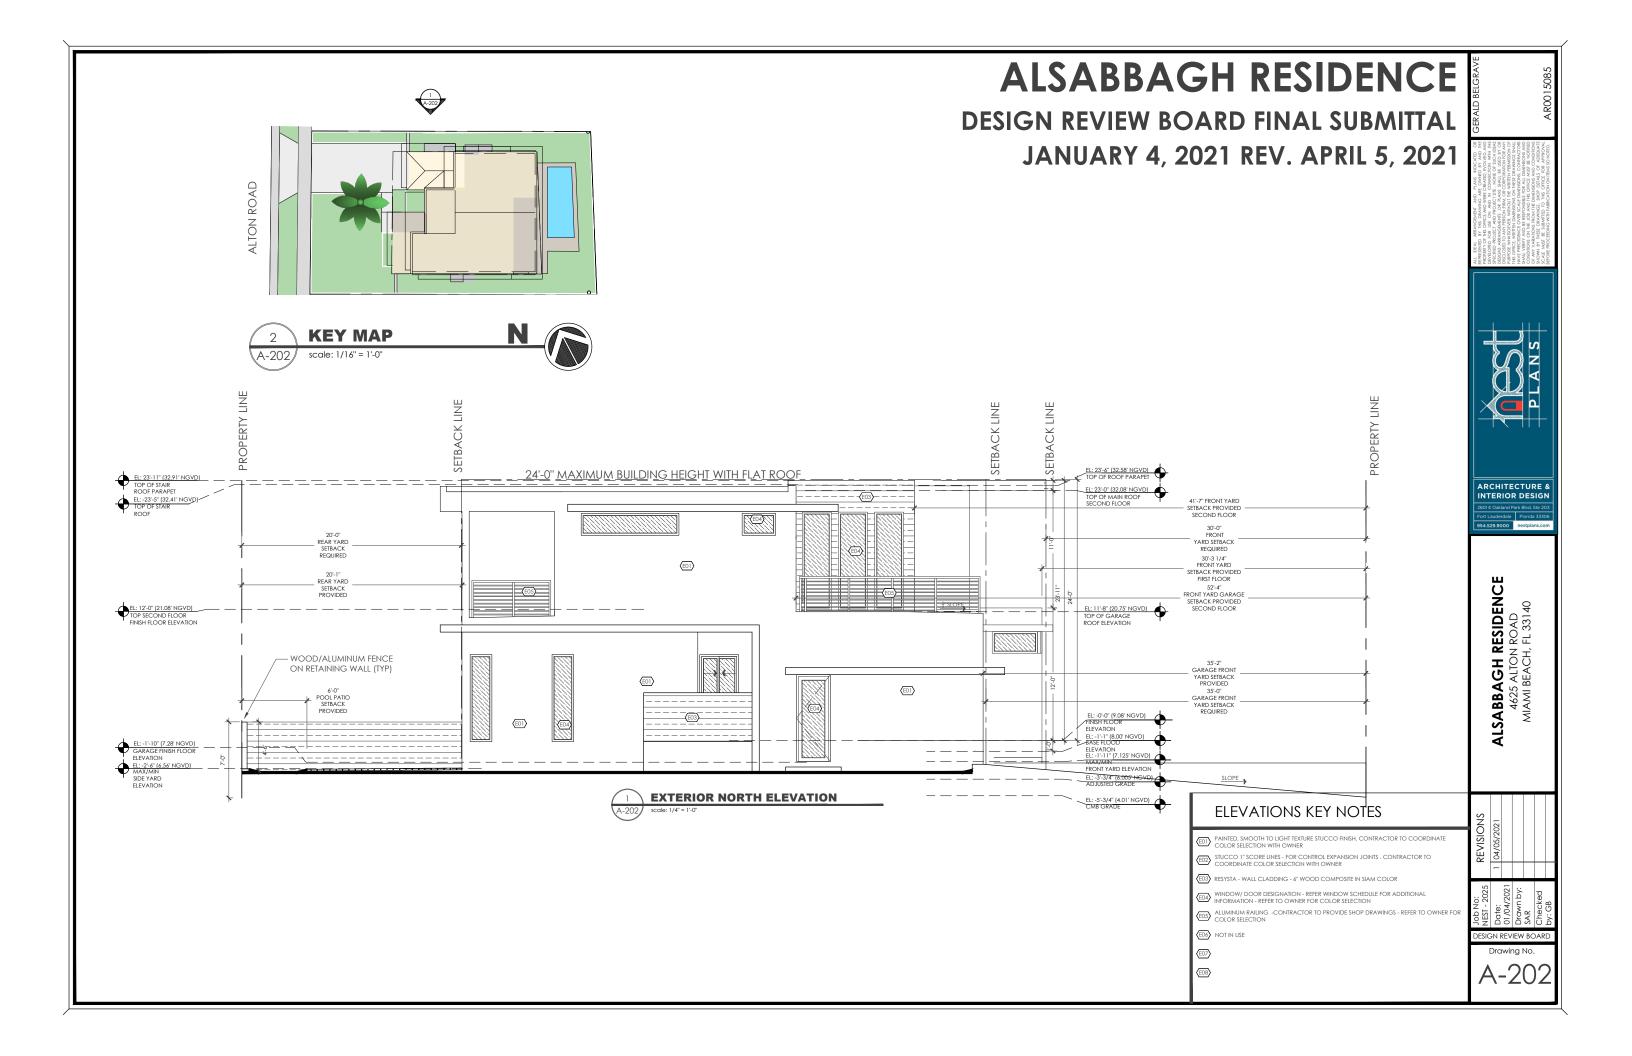


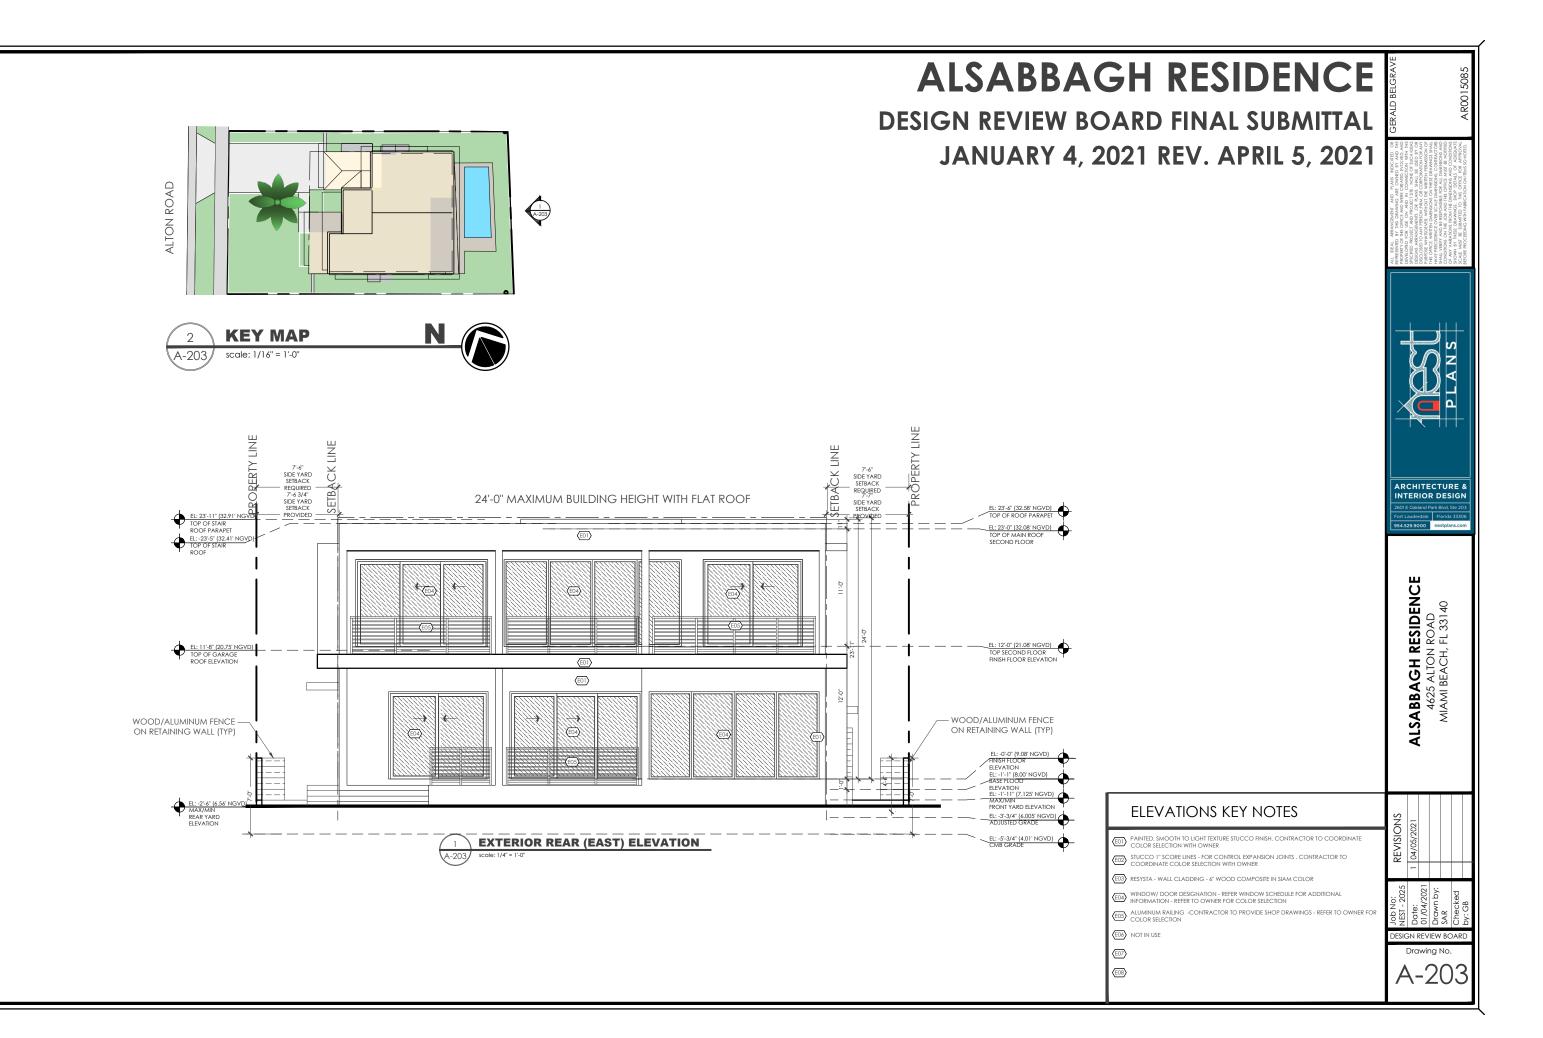

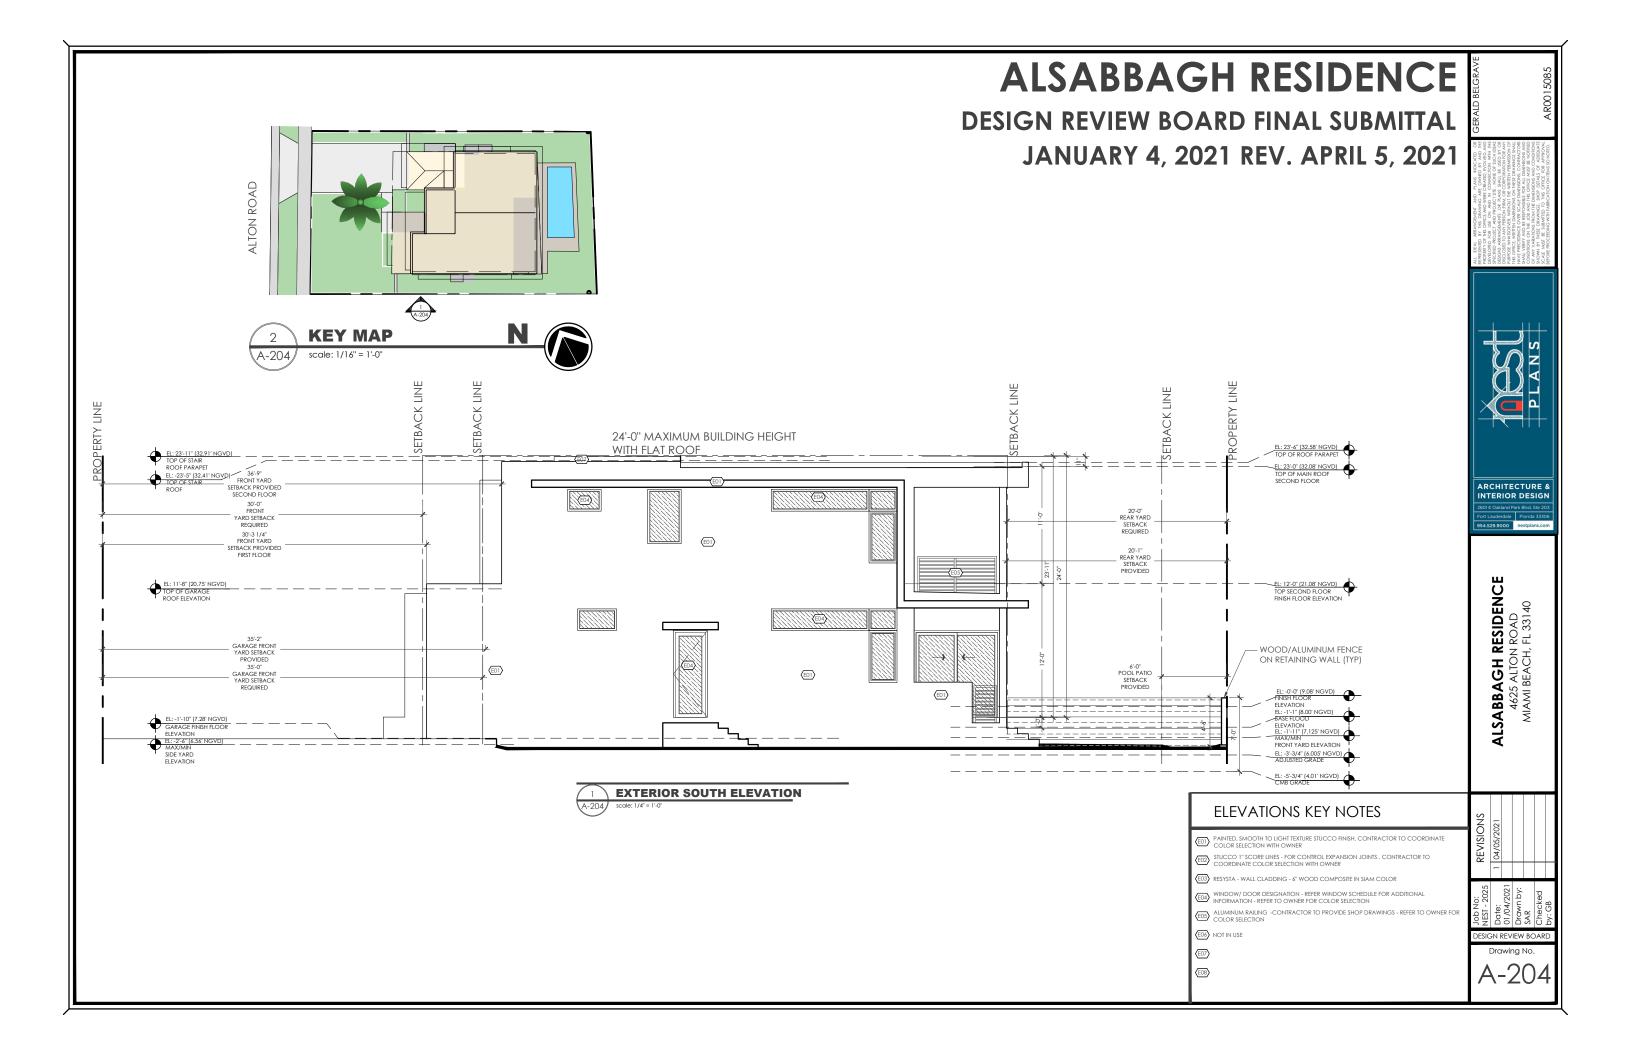

DESIGN REVIEW BOARD FINAL SUBMITTAL JANUARY 4, 2021 REV. APRIL 5, 2021

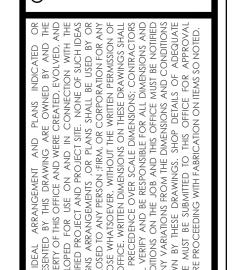

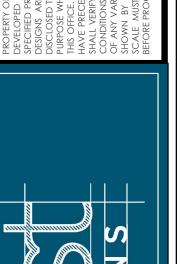







ALSABBAGH RESIDENCE 4625 ALTON ROAD MIAMI BEACH, FL 33140

DESIGN REVIEW BOARD Drawing No.

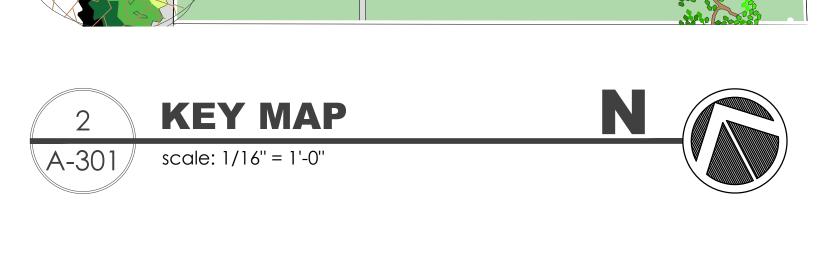

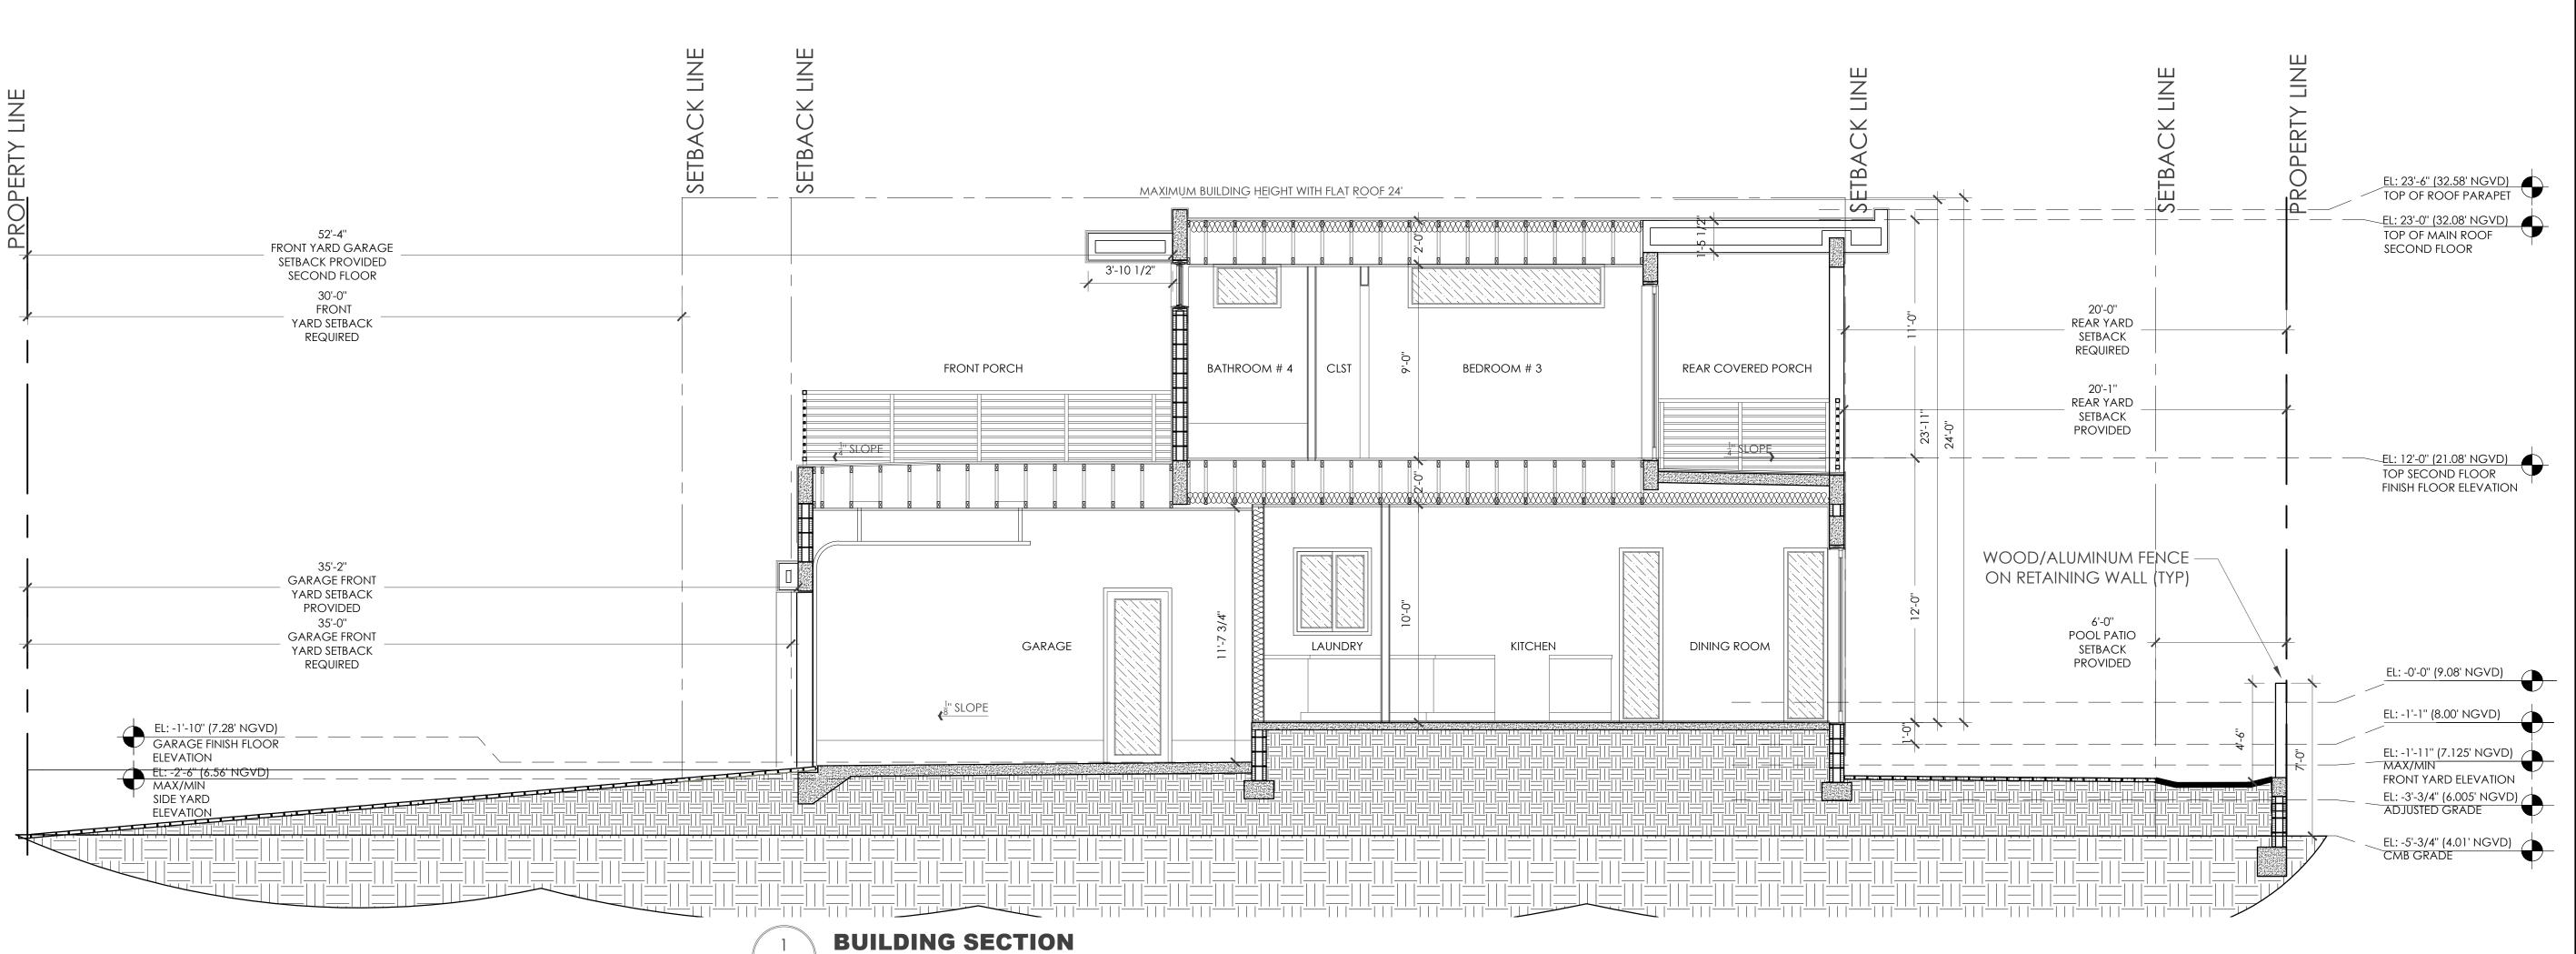

A-301 scale: 1/4" = 1'-0"

DESIGN REVIEW BOARD FINAL SUBMITTAL JANUARY 4, 2021 REV. APRIL 5, 2021



PROFICE OF THE CHARLES FOUND TO THE PROFILE OF THE CHARLES FOR THE CHARLES FOUND THE



ARCHITECTURE & INTERIOR DESIGN
2601E Oakland Park Blvd, Ste 203
Fort Lauderdale Florida 33306
954.529.9000 nestplans.com

EL: 23'-6" (32.58' NGVD) TOP OF ROOF PARAPET

WOOD/ALUMINUM FENCE


ON RETAINING WALL (TYP)

ELEVATION EL: -1'-11" (7.125' NGVD) MAX/MIN FRONT YARD ELEVATION ALSABBAGH RESIDENCE 4625 ALTON ROAD MIAMI BEACH, FL 33140

No:
1-2025 REVISIONS
e: 1 04/05/2021
wn by:
csced
GB

NEST - 2 Nes

A-302

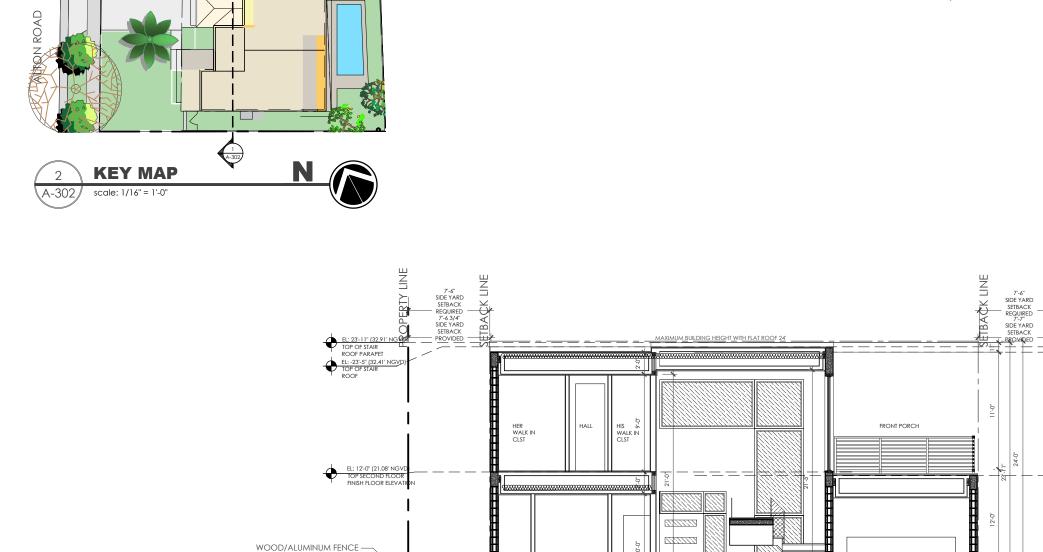

**BUILDING SECTION** 

FOYER

ON RETAINING WALL (TYP)

DESIGN REVIEW BOARD FINAL SUBMITTAL JANUARY 4, 2021 REV. APRIL 5, 2021










ARCHITECTURE & INTERIOR DESIGN
2601 E Oakland Park Blvd, Ste 203
Fort Lauderdale | Florida 33306
954.529.9000 | nestplan.com

ALSABBAGH RESIDENCE 4625 ALTON ROAD MIAMI BEACH, FL 33140

2025 REVISIONS
2021 1 04/05/2021
2021 1 04/05/2021
A by:

A-40

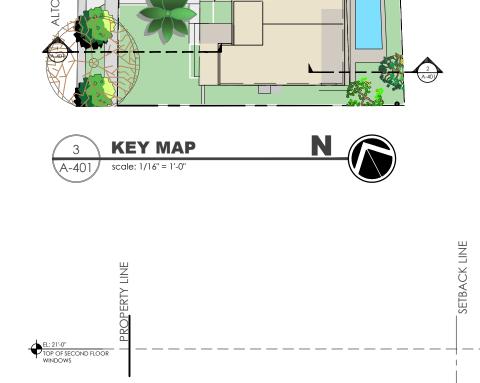


30'-0" FRONT YARD SETBACK REQUIRED

FRONT YARD SETBACK SECTION


EL: -1'-11" (7.125' NGVD) MAX/MIN FRONT YARD ELEVATION


> NOTE: AVERAGE GRADE 4.01' NGVD ADJUSTED GRADE 6.005 NGVD

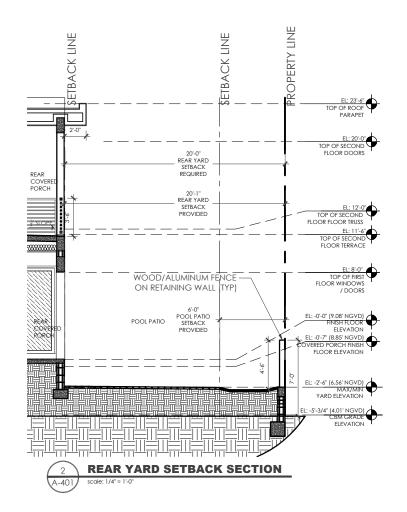


**DESIGN REVIEW BOARD FINAL SUBMITTAL** 

JANUARY 4, 2021 REV. APRIL 5, 2021

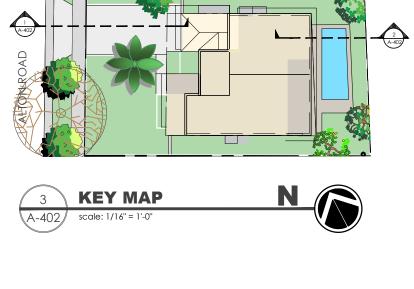

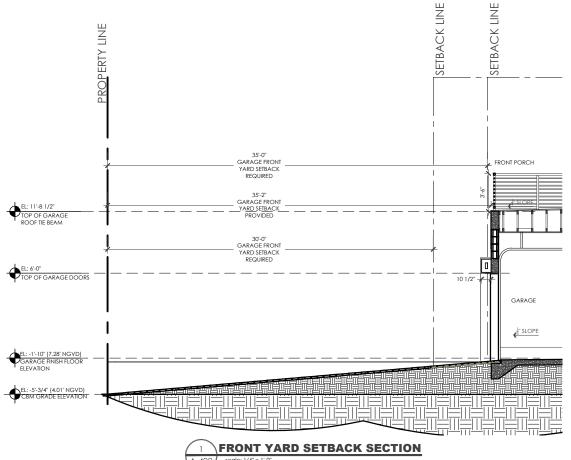

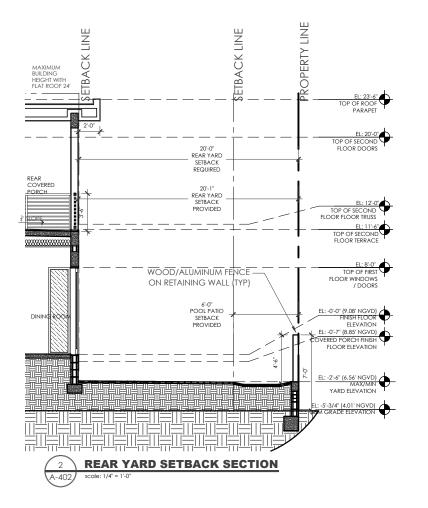





ALSABBAGH RESIDENCE 4625 ALTON ROAD MIAMI BEACH, FL 33140

							ı
REVISIONS	04/05/2021						
	-						ı
b No: ST - 2025	ate:	/04/2021	awn by:	2	ecked	:GB	


**DESIGN REVIEW BOARD FINAL SUBMITTAL JANUARY 4, 2021 REV. APRIL 5, 2021** 



ARCHITECTURE & INTERIOR DESIGN

ALSABBAGH RESIDENCE 4625 ALTON ROAD MIAMI BEACH, FL 33140

A-403

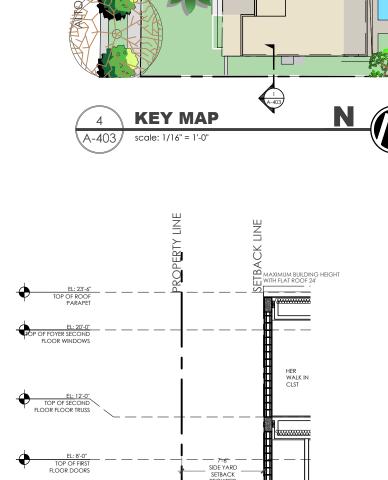


SIDE YARD SETBACK SECTION

WOOD/ALUMINUM FENCE -ON RETAINING WALL (TYP)

EL: -2'-6" (6.56' NGVD)


YARD ELEVATION

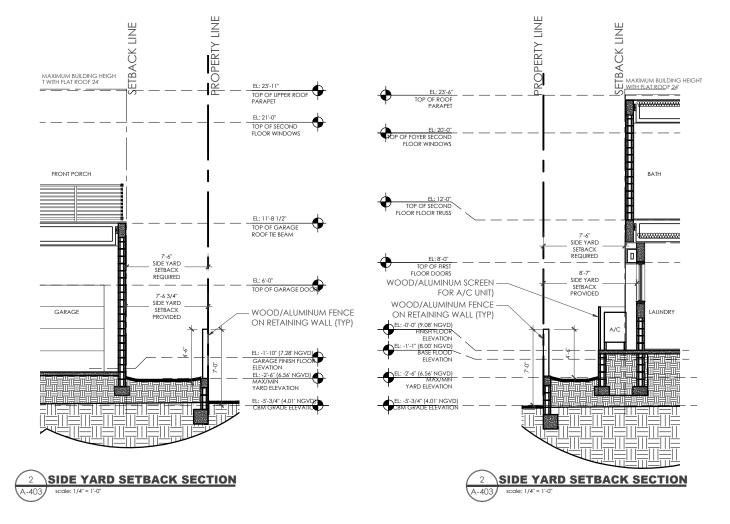


**DESIGN REVIEW BOARD FINAL SUBMITTAL** JANUARY 4, 2021 REV. APRIL 5, 2021





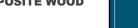

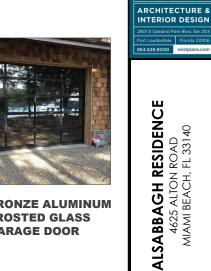

06 - BRONZE ALUMINUM FROSTED GLASS



02 - BRICK PAVER



**GARAGE DOOR** 



03 - COMPOSITE WOOD



01 - STUCCO SMOOTH

04 - BRONZE WINDOW/

**DOOR FRAMES** 

**05 - BRONZE ALUMINUM RAILING** 



# **MATERIAL SELECTION BOARD**

ALTON ROAD

**KEY MAP** 

#### **ELEVATIONS KEY NOTES**

- (EDI) PAINTED, SMOOTH TO LIGHT TEXTURE STUCCO FINISH. CONTRACTOR TO COORDINATE COLOR SELECTION WITH OWNER
- E02 BRICK PAVER -
- $\overline{\text{E03}}$  resysta wall cladding 6" wood composite in Siam Color
- (EO) ALUMINUM RAILING -CONTRACTOR TO PROVIDE SHOP DRAWINGS REFER TO OWNER FO
- $\langle \overline{\text{E06}} \rangle$  garage door bronze aluminum and frosted glass door

#### GENERAL LANDSCAPE NOTES

A mandatory pre-planting meeting is required with the City's landscape architect, Thomas White (954-828-5350) prior to any landscape work done on site.

#### The plan takes precedence over the plant list.

2 Full business days before digging, call toll free 1-800-432-4770 Sunshine State One Call of Florida, Inc. Notification Center. For City of Fort Lauderdale Utilities call 1-954-828-8000. Contractors are responsible for coordinating with the owners and appropriate public agencies to assist in locating and verifying all underground utilities prior to excavation. All existing utilities shown on the plans are to be considered approximate and should be verified by the contractor prior to the start of work operations..

General site and berm grading to  $\pm/-1$  inch (1") shall be provided by the general contractor. All finished site grading and final decorative berm shaping shall be provided by the landscape contractor.

All sizes shown for plant material on the plans are to be considered Minimum. All plant material must meet or exceed these minimum requirements for both height and spread. Any other requirements for specific shape or effect as noted on the plan(s) will also be required for final acceptance.

All plant material furnished by the landscape contractor shall be Florida #1 or better as established by Grades and Standards for Florida Nursery Trees and Plants.

All trees designated as single trunk shall have a single, relatively straight, dominant leader, proper structural branching and even branch distribution. Trees with bark inclusion, tipped branches, and co-dominant trunks will not be accepted. Trees with girdling, circling and/or plunging roots will be rejected.

All planting beds shall be free of all rocks  $\frac{1}{2}$ " or larger, sticks, and objectionable material including weeds, weed seeds. All limerock shall be removed/cleaned down to the native soils. Planting soil  $\frac{50}{50}$  sand/topsoil mix shall be delivered to the site in a clean loose and friable condition and is required around the root ball of all trees and palms, the top 6" of all shrubs and ground cover beds. This soil can be tilled into the existing soil after the existing soil has been cleaned of all rocks, limestone and sticks. Recycled compost is encouraged as a soil amendment alternative. Sod  $\frac{1.5-2}{20}$  topsoil comes furnished. A mandatory inspection of the planting beds is required before planting (954-828-5350).

All burlap, string, cords, wire baskets, plastic or metal containers shall be removed from the rootballs before planting. Remove all bamboo and metal nursery stakes. Remove all tagging tape.

All trees/palms shall be planted so the top of the root ball, root flair are slightly above final grade. Shrub material shall be planted such that the top of the plant ball is flush with the surrounding grade. It is the sole responsibility of the landscape contractor to insure that all new plantings receive adequate water during the installation and during all plant warranty periods. Deep watering of all new trees and palms and any supplemental watering that may be required to augment natural rainfall and site irrigation is mandatory to insure proper plant development and shall be provided as a part of this contract.

All trees/palms shall be staked using biodegradable material. No wire, black strapping, or other synthetic material shall be used. Nailing into trees and palms for any reason is prohibited and the material will be rejected. Please refer to the planting details

All landscape and lawn areas shall be irrigated by a fully automatic sprinkler system with a minimum 100% coverage with all heads adjusted to 50% overlap. Each system shall be installed with an operational rain sensor and rust inhibitor.

#### No fertilizers are required.

All landscape areas shall be covered with Pine Straw, Pine Bark, Eucalyptus or sterilized seed free Melaleuca mulch to a minimum depth of three inches (3") of cover when settled. Spread mulch to 1" thickness 3" away from the trunks/stems of all plant material. All trees in sodded areas shall have a clean cut 4' diameter mulch ring. The 5—6" height water ring shall be made from mulch, not soil. Certain areas may receive a thicker mulch cover where noted on plans. Cypress, red, gold and green mulch is prohibited.


All open areas not covered by trees, palms, shrubs, vines or ground covers shall receive Stenotaphrum secundatum, St. Augustine 'Palmetto' sod, whether labeled on the plans or not, unless a different species is indicated on the planting plan. All noted s.f. shall be approximate; it is the contractor's responsibility to do his or her take off and sod all open areas. It shall be the responsibility of the contractor to include in the bid, the repair of any existing sod which may be damaged during construction.


Please refer to the planting details for a graphic representation of the above notes.

All ideas, designs and plans indicated or represented by this drawing are owned by and are the exclusive property of Thomas White, ASLA—ISA, AKA Land Art Planning & Design, LLC.


All plant material as included herein shall be warranted by the landscape contractor for a minimum period as follows: All trees and palms for 12 months, all shrubs, vines, groundcovers and miscellaneous planting materials for 90 days, and all lawn areas for 60 days after final acceptance by the owner or owner's representative.

Failure to comply with any of the above will result in the entire landscape installation to be removed and completely re—planted.

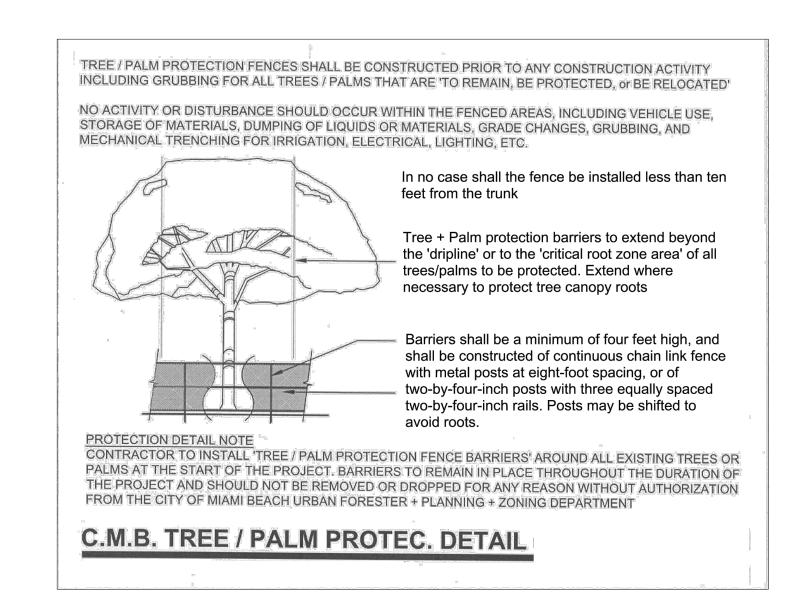


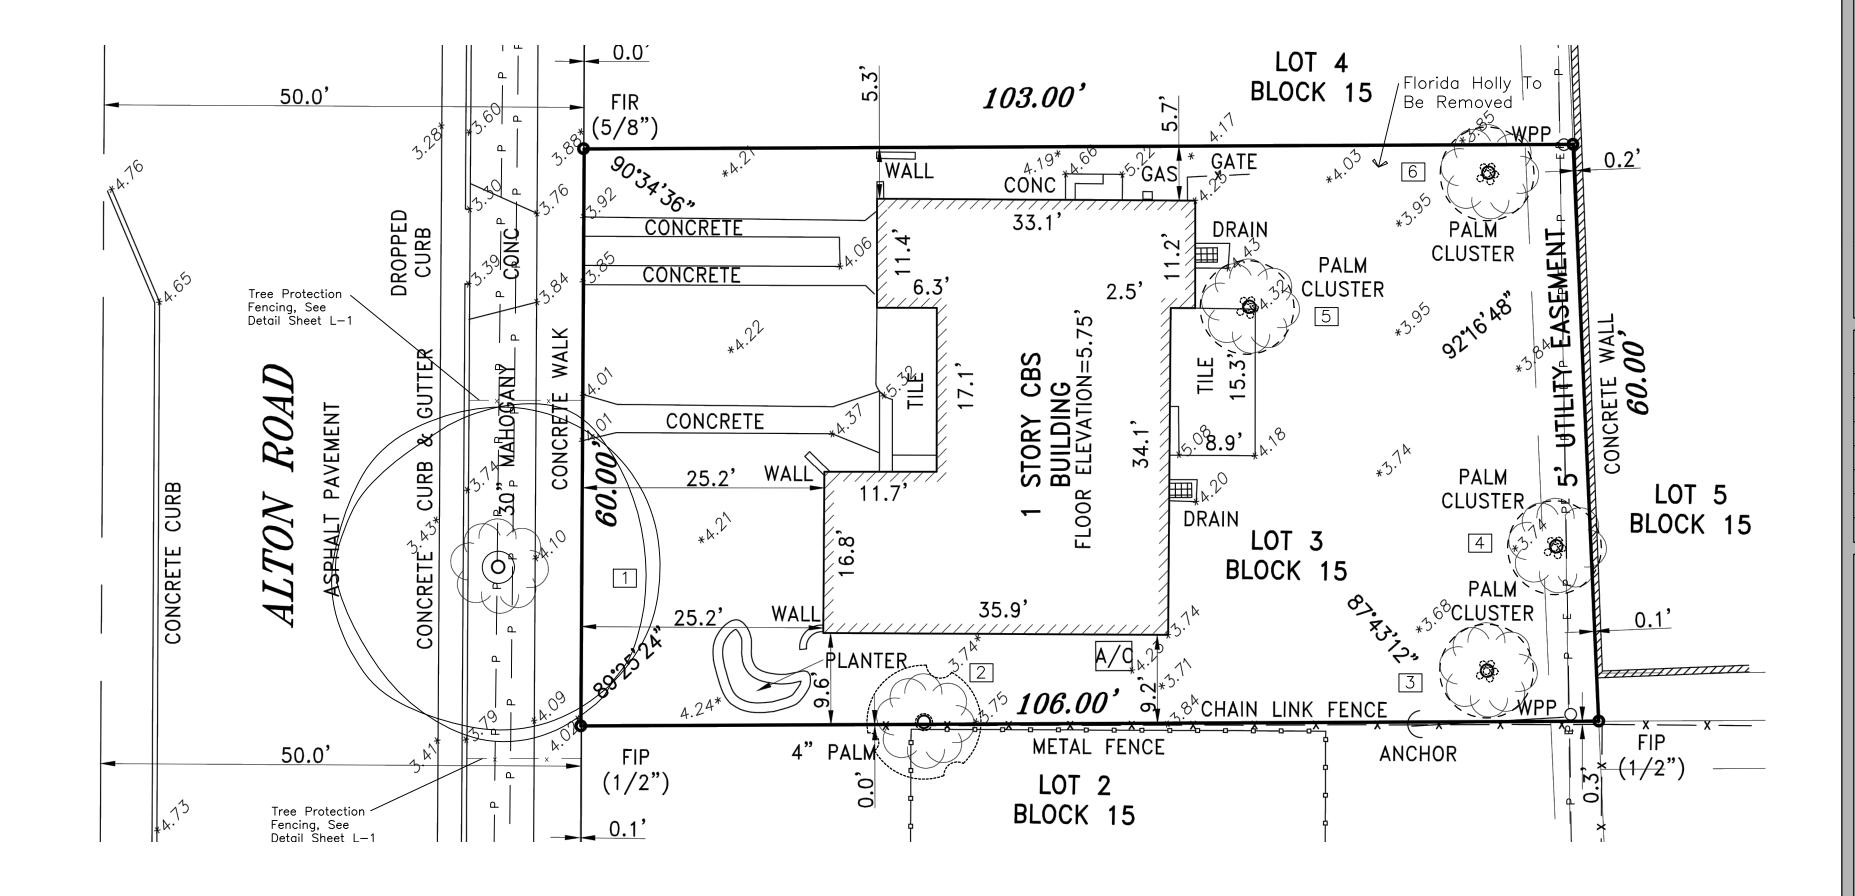



<b>Existing Tre</b>	e List														
Guide for Plant Ap	opraisal, 9th Edition														
	4625 Alton Road, Miami Beach, FL														
	2: 12/10/2020														
	r: Thomas White, ASLA-ISA														
Appraiser	Landscape Architect #LA1100 / ISA A	rhorist F	- -1 -524	<b>Q</b> Δ											
Tree #	Species		1	Class	Rating %	=	X DBH Caliper	V	(Condition)	Condition %		Caliper	Poplacoment	Recommendatio	n
1166 #	(Botanical Name / Common Name)		σpi.	Class	nating /6		(In Inches)	^	(Condition)	Condition //	-	Removed	Value	necommendatio	111
	(Botanical Name / Common Name)						(III IIICHES)					Removed	(\$65 per Inch)		
1	Swietenia mahogani / Mahogany	20'	30'	А	100	1.00	30		** Very Poor	6%		0.00	\$0	To Remain Off-Site TR	BD by City of Miami Beach
I	Swieterila manogani / Manogany	20	30	^	100	1.00	30	-	··· very Poor	0 /6		0.00	\$0	TO Herriain. Oil-Site 1D	by City of Miami Deach
**	Major Trunk Wounds and Severe Hatracking	via Utility	y Line C	L Claerance Trir	nming							0.00	ΨΟ		
Condition:															
	Specimen			100-80	%										
	Good-Healthy			79-60	%										
	Fair			59-40	%			Ca	liper Remove	d Formula = Ra	ating	% x DBH C	aliper x Condition	on %.	
	Poor			39-20	%			Re	olacement Va	lue Formula =	DBH	Caliper Inc	hes x \$65.		
	Very Poor			19-1	%										
	Dead-Cull			0											
Class	A			100%											
	В			80%											
	С			60%											
	D			40%											
Existing Pal	m List					Appra	aised Value = {Ba	asic	Tree Cost (B	⊥ ase Value) x Sr	ecie	s % x Condi	tion % x Location	 on %}	
	st Method per CTLA 9th Edition (pgs. 68-	60)					(					- /- //			
replacement ous	it wellow per OTEA attribution (pgs. 06-	03)							#1	#2	7	#3	#4	#5 (#1 x2x3x4)	
Palm	Species	Heigl	ht	Class	Rating %	=	DBH Caliper		Palm CT	Installation	(	Condition	Location	Final	Recommendation
#	(Botanical Name / Common Name)				J .		(In Inches)		(In Feet)	Cost		%	(Residential)	Value	
2	Ptychosperma elegans / Solitaire Palm	13		D	40	0.40	3		10	\$85		12%	0.4	\$41	To Be Removed
3	Dypsis lutescens / Areca Palm	10		D	40	0.40	10		6	\$85		22%	0.4	\$45	To Be Removed
4	Dypsis lutescens / Areca Palm	12		D	40	0.40	10		8	\$85		24%	0.4	\$65	To Be Removed
5	Dypsis lutescens / Areca Palm	14		D	40	0.40	10		10	\$85		22%	0.4	\$75	To Be Removed
6	Dypsis lutescens / Areca Palm	14		D	40	0.40	10		10	\$85		22%	0.4	\$75	To Be Removed
														\$301	TOTAL

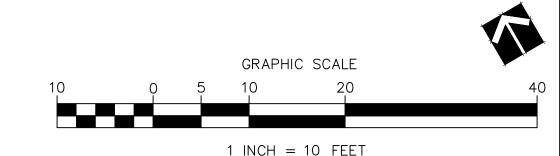

THOMAS WHITE, ASLA—ISA
LANDSCAPE ARCHITECT, LEED GREEN
ASSOCIATE, CERTIFIED ARBORIST
2600 NE 27th AVENUE
FORT LAUDERDALE, FLORIDA 33306
tcawhite@bellsouth.net
954-253-2265

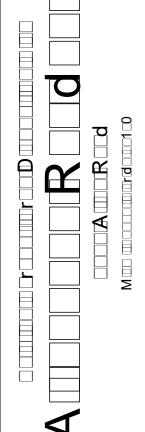

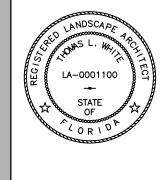

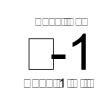

**K9Grass Lite or Classic** 1.1 DESCRIPTION OF WORK

The contractor shall provide all labor, materials, equipment, and tools necessary for the complete installation of a "no infill" synthetic grass dog surface with a stable draining base. The complete synthetic grass system shall consist of, but not necessarily be limited to the following:

A. Area of construction with the extent of artificial turf work as shown on the drawings.

Subgrade, base, and drainage construction as specified in Section 2 and Section 3 of this document. C. Quality synthetic grass product manufactured in the USA according to specifications in Section 2 of this document. Product shall be a knitted synthetic grass product (not tufted) and contain an antimicrobial agent while meeting or exceeding all guidelines as established herein. For characteristics not specifically stated, shall meet or exceed all guidelines published by the Synthetic Turf Council.

D. The synthetic grass surface shall be specifically designed, manufactured, and installed for the intended use as a commercial/residential use dog surfacing solution.

E. Plastic perimeter boards ("2x4" or "2x2" set vertically) are to surround the entire area for anchoring of the turf. The top edge of this surface is to be a minimum of 1/2" below any adjacent solid walking surfaces where there could be foot traffic.

F. Stainless steel staples, 1" in length, are to be used to anchor the synthetic turf to the perimeter boards.

Contractor shall ensure that products for pet/dog system meet the following performance requirements: F. The components, as well as the installation methods utilized, shall be designed and executed in a manner to hold up to the unique challenges dogs present. The materials as hereinafter specified shall withstand full climatic exposure in the location of the play yard/dog run, be resistant to insect infestation, rot, fungus, mold and mildew, shall also withstand ultra-violet rays, and allow the free flow of water vertically through the surface and into the drainage below.

G. The seams of all system components shall provide a permanent, tight, secure, and hazard free surface. The installed synthetic grass and drainage system shall allow for drainage and water flow through the system at a rate of not less than 800" per hour.

#### 1.3 SERVICE AND QUALITY ASSURANCE

Synthetic grass vendor shall provide ongoing service, quality assurance, and warranty, consisting of, but not necessarily be

A. The synthetic grass vendor must provide competent workmen skilled in this type of dog surface installation. The

synthetic grass vendor shall provide a qualified installation foreman to coordinate and review the component parts of the synthetic grass system. Foreman shall be introduced to owner or owner's representative prior to start of construction. B. The synthetic grass vendor and installer must be experienced with no less than six completed commercial dog installations (2500sf or greater) where a knitted synthetic grass surface was installed. Installer must be competent in the installation of this material, including attachment of seams, proper trimming, and attaching techniques, prior to the start of turf installation.

C. The synthetic grass vendor shall submit its manufacturer's warranty, which warrants the synthetic grass product: Provide coverage of synthetic grass for a minimum of ten (10) years from the date of substantial completion.

Warrant that the materials installed meet or exceed the product specifications. Be from a single source (certified by manufacturer) covering workmanship and all materials.

IV. Assure the availability of exact or substantially the same replacement materials for the synthetic grass system for the full warranty period.

V. Include general wear and damage caused by UV degradation. The warranty may specifically exclude vandalism and Acts of God beyond the control of the manufacturer or installer.

Synthetic grass vendor must submit the following to owner or owner's representative with the official bid package: One (1) copy of the most recent installation reference list for projects of similar scope to this project completed in

 Synthetic grass: ForeverLawn K9Grass Lite or Classic or Landscape Architect approved equal. Pile Weight: 72 oz. /sy.

Face Yarn Type: Primary: Polyethylene; Secondary: Heat set textured nylon monofilament containing antimicrobial agent Yarn Count: Primary 5,000/4; Secondary: 4,200/8

Pile Height (knitted): 7/8" (+/- 1/8). Color: Primary: Summer Green; Secondary: Turf green

Construction: Knitted

Antimicrobial Protection: AlphaSan (manufactured into yarn)

Tufting Gauge: N/A - knitted product Backing: Flow-through knitted backing

Seaming: Turf adhesive

Total Product Weight: 87 oz. /sy. Finished Roll Width: 15 ft. (4.6 m)

Finished Roll Length: Up to 150 ft. (45.72 m)

The synthetic grass shall be delivered in 15-foot-wide rolls. The rolls will be laid out and installed as specified in the site layout and equipment placement drawings. II. All seams shall be installed and secured with approved turf adhesive. Seams secured with stitching alone shall not be

III. No infill material is to be used.

B. Base and Attaching Components: Base is to be prepared using plastic "2x4" or 2x2" plastic board and secured using 1" length 1/4" crown stainless steel staples. Turf is to be secured around all edges.

#### **3 EXECUTION**

3.1 BASE AND DRAINAGE CONSTRUCTION

The synthetic grass base contractor shall strictly adhere to the installation procedures outlined under this section. Any variance from these requirements must be accepted in writing, by the synthetic grass vendor, and submitted to the owner or owner's representative, verifying that the changes do not adversely affect the performance or warranty.

shall also be compacted to a recommended 90% compaction rate. B. Plastic Nailer Board: The synthetic turf perimeter fastening structure shall be installed before the drainage aggregate. Install a synthetic nailer board around perimeter and all penetrating objects. Nailer board shall be flush to grade (or

A. Excavation: Existing ground cover shall be excavated to the depth established on the excavation plan. The sub-grade

as specified in site detail drawings) when adjacent to soft surface (i.e. natural grass, mulch). Nailer board shall be 1/2" to 3/4" below grade when adjacent to hard walking surface (i.e. concrete or tile). II. This shall be the responsibility of the synthetic turf base contractor. See synthetic turf edge attachment detail.

C. Base Drainage Aggregate: Installation of the free draining base aggregate of 3/8" to 5/8" clean compactable angular stone (any mix with fines in excess of 20% must be approved by manufacturer), shall follow procedures provided. If the sub-base does not permit liquids to freely percolate, auxiliary drainage is required. Base material must be installed to a recommended depth of 3 1/2". The drainage network and its existing elevations shall not be disrupted through ground pressures from trucks, dozers, or by any other means.

The stone shall be left firm and compacted while allowing the porosity and drainage capabilities of the aggregate profile.

I. The free draining base course should be designed to meet local soil and weather conditions. It must be installed to a minimum depth of  $3 \frac{1}{2}$  with a recommended compaction rate of 90%.

#### 3.2 SYNTHETIC GRASS SYSTEM INSTALLATION

After a final inspection of the stone base by the synthetic grass contractor and the owner's representative, the synthetic turf installation shall begin. The synthetic grass product shall be delivered in 15-foot-wide rolls. A. Synthetic grass rolls shall be joined via adhesive bond seaming and reinforced with specialty turf adhesive where

necessary.

Seams shall be flat, tight, and permanent with no separation or fraying.

Grass rolls must be installed with pile leaning the same direction. Synthetic Turf Perimeter Attachment:

After final layout and seaming of the synthetic grass product, the synthetic turf material shall at a minimum be secured to the top of plastic nailer board firmly anchored to sidewalk, curb, wall, or by rebar making up the perimeter of the synthetic turf area.

The turf shall be attached to plastic nailer board by stainless steel staples, screws, and/or nails. III. Soil or surfacing material outside of the defined synthetic turf area shall be backfilled against turf wrapped perimeter edge and have zero transition edge to synthetic turf unless otherwise specified.

Concrete and solid walking surfaces should be 1/2" to 3/4" higher than the top of the board. C. Infill Application: It is imperative that no infill is utilized with synthetic turf used with dogs.


A. The synthetic grass vendor must verify that a qualified representative has inspected the installation and that the finished surface conforms to the manufacturer's requirements.

B. Extra materials: Owner shall be given the option to retain and store excess materials such as excess turf left over from the project.


#### 3.4 CLEAN UP

Contractor shall provide the labor, supplies, and equipment as necessary for final cleaning of surfaces and installed B. During the contract and at intervals as directed by the owner or owner's representative and as synthetic grass system


installation is completed, clear the site of all extraneous materials, rubbish, or debris, and leave the site in a clean, safe, well-draining, neat condition. C. Surfaces, recesses, enclosures, etc. shall be cleaned as necessary to leave the work area in a clean, immaculate condition ready for immediate occupancy and use by the owner

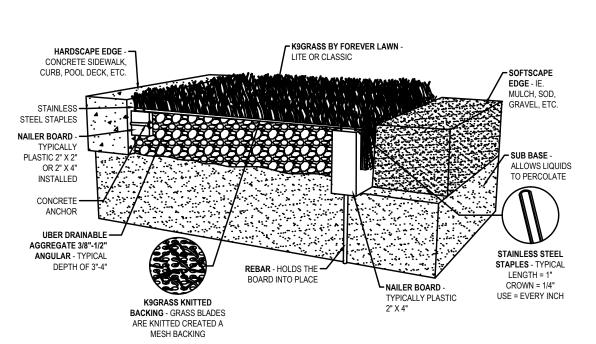

### ARTIFICIAL TURF DETAIL

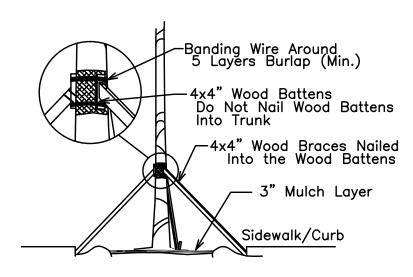


### DATE PALM BRACING DETAIL

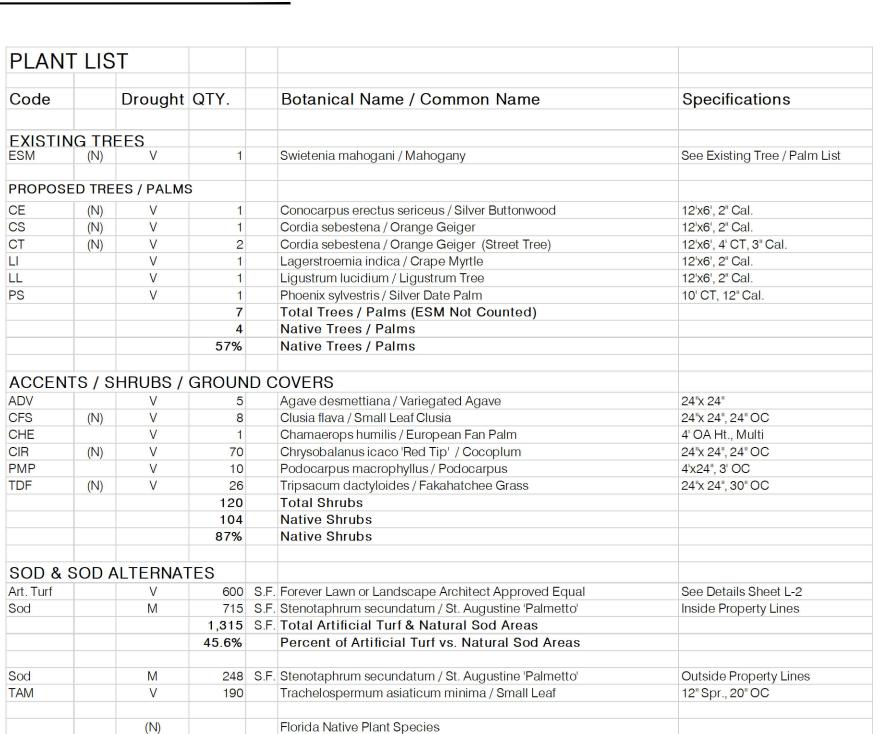


Moderate Drought Tolerance

Very Drought Tolerant


	Zoning:	RS-4			Lot Area	0.14	Acres	6,300.00	s.f.		
	8	Res Low Ris	e, Med Dens	ity				,			
	OPEN SPACE			V					REQUIRED	PROVIDED	
Α.	Square feet of require	red Open Spac	ce as indicate	ed on site plan:							
	Lot area =	6,300.00	s.f. x	25	% =	1,575.00	s.f.		1,575.00	2,932.00	
	LAWN AREA C	ALCULAT	TION								
١.	Totals.f. of lands ca	ped open spa	ce required b	y Miami 21					1,575.00	2,932.00	
В.	Maximum lawn area			50	% x	2,932.00	s.f. =	50%	1,466.00	1,455	50%
	TREES										
Α.	No. trees required per net lot acre  less existing number of trees meeting minimum requirements =								3		
	less existing number	of trees meet	trees x	0.14	acreas =				3	3	
3.	% of palms allowed	(two palms =	one tree): Nu	mber of trees p	provided x 30% =			30%	2	0	0%
C.	% natives required:	Number of tre	es provided	x 30% =				30%	2	5	71%
<b>).</b>	% Drought Tolerand	e and Low M	aintenance: ]	Number of tree	s provided x 50% =			50%	4	7	100%
Ξ.	Street trees (maximu										
	0	linear feet ald	ong street / 3	0 =					0	0	
	% of Palms permitte	is x30%				0	0				
F.											
	60	linear feet ald	ong street / 2	5 =					2	2	
	Total number of tree	s required =							5	7	
	<u>SHRUBS</u>										
١.	Number of shrubs re	quired: Numb	er of shrubs	required x 10					50	118	
3.	% Native of shrubs	required: Nun	ber of shrub	s provided x 50	)% =			50%	25	104	88%
	% Drought Toloran	e and Low M	aintenance:	Number of shr	ıbs provided x 50%	=		50%	25	118	100%

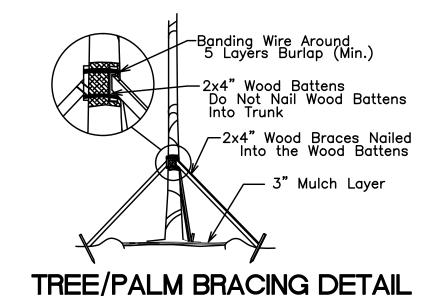

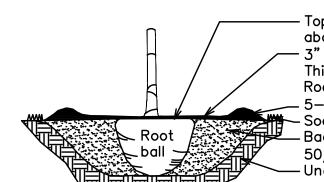


Top of root ball 1" above landscape soil. - 3" Mulch Layer, 1" Thick Against Trunk And Root Flare. .5-6" Mulch Water Rina. ₩ Sod Where Applicable. Backfill with Tilled in 50/50 Topsoil/Sand. -Undisturbed Earth.

TREE/PALM PLANTING DETAIL

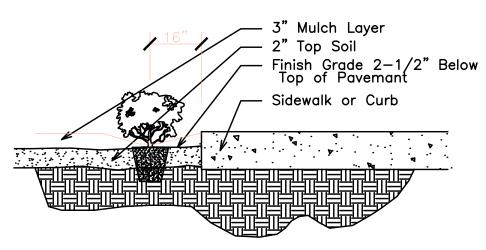


SHRUB INSTALLATION DETAIL

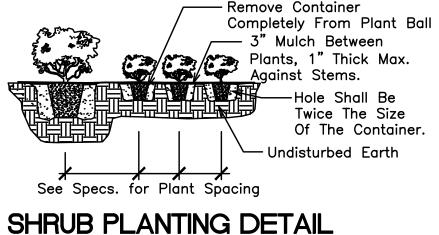


	Current Land Use	Res Low Rise, Med Density				
	Gross Site Area:	6,300	Sq. Feet	=	0.14	Acre
ner.	Building Area:	1,919	Sq. Feet	=	30.5%	
	Driveways / Walkways / Patios	1,449	Sq. Feet	=	205.4%	
	Total Impervious Areas:	3,368	Sq. Feet	=	53.5%	
	Total Pervious/Landscape Area:	2,932	Sq. Feet	=	46.5%	

Current Zoning Designation: RS-4


SITE PLAN INFORMATION

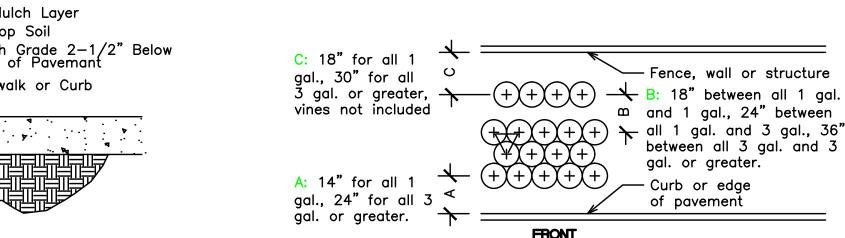



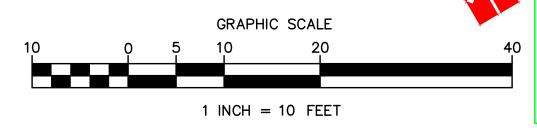



R12-29-2020: Per City Comments
3-27-2021: Per Front Retaining Walls

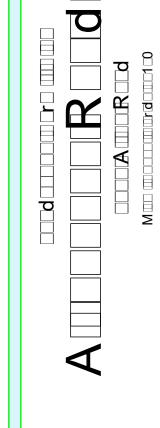



 $\mathsf{DRA} \square \square$  $\mathsf{DA}\square\square\square$ 1 □- □- □0 □0

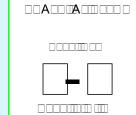

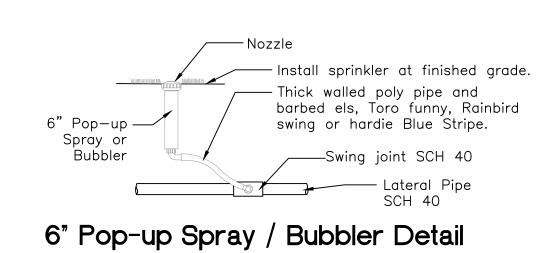

## IRRIGATION LEGEND:

3" MAIN LINE

CONTROLLER — Intermatic Electric 2 station controller.

Mini Clik automatic rain sensor shutoff switch mounted outside on eave of structure.

ZONE VALVES — Fimco 2 Station Indexing Valve.

Sch. 40, 2 Sizes Larger. NOTE - Pipe Size Shown is the Lateral Size, NOT the Sleeve Size

> 6" POP-UP SPRAY -Hunter MP Rotator Series: Nozzles as Required.


LATERAL ZONE LINES.


NOTE — All of the below may not be used

		13-21'	8-15'	6-12
0.0		Series	Series	Series
90	Q			
120	T	$\Diamond$	$\bigcirc$	A
180	Н	Ď	D	В
240	TT	$\supset$	D	$\mathcal{A}$
270	TQ	$\bigcirc$	5	Ш
360	F	$\tilde{\oslash}$		$\blacksquare$

SS-530 5 x 30'

**■** ES-515 5 x 15'

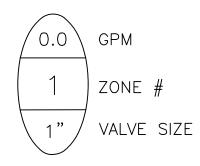

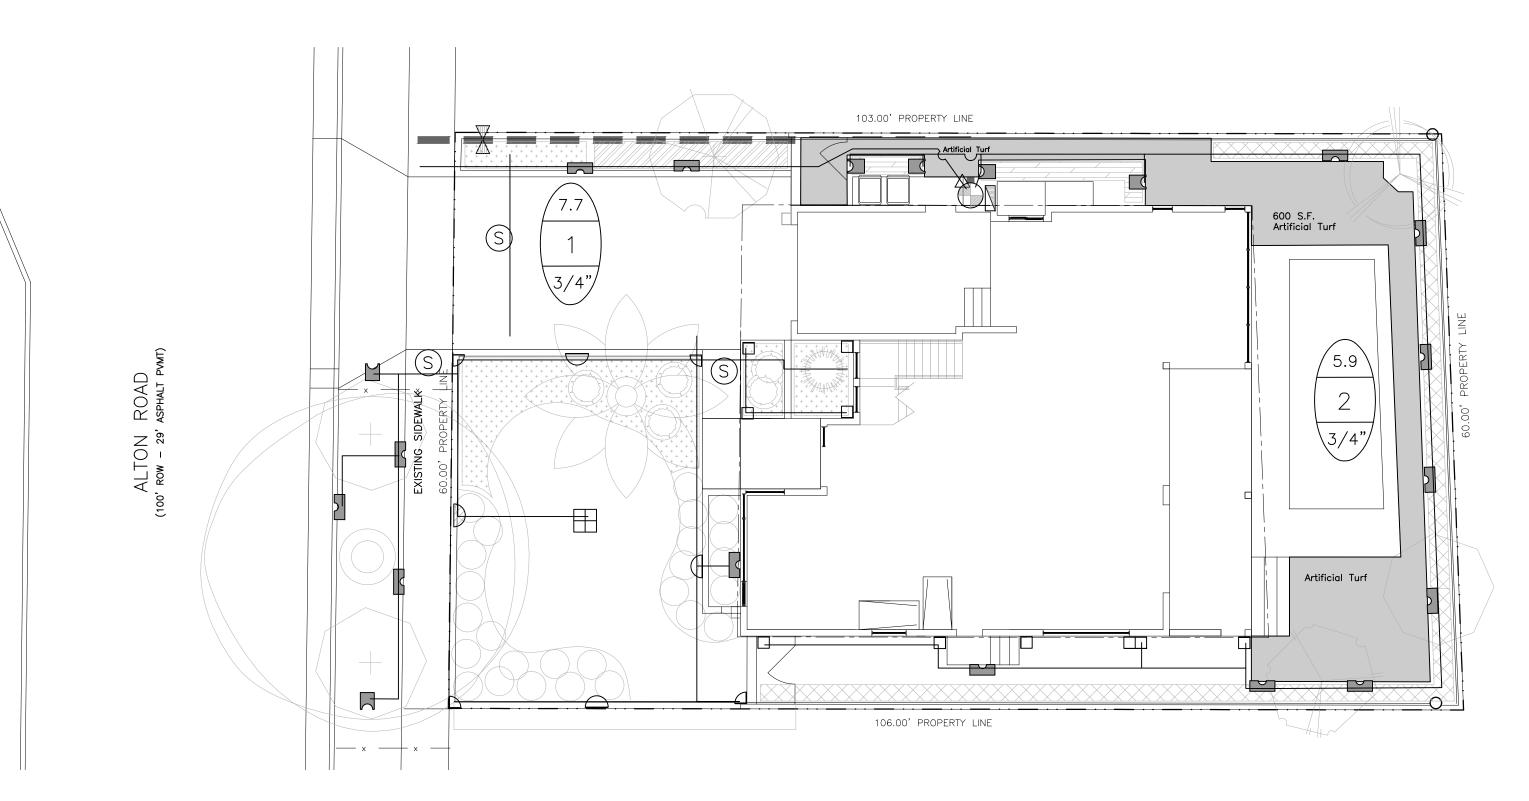

#### IRRIGATION NOTES:

Main Lines: PVC SCH 40 Solvent Weld. Zone Lines: PVC SCH 40 Solvent Weld. 1/2 in. is not used. Min. pipe is 3/4 in. All end of the line unmarked pipe = 3/4 in. (min.). Sleeves and suction Line: PVC SCH 40.

Fittings: SCH 40 PVC

Fabrication: To manufacturers specifications. Use blue or grey PVC cement, square cut, clean and prime all joints.

Allow all main lines to cure for 24 hours before pressuring.

All pipe, fittings, and solvents to conform to latest ASTM specs.

Depth of Lines: Main Line and wiring = 18 in. depth, min. Sleeving under pavement = 24 in. depth, min.

Suction Line = 24 in. depth, nominal. Zone Lines 1-1/2 in. and smaller = 10 in. depth, min.

Control Wires: AWG 14 for all hot wires and AWG 12 for common. Solid copper type UF UL listed for direct burial.

Run wires under main. Run spares, two min.

Splice wires only in a valve box. All splices shall be moisture proof using Snap

tite or DBY UL connectors.


Common shall be white, hot shall be red or color coded Spare shall be black. Run all wires in Grey Electrical SCH 40 conduit..

Backfill all trenches free of debris, compact to original density, flush all lines, use screens in all heads, adjust heads for proper coverage avoiding excess water on walls, walks, etc.

All details are graphically shown only. All quantities shall be verified by the contractor prior to installation. It shall be the contractors responsibility to assure complete overlapping coverage. Any discrepancies shall be reported to the owner and landscape architect before proceeding. Codes and local regulations shall take precedence over these plans, it is the contractors responsibility to comply. The landscape architect reserves the right to make minor field changes, the contractor may field adjust spray nozzle selection to provide for proper 100% min. coverage.

Provide owner with an accurate as installed plan(s) at completion showing main lines, wiring, valves, crossings, etc. using dimensions from fixed datums.

Contractor shall verify all underground utilities prior to commencement of work.

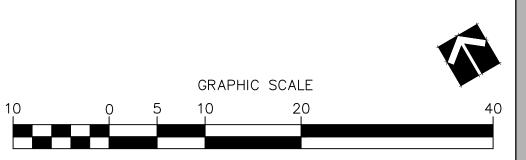

1 INCH = 10 FEET

