# FINAL DRB SUBMITTAL DECEMBER 7, 2020

REQUEST FOR DRB APPROVAL FOR: 6342-6360 NORTH BAY ROAD MIAMI BEACH, FLORIDA 33141 DRB CASE FILE #DRB20-0614

#### SCOPE OF WORK

#### PROJECT SCOPE:

ADD NEW ACCESSORY GAME COURTS, CABANA AND SMALL STORAGE ROOM FOR AN EXISTING SINGLE-FAMILY HOME

#### **REQUESTED VARIANCES:**

- 1. VARIANCE TO ALLOW 8'-0" SOUTH SIDE YARD SETBACK WHERE 41'-2 1/2" IS REQUIRED TO ALLOW 18' TALL TENNIS COURT LIGHTS.
- 2. VARIANCE TO ALLOW FOR A SUM OF THE SIDE YARD SETBACKS OF 23'-3" VERSUS A REQUIRED SUM OF SIDE SETBACKS OF 56'-5 1/2" TO ALLOW TENNIS COURT LIGHTING.
- 3. REQUEST FOR A VARIANCE TO ALLOW FOR THE CONSTRUCTION OF A NEW OUTDOOR STORAGE UNIT AT THE NORTH CORNER OF THE EXISTING 2 STORY RESIDENCE AT EXISTING SETBACK OF 15'-3".

6342/6360 NBR

MIAMI BEACH, FL

SITE ADDRESS:

6342 AND 6360 NORTH BAY ROAD MIAMI BEACH, FL 33141

TEAM:

LANDSCAPE ARCHITECT:

CLAD 1160 NE 86th STREET MIAMI, FL 33138

ARCHITECT:

CFZ DESIGN (239) 898-754

SEAL:

Carolina Digitally signed by Carolina Monteiro Date: 2020.12.07 10:23:18-05'00'

FOR THE FIRM: CLAD, LLC LC26000587 1160 NE 86th STREET, MIAMI, FL 33138 Carolina Monteiro da Silva LA6667311

DRAWING TITLE


**COVER SHEET** 

REVISIONS

SSUE: DATE:
PRE-DRB SUBMITTAL 11/16/20
FINAL DRB SUBMITTAL 12/07/20

CCALEINTS

PROJ NO: 2026 SHEET NO:

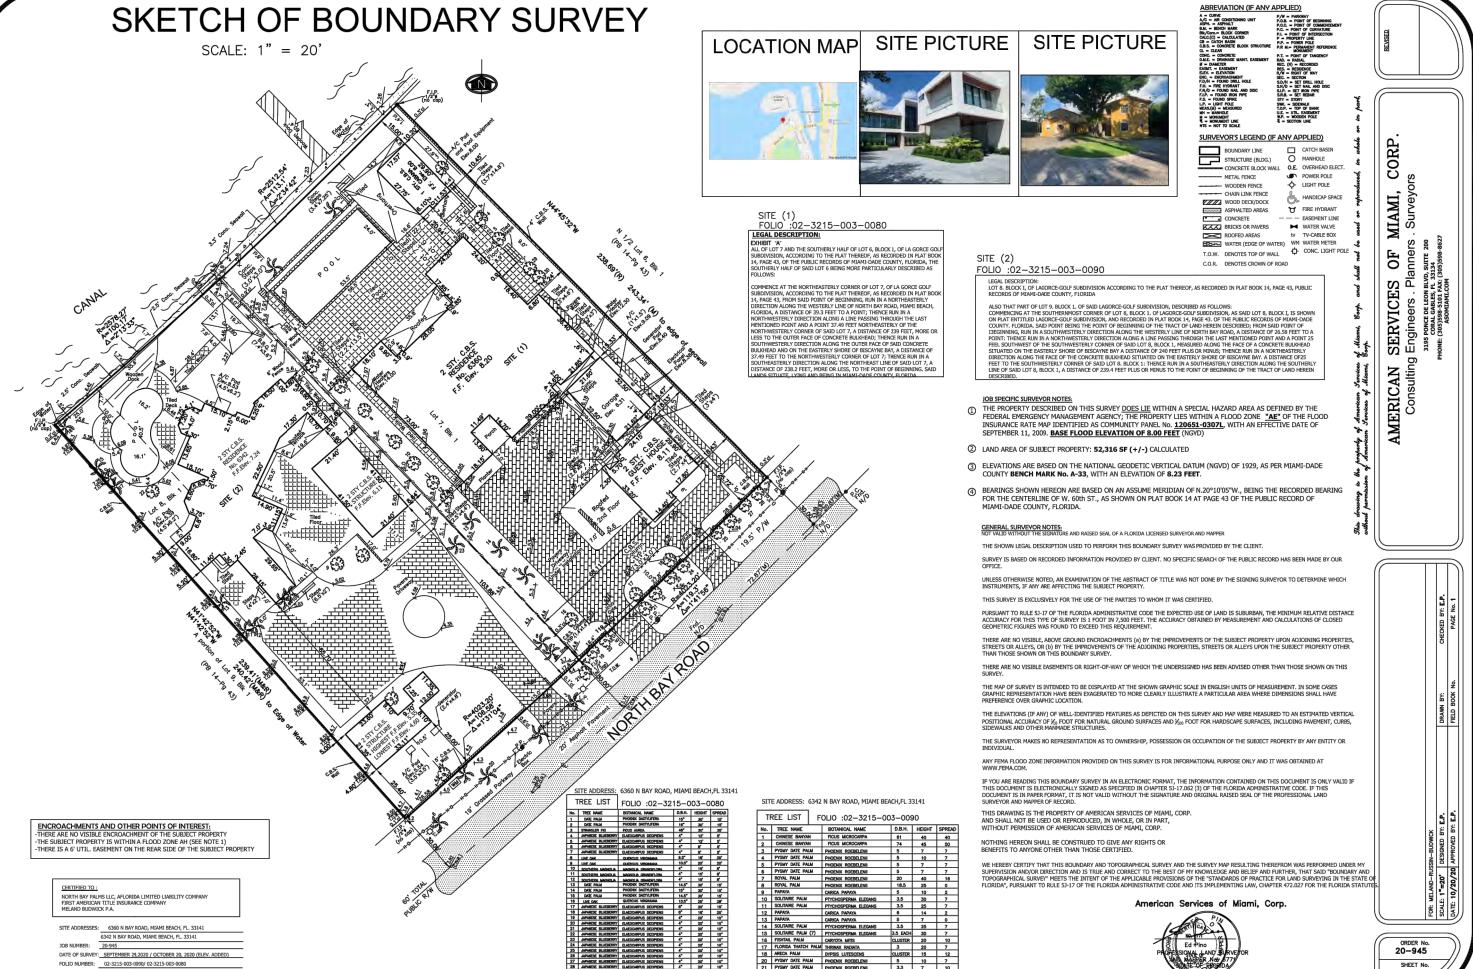


DATE: OCTOBER 20, 2020

		<b>X</b> = SHEET S	X = SHEET SUBMITTED •= :			
		PRE-DR SUBMITT		FINAL DRB SUBMITTAL		
SHEET#		11/16/20		12/07	/2020	
L-000	COVER SHEET	X		Х	•	
	SITE SURVEY (BY OTHERS)			Х		
L-001	SITE MAP AND SHEET INDEX	X		Х	•	
L-002	ZONING DATA TABLE	X		Χ	•	
L-003	EXISTING SITE CONDITIONS	Х		Х		
L-004	NEIGHBORHOOD CONTEXT	Х		Х		
L-005	NEIGHBORHOOD CONTEXT	X		Х		
L-100	TREE DISPOSITION PLAN	X		Х		
L-101	TREE DISPOSITION SCHEDULE			Χ		
L-102	TREE MITIGATION PLAN	X		Χ		
L-103	TREE MITIGATION SCHEDULE	х		Х		
	T					
L-200	ILLUSTRATIVE OVERALL SITE PLAN	X		X	•	
L-202	HARDSCAPE DIMENSION PLAN	X		Х	•	
L-203	VARIANCE DIAGRAM	x		Х	•	
L-300	FRONT LANDSCAPE ELEVATION			Х		
L-301	LANDSCAPE SITE SECTION			X		
L-30 i	EANDSCA E SITE SECTION					
L-500	CANOPY PLANTING PLAN	x		Х	•	
L-501	UNDERSTORY PLANTING PLAN	X		X		
L-502	PLANTING SCHEDULE AND LANDSCAPE LEGEND	X		X		
L-503	OPEN SPACE DIAGRAM	X		Х		
L-504	PLANTING DETAILS			X		
L-004	PLANTING IMAGES	x		X	•	
	I EAVIING IIVAGEO					
A-001	ZONING DIAGRAMS - LOT COVERAGE	х		Х	•	
A-001.2	ZONING DIAGRAMS - UNIT SIZE			Х		
A-002	PROPOSED FRONT AND REAR YARD	x		X		
A-050	AXONOMETRIC	X		X		
A-051	RENDERING - N BAY ROAD VIEW	X		X	•	
A-052	RENDERING - STREET VIEW	x		X	•	
A-053	AERIAL RENDER			X		
A-060	DEMOLITION PLAN			X		
74000	DEMOCITICATE EAT					
A-100	SITE PLAN	Х		Х	•	
A-200	ENLARGED GROUND FLOOR PLAN	X		Х	•	
A-201	ENLARGED GROUND FLOOR PLAN	x		Х	•	
A-300	ROOF PLAN			х		
74300	NOO! 1 EAV					
A-500	ELEVATIONS	X		Х	•	
A-501	ELEVATIONS	х		Х	•	
A-502	ELEVATIONS	х		Х	•	
				.,	Ī	
A-600	SECTION OF CABANA	X		Х	•	
A-801	MATERIAL BOARD			Х		
A-801.2	MATERIAL BOARD			Х		
A-900	PHOTOMETRICS			Х		
A-901	LIGHTING			Χ		
A-902	LIGHTING			Х		
A-903	LIGHTING			Х		
A-904	LIGHTING			Х		
SHEET	INDEX					



LOCATION MAP 6342/6360 NORTH BAY ROAD MIAMI BEACH, FLORIDA 33141

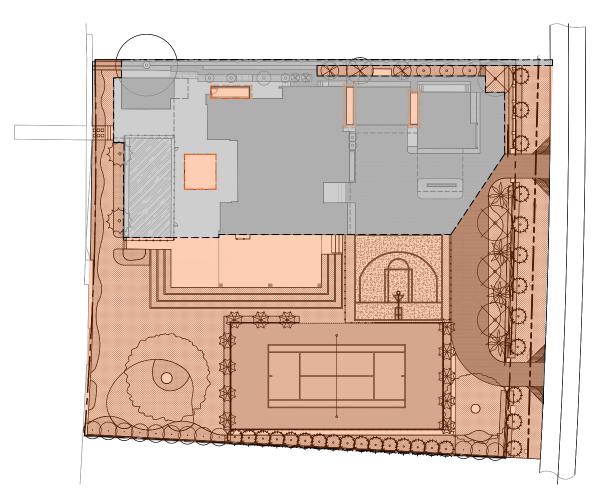

SCOPE OF WORK DIAGRAM

SCOPE OF WORK

NOTE IN SCOPE

6342/6360 NBR

MIAMI BEACH, FL

SITE ADDRESS:

6342 AND 6360 NORTH BAY ROAD MIAMI BEACH, FL 33141

LANDSCAPE ARCHITECT:

ARCHITECT:

Carolina Digitally signed by Carolina Monteiro Date: 2020.12.07 10:26:25 -05'00'

DRAWING TITLE:

SITE MAP AND SHEET INDEX

| ISSUE: DATE: | PRE-DRB SUBMITTAL | 11/16/20 | FINAL DRB SUBMITTAL | 12/07/20 |

PROJ NO: 2026 SHEET NO:

### SINGLE FAMILY RESIDENTIAL - ZONING DATA SHEET

ITEM #	Zoning Information								
1	Address:	6342 North Bay Road & 6	360 North Bay Road						
2	Folio number(s):	02-3215-003-0090 & 02-3215-003-0080							
3	Board and file numbers :	DRB20-0614							
4	Year built:	1935 & 2018	Zoning District: RS-2						
5	Based Flood Elevation:	8 NGVD	Grade value in NGVD		3.73 NGVD				
5	Adjusted grade (Flood+Grade/2):	5.85 NGVD	Free board:						
7	Lot Area:	52,316 SF							
3	Lot width:	225'-10 1/4"	Lot Depth:		239'-5" FT				
9	Max Lot Coverage SF and %:	15,694.8 SF (30%)	Proposed Lot Coverage	ge SF and %:	11,042 S.F. (21.1%)				
10	Existing Lot Coverage SF and %:	9,580 S.F. (34.6%)	Lot coverage deducte	d (garage-storage) SF:	10,542 S.F. (20.1%)				
11	Front Yard Open Space SF and %:	2,511 S.F. 55.7%	Rear Yard Open Space	e SF and %:	6,064 S.F. (78.8%)				
12	Max Unit Size SF and %:	26,158 S.F.	Proposed Unit Size SF	and %:	14,010 S.F. (26.7%)				
13	Existing First Floor Unit Size:	7,317 SF (26.4%)	Proposed First Floor L	Jnit Size:	7,872 SF (15.0%)				
14	Existing Second Floor Unit Size	6,138 S.F. (22.1%)	Proposed Second Floo % (Note: to exceed 70 main home require D Proposed Second Floo	NO NEW WORK WAS ADDED TO CHANGE EXISITING CONDITIONS					
16			Proposed Roof Deck A Maximum is 25% of t immediately below):	NO NEW WORK WAS ADDED TO CHANGE EXISITING CONDITION					
		Required	Existing	Proposed	Deficiencies				
17	Height:								
18	Setbacks:		Logarity Company						
19	Front level:	20 FT	21'-8"	21'-8"					
21	Side North:	Remainder of 25% of lot width	15'-3"	15'-3"					
22	Side South:	41'-2 1/2"	118'-4 1/2"	87'-9 3/4"	8'-0" (TENNIS COURT LIGHTS ONLY)				
23	Rear:	35-11" FT	62'-11"	62'-11°					
	Accessory Structure Side 1:								
24	Accessory Structure Side 2 or (facing street):		10'-1"	10'-1"					
25	Accessory Structure Rear:		15'-8"	15'-8"					
26	Sum of Side yard :	56'-5 1/2" FT.	134' -0 3/4"	103'-0" - 3/4"	23'-3" (FOR TENNIS COURT ONLY)				
27	Located within a Local Historic District?			NO					
28	Designated as an individual Historic Sing	le Family Residence Site?		NO					
29	Determined to be Architecturally Signific			NO					

### Notes:

If not applicable write N/A

All other data information should be presented like the above format

	Required	Existing	Proposed	Deficiencie
Tennis Court Setbacks:				
Side	7.5'		7 <sup>1</sup> -5 <sup>n</sup>	
Rear	7.5'		82'-7-1/4"	
Tennis Light fixtures:				
Side	41'-2 1/2"		8'-0"	33'-2"

6342/6360 NBR

MIAMI BEACH, FL

SITE ADDRESS:

6342 AND 6360 NORTH BAY ROAD MIAMI BEACH, FL 33141

TEAM:

LANDSCAPE ARCHITECT:

ARCHITECT:

CFZ DESIGN (239) 898-7549

Carolina Digitally signed by Carolina Monteiro Date: 2020.12.07 10:27:56-05'00'

FOR THE FIRMS CLAD, LLC LC26000SB7 1160 NE 86th STREET, MLAM, FL 33138 Carolina Montairo da Siliva LA6667311

DRAWING TITLE:

ZONING DATA TABLE

 ISSUE:
 DATE:

 PRE-DRB SUBMITTAL
 11/16/20

 FINAL DRB SUBMITTAL
 12/07/20

PROJ NO: 2026 SHEET NO:

## 6342 NORTH BAY ROAD



FRONT



MIDDLE



6360 NORTH BAY ROAD



FRONT



MIDDLE



REAR

# 6342/6360 NBR

#### MIAMI BEACH, FL

SITE ADDRESS: 6342 AND 6360 NORTH BAY ROAD MIAMI BEACH, FL 33141

# LANDSCAPE ARCHITECT:

### ARCHITECT:

# Carolina Digitally signed by Carolina Monteiro Date: 2020.12.07 10:30:30 -05'00'

#### DRAWING TITLE:

# EXISTING SITE CONDITIONS

ISSUE:	DATE:
PRE-DRB SUBMITTAL	11/16/2
FINAL DRB SUBMITTAL	12/07/2

PROJ NO: 2026 SHEET NO:



1. 6105 NORTH BAY ROAD



3. 6386 NORTH BAY ROAD



2. 6324 NORTH BAY ROAD



4. 6396 NORTH BAY ROAD



KEY PLAN

### MIAMI BEACH, FL

SITE ADDRESS:

6342 AND 6360 NORTH BAY ROAD MIAMI BEACH, FL 33141

EAM:

LANDSCAPE ARCHITECT:

CLAD 1160 NE 86th STREET MIAMI, FL 33138

(786) 253-7017 carolina.monteiro@clad-landscape.co

ARCHITECT:

CFZ DESIGN (239) 898-7549

SEAL:

Carolina Digitally signed by Carolina Monteiro Date: 2020.12.07 10:34:24 -05'00'

FOR THE FIRM:
CLAD, LLC
LC26000587
1160 NE 86th STREET,
MIAMI, FL 33138
Carolina Monteiro da Silva
LA6667311

DRAWING TITLE:

# NEIGHBORHOOD CONTEXT

TOTONG.

| ISSUE: DATE: | PRE-DRB SUBMITTAL | 11/16/20 | FINAL DRB SUBMITTAL | 12/07/20 |

CCALEINTC

PROJ NO: 2026 SHEET NO:



1. 6361 NORTH BAY ROAD



3. 6381 NORTH BAY ROAD



2. 6371 NORTH BAY ROAD



4. 6391 NORTH BAY ROAD



KEY PLAN

#### MIAMI BEACH, FL

SITE ADDRESS:

6342 AND 6360 NORTH BAY ROAD MIAMI BEACH, FL 33141

EAM:

LANDSCAPE ARCHITECT:

CLAD 1160 NE 86th STREET MIAMI, FL 33138

MIAMI, FL 33138 (786) 253-7017 carolina.monteiro@clad-landscape.c

ARCHITECT:

CFZ DESIGN (239) 898-7549

SEAL:

Carolina Digitally signed by Carolina Monteiro Date: 2020.12.07 10:38:33 - 05'00'

R THE FIRM:
AD, LLC
26000587
30 NE 86th STREET,
AMI, FL 33138
rollina Monteiro da Silva

DRAWING TITLE:


## NEIGHBORHOOD CONTEXT

NACTORIC

| ISSUE: DATE: | PRE-DRB SUBMITTAL | 11/16/20 | FINAL DRB SUBMITTAL | 12/07/20 |

CCALEINTC

PROJ NO: 2026 SHEET NO:

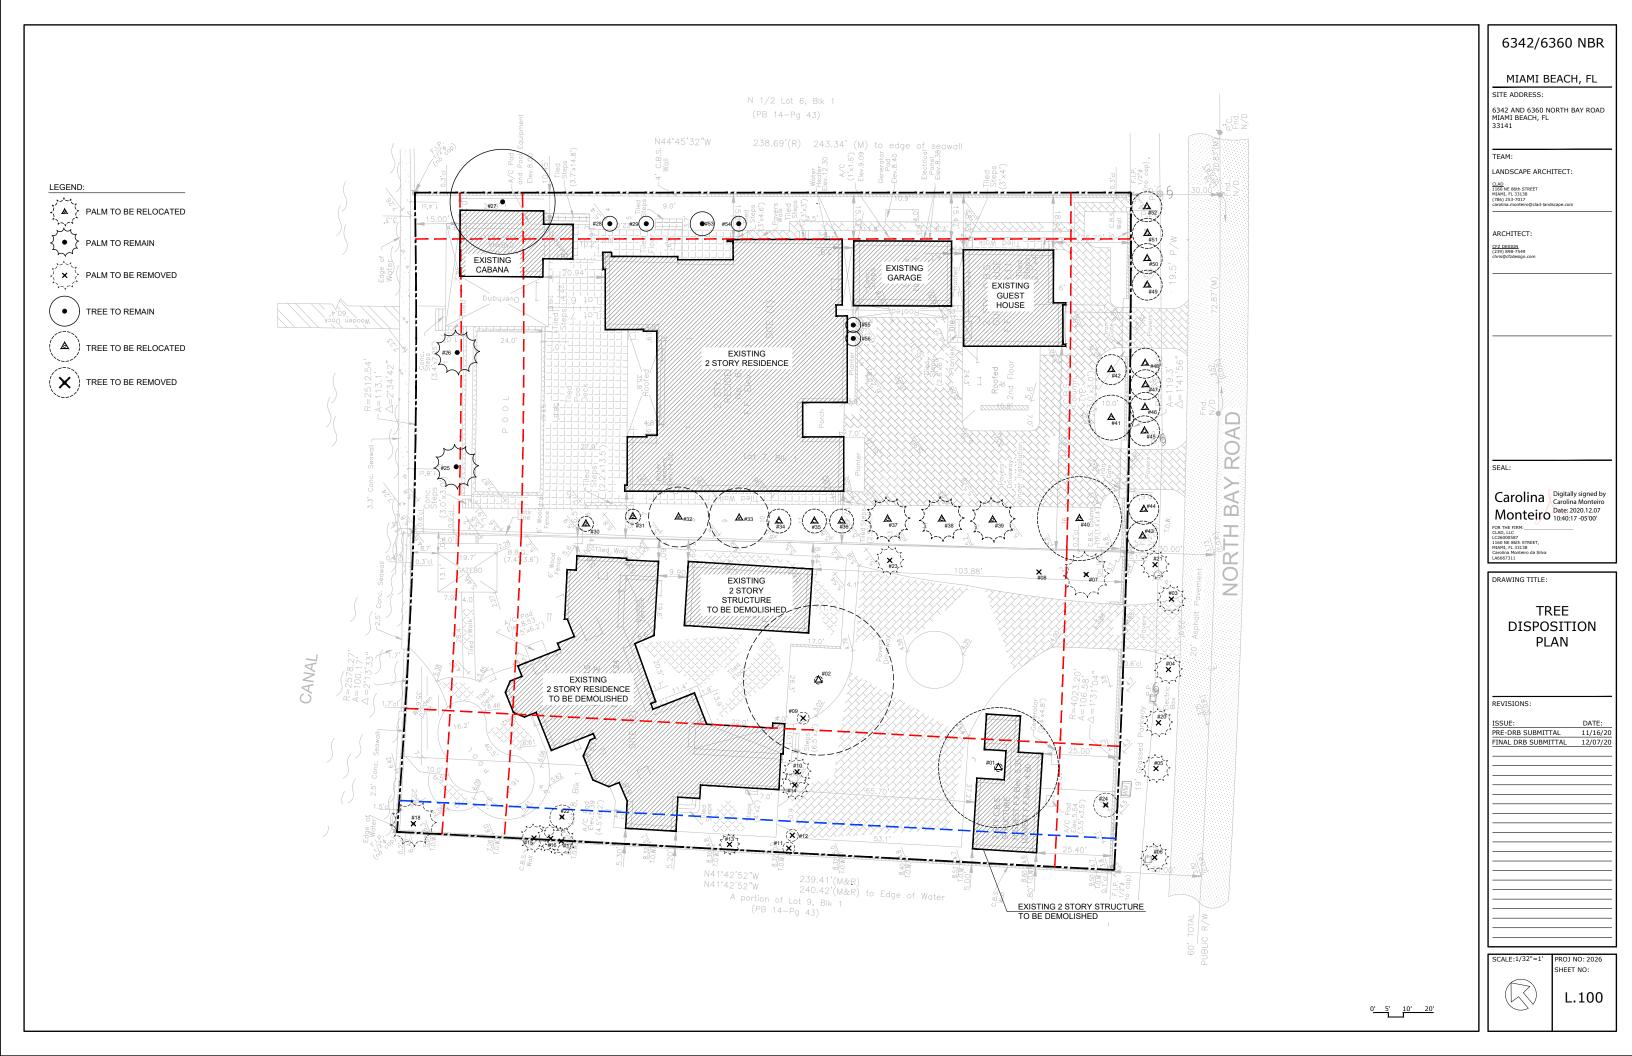

#### TREE DISPOSITION SCHEDULE

TREE DISPOSITION SCHEDULE									
ŞYM	SCIENTIFIC NAME	COMMON NAME	DBH (in)	HEIGHT (ft)	SPREAD (ft)	CONDITION	NATIVE	DISPOSITION	
1	Ficus microcarpa	Chinese Banyan	61	40	40	GOOD		RELOCATE	
2	Ficus microcarpa	Chinese Banyan	74	45	50	GOOD		RELOCATE	
3	Phoenix roebelleni	Pygmy Date Palm	5	7	7	GOOD		REMOVE	
4	Phoenix roebelleni	Pygmy Date Palm	5	10	7	GOOD		REMOVE	
5	Phoenix roebelleni	Pygmy Date Palm	5	7	7	FAIR		REMOVE	
6	Phoenix roebelleni	Pygmy Date Palm	5	7	7	FAIR		REMOVE	
7	Roystonea regia	Royal Palm	20	40	16	GOOD	NATIVE	REMOVE	
8	Roystonea regia	Royal Palm	19	25	0	DEAD	NATIVE	REMOVE	
9	Carica papaya	Papaya	5	10	2	POOR		REMOVE	
10	Ptychosperma elegans	Solitaire Palm	4	30	7	FAIR		REMOVE	
11	Ptychosperma elegans	Solitaire Palm	3.5	25	7	FAIR		REMOVE	
12	Carica papaya	Papaya	6	14	2	POOR		REMOVE	
13	Carica papaya	Papaya	5	7	0	POOR		REMOVE	
14	Ptychosperma elegans	Solitaire Palm	4	30	7	FAIR		REMOVE	
15	Ptychosperma elegans	Solitaire Palm (7)	25	20	10	GOOD		REMOVE	
16	Caryota mitis	Fishtail Palm	CLUSTER	20	7	POOR		REMOVE	
17	Thrinax radiata	Florida Thatch Palm	3	15	12	FAIR	NATIVE	REMOVE	
18	Dypsis lutescens	Areca Palm	CLUSTER	15	7	FAIR		REMOVE	
20	Phoenix roebelleni	Pygmy Date Palm	5	7	10	FAIR		REMOVE	
21	Phoenix roebelleni	Pygmy Date Palm	6	14	8	GOOD		REMOVE	
22	Koelreuteria paniculata	Golden Rain Tree	4	30	7	FAIR		REMOVE	
23	Ptychosperma elegans	Solitaire Palm (2)	7	15	8	FAIR		REMOVE	
24	Carica papaya	Papaya	8	15	8	GOOD		REMOVE	
25	Phoenix Dactylifera	Date Palm	15	30	15	GOOD		REMAIN	
26	Phoenix Dactylifera	Date Palm	16	30	15	GOOD		REMAIN	
27	Ficus aurea	Florida Strangler Fig	48	30	35	FAIR	NATIVE	REMAIN	
28	Elaeocarpus decipiens	Japanese Blueberry	4	12	5	GOOD		REMAIN	
29	Elaeocarpus decipiens	Japanese Blueberry	4	12	5	GOOD		REMAIN	
30	Elaeocarpus decipiens	Japanese Blueberry	4	8	5	GOOD		RELOCATE	
31	Elaeocarpus decipiens	Japanese Blueberry	4	8	5	GOOD		RELOCATE	
32	Quercus virgniana	Live Oak	9.5	18	20	FAIR	NATIVE	RELOCATE	
33	Quercus virgniana	Live Oak	10.5	20	20	GOOD	NATIVE	RELOCATE	
34	Magnolia grandiflora	Southern Magnolia	4	16	8	GOOD	NATIVE	RELOCATE	
35	Magnolia grandiflora	Southern Magnolia	4	15	8	GOOD	NATIVE	RELOCATE	
36	Magnolia grandiflora	Southern Magnolia	4	15	8	GOOD	NATIVE	RELOCATE	
37	Phoenix Dactylifera	Date Palm	14.5	30	15	GOOD		RELOCATE	
38	Phoenix Dactylifera	Date Palm	15	30	15	GOOD		RELOCATE	
39	Phoenix Dactylifera	Date Palm	14.5	30	15	GOOD		RELOCATE	
40	Quercus virgniana	Live Oak	13.5	25	28	GOOD	NATIVE	RELOCATE	
41	Elaeocarpus decipiens	Japanese Blueberry	8	20	15	GOOD		RELOCATE	
42	Elaeocarpus decipiens	Japanese Blueberry	8	18	10	GOOD		RELOCATE	
43	Calophyllum brasiliense	Brazilian Beautyleaf	4	20	10	GOOD		RELOCATE	
44	Calophyllum brasiliense	Brazilian Beautyleaf	4	20	10	GOOD		RELOCATE	
45	Calophyllum brasiliense	Brazilian Beautyleaf	4	20	10	GOOD		RELOCATE	
46	Calophyllum brasiliense	Brazilian Beautyleaf	4	20	10	GOOD		RELOCATE	
47	Calophyllum brasiliense	Brazilian Beautyleaf	4	20	10	GOOD		RELOCATE	
48	Calophyllum brasiliense	Brazilian Beautyleaf	4	20	10	GOOD		RELOCATE	
49	Calophyllum brasiliense	Brazilian Beautyleaf	4	20	10	GOOD		RELOCATE	
50	Calophyllum brasiliense	Brazilian Beautyleaf	4	20	10	GOOD		RELOCATE	
51	Calophyllum brasiliense	Brazilian Beautyleaf	4	20	10	GOOD		RELOCATE	
52	Calophyllum brasiliense	Brazilian Beautyleaf	4	20	10	GOOD		RELOCATE	
53	Elaeocarpus decipiens	Japanese Blueberry	4	12	8	GOOD		REMAIN	
54	Elaeocarpus decipiens	Japanese Blueberry	4	8	5	POOR		REMAIN	
55	Elaeocarpus decipiens	Japanese Blueberry	3	12	5	GOOD		REMAIN	
56	Elaeocarpus decipiens	Japanese Blueberry	3	12	5	GOOD		REMAIN	

6342/6360 NBR

MIAMI BEACH, FL

SITE ADDRESS:

6342 AND 6360 NORTH BAY ROAD MIAMI BEACH, FL 33141

TEAM:

LANDSCAPE ARCHITECT:

ARCHITECT:

SEAL:

Carolina Digitally signed by Carolina Monteiro Date: 2020.12.07
POR THE FIRM: CAPOLICE THE PRIME THE PRIME

DRAWING TITLE:

TREE DISPOSITION SCHEDULE

REVISIONS:


 ISSUE:
 DATE:

 PRE-DRB SUBMITTAL
 11/16/20

 FINAL DRB SUBMITTAL
 12/07/20

SCALE: N.T.S.

PROJ NO: 2026 SHEET NO:

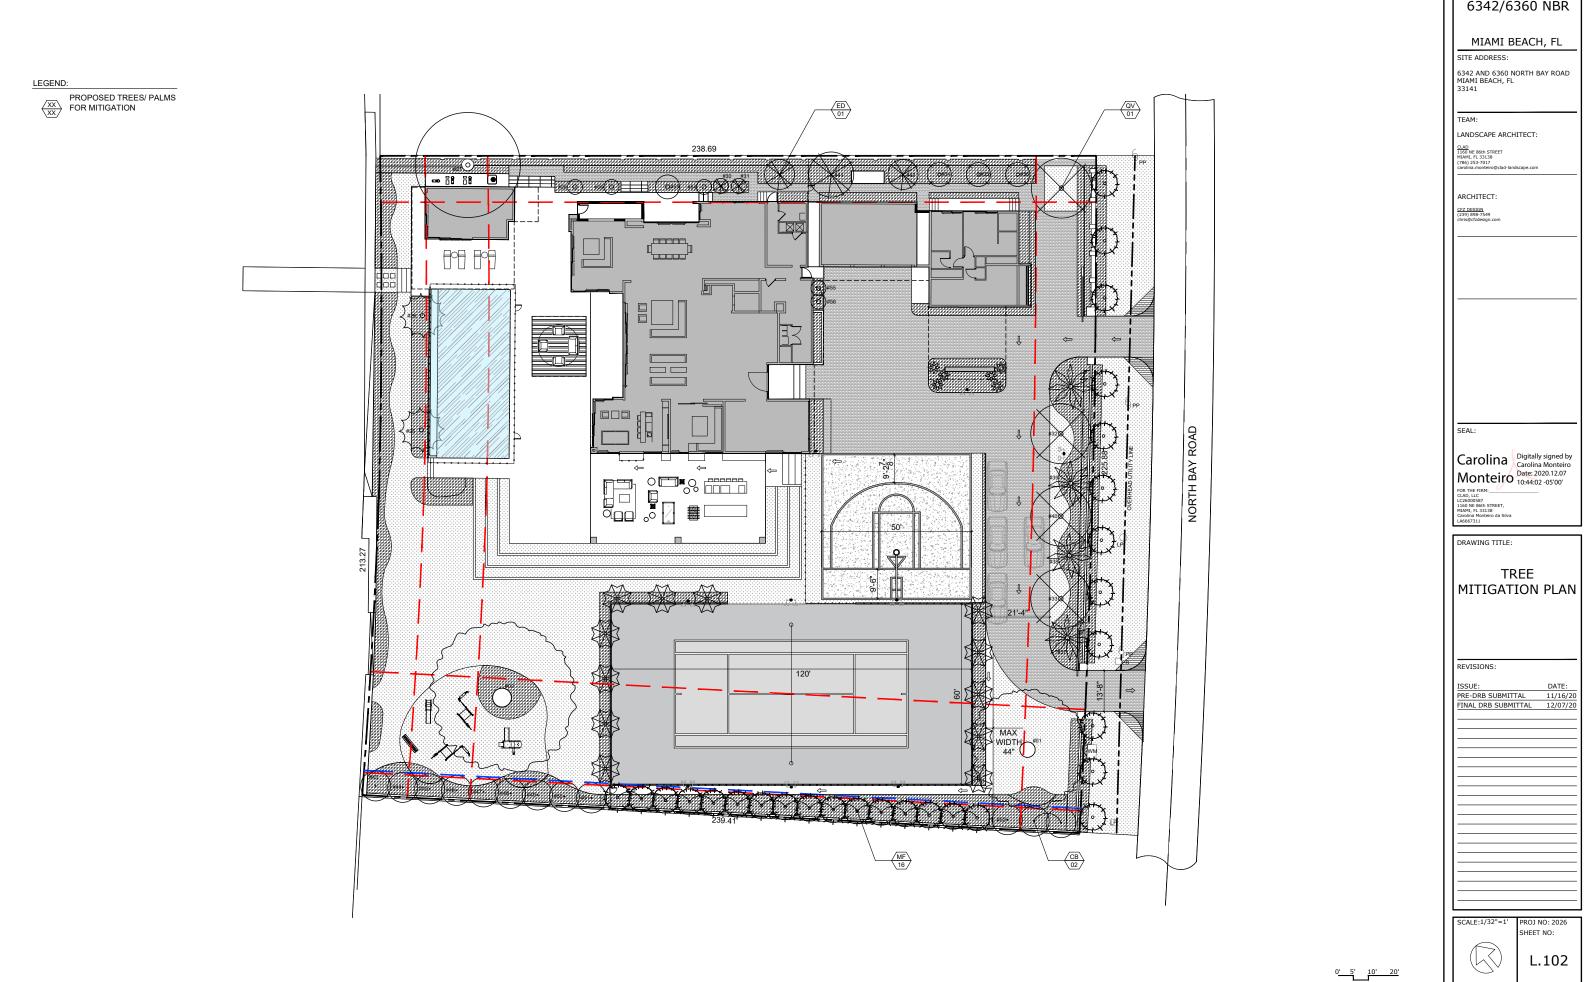

#### TREE REMOVAL SCHEDULE

SYM	SCIENTIFIC NAME	COMMON NAME	DBH (in)	HEIGHT (ft)	SPREAD (ft)	CONDITION	NATIVE	DISPOSITION	DBH (in) REMOVED	PALMS REMOV
3	Phoenix roebelleni	Pygmy Date Palm	5	7	7	GOOD		REMOVE		1
4	Phoenix roebelleni	Pygmy Date Palm	5	10	7	GOOD		REMOVE		1
5	Phoenix roebelleni	Pygmy Date Palm	5	7	7	FAIR		REMOVE		1
6	Phoenix roebelleni	Pygmy Date Palm	5	7	7	FAIR		REMOVE		1
7	Roystonea regia	Royal Palm	20	40	16	GOOD	NATIVE	REMOVE		1
8	Roystonea regia	Royal Palm	19	25	0	DEAD	NATIVE	REMOVE		1
9	Carica papaya	Papaya	5	10	2	POOR		REMOVE	5	
10	Ptychosperma elegans	Solitaire Palm	4	30	7	FAIR		REMOVE		1
11	Ptychosperma elegans	Solitaire Palm	3.5	25	7	FAIR		REMOVE		1
12	Carica papaya	Papaya	6	7	0	POOR		REMOVE	6	
13	Carica papaya	Papaya	5	7	0	POOR		REMOVE	5	1
14	Ptychosperma elegans	Solitaire Palm	4	30	7	FAIR		REMOVE		1
15	Ptychosperma elegans	Solitaire Palm (7)	25	20	10	GOOD		REMOVE		1
16	Caryota mitis	Fishtail Palm	CLUSTER	20	7	POOR		REMOVE		1
17	Thrinax radiata	Florida Thatch Palm	3	15	12	FAIR	NATIVE	REMOVE		1
18	Dypsis lutescens	Areca Palm	CLUSTER	15	7	FAIR		REMOVE		1
20	Phoenix roebelleni	Pygmy Date Palm	5	7	10	FAIR		REMOVE		1
21	Phoenix roebelleni	Pygmy Date Palm	6	14	8	GOOD		REMOVE		1
22	Koelreuteria paniculata	Golden Rain Tree	4	30	7	FAIR		REMOVE	4	
23	Ptychosperma elegans	Solitaire Palm (2)	7	15	8	FAIR		REMOVE		1
24	Carica papaya	Papaya	8	15	8	GOOD		REMOVE	8	
CEE ADRO	RIST REPORT FOR FURTHER DET	All ON TREES AND DALMS ON	I TUIC LICT	I.				TOTAL REMOVED	28	17

28" DBH + 17 TREES FOR THE REMOVAL OF 17 PALMS, EQUIVALENT TO: 27 REPLACEMENT TREES (MIN. 2" CALIPER, 6' CANOPY, 12' HT), OR 14 REPLACEMENT TREES (MIN. 4" CALIPER, 8' CANOPY, 16' HT) 8 TREES MUST BE NATIVE (30% OF REQUIRED TREES)

SPECIES DIVERSITY: 21-30: 4 SPECIES

THE CODE (NEW ORDINANCE) IS BEING MET BY USING: 20 TREES (MIN. 4" CALIPER, 8' CANOPY, 16' HT)

#### TREES USED FOR MITIGATION

SYM	QTY	SCIENTIFIC NAME	COMMON NAME	NATIVE	NOTES
СВ	2	Calophyllum brasiliense	BRAZILIAN BEAUTY LEAF	N	minimum 16' HT; 4" DBH
MF	16	Myrcianthes fragrans	SIMPSON'S STOPPER TREE	Υ	minimum 16' HT; 4" DBH
QV	1	Quercus virginiana	LIVE OAK	Υ	minimum 16' HT; 4" DBH
ED	1	Elaeocarpus decipiens	JAPANESE BLUEBERRY	N	minimum 16' HT; 4" DBH

Total: 20 TREES USED FOR MITIGATION DIVIDED IN 4 SPECIES

6342/6360 NBR

MIAMI BEACH, FL

SITE ADDRESS:

6342 AND 6360 NORTH BAY ROAD MIAMI BEACH, FL 33141

TEAM:

LANDSCAPE ARCHITECT:

1160 NE 86th STREET MIAMI, FL 33138 (786) 253-7017

ARCHITECT:

CFZ DESIGN

chris@cfzdesign.cor

SEAL:

Carolina Digitally signed by Carolina Monteiro Date: 2020.12.07 10:45:39 -05'00'

COR THE FIRM: CLAD, LLC LC26000587 L160 NE 86th STREET, MIAMI, FL 33138 Carolina Monteiro da Silva LA6667311

DRAWING TITLE:


TREE MITIGATION SCHEDULE

REVISIONS:

ISSUE: DATE:
PRE-DRB SUBMITTAL 11/16/20
FINAL DRB SUBMITTAL 12/07/20

SCALE: N.T.S.

PROJ NO: 2026 SHEET NO:

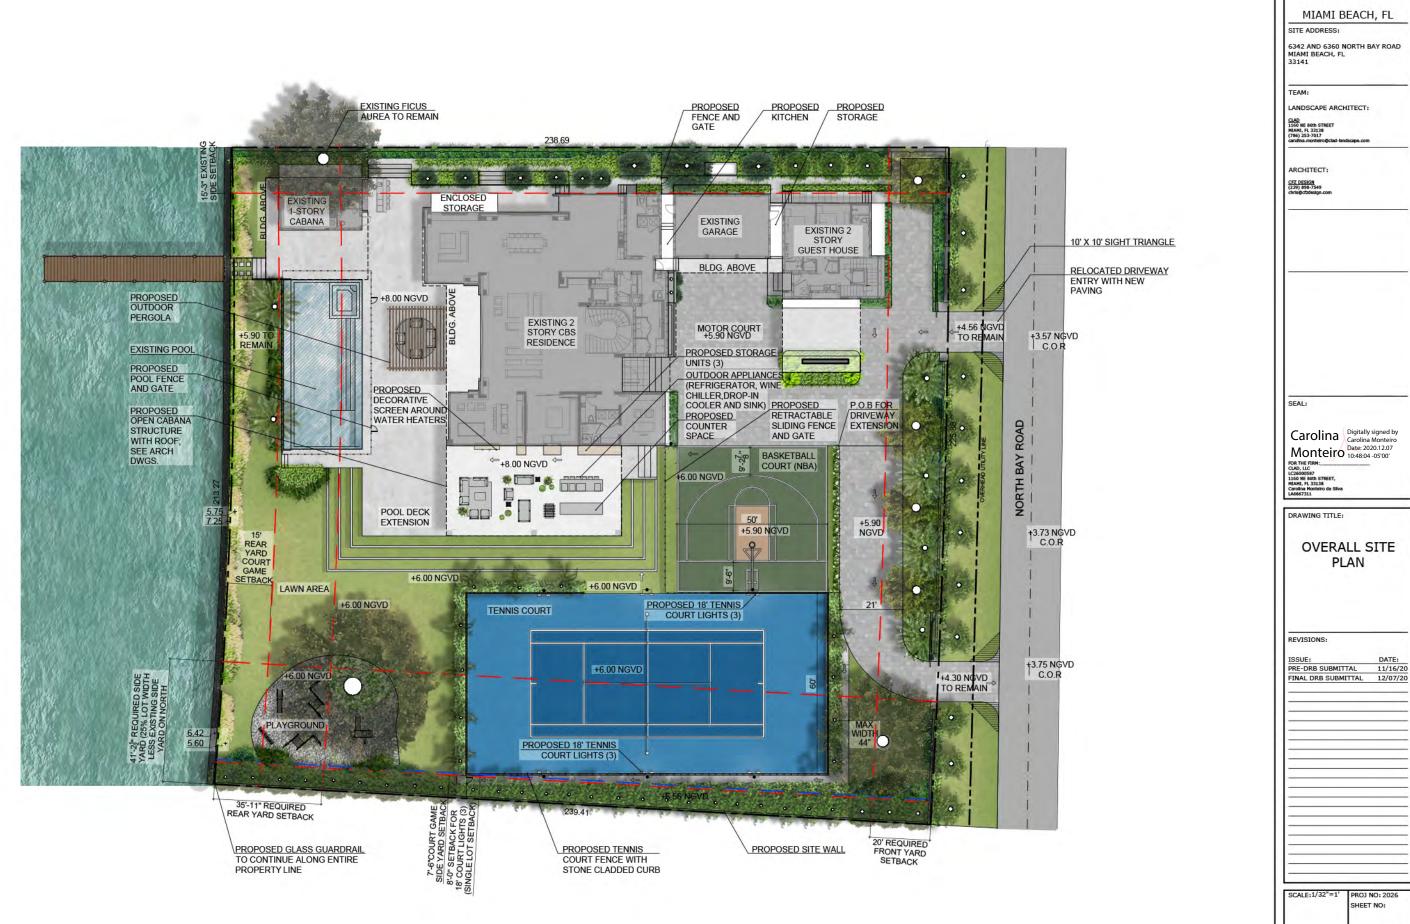

L.200

0' 5' 10' 20'

