TREE LEGEND

10'

12'

10'

15'

20'

20'

10'

15'

20'

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20'

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20'

25'

20'

20'

25'

25'

20'

HEIGHT CANOPY DIAMETER

3"

3"

0.5"

1"

10"

3"

3"

0.5"

0.8"

3"

3"

3"

3"

3"

3"

3"

1.5"

0.5"

0.5"

0.5"

1.5"

1.5"

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5'

5'

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15'

15'

5'

10'

10'

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10'

NAME

1 CLOSTER

2 CLOSTER

3 TREE

4 TREE

5 TREE

8 TREE

9 TREE

6 CLOSTER

7 CLOSTER

10 CLOSTER

11 CLOSTER

12 CLOSTER

13 CLOSTER

14 CLOSTER

15 CLOSTER

16 CLOSTER

18 (A)(B)TREE

17 TREE

19 TREE

20 TREE

21 TREE

22 TREE

23 TREE

24 TREE

25 TREE

26 TREE

27 TREE

28 TREE

29 TREE

30 TREE

THE E SURVE

EDGE OF PAVEMENT ABBOTT AVENUE 35: ASPHALT PAVEMENT 50' PUBLIC RIGHT-OF-WAY ·2:5: VALLEY GUTTER FAST RIGHT-OF-WAY LINE -· EDGE OF PAVEMENT 5 CONC 200 00 (R) ·50·00'(R&M) /50.00'(R&M) BLOCK ON PL-CORNER FIP 1/2 FIP 1/2" NO LD NO I.D. NO I.D. PORCH 6 _ **—** S 刀 Ш Ш LOT-6 .50'(R&M) LOT-4 BLOCK-II BLOCK-II PORCH 0.55' CL-୍ଦ 🛭 ØNE STÓRY STEPS റ്റ 🗵 BUILDING ≤@ <u>_</u> Ø∰ Ø∰^{A/E}L_ 0.65' CL--0.42' CL FIP 1/2" FIP 1/2" 50.00'(R&M) NO I.D. NO I.D. LOT-7 LOT-9 LOT-8 BLOCK-II BLOCK-II BLOCK-II

PROPERTY ADDRESS: **7611 ABBOTT AVENUE** MIAMI BEACH, FJ. 33141 (FOLIO No. 02-3202-007-0700)

DESCRIPTION

BLOCK

CORNER

FIP 1/2"

NO I.D.

7

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Lot 5, Block 11, of "ALTOS DEL MAR No. 3" according to the Plat thereof as recorded in Plat Book 8, at Page 41, of the Public Records of Miami-Dade County, Florida.

There may be legal restrictions on the subject property that are not shown on the Map of Survey that may be found in the Public Records of Miami-Dade County, or the records of any other public and private entities as their jurisdictions may appear.

The Map of Survey is intended to be displayed at the stated graphic scale in English units of measurement. Attention is brought to the fact that said drawing may be altered in scale by the reproduction process.

This Survey was conducted for the purpose of a TREE SURVEY only and is not intended to delineate the regulatory jurisdiction of any federal, state, regional or local agency board, commission LOCATION MAP(NOT TO SCALE) or other entity.

Legal description was furnished by the client. The elevations of well-identified features as depicted on this survey and map were measured to an estimated vertical positional accuracy of 1/10 If shown elevations are referred to NGVD of 1929 foot for natural ground surfaces and 1/100 foot for The surveyor makes no representation as to hardscape surfaces, including pavements, curbs and other man-made features as may exist.

Well-identified features as depicted on this survey Subsurface improvements and/or encroachments and map were measured to an estimated horizontal positional accuracy of 1/10 foot unless otherwise shown.

Legal Description subject to any dedications, limitations, restrictions, reservations or recorded

Sketch of Survey cannot be used for construction purposes. Surveyor not responsible for third party alterations.

LIST OF POSSIBLE ENCROACHMENT: N/A

BENCH MARK USED BM #78-01, Elev.= 4.27' converted to NGVD 1929



ownership, possession or occupation of the subject property by any entity or individual.

within, upon, across, abutting or adjacent to the subject property were not located and are not

Not valid without the signature and original raised seal of a Florida Licensed Surveyor and Mapper. Additions and deletions to this Map of Survey by other than the signing party are prohibited without the written consent of the signing party.

This Map of Survey has been prepared for the exclusive use of the entities named herein and the certification does not extend to any unnamed

THE MAP OF SURVEY RESULTING THERE FROM WAS PERFORMED UNDER MY DIRECTION AND IS TRUE AND CORRECT TO THE BEST OF MY NOWLEDGE AND BELIEF AND FURTHER, THAT SAID "TREE SURVEY" MEETS THE INTENT OF THE MINIMUM TECHNICAL STANDARDS FOR LAND SURVEYING IN THE STATE OF FLORIDA" PURSUANT TO RULE 5.117 OF THE FLORIDA ADMINISTRATIVE CODE AND ITS IMPLEMENTING RULE, CHAPTER 472.027 OF THE FLORIDA STATUTES.

ARTURO TOIRAC PROFESSIONAL LAND SURVEYOR No. 3102 STATE OF FLORIDA

Insurance

12-09-202

J.V.D.

FLOOD ZONE INFORMATION: Community No. 120651 Panel No. 0326

AERIAL MAP (NOT TO SCALE)

Suffix: L FIRM Date: 09-11-2009 Flood Zone: AE + 8'



VIZCAYA SURVEYING AND MAPPING, INC. Land Surveyors & Mapper LB #8000 CARLOS@CBSSERVICESMIAMI.COM 13217 SW 46 LANE, MIAMI, FL. 33157

(786) 290-4184

party CERTIFY TO: AMIR RON & VICTORIA V. RON SURVEYOR'S CERTIFICATION: HEREBY CERTIFY: THAT THIS "TREE SURVEY" AND Survey is not covered by Proffesional Liability

12-09-2020

SHEET No. 1/1 JOB No.:

ORIGINAL

FIELD DATE

REVISIONS:

DRAWN

SURV

2""

MH MML MGVC NTS OE PB

201445

U.S. DEPARTMENT OF HOMELAND SECURITY Federal Emergency Management Agency National Flood Insurance Program

OMB No. 1660-0008 Expiration Date: November 30, 2022

ELEVATION CERTIFICATE

Important: Follow the instructions on pages 1–9.

Copy all pages of this Elevation Certificate and all attachments for (1) community official, (2) insurance agent/company, and (3) building owner.

SECTION A - PROPERTY INFORMATION						FOR INSUR	ANCE COMPANY USE	
A1. Building Owner's Name AMIR RON & VICTORIA V RON Policy Number:							oer:	
A2. Building Street Address (including Apt., Unit, Suite, and/or Bldg. No.) or P.O. Route and Company NAIC Number:								AIC Number:
7611 ABBOTT AVE	NUE F	OL #02-3202-007-07	00	JOB #201445	5 (JV)			
City MIAMI BEACH				State Florida			ZIP Code 33141	
		nd Block Numbers, Ta R No. 3", PB 4, PG 41,			-		•	
A4. Building Use (e	.g., Residen	itial, Non-Residential,	Addition,	Accessory, e	etc.)	RESIDENTI	AL	
A5. Latitude/Longit	ude: Lat. 2	5° 41' 41.41"N	Long. 8	0° 07' 22.03"	W	Horizontal D	Datum: NAD 1	927 × NAD 1983
A6. Attach at least	2 photograp	hs of the building if the	e Certific	ate is being u	ised to c	obtain flood i	insurance.	
A7. Building Diagra	m Number	8						
A8. For a building v	vith a crawls	pace or enclosure(s):						
a) Square foot	age of crawl	space or enclosure(s)		1	1069.00	sq ft		
b) Number of p	ermanent flo	ood openings in the cra	awlspace	e or enclosure	e(s) with	in 1.0 foot a	bove adjacent gra	de <u>6</u>
c) Total net are	a of flood op	penings in A8.b	1	440.00 sq in	1			
d) Engineered	flood openir	ngs? 🗌 Yes 🗵 N	No					
A9. For a building w	ith an attach	ned garage:						
a) Square foota	age of attach	ied garage		N/A sq ft				
b) Number of p	ermanent flo	ood openings in the at	tached g	arage within	1.0 foot	above adjac	cent grade N/A	
c) Total net are	a of flood op	penings in A9.b		N/A sq	in			
d) Engineered	flood openin	gs? Yes 🗷 N	No					
	SE	CTION B - FLOOD	INSURA	NCE RATE	MAP (F	IRM) INFO	RMATION	
B1. NFIP Communit	-			B2. County MIAMI-DAD				B3. State Florida
B4. Map/Panel Number	B5. Suffix	B6. FIRM Index Date		 RM Panel ective/	B8. Flo		B9. Base Flood El	evation(s) Base Flood Depth)
12086 C 0326	L	09-11-2009	Rev 09-11-2	vised Date 2009	,	AE	8'	, ,
B10. Indicate the source of the Base Flood Elevation (BFE) data or base flood depth entered in Item B9: ☐ FIS Profile ※ FIRM ☐ Community Determined ☐ Other/Source:								
B11. Indicate elevation datum used for BFE in Item B9: 🗵 NGVD 1929 🗌 NAVD 1988 📗 Other/Source:								
B12. Is the building located in a Coastal Barrier Resources System (CBRS) area or Otherwise Protected Area (OPA)? 🗌 Yes 🗵 No								
Designation Date: N/A CBRS OPA								

ELEVATION CERTIFICATE

OMB No. 1660-0008 Expiration Date: November 30, 2022

IMPORTANT: In these spaces, copy the corresponding	FOR INSURANCE COMPANY USE		
Building Street Address (including Apt., Unit, Suite, and/or 7611 ABBOTT AVENUE FOL #02-3202-007-0700	Bldg. No.) or P.O. Rou JOB #201445 (JV)		Policy Number:
City Stat	e ZIP	Code	Company NAIC Number
MIAMI BEACH Flor	ida 3314	41	
SECTION C – BUILDING ELE	EVATION INFORMAT	TION (SURVEY RE	EQUIRED)
C1. Building elevations are based on: Constructio *A new Elevation Certificate will be required when co	• 🗆	ding Under Constru	ction* X Finished Construction
C2. Elevations – Zones A1–A30, AE, AH, A (with BFE),			AE, AR/A1–A30, AR/AH, AR/AO.
Complete Items C2.a-h below according to the build Benchmark Utilized: #78-01	ling diagram specified		o Rico only, enter meters.
Indicate elevation datum used for the elevations in it		· · · · · · · · · · · · · · · · · · ·	<u>,, </u>
□ NGVD 1929 NAVD 1988 Other/S	, ,	***	
Datum used for building elevations must be the same		BFE.	
a) Top of bottom floor (including basement, crawlsp	acc or analogura floor	`	Check the measurement used. 6.46 ⊠ feet ☐ meters
	ace, or enclosure noor)	N/A feet meters
b) Top of the next higher floor	0.7		N/A feet meters
c) Bottom of the lowest horizontal structural membe	r (v Zones only)		N/A feet meters
d) Attached garage (top of slab)e) Lowest elevation of machinery or equipment serv	vicing the building		
(Describe type of equipment and location in Com	ments)		
f) Lowest adjacent (finished) grade next to building	,		
g) Highest adjacent (finished) grade next to building			4.69 X feet meters
h) Lowest adjacent grade at lowest elevation of dec structural support	k or stairs, including		N/A feet meters
SECTION D – SURVEYOR,	ENGINEER, OR ARC	CHITECT CERTIFI	CATION
This certification is to be signed and sealed by a land sur I certify that the information on this Certificate represents statement may be punishable by fine or imprisonment un	my best efforts to inter	rpret the data availa	law to certify elevation information. ble. I understand that any false
Were latitude and longitude in Section A provided by a lic	ensed land surveyor?	⊠Yes □ No	Check here if attachments.
Certifier's Name ARTURO TOIRAC, P.L.S.	License Number 3102		
Title			7
PROFFESIONAL. SURVEYOR & MAPPER			Place
Company Name VIZCAYA SURVEYING AND MAPPING, INC.			Seal
Address 13217 S.W. 46 LANE			Here
City MIAMI	State Florida	ZIP Code 33157	
Signature	Date	Telephone	Ext.
	12-09-2020	(786) 290-4184	
Copy all pages of this Elevation Certificate and all attachme		fficial, (2) insurance a	agent/company, and (3) building owner.
Comments (including type of equipment and location, per C.O.R. Elevation= 4.67' REAR BUILDING F.F.E. 6.00 C2. e) A/C CONC LOCATED AT THE EAST WALL LINE A5. CONVERTING ADDRESS TO LATITUDE/ LONGITU	DIAGRAM 1-B FACADE	orse PROGRAM	

ELEVATION CERTIFICATE

OMB No. 1660-0008 Expiration Date: November 30, 2022

IMPORTANT: In these spaces, copy the correspondir	ng information from Section A.	FOR INSURA	NCE COMPANY USE
Building Street Address (including Apt., Unit, Suite, and/	,	No. Policy Numbe	r:
7611 ABBOTT AVENUE FOL #02-3202-007-0700			
- ,	tate ZIP Code lorida 33141	Company NAI	C Number
	EVATION INFORMATION (SURVE	Y NOT REQUIRED)	
	AO AND ZONE A (WITHOUT BFE		
For Zones AO and A (without BFE), complete Items E1–complete Sections A, B,and C. For Items E1–E4, use na enter meters.			
E1. Provide elevation information for the following and of the highest adjacent grade (HAG) and the lowest act a) Top of bottom floor (including basement,		whether the elevation i	s above or below
crawlspace, or enclosure) is		meters above o	or 🗌 below the HAG.
 Top of bottom floor (including basement, crawlspace, or enclosure) is 	feet [meters above o	or 🗌 below the LAG.
E2. For Building Diagrams 6–9 with permanent flood op the next higher floor (elevation C2.b in the diagrams) of the building is	enings provided in Section A Items 8	_ ` _	–2 of Instructions),
E3. Attached garage (top of slab) is			or below the HAG.
E4. Top of platform of machinery and/or equipment servicing the building is	feet	☐ meters ☐ above o	or Delow the HAG.
E5. Zone AO only: If no flood depth number is available floodplain management ordinance? Yes	e, is the top of the bottom floor elevate No Unknown. The local officia		
SECTION F - PROPERTY OWN	ER (OR OWNER'S REPRESENTAT	IVE) CERTIFICATION	
The property owner or owner's authorized representative community-issued BFE) or Zone AO must sign here. The	e who completes Sections A, B, and I e statements in Sections A, B, and E	E for Zone A (without a are correct to the best	FEMA-issued or of my knowledge.
Property Owner or Owner's Authorized Representative's	s Name		
Address	City	State	ZIP Code
Signature	Date	Telephone	
Comments			
		☐ Check	here if attachments.

ELEVATION CERTIFICATE

OMB No. 1660-0008 Expiration Date: November 30, 2022

MPORTANT: In these spaces, copy the corresponding information from Section A. FOR INSURANCE COMPANY USE							
Building Street Address (including Apt., Unit, S 7611 ABBOTT AVENUE FOL #02-3202-0	,		Policy Number:				
City MIAMI BEACH	State Florida	ZIP Code 33141	Company NAIC Number				
SECTION G – COMMUNITY INFORMATION (OPTIONAL)							
The local official who is authorized by law or ordinance to administer the community's floodplain management ordinance can complete Sections A, B, C (or E), and G of this Elevation Certificate. Complete the applicable item(s) and sign below. Check the measurement used in Items G8–G10. In Puerto Rico only, enter meters.							
G1. The information in Section C was taken from other documentation that has been signed and sealed by a licensed surveyor, engineer, or architect who is authorized by law to certify elevation information. (Indicate the source and date of the elevation data in the Comments area below.)							
G2. A community official completed Sect or Zone AO.	on E for a building locate	d in Zone A (without a FEM/	A-issued or community-issued BFE)				
G3. The following information (Items G4-	-G10) is provided for com	munity floodplain managem	ent purposes.				
G4. Permit Number	G5. Date Permit Issued		Date Certificate of Compliance/Occupancy Issued				
G7. This permit has been issued for:	New Construction S	Substantial Improvement					
G8. Elevation of as-built lowest floor (including of the building:	g basement)	[] feet	meters Datum				
G9. BFE or (in Zone AO) depth of flooding at	the building site:	feet	meters Datum				
G10. Community's design flood elevation:		feet	meters Datum				
Local Official's Name		Title					
Community Name		Telephone					
Signature		Date					
Comments (including type of equipment and lo	cation, per C2(e), if applic	cable)					
			Check here if attachments.				

BUILDING PHOTOGRAPHS

ELEVATION CERTIFICATE

See Instructions for Item A6.

OMB No. 1660-0008

Expiration Date: November 30, 2022

IMPORTANT: In these spaces, c	FOR INSURANCE COMPANY USE		
, ,	Apt., Unit, Suite, and/or Bldg. No.) o L #02-3202-007-0700 JOB #2	Policy Number:	
City MIAMI BEACH	State Florida	ZIP Code 33141	Company NAIC Number

If using the Elevation Certificate to obtain NFIP flood insurance, affix at least 2 building photographs below according to the instructions for Item A6. Identify all photographs with date taken; "Front View" and "Rear View"; and, if required, "Right Side View" and "Left Side View." When applicable, photographs must show the foundation with representative examples of the flood openings or vents, as indicated in Section A8. If submitting more photographs than will fit on this page, use the Continuation Page.



Photo One

HOUSE FRONT VIEW 12-09-20 Photo One Caption

Clear Photo One



Photo Two

Photo Two Caption HOUSE LEFT VIEW 12-09-20 Clear Photo Two

BUILDING PHOTOGRAPHS

ELEVATION CERTIFICATE

Continuation Page

OMB No. 1660-0008

Expiration Date: November 30, 2022

IMPORTANT: In these spaces, copy the corresponding information from Section A.	FOR INSURANCE COMPANY USE
Building Street Address (including Apt., Unit, Suite, and/or Bldg. No.) or P.O. Route and Box No. 7611 ABBOTT AVENUE FOL #02-3202-007-0700 JOB #201445 (JV)	Policy Number:
, ,	Company NAIC Number

If submitting more photographs than will fit on the preceding page, affix the additional photographs below. Identify all photographs with: date taken; "Front View" and "Rear View"; and, if required, "Right Side View" and "Left Side View." When applicable, photographs must show the foundation with representative examples of the flood openings or vents, as indicated in Section A8.



Photo Three

Photo Three Caption REAR HOUSE VIEW 12-09-20

Clear Photo Three



Photo Four

Photo Four Caption REAR HOUSE VIEW 12-09-20

Clear Photo Four

AMIR RON RESIDENCE

7611 ABBOTT AVENUE MIAMI BEACH, FL 33141



TABLE OF CONTENTS:

COVER COVER SHEET DRB.1 EXISTING & DEMOLITION SITE PLAN EXISTING & DEMOLITION BUILDING "A" FLOOR PLAN DRB.1.1 EXISTING & DEMOLITION BUILDING "A" ELEVATIONS LOCATION PLAN & ZONING INFO DRB.2 LOCATION MAP DRB.2.1 PROPOSED SITE PLAN FAR SHADED DIAGRAM PROPOSED BUILDING "A" 1ST FLOOR PLAN DRB.5 PROPOSED BUILDING "A" 2ND FLOOR PLAN DRB.5.1 PROPOSED & EXISTING ROOF PLAN DRB.6 DRB.7 PROPOSED BUILDING "A" ELEVATIONS EXISTING BUILDING "B" FLOOR PLAN DRB.8 EXISTING BUILDING "B" ELEVATIONS DRB.9 EXISTING BUILDING "A" PICTURES DRB.10 EXISTING BUILDING "B" PICTURES NEIGHBORHOOD CONTEXT PICTURES DRB.11 DRB.12 NEIGHBORHOOD CONTEXT PICTURES NEIGHBORHOOD CONTEXT PICTURES DRB.13 DRB.14 CONTEXTUAL ELEVATION LINE DRAWINGS LANDSCAPING COVER SHEET DRB.15 L-0EXISTING TREE DISPOSITION PLAN L-1EXISTING TREE NOTES & DETAILS L-2LP-1 PLANTING PLANS LP-2PLANTING NOTES & DETAILS IR-1IRRIGATION PLAN IRRIGATION NOTES & DETAILS IR-2

SCOPE OF WORK:

-DEMOLISH ENTIRE ONE STORY BUILDING UNIT "A". -BUILD NEW 2 STORY RESIDENCE AT THE REQUIRED 20' SETBACK TO REPLACE UNIT "A" MAINTAINING CHARACTER & DESIGN ELEMENTS THROUGHOUT BOTH FLOORS. -EXISTING ONE STORY BUILDING UNIT "B" TO REMAIN WITH NO WORK.

-VARIANCE BEING REQUESTED FOR EXISTING DRIVEWAY NOT IN COMPLIANCE WITH 5' SIDE SETBACK. NO PARKING WITHIN FIRST 10'.


√ \1ST. ISSUE 01.19.21 2ND


ECT, Inc.
A. #0015344
Jelopment
ROFESSIONAL


Job No.

Scale SHOWN

AA-26001560 Sheet No.

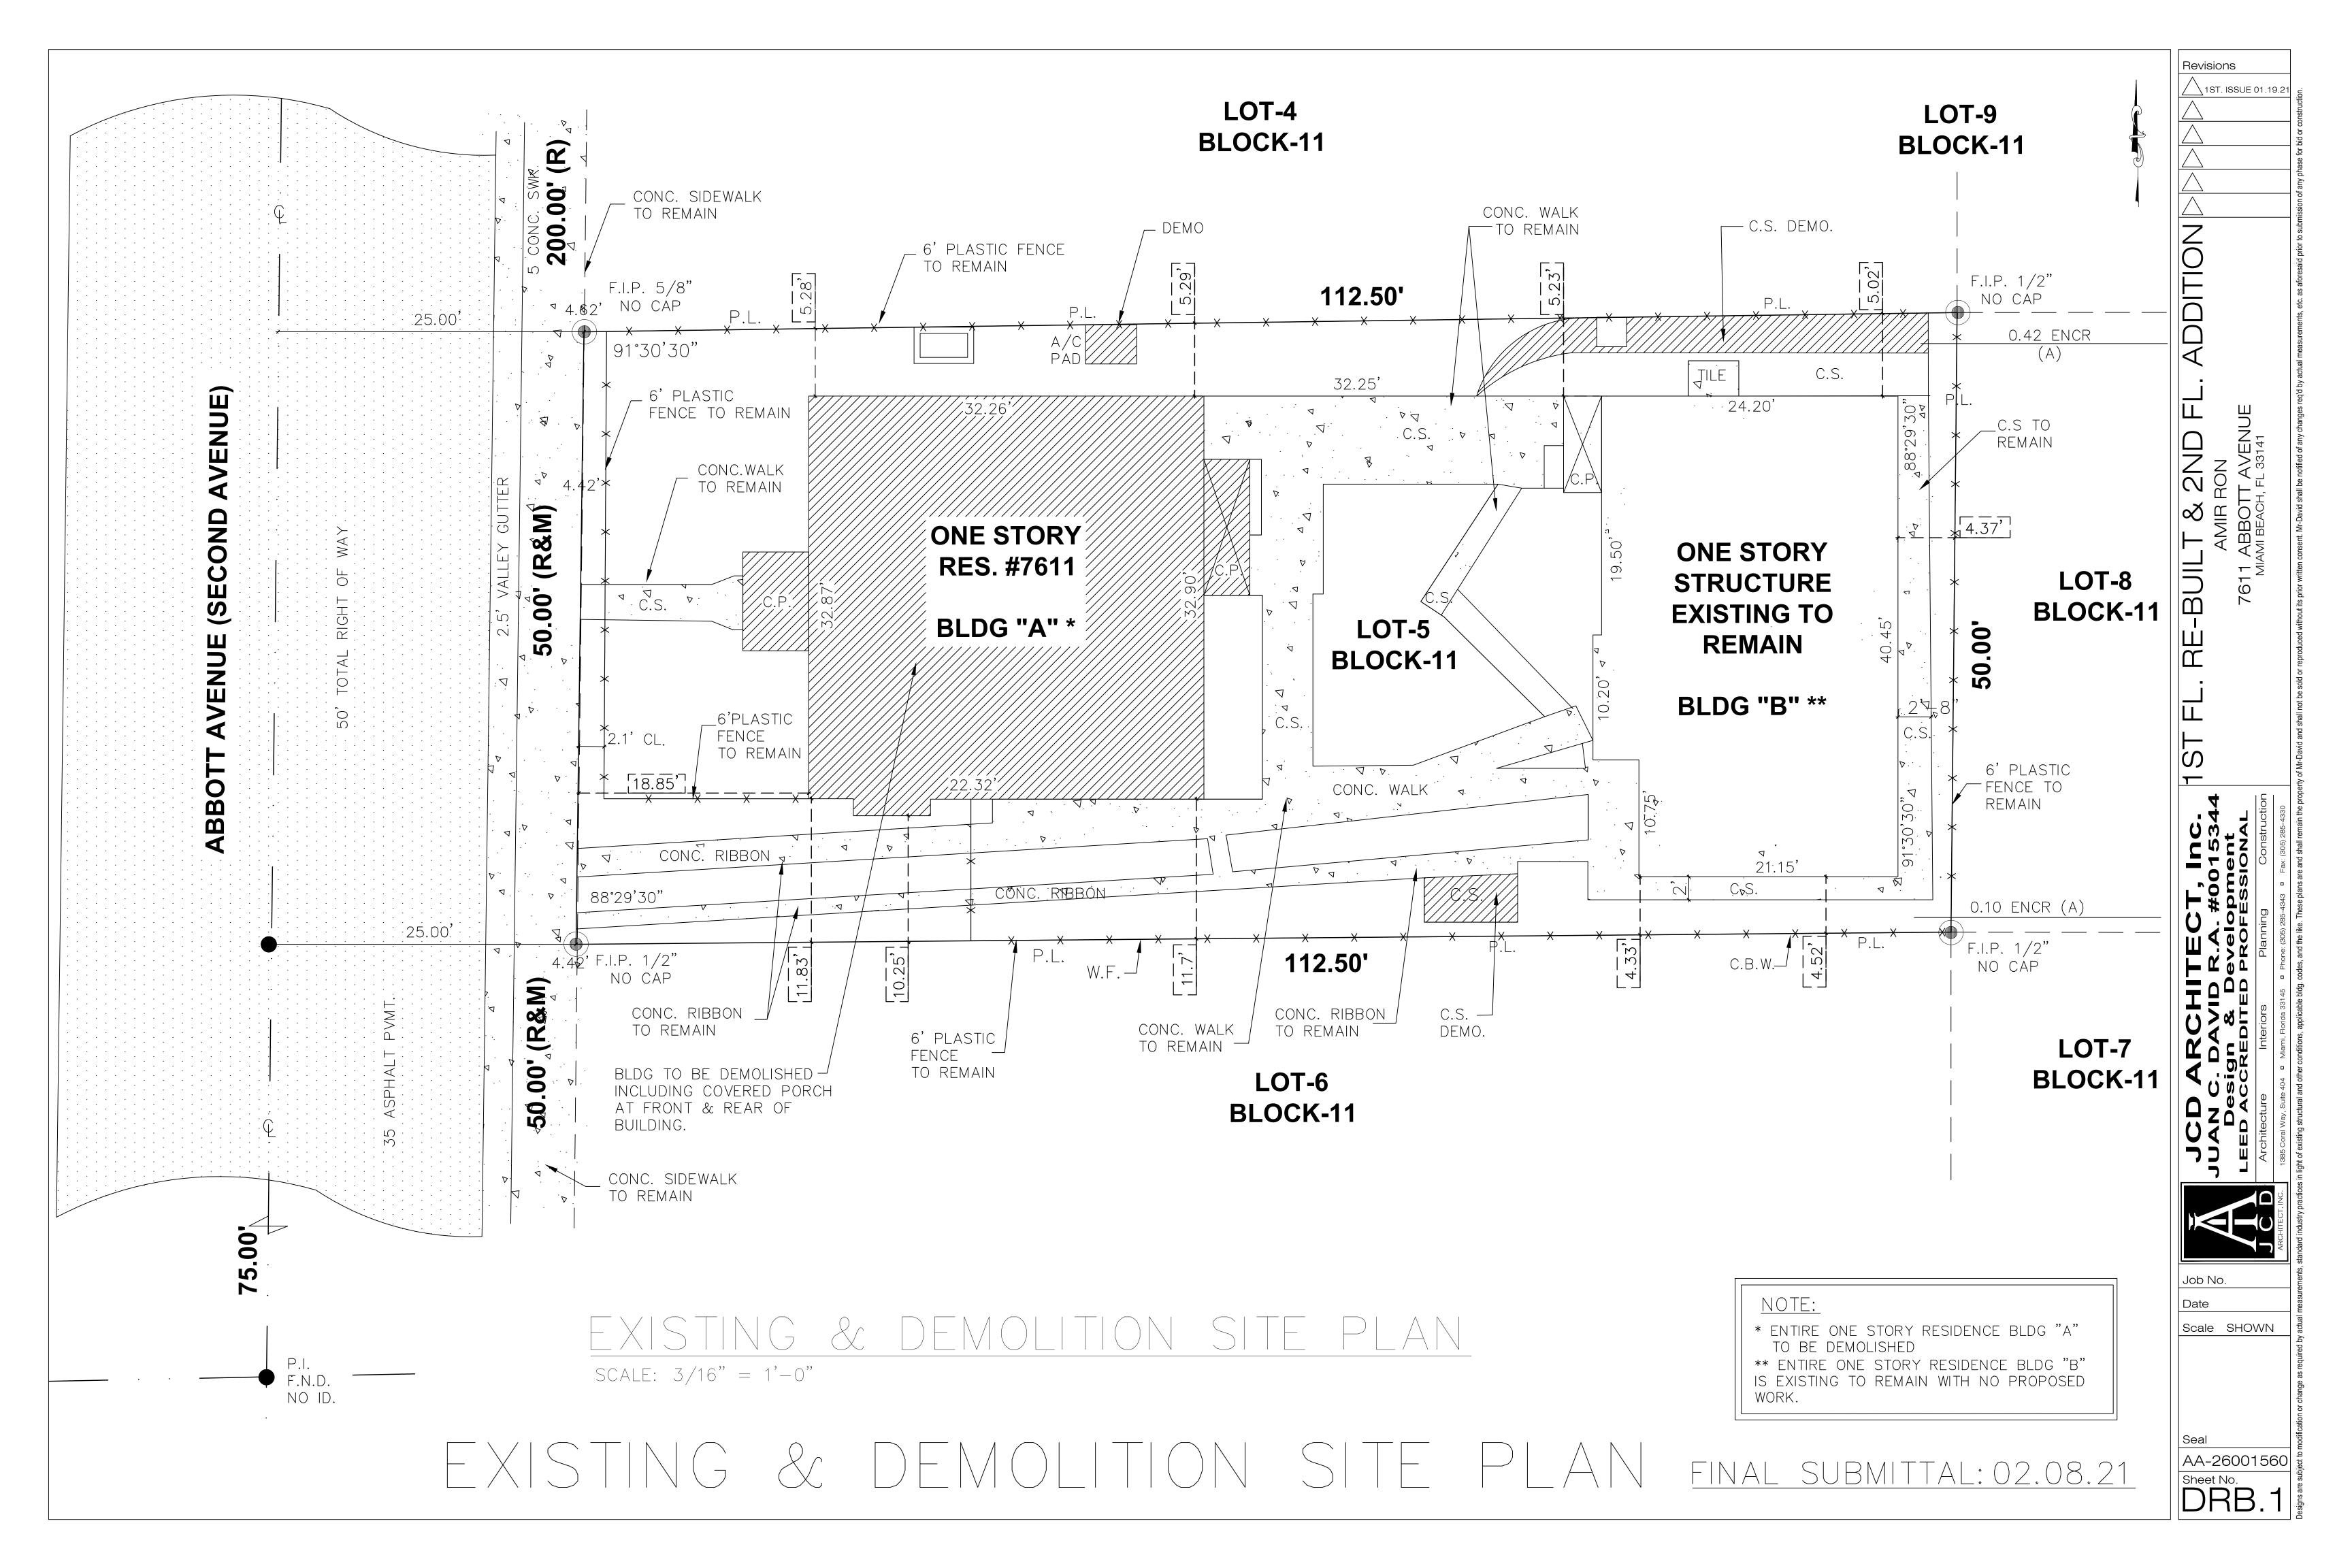

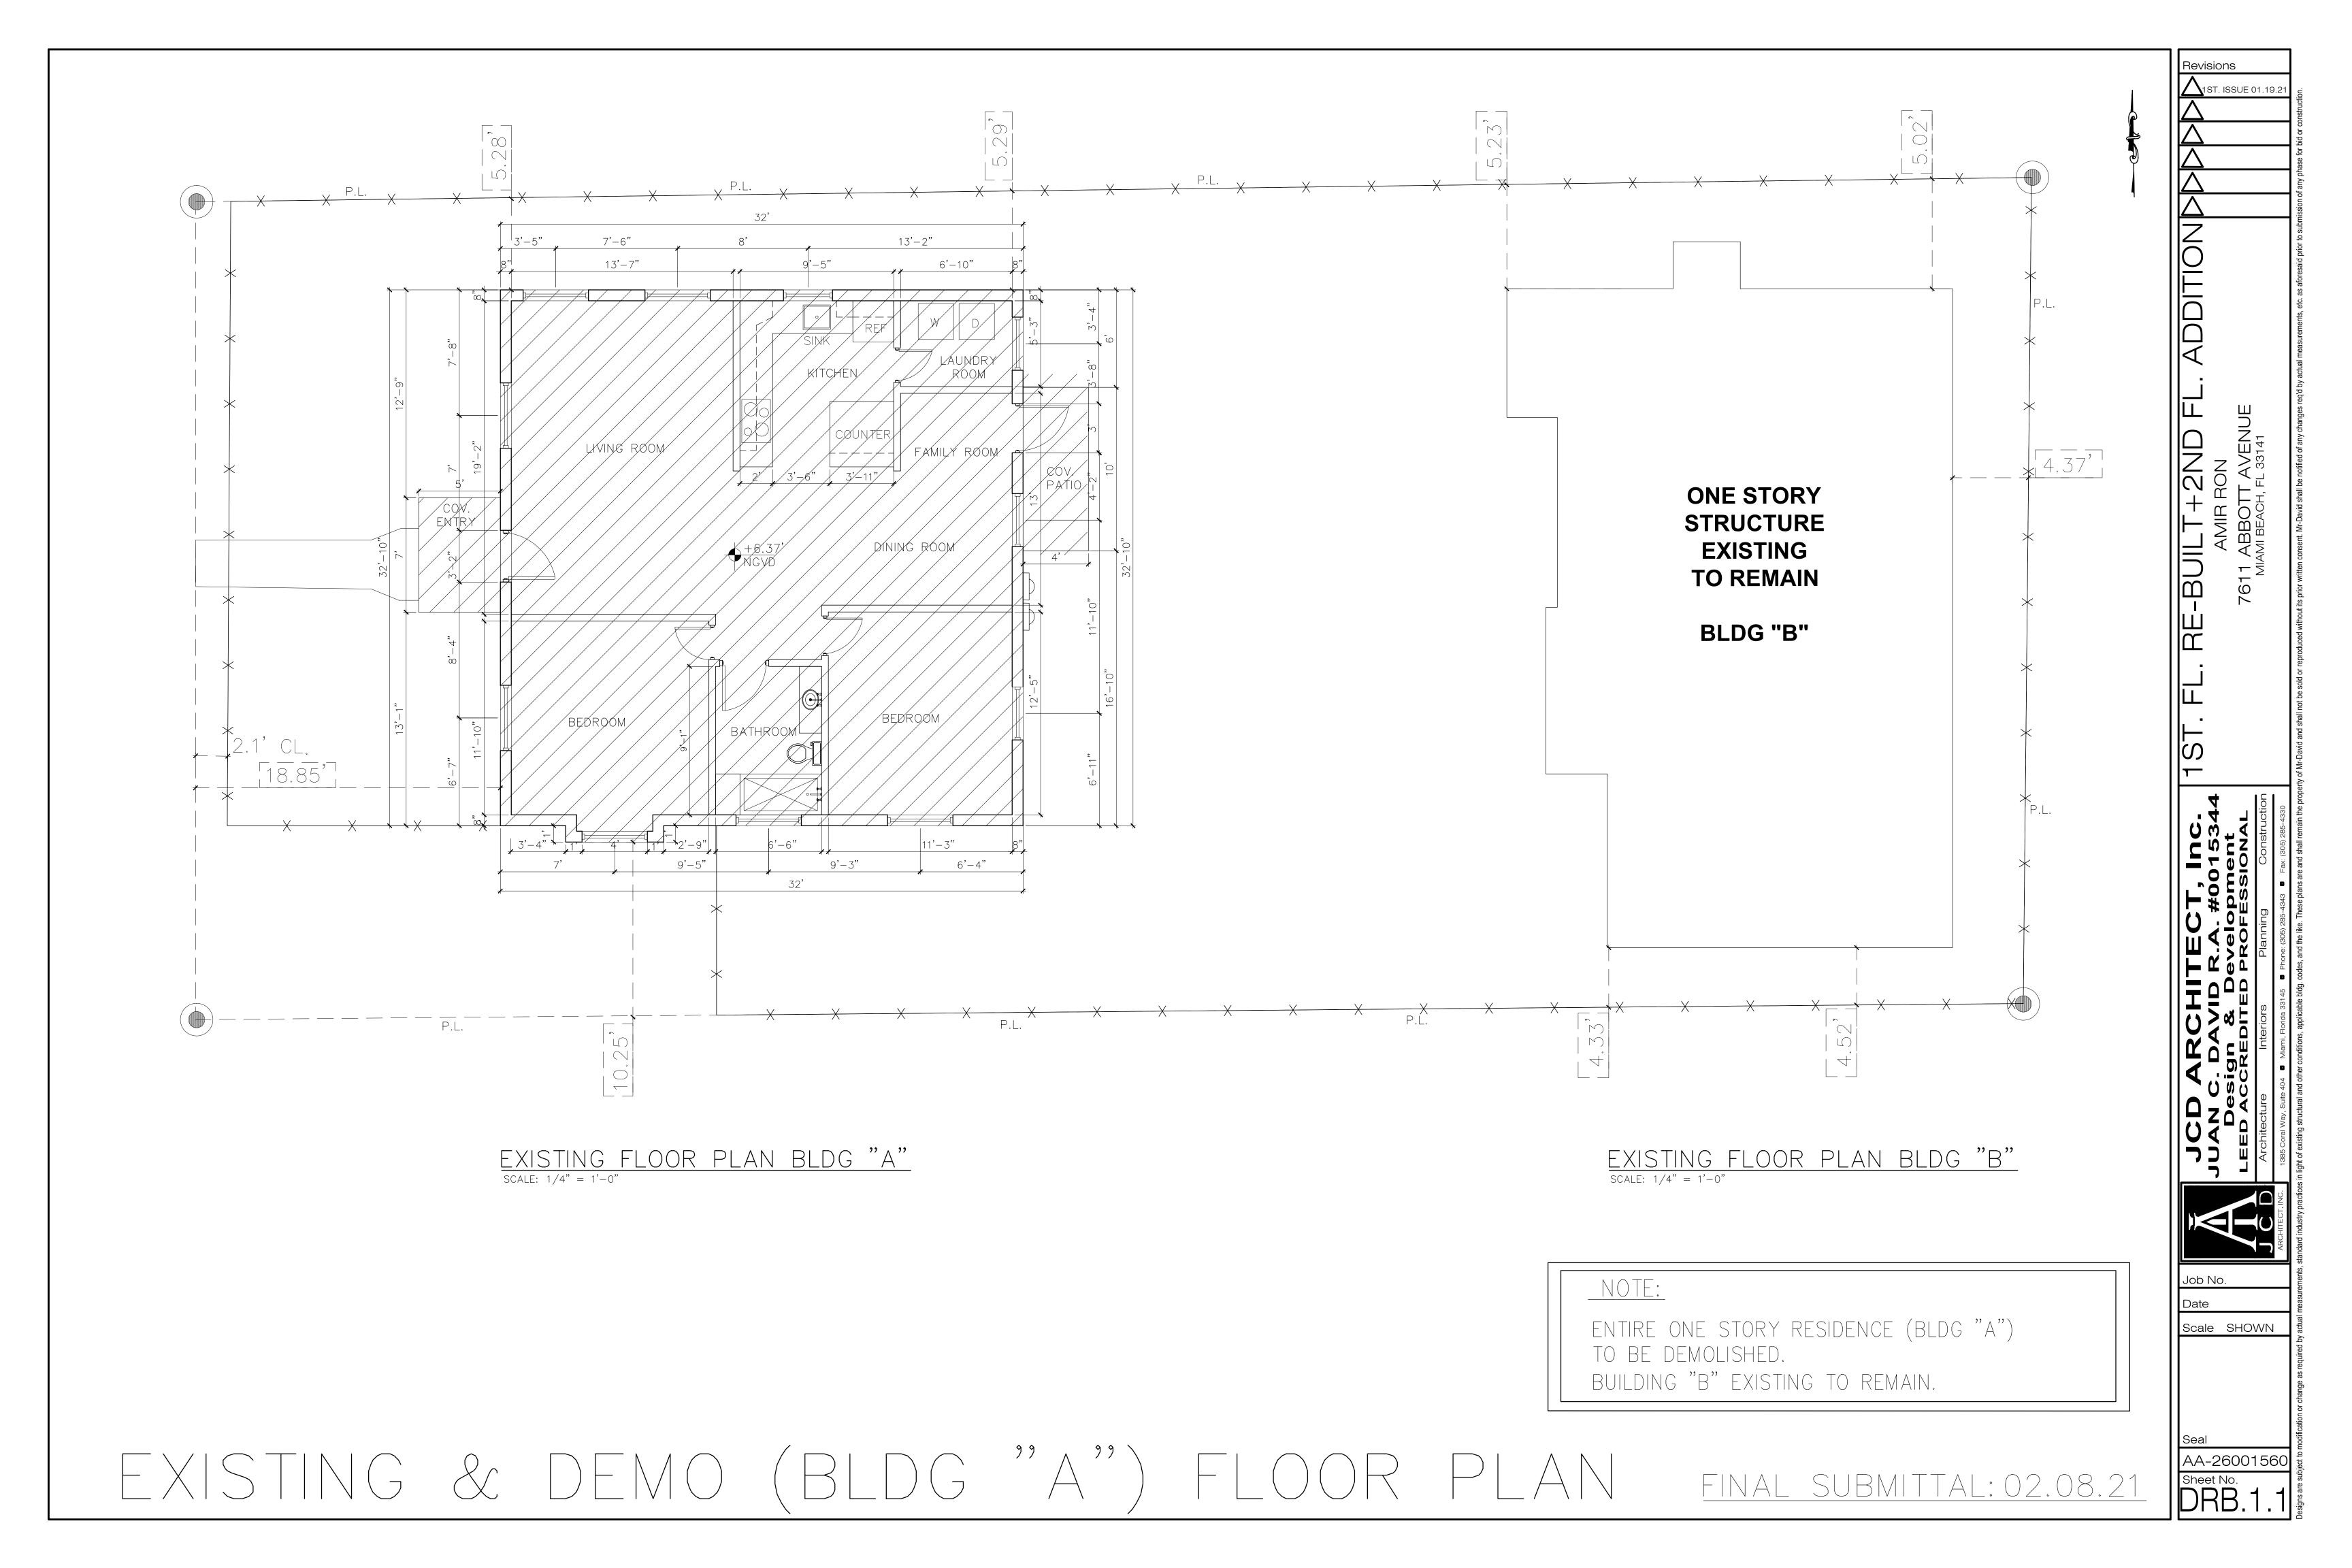

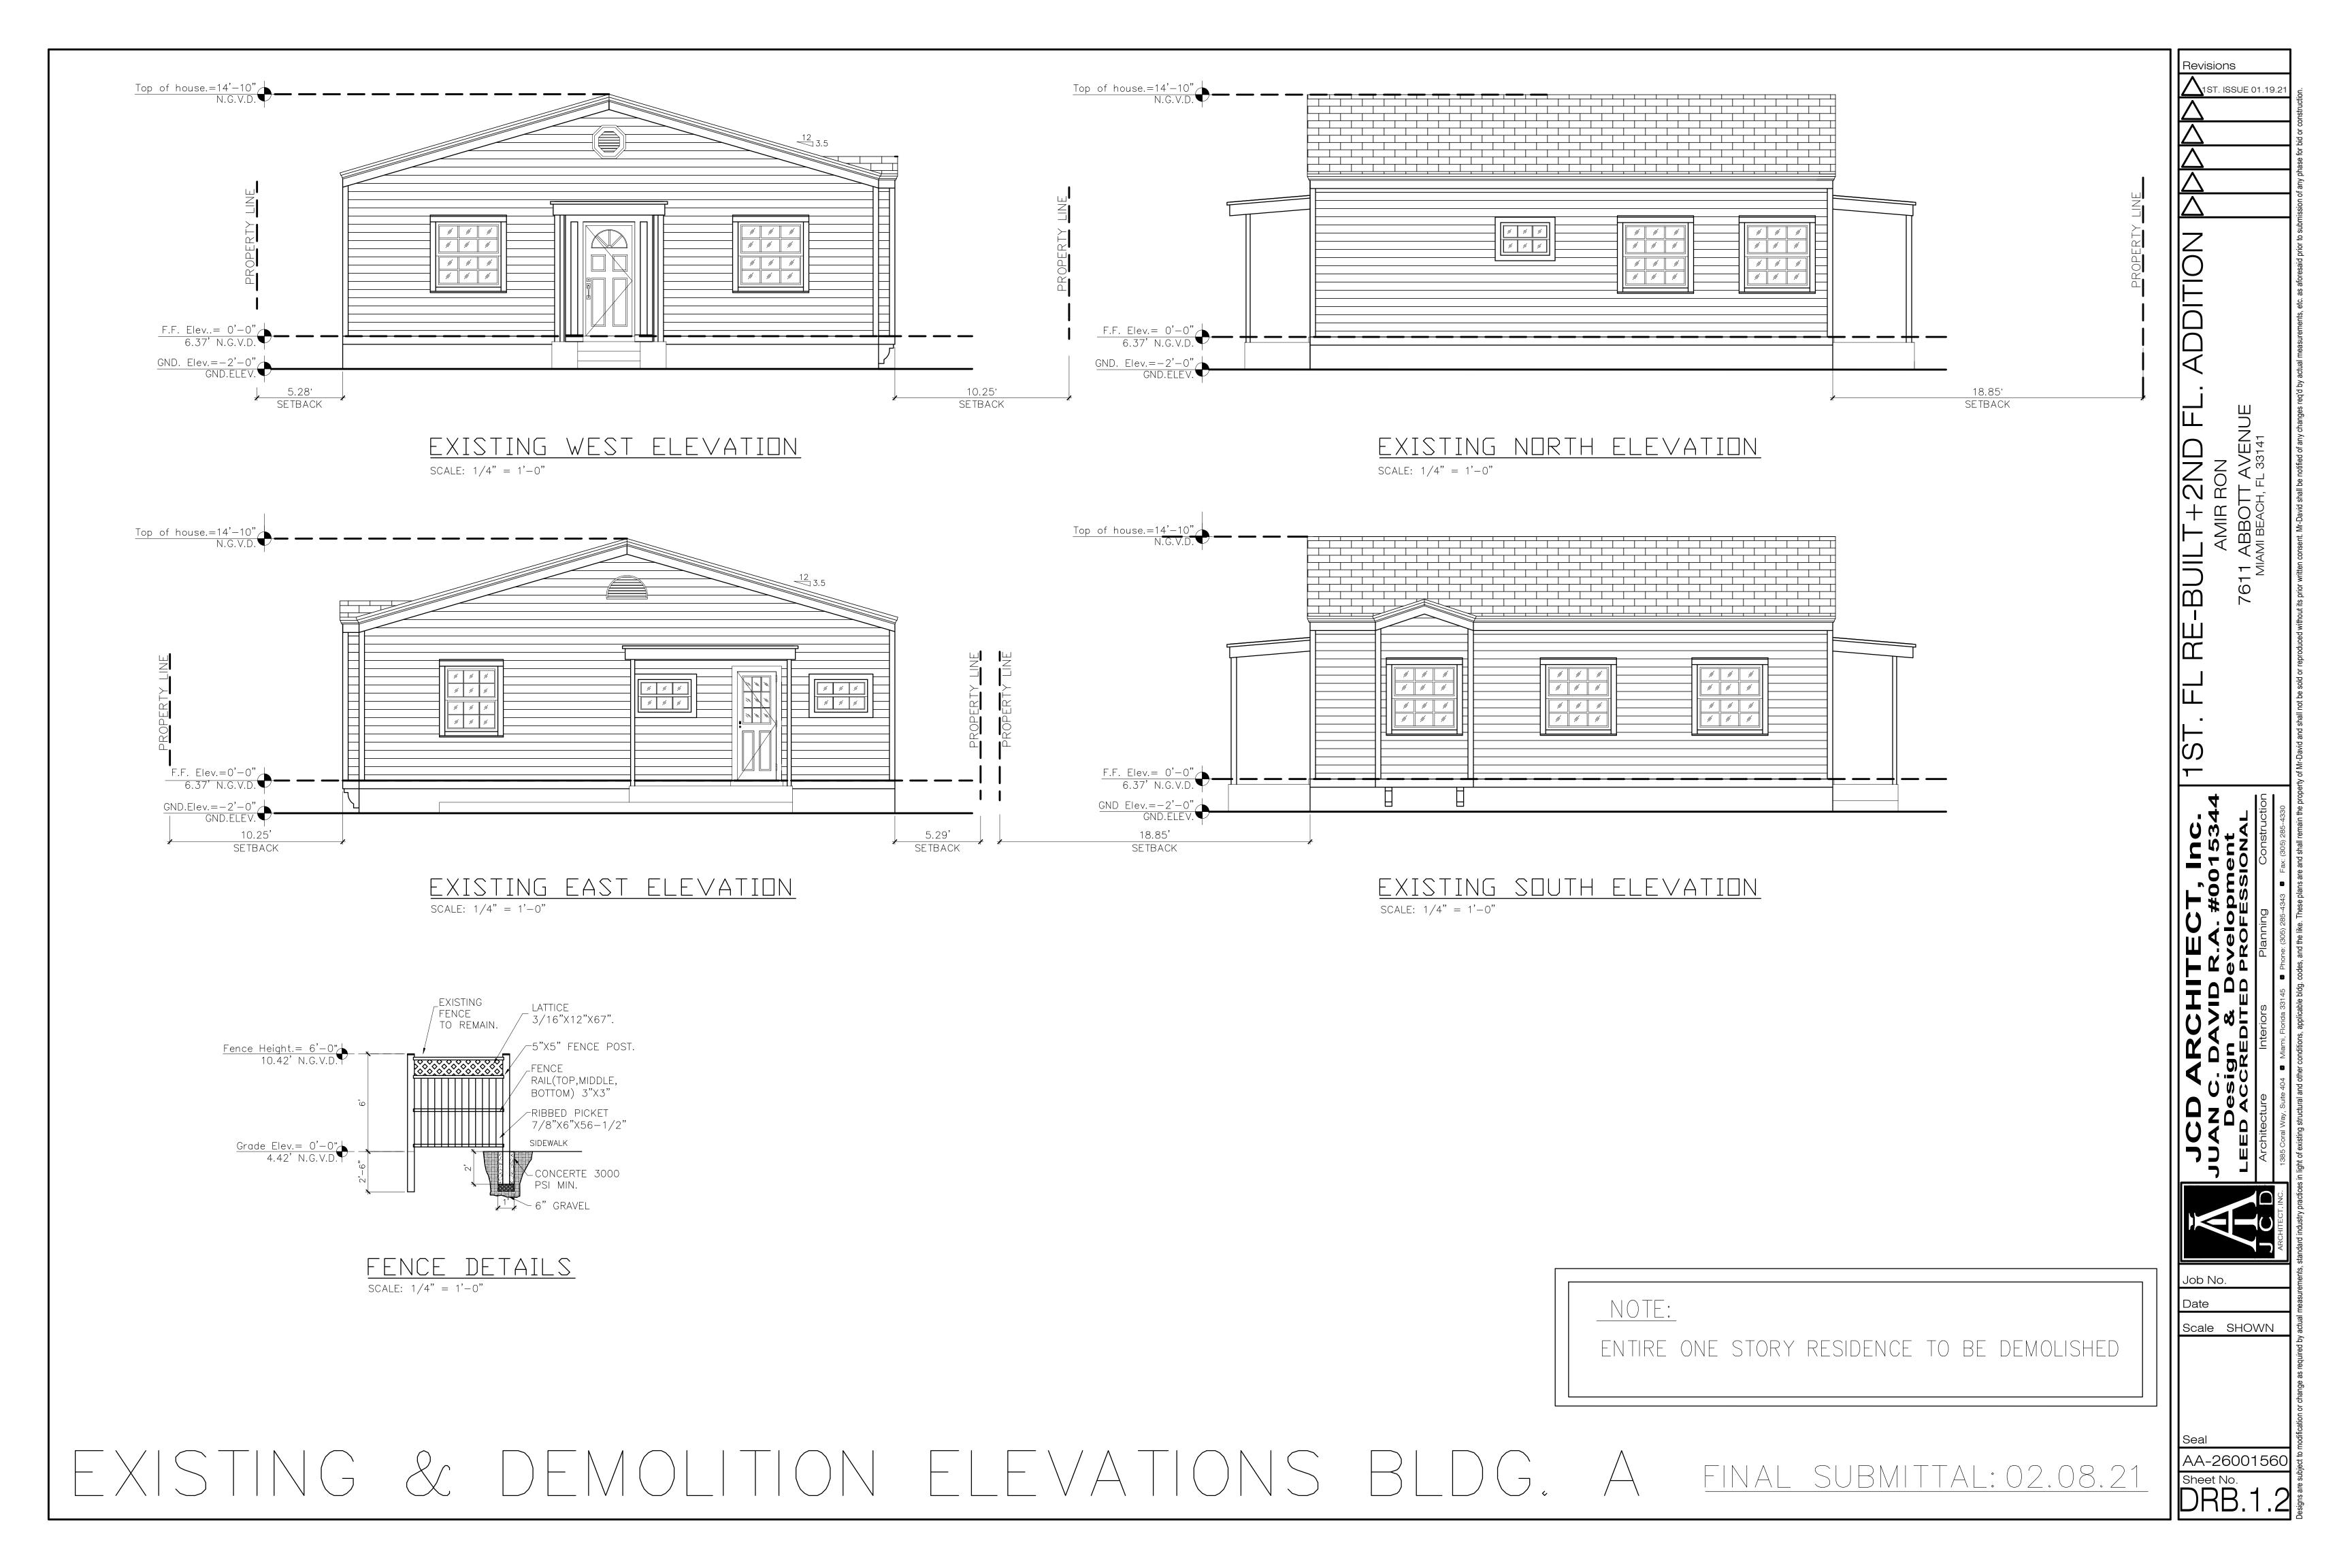

1 of 2

Planning Department, 1700 Convention Center Drive Miami Beach, Florida 33139, www.miamibeachfl.gov

MULTIFAMILY - COMMERCIAL - ZONING DATA SHEET

ITEM #	Zoning Information				
1	Address:	7611 ABBOTT AVE.			
2	Board and file numbers :	DRB20-0606			
3	Folio number(s):	02-3202-007-0700			
4	Year constructed:	1936	Zoning District:	RM-1 North Beach Nat	tional Conservation District
5	Based Flood Elevation:	+ 8.0'	Grade value in NGVD:	+ 4.67	
6	Adjusted grade (Flood+Grade/2):	+ 6.34'	Lot Area:	5,625 SF	
7	Lot width:	50.0'	Lot Depth:	112.5'	
8	Minimum Unit Size	N/A	Average Unit Size	N/A	
9	Existing use:	MULTI FAM RES	Proposed use:	MULTI FAM RES	
			-		
		Maximum	Existing	Proposed	Deficiencies
10	Height	32'	14'	23.25'	N/A
11	Number of Stories	2	1	2	N/A
12	FAR	7,031.25 S.F.	2,033 S.F.	3,103 SF	N/A
13	Gross square footage	N/A			
14	Square Footage by use	N/A			
15	Number of units Residential	N/A			
16	Number of units Hotel	N/A			
17	Number of seats	N/A			
18	Occupancy load	N/A			
	Setbacks	Required	Existing	Proposed	Deficiencies
	Subterranean:				
19	Front Setback:	N/A			
20	Side Setback:	N/A			
21	Side Setback:	N/A			
22	Side Setback facing street:	N/A			
23	Rear Setback:	N/A			
	At Grade Parking:				
24	Front Setback:	N/A			
25	Side Setback:	N/A			
26	Side Setback:	N/A			
27	Side Setback facing street:	N/A			
28	Rear Setback:	N/A			
	Pedestal:				
29	Front Setback:	20'	18.85'	20'	N/A
30	Side Setback:	5'	10.25'	10.75'	N/A
31	Side Setback:	5'	5.29'	5.29'	N/A
32	Side Setback facing street:	N/A	N/A	N/A	N/A
33	Rear Setback:	20'	59.30'	58.00'	N/A
	Tower:				
34	Front Setback:	N/A			
35	Side Setback:	N/A			
ITEM #	Setbacks	Required	Existing	Proposed	Deficiencies
36	Side Setback:	N/A			
		31/4			
37	Side Setback facing street:	N/A			

MAMIBEACH

2 of 2

Planning Department, 1700 Convention Center Drive Miami Beach, Florida 33139, www.miamibeachfl.gov


	Parking	Required	Existing	Proposed	Deficiencies
39	Parking district	N/A			
40	Total # of parking spaces	N/A			
41	# of parking spaces per use (Provide a separate chart for a breakdown calculation)	N/A			
42	# of parking spaces per level (Provide a separate chart for a breakdown calculation)	N/A			
43	Parking Space Dimensions	N/A			
44	Parking Space configuration (450,600,900,Parallel)	N/A			
45	ADA Spaces	N/A			
46	Tandem Spaces	N/A			
47	Drive aisle width	N/A			
48	Valet drop off and pick up	N/A			
49	Loading zones and Trash collection areas	N/A			
50	racks	N/A			

	Restaurants, Cafes, Bars, Lounges, Nightclubs	Required	Existing	Proposed	Deficiencies
51	Type of use	N/A			
52	Total # of seats	N/A			
53	Total # of seats per venue (Provide a separate chart for a breakdown calculation)	N/A			
54	Total occupant content	N/A			
55	Occupant content per venue (Provide a separate chart for a breakdown calculation)	N/A			
56	Is this a contributing building?		Yes o	r no	
57	Located within a Local Historic District?		Yes o	r no	

Notes:

If not applicable write N/A

All other data information may be required and presented like the above format.

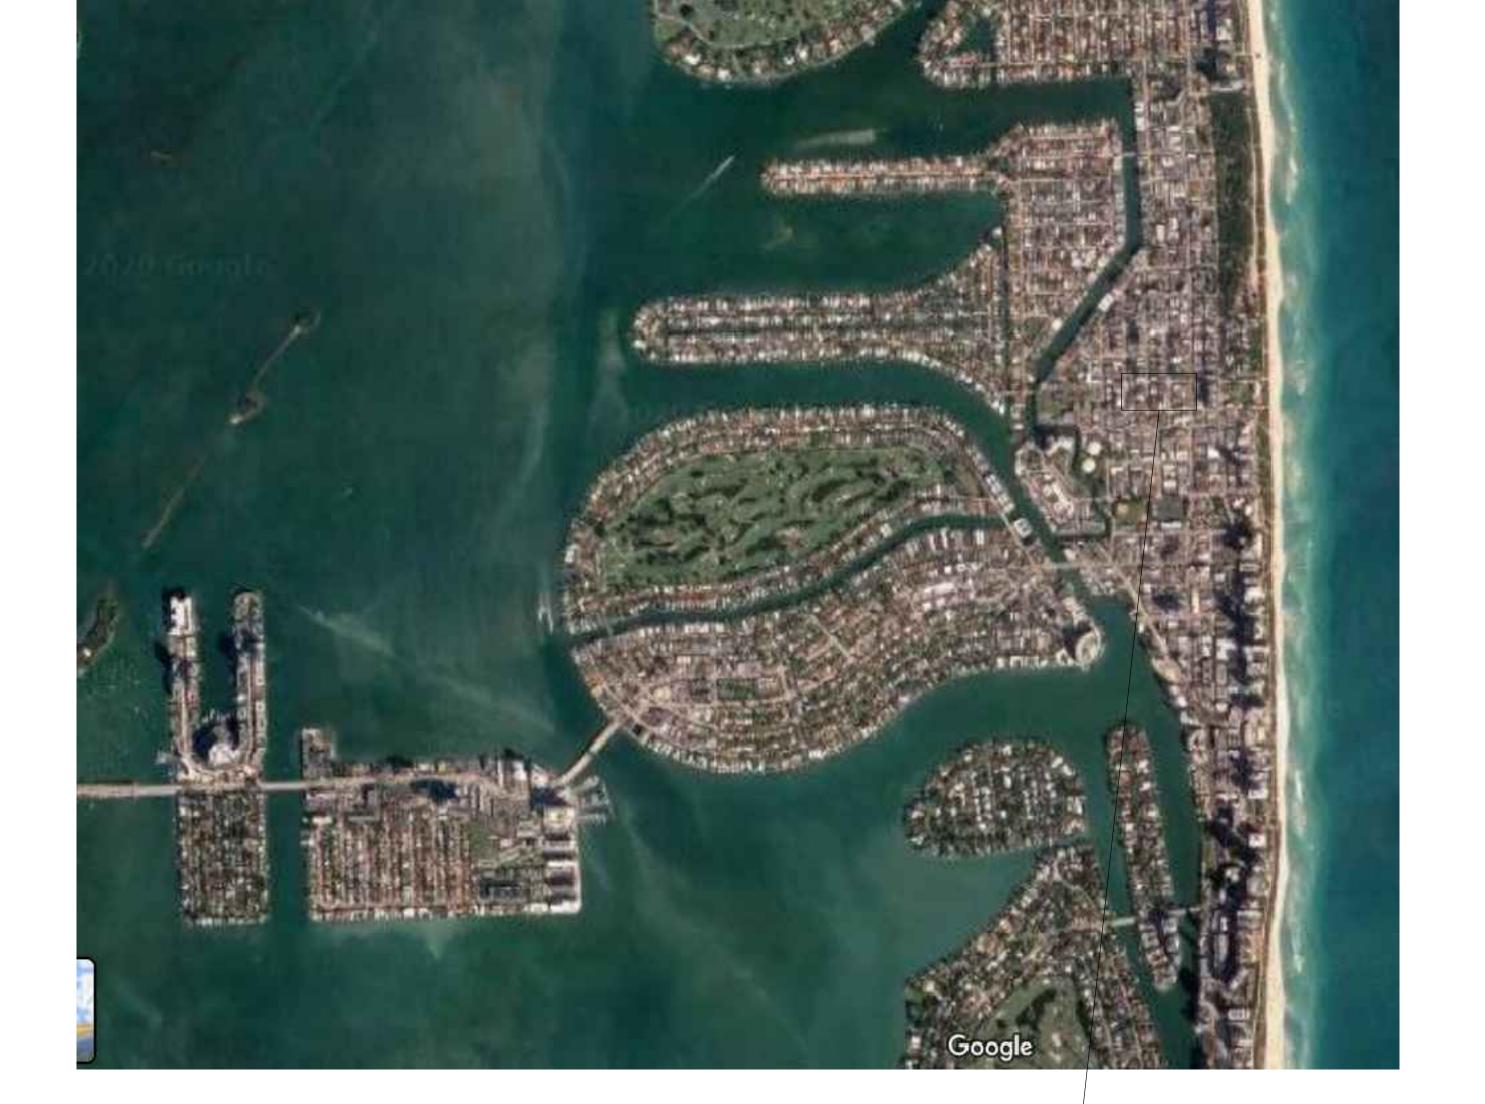

LAREA OF WORK

LOCATION PLAN (AERIAL 1/2 RADIUS)
N.T.S.

OCATION PLAN & ZONING INFO FINAL SUBMITTAL: 02.08.21

FL. RE-BUILT & 2ND FL. ADDITION PP

1ST. ISSUE 01.19.2

ARCHITECT, Inc.

2. DAVID R.A. #00153

sign & Development

scredited Professional

JU C D Ar Architect, INC.

Job No.

Date

Scale SHOWN

eal

AA-26001560
Sheet No.
DRB.2



SUBJECT PROPERTY—

ENLARGED LOCATION PLAN



SUBJECT PROPERTY —

ADJACENT PROPERTIES

LOCATION MAP

FINAL SUBMITTAL: 02.08.21

FL. RE-BUILT & 2ND FL. ADDITION PPP PP AMIR RON 7611 ABBOTT AVENUE

JCD ARCHITECT, Inc JUAN C. DAVID R.A. #00153 Design & Development LEED ACCREDITED PROFESSIONA


ARCHITECT, INC. 138


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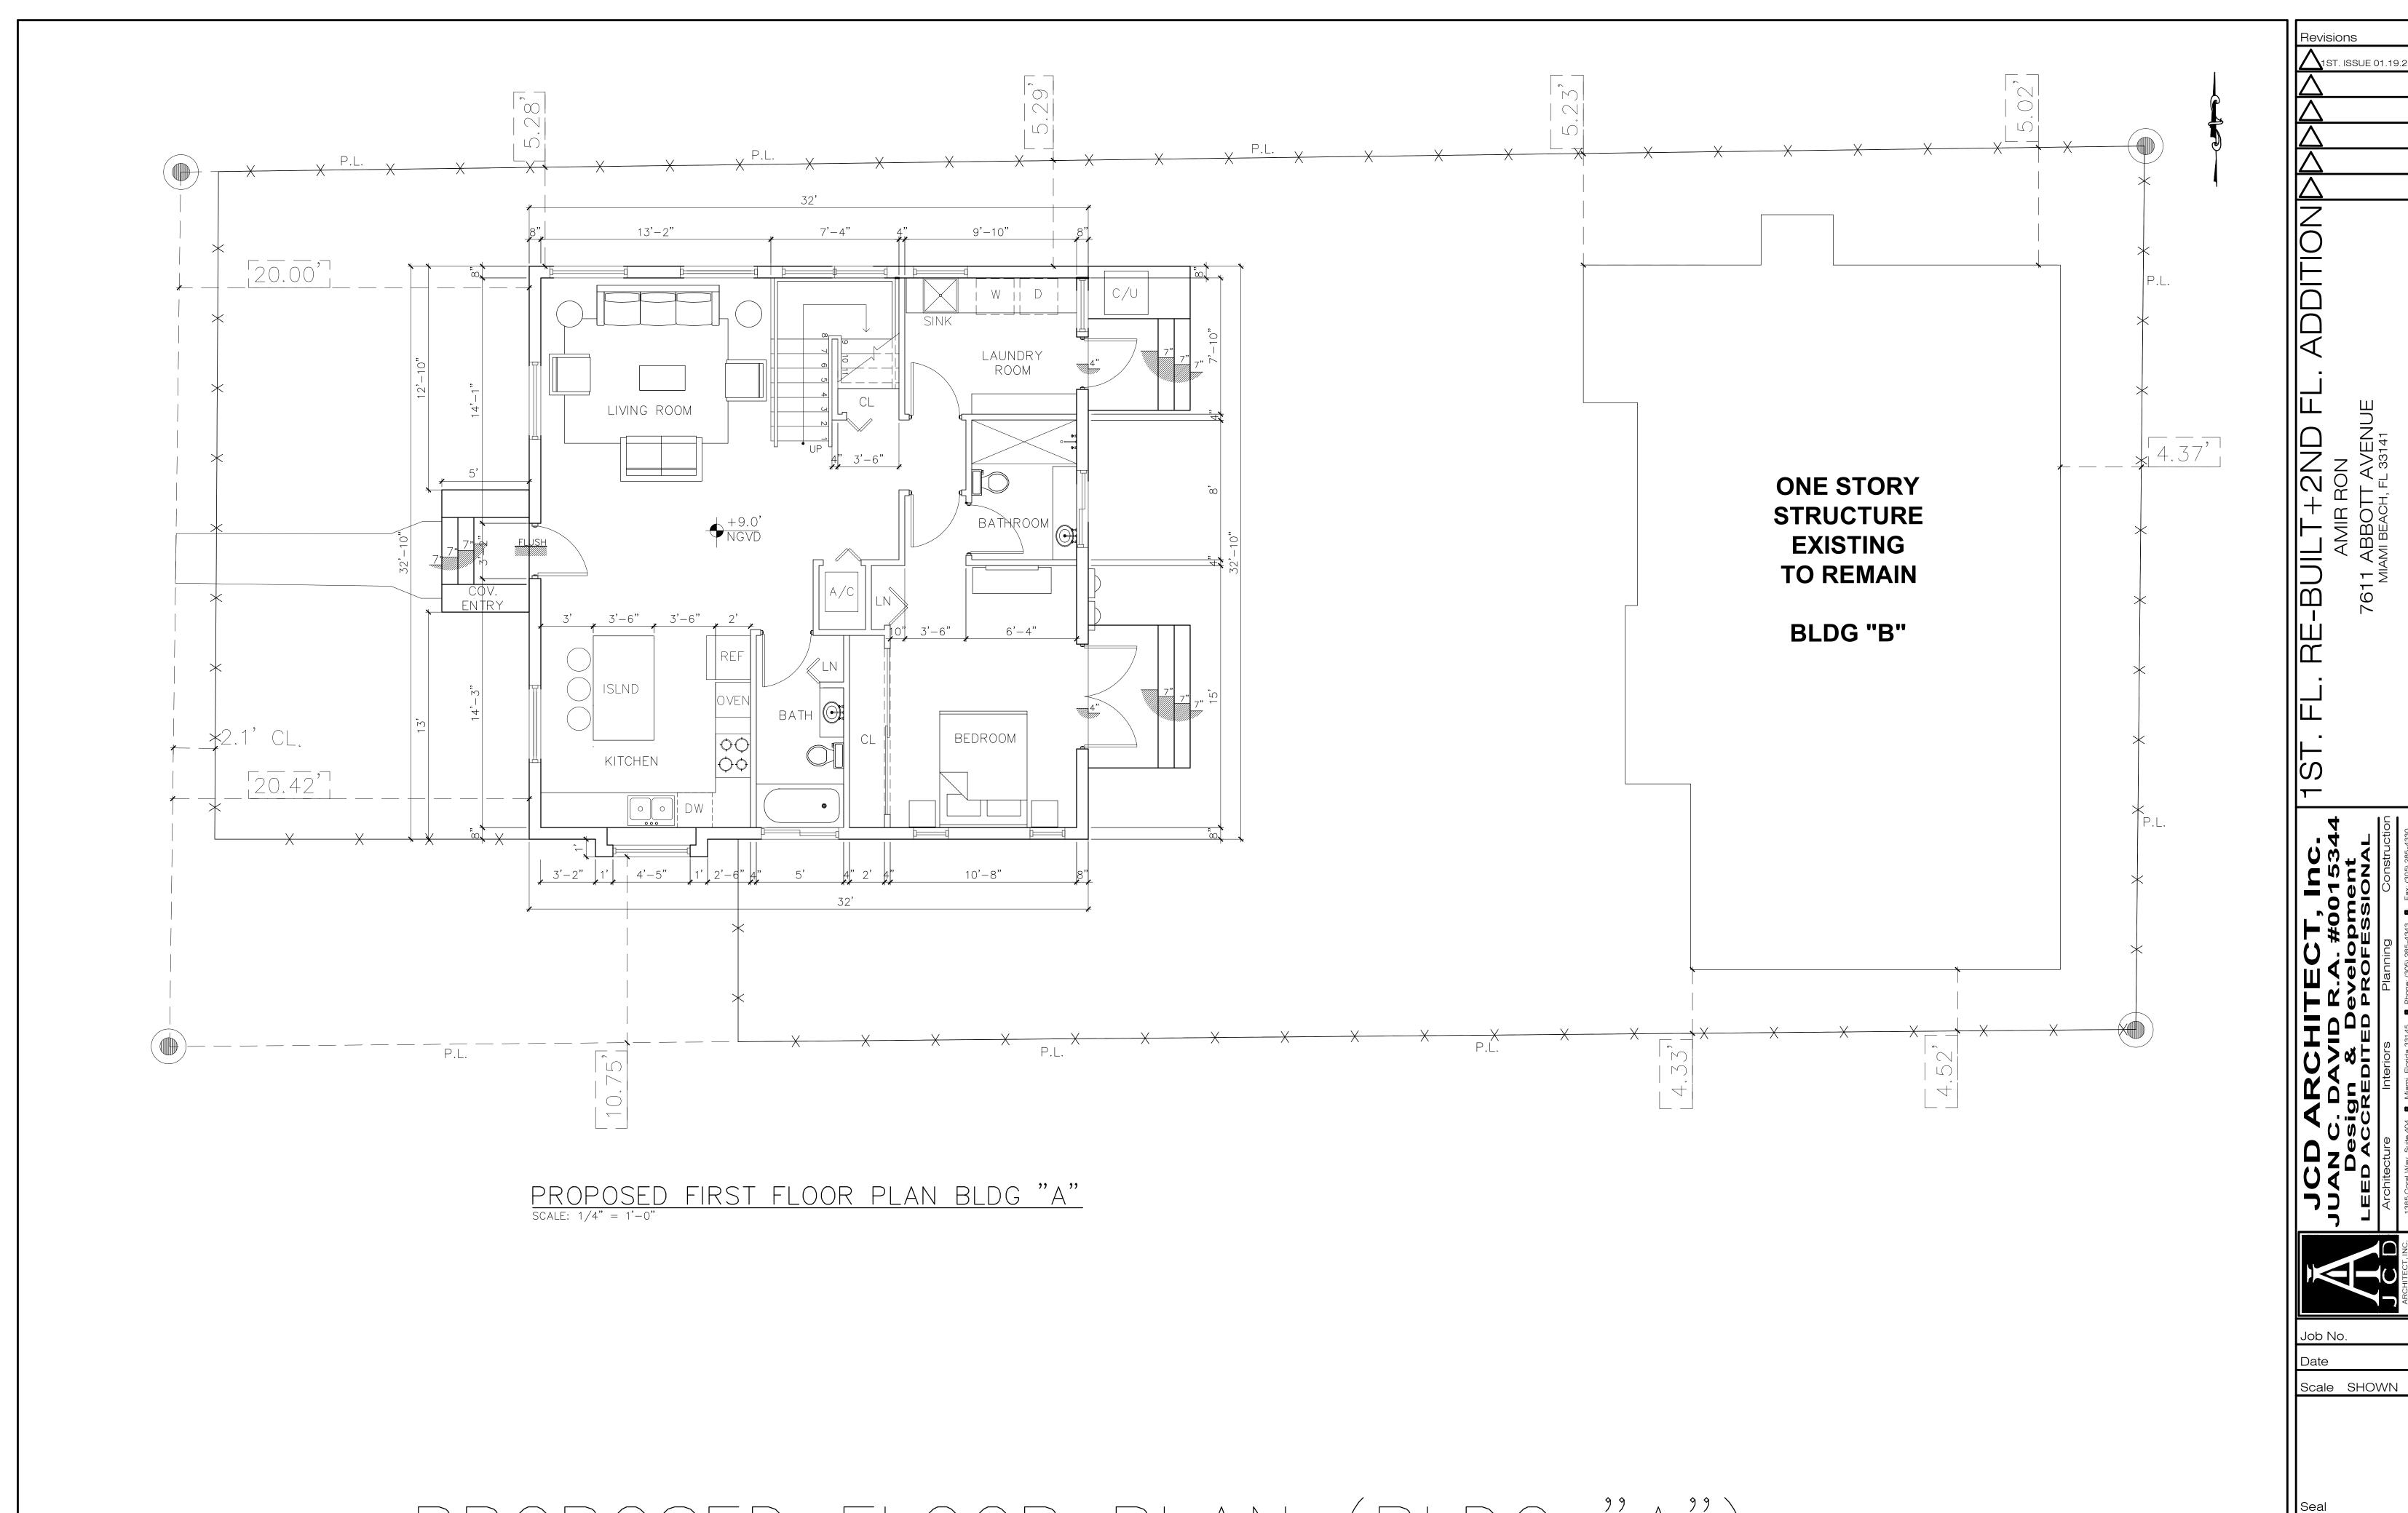
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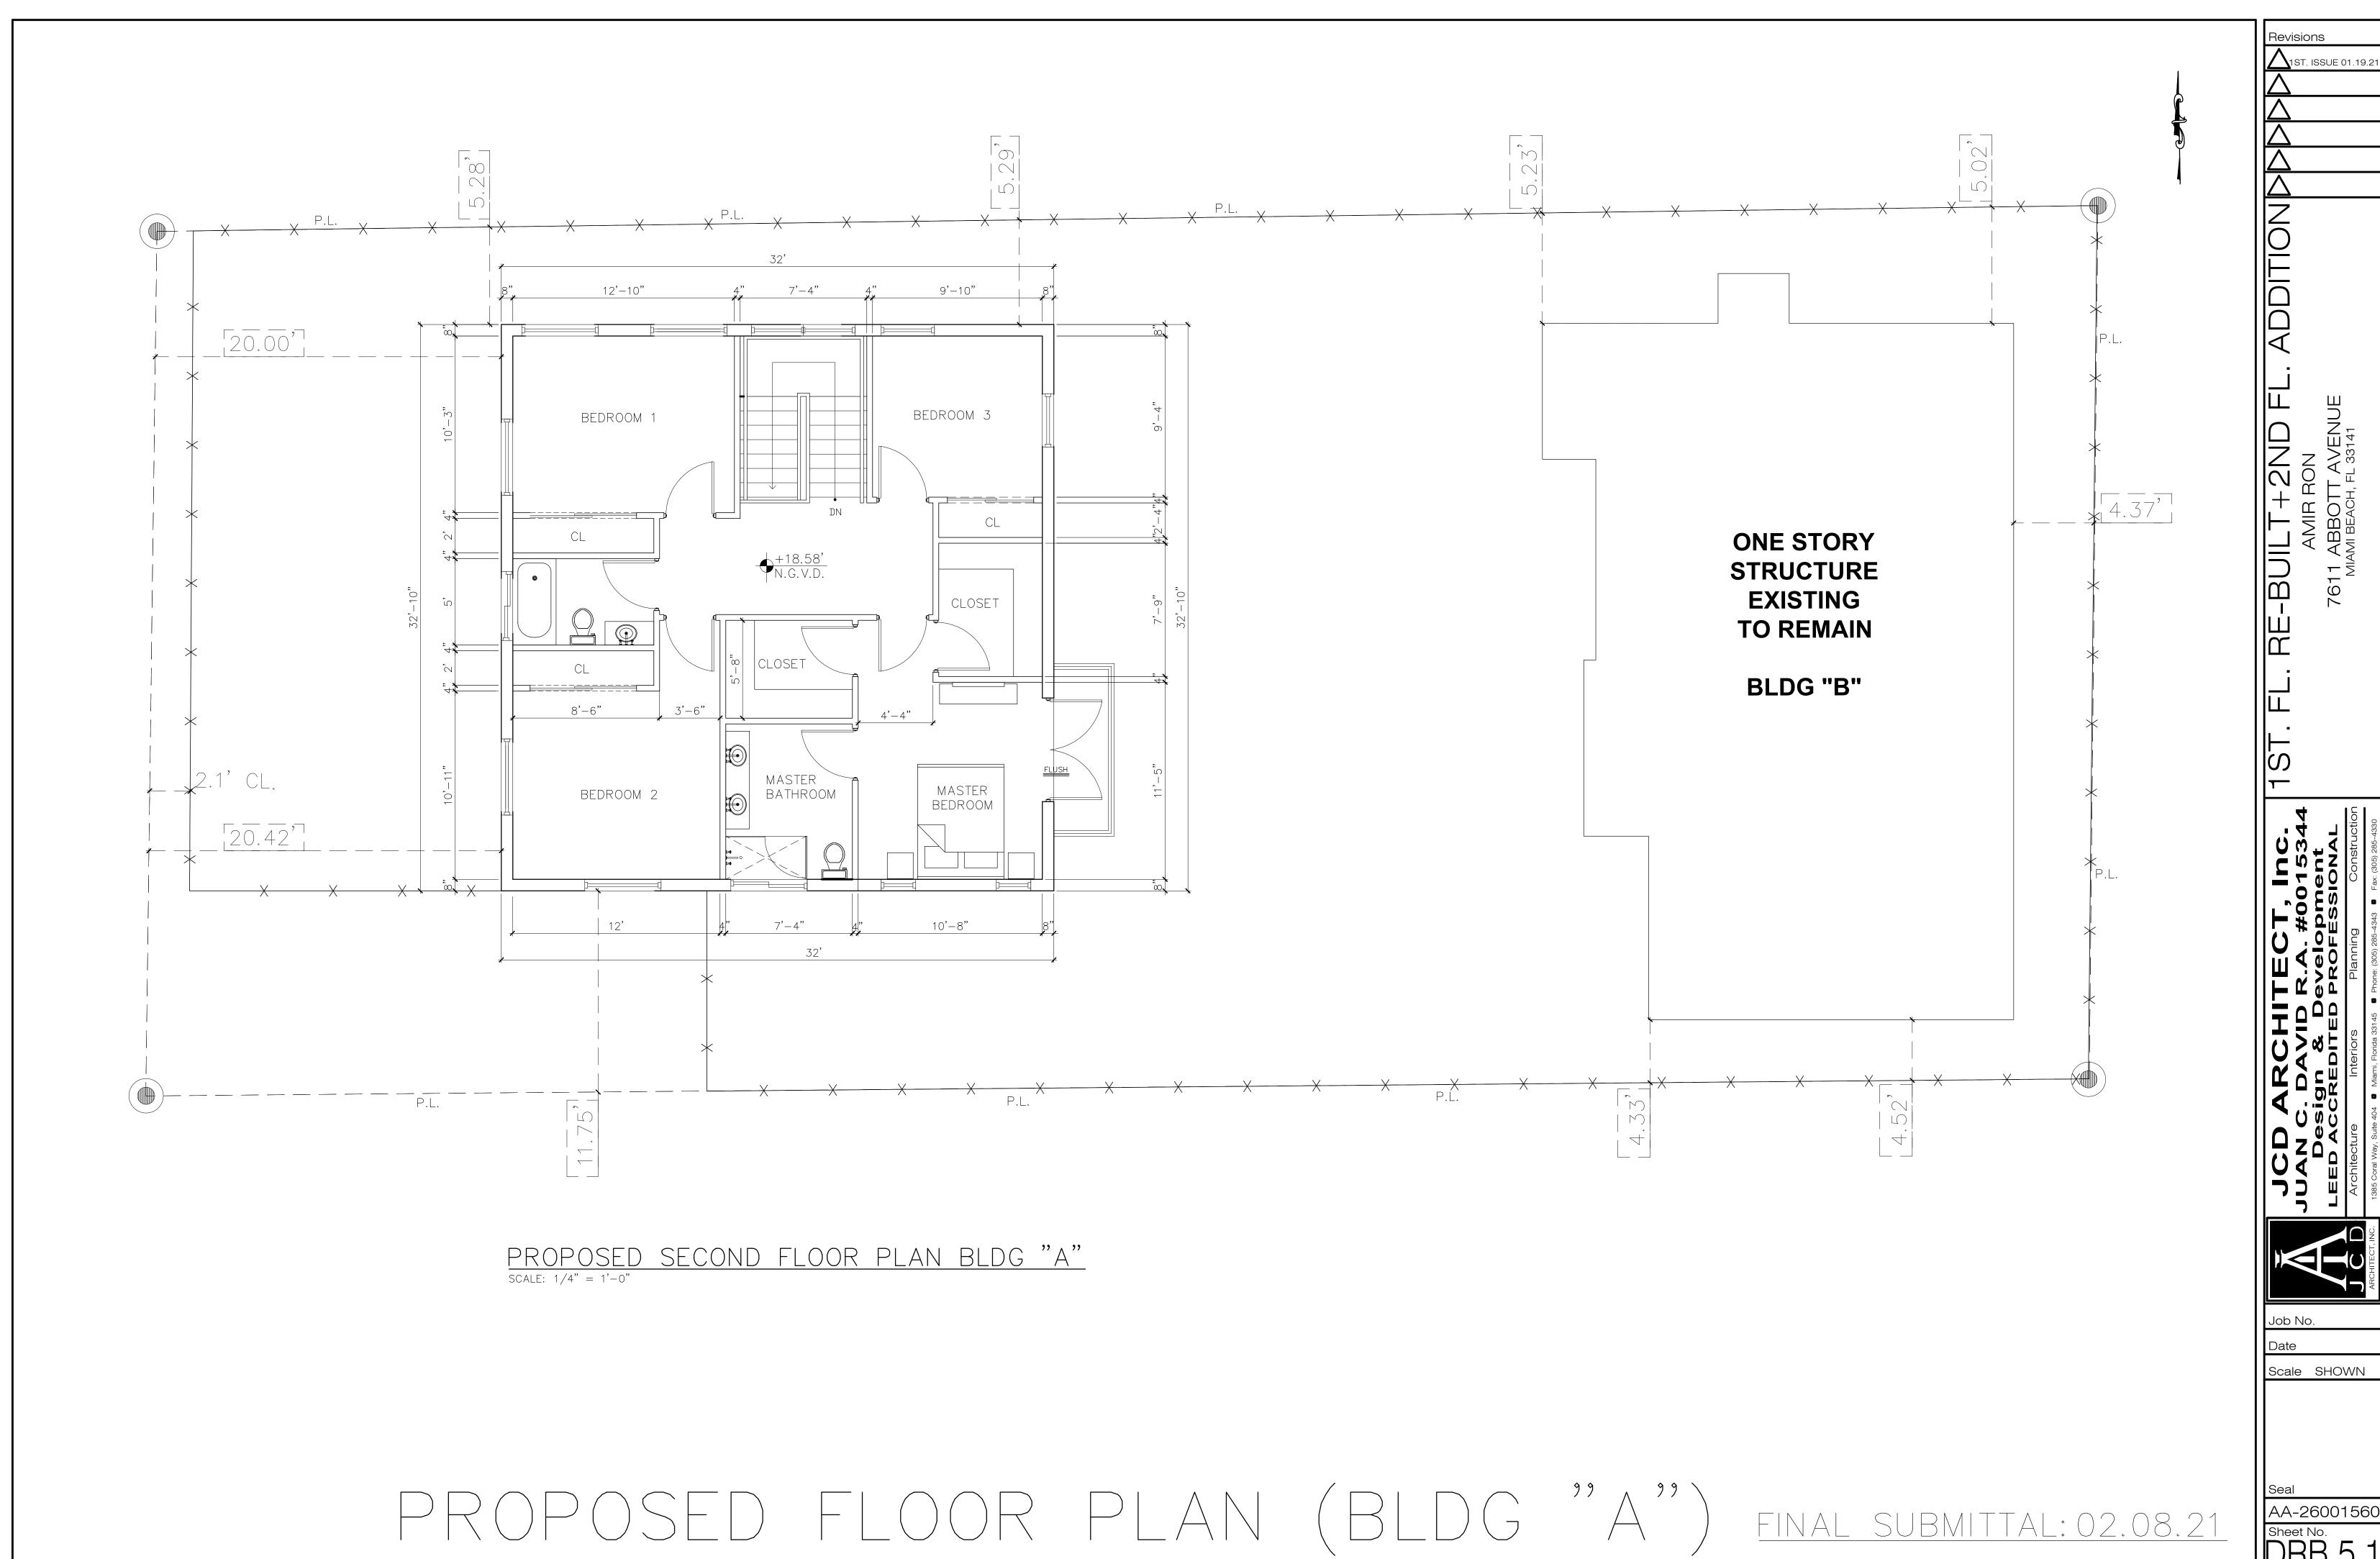
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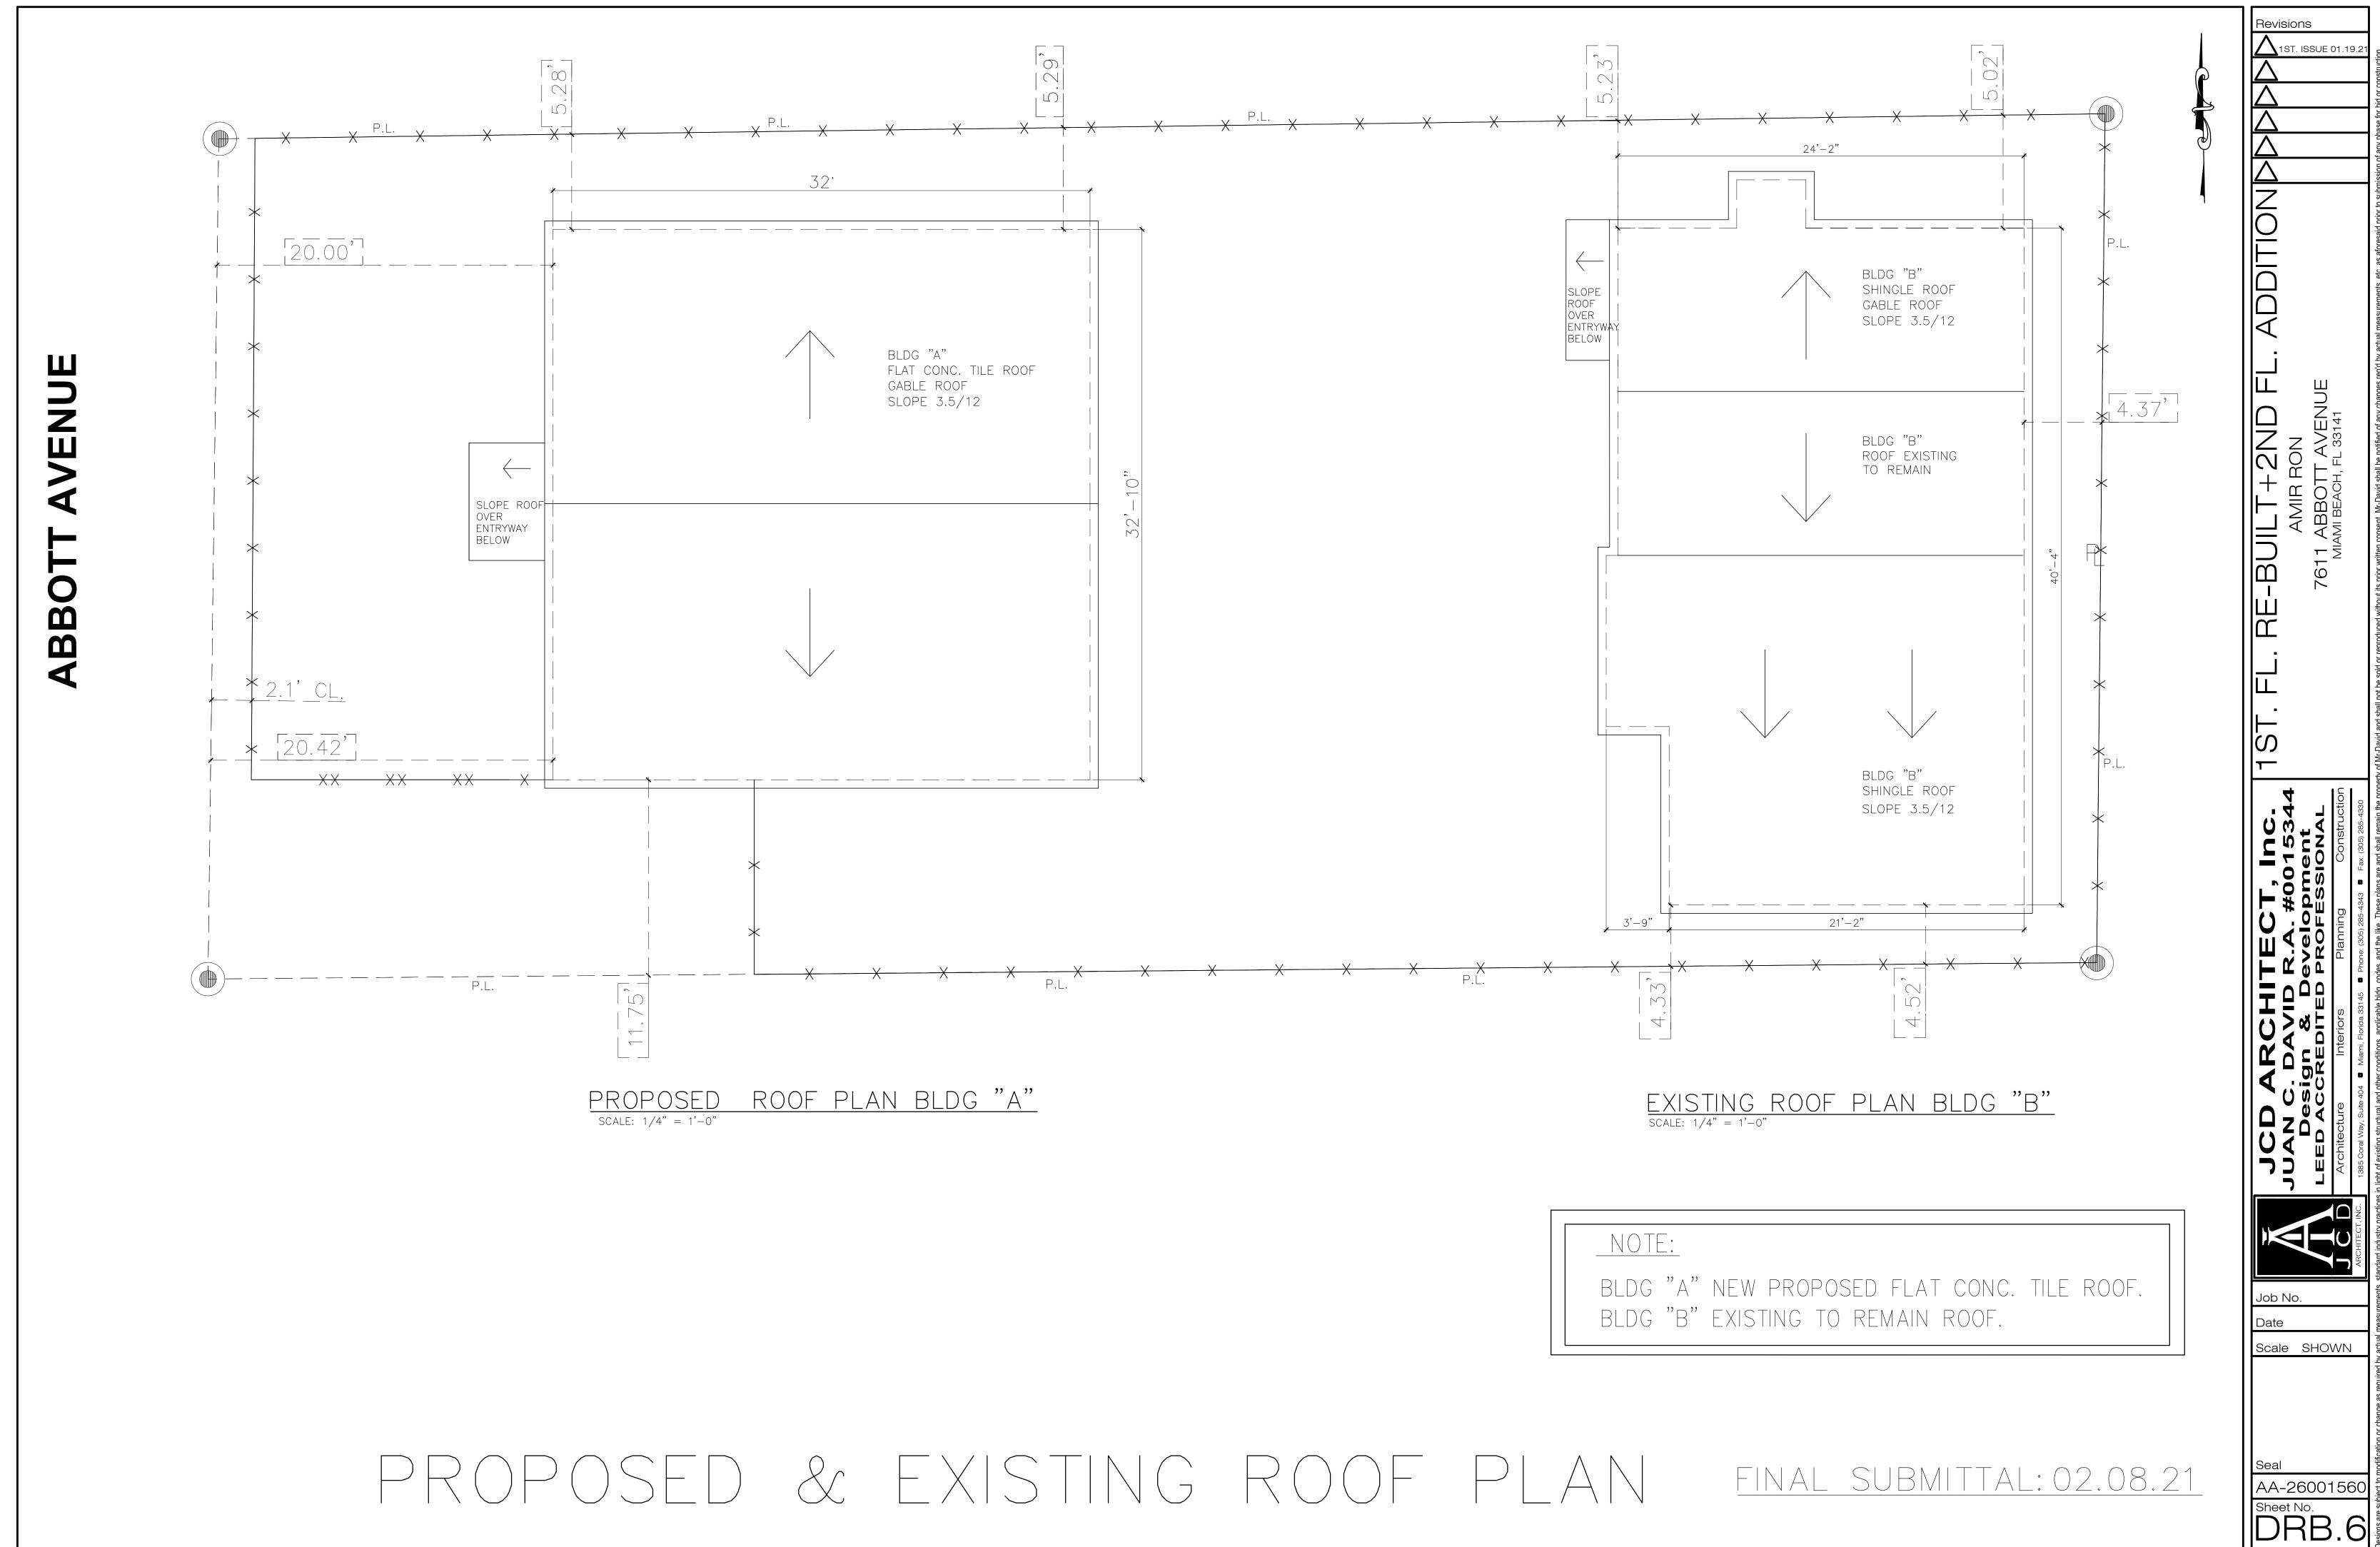




PROPOSED FLOOR PLAN (BLDG "A") FINAL SUBMITTAL: 02.08.21 AA-26001560 Sheet No. DRB.5

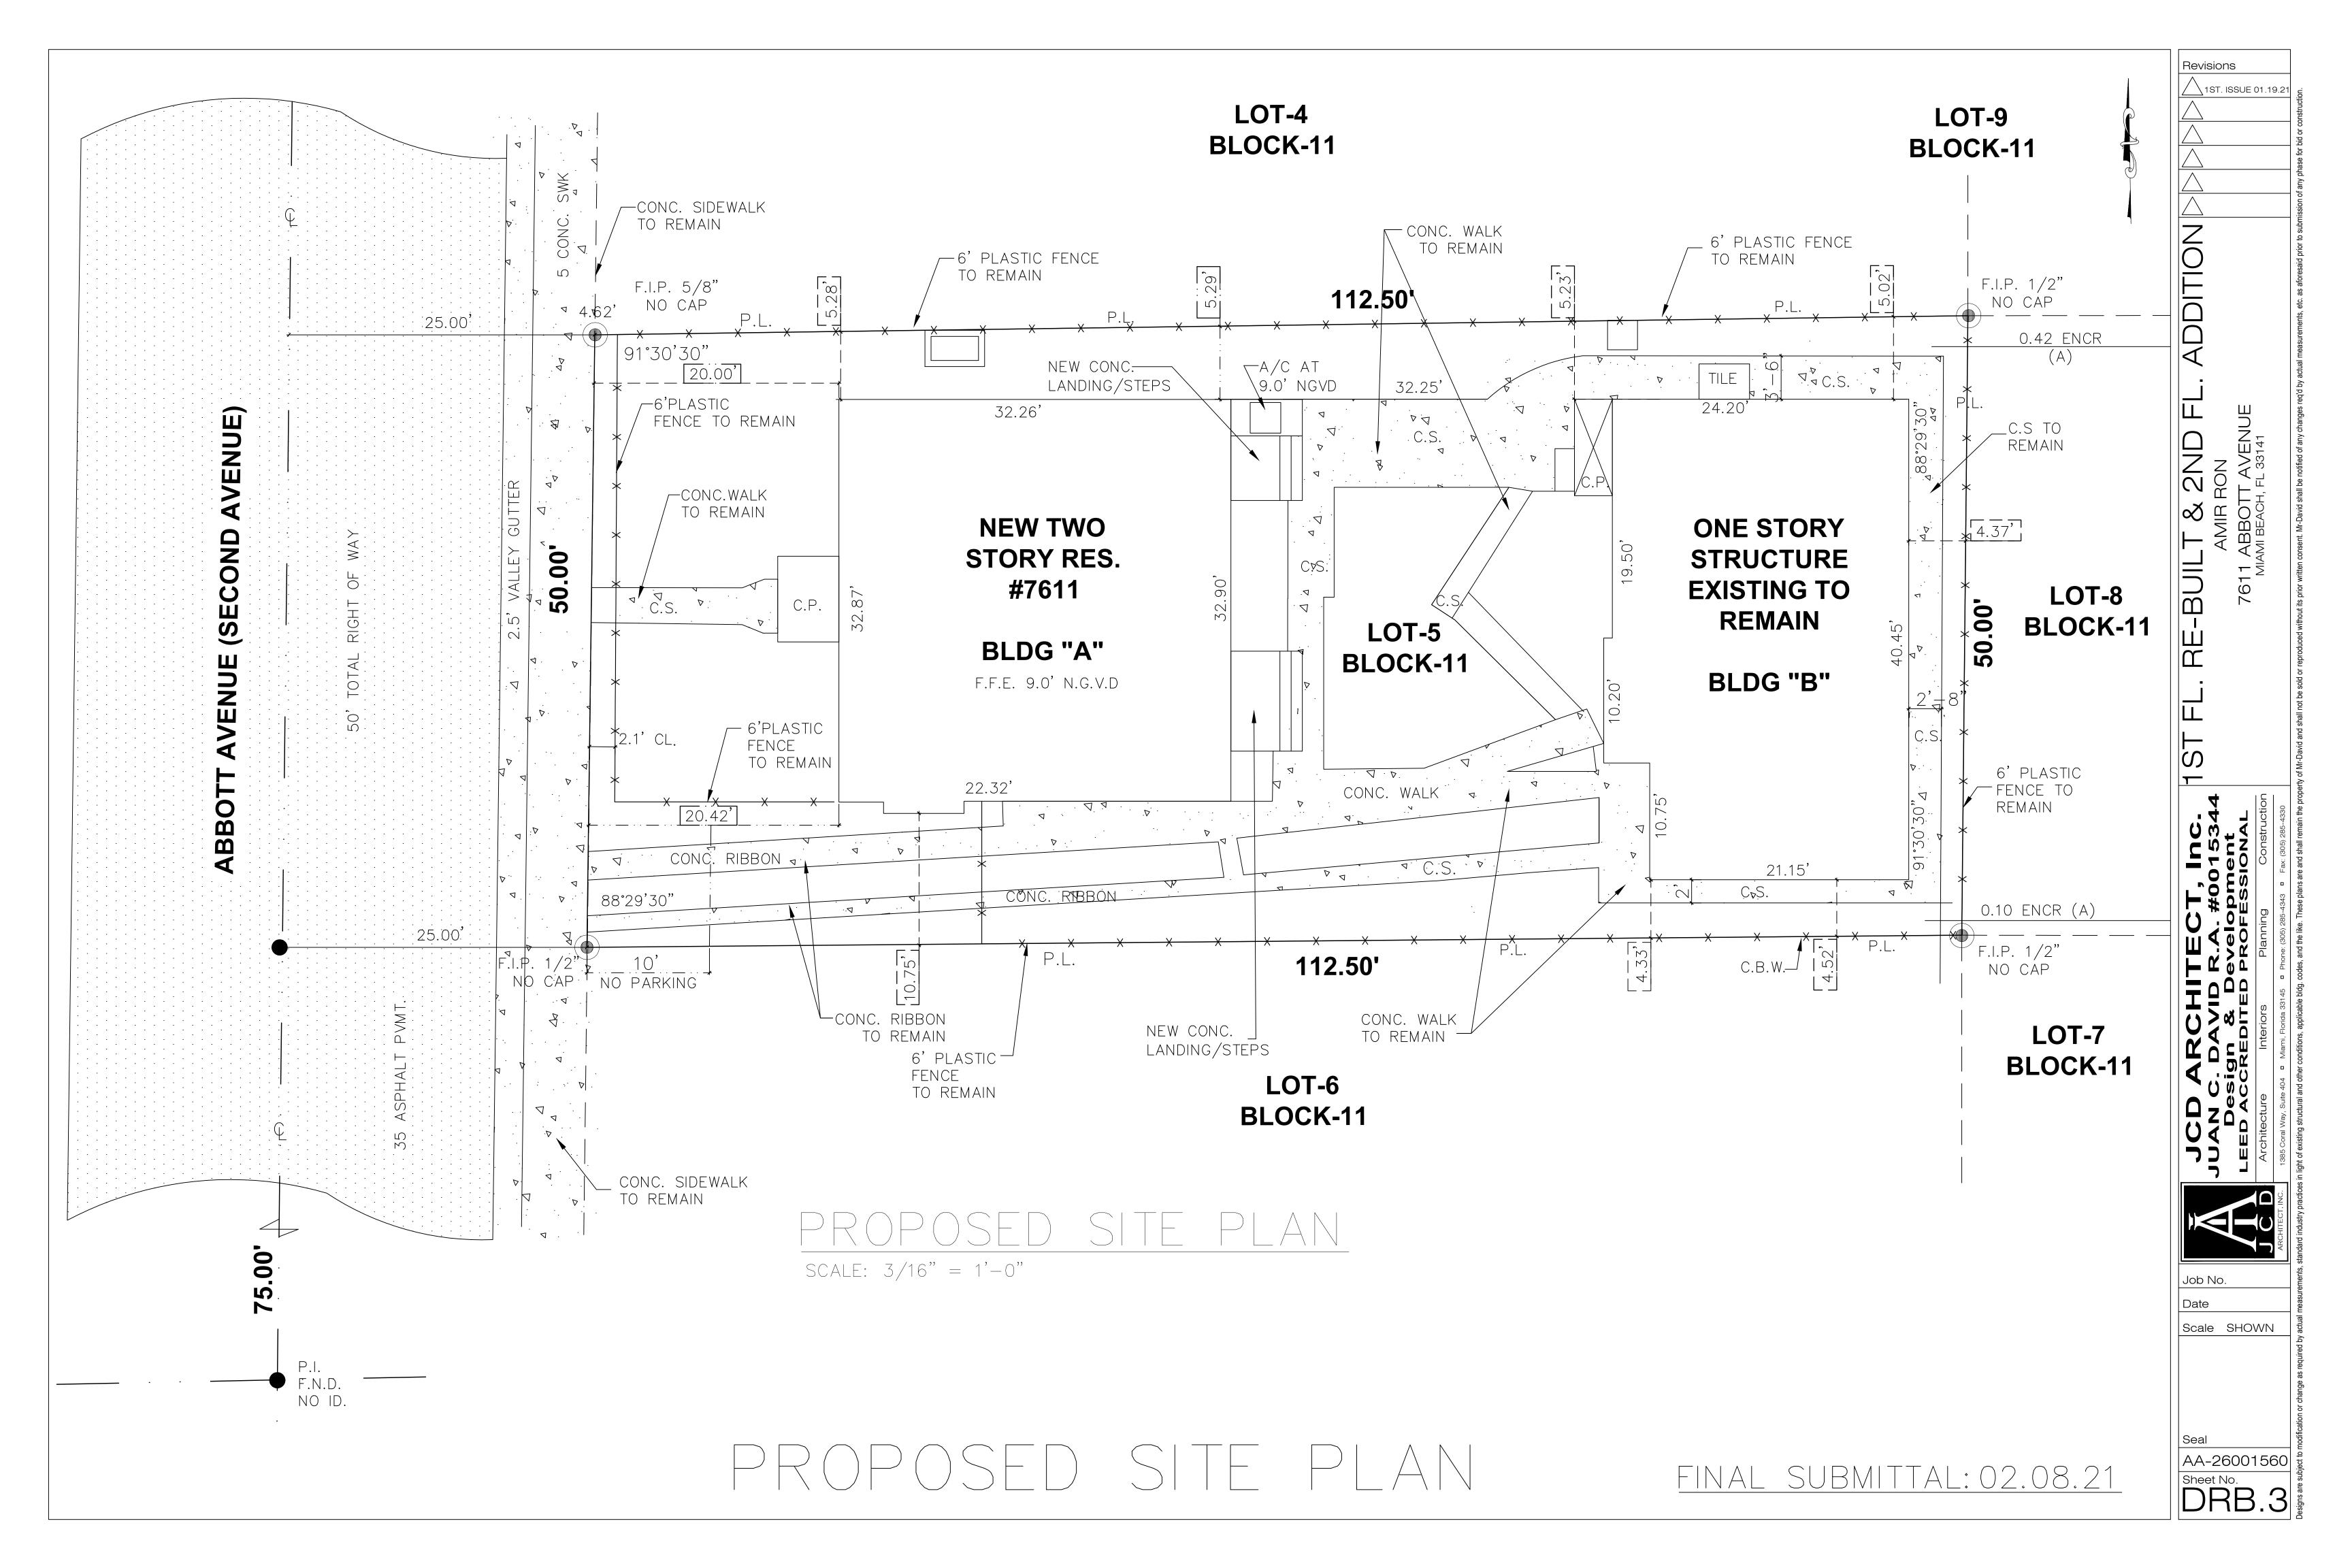

AA-26001560 Sheet No. DRB.5.1

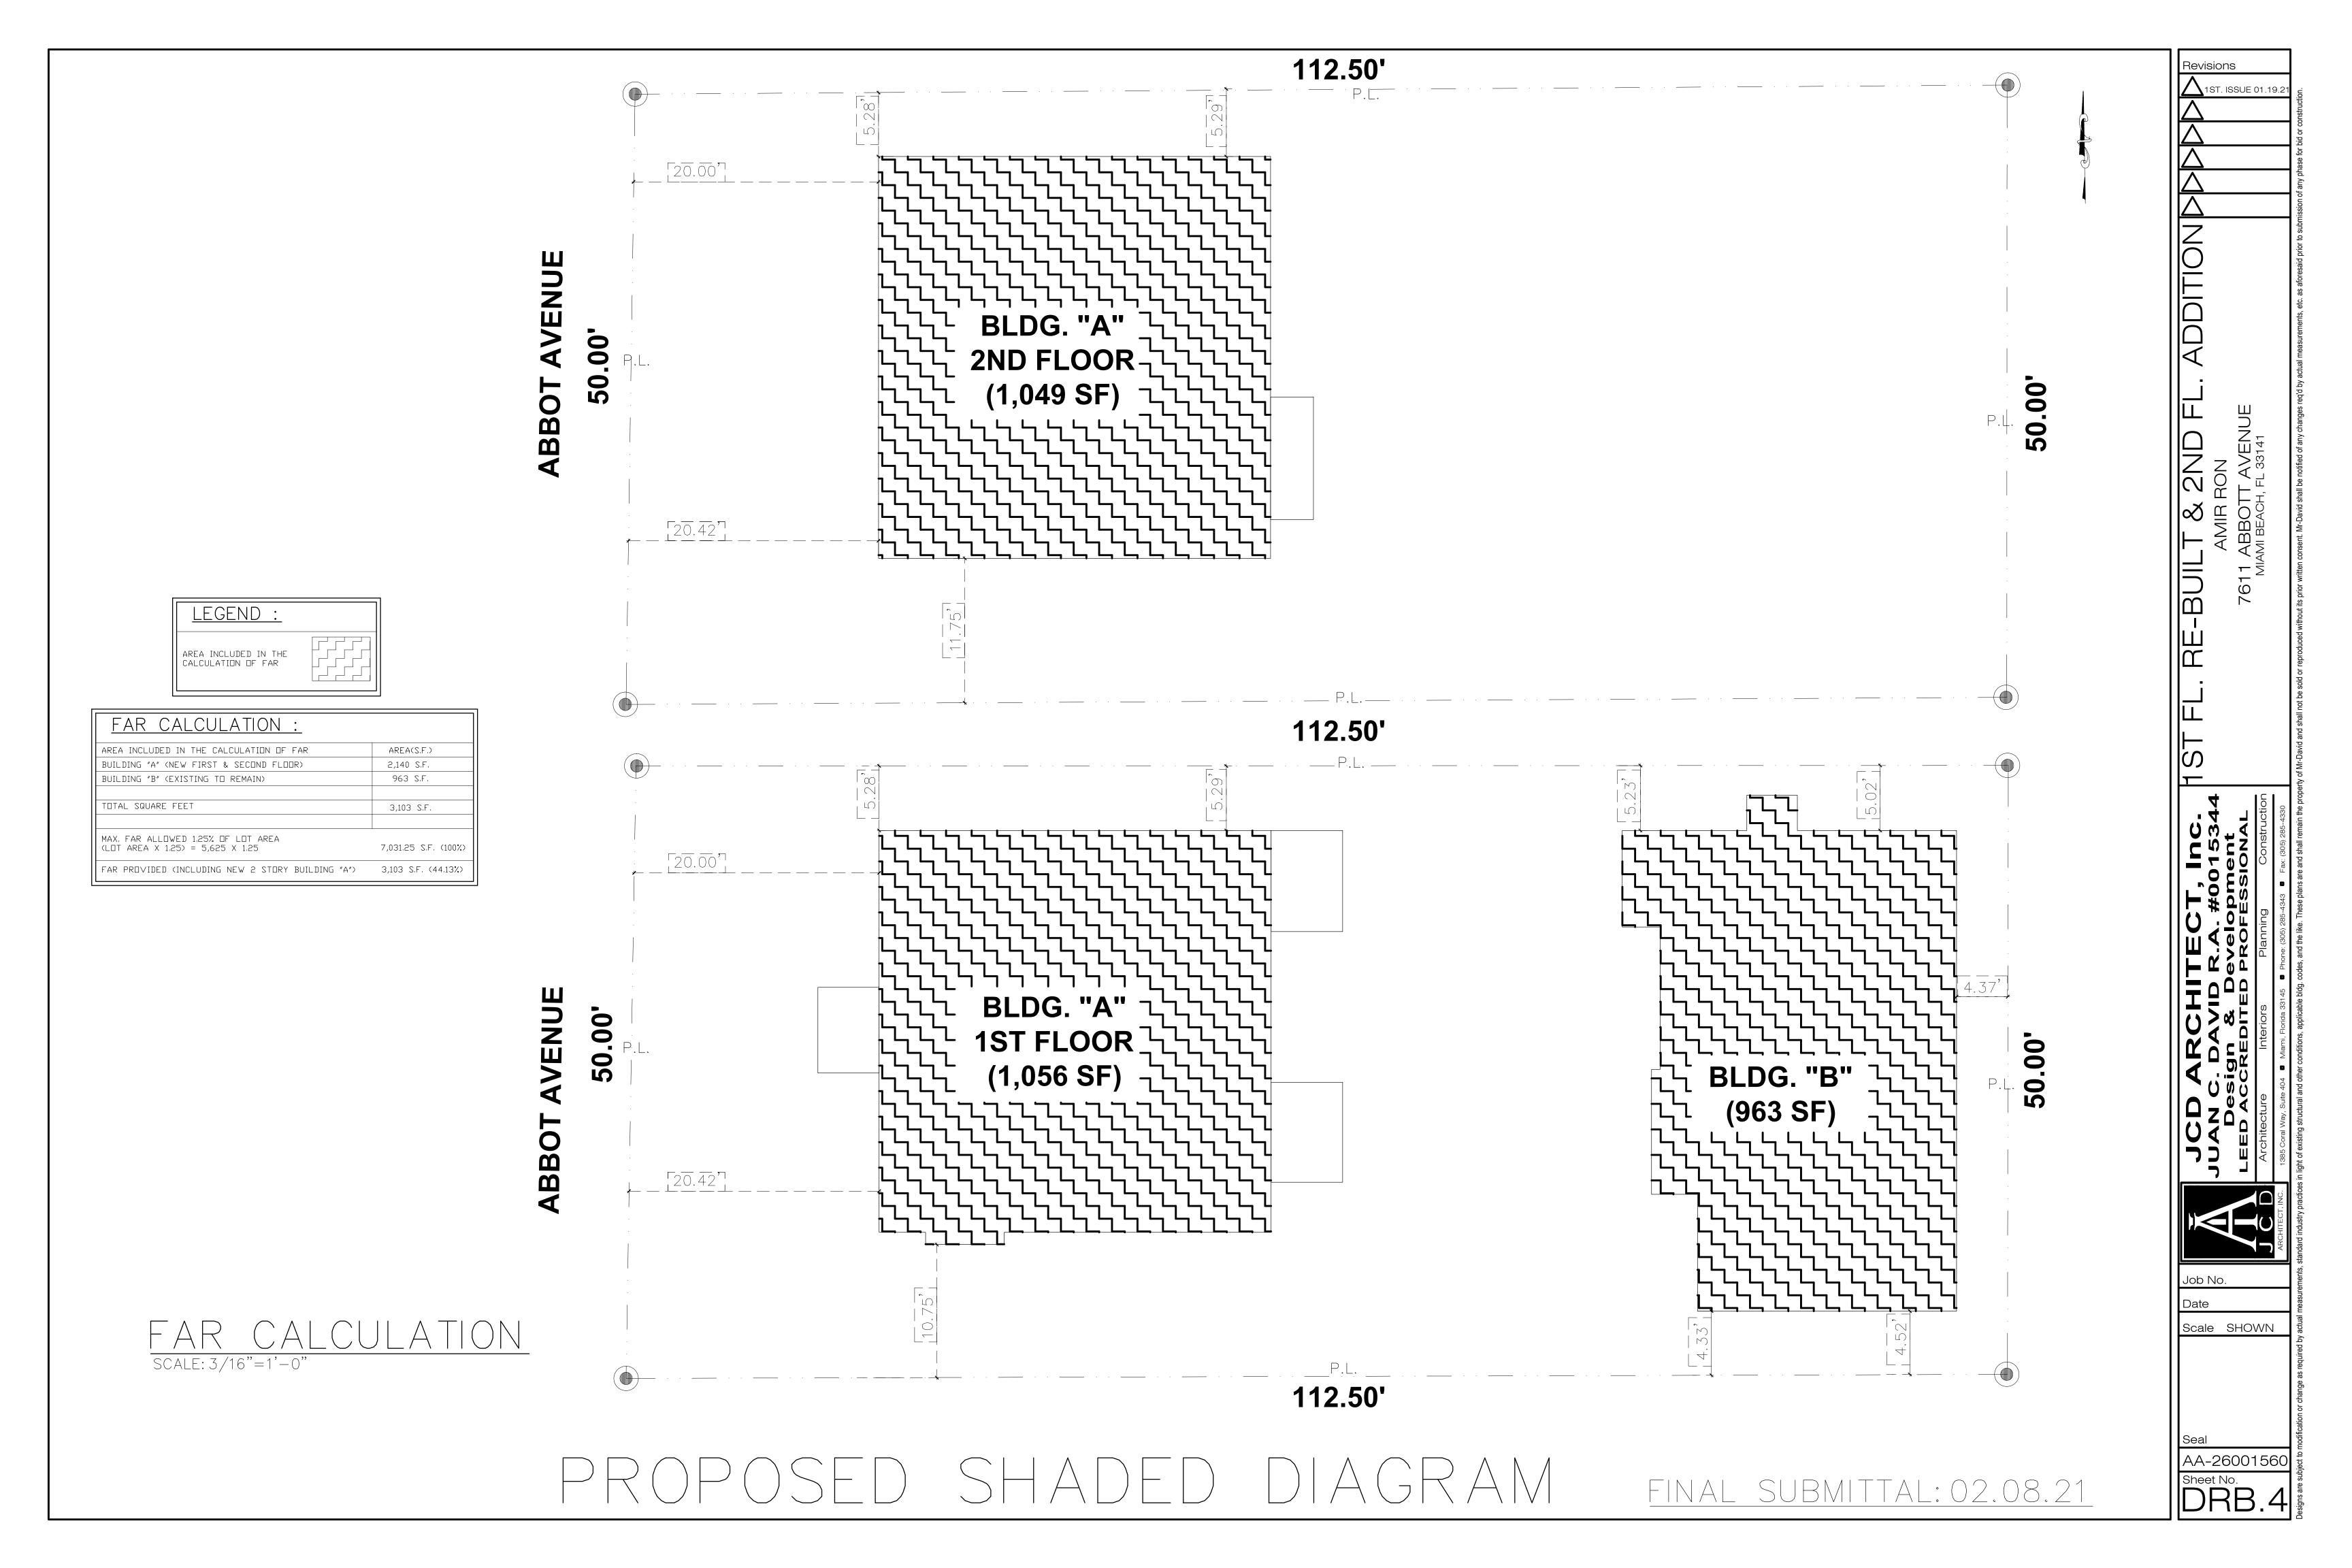



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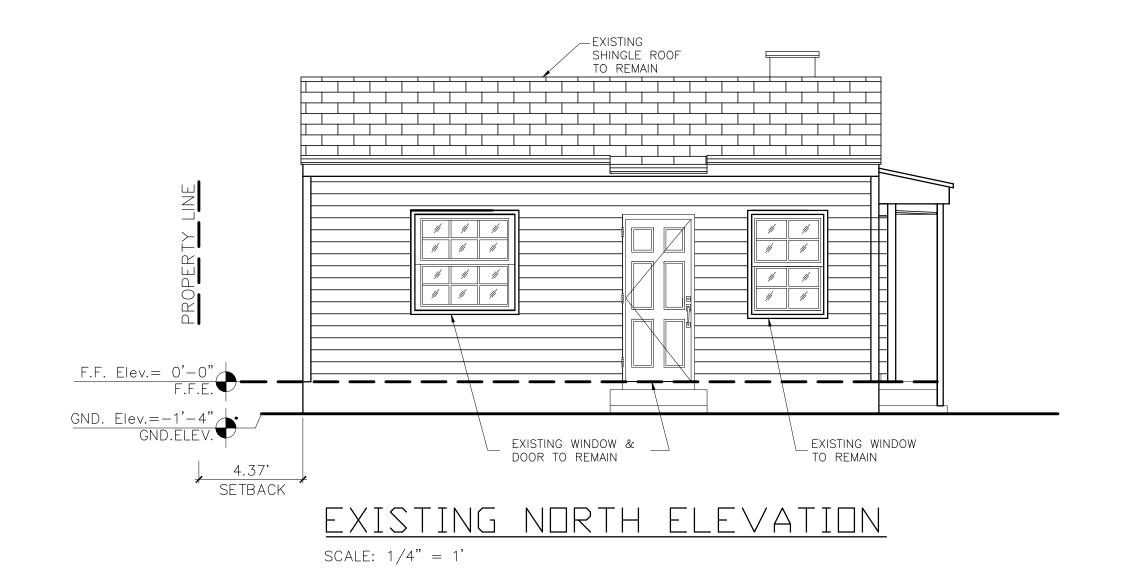



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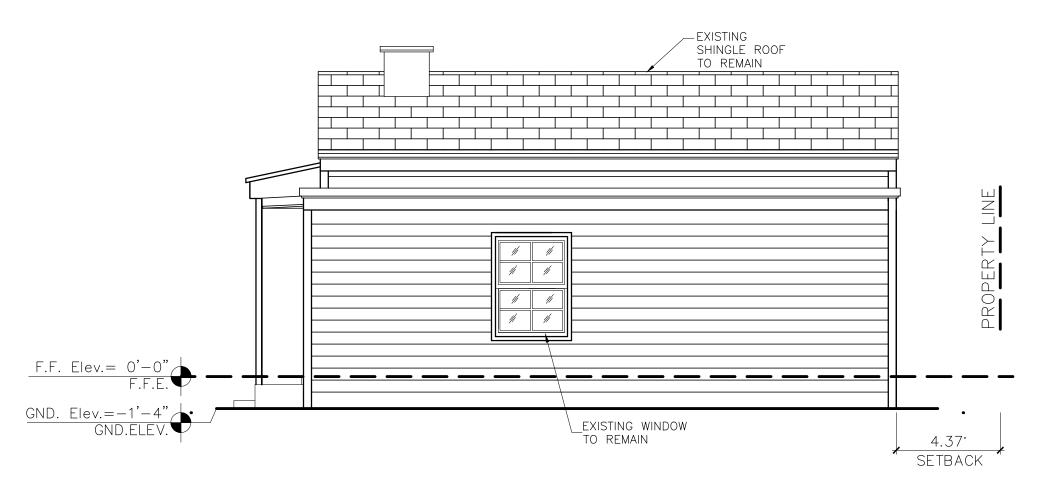






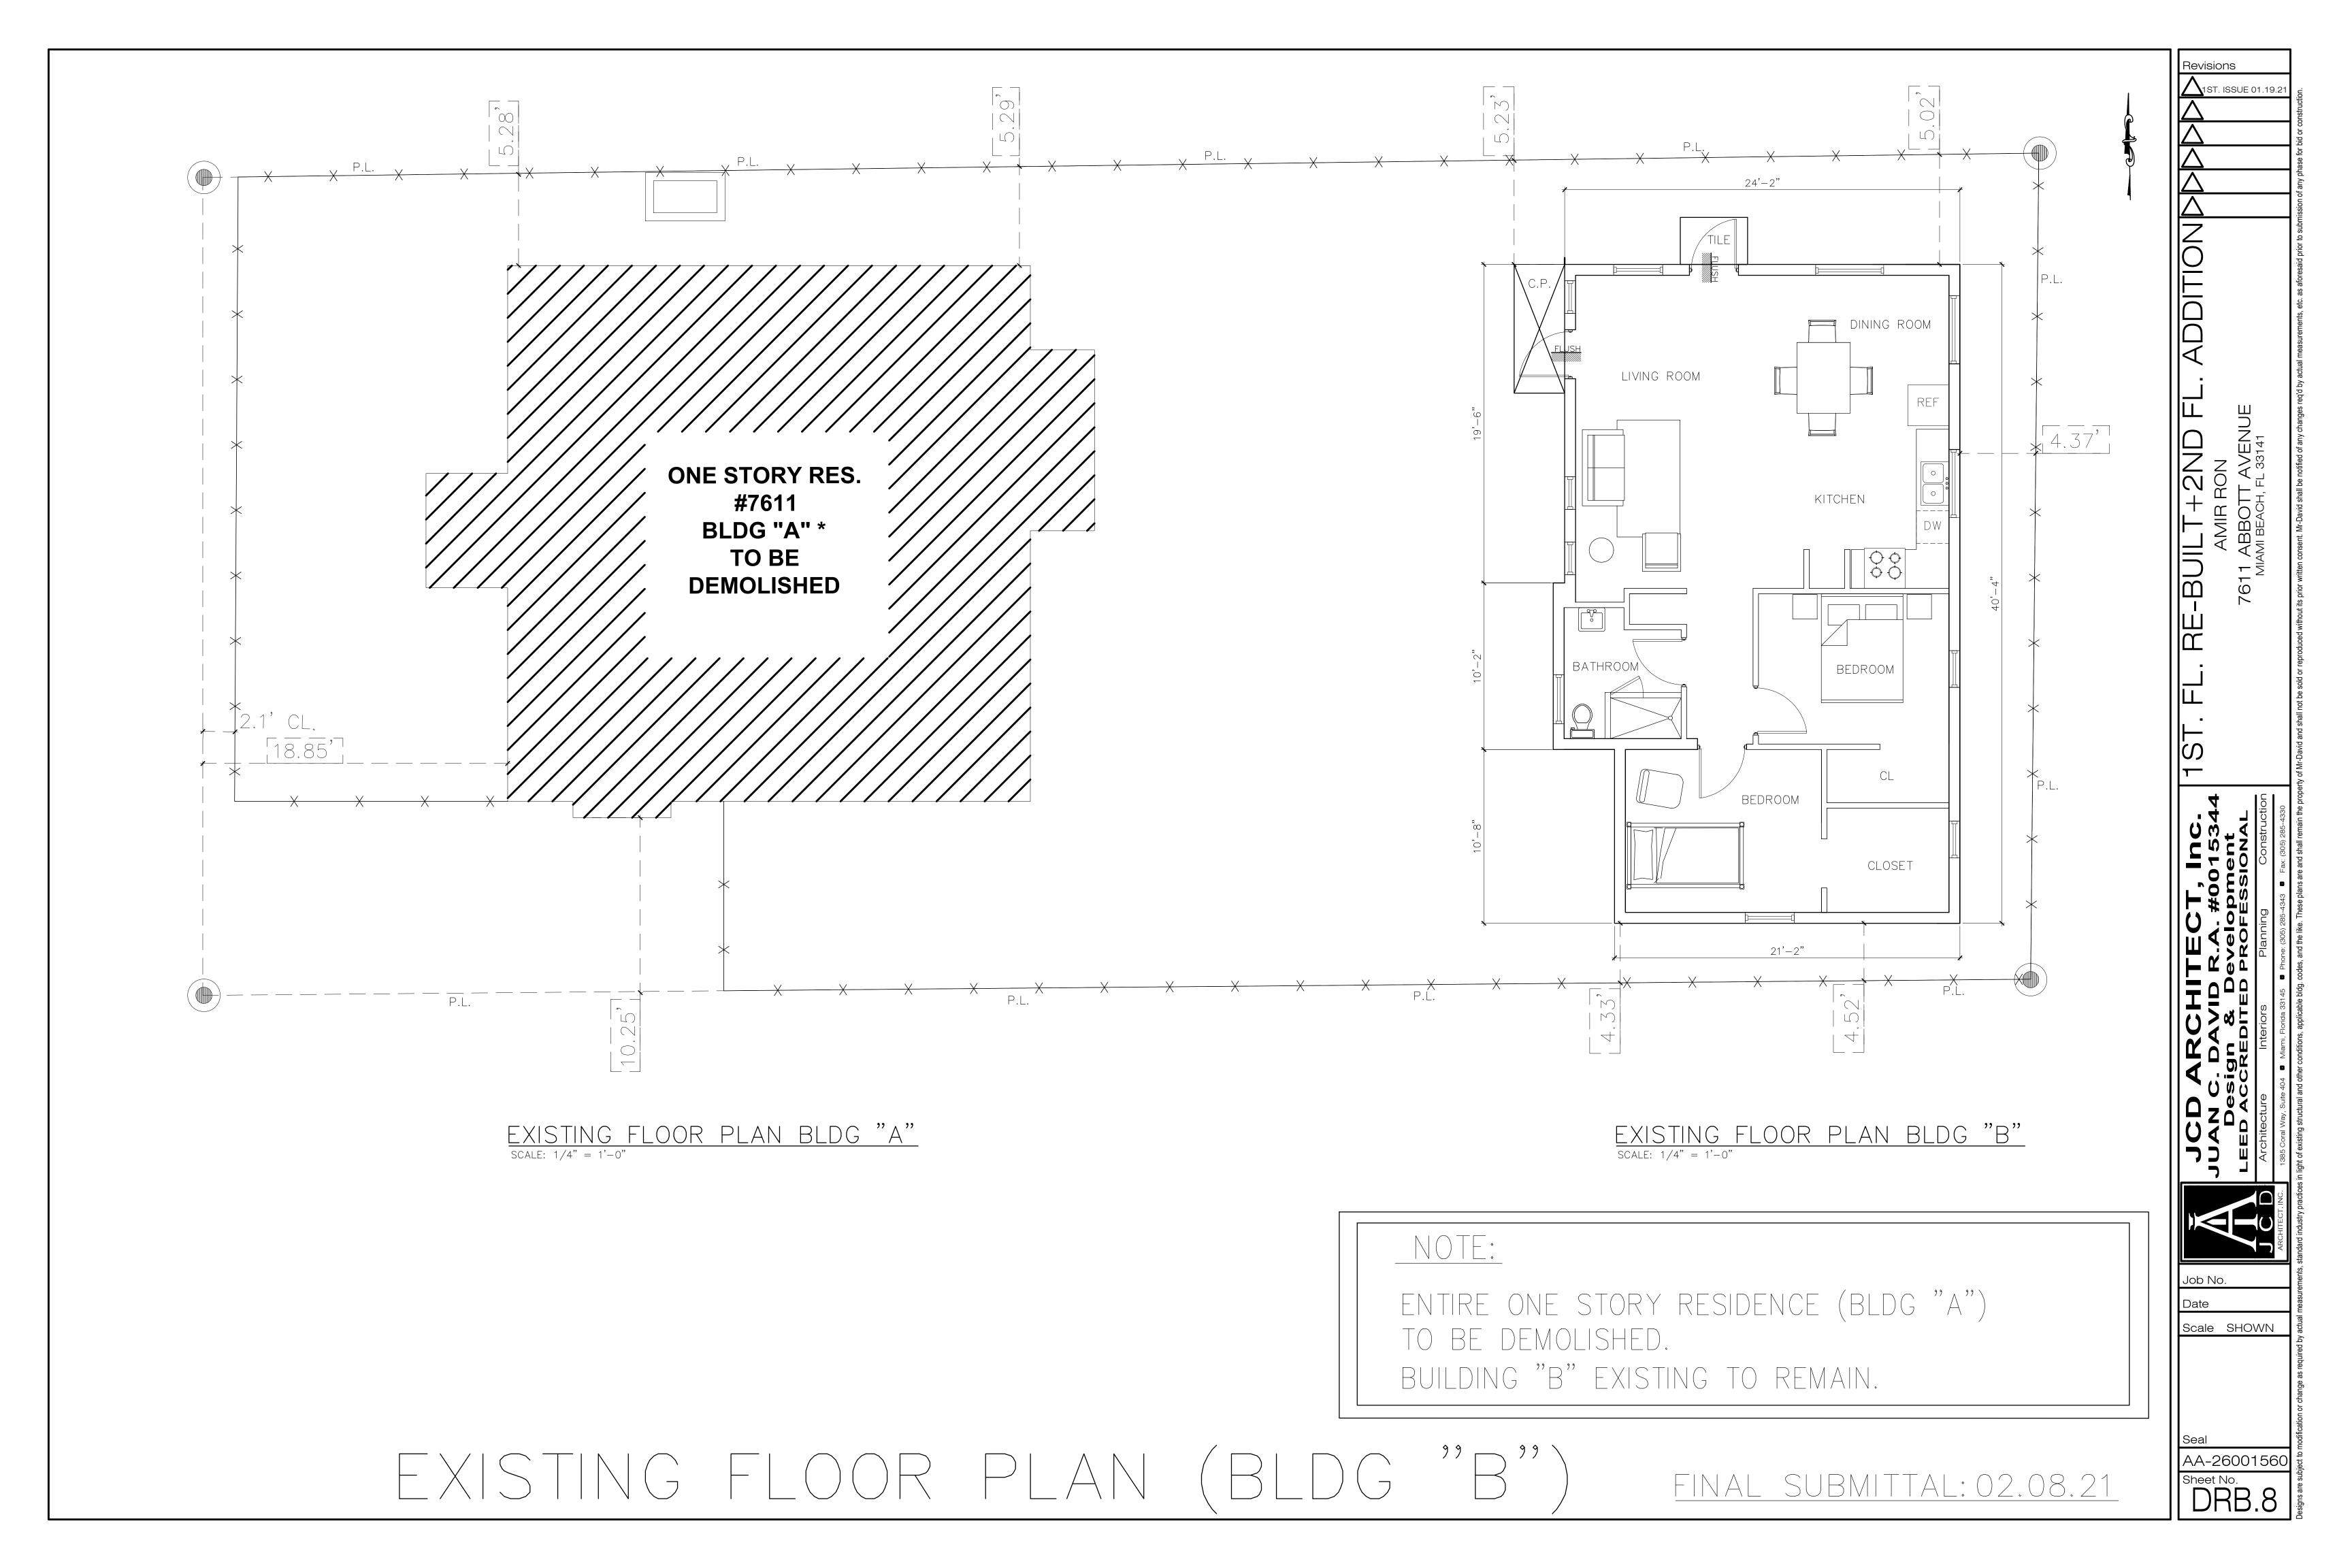

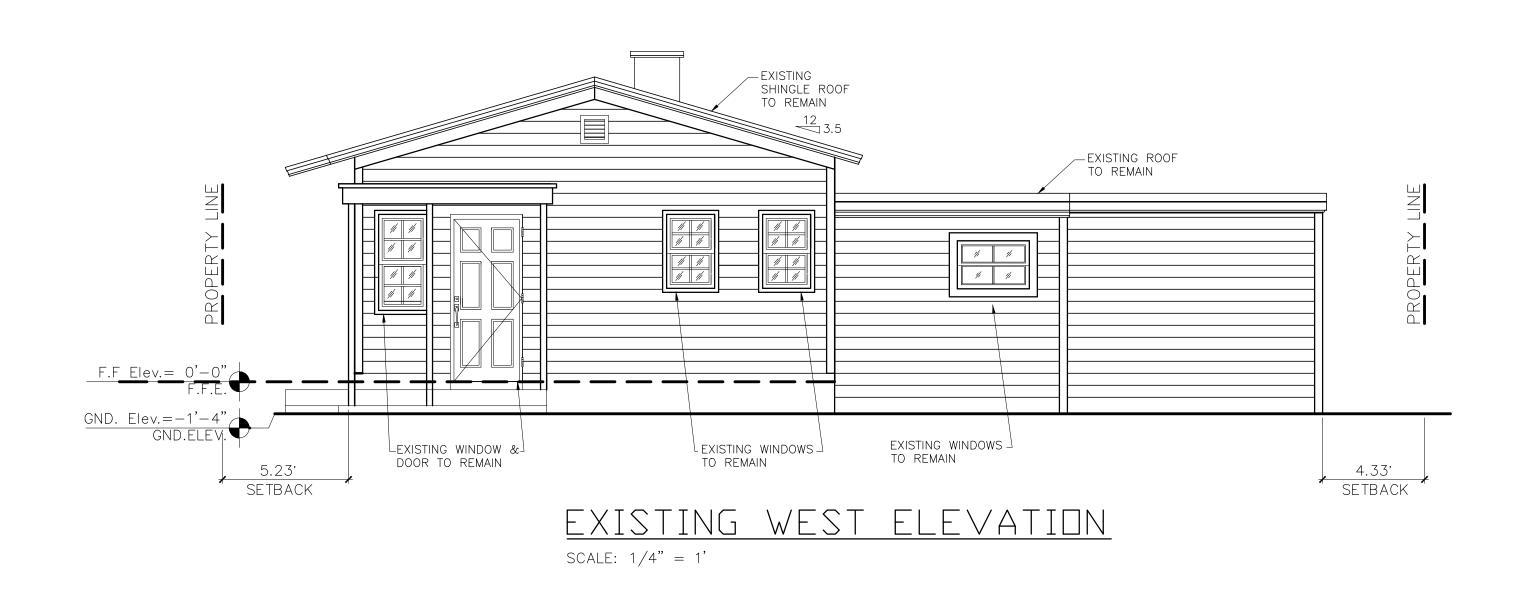

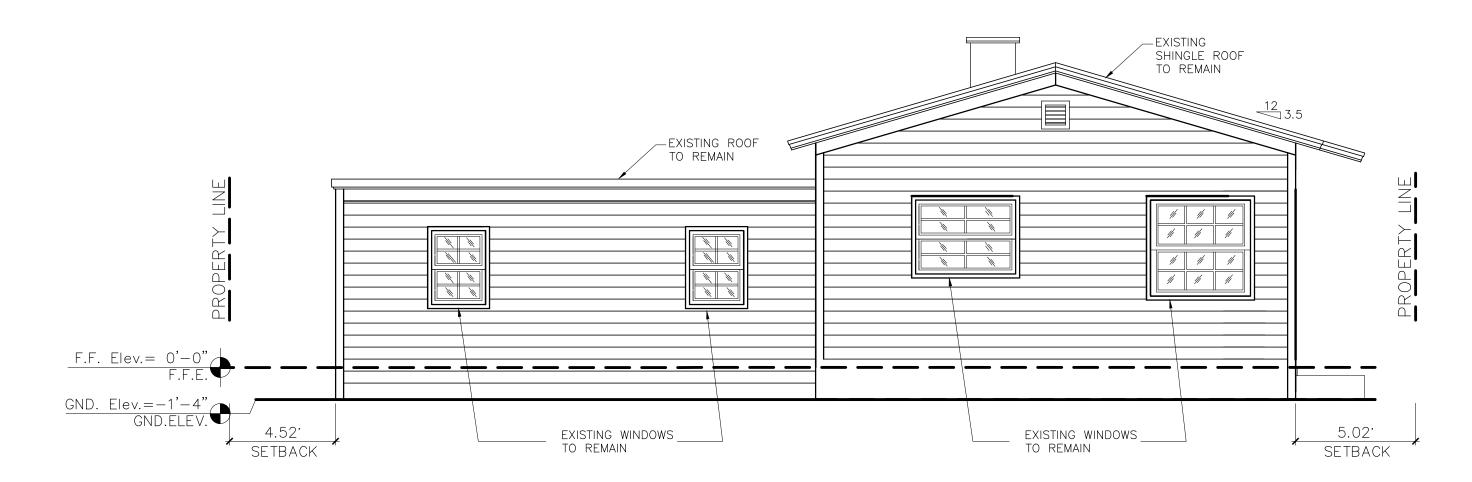

EXISTING SOUTH ELEVATION

SCALE: 1/4" = 1'

NOTE:

ENTIRE ONE STORY RESIDENCE TO REMAIN

EXISTING ELEVATIONS BLDG B

FINAL SUBMITTAL: 02.08.21

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ARCHITECT, INC.

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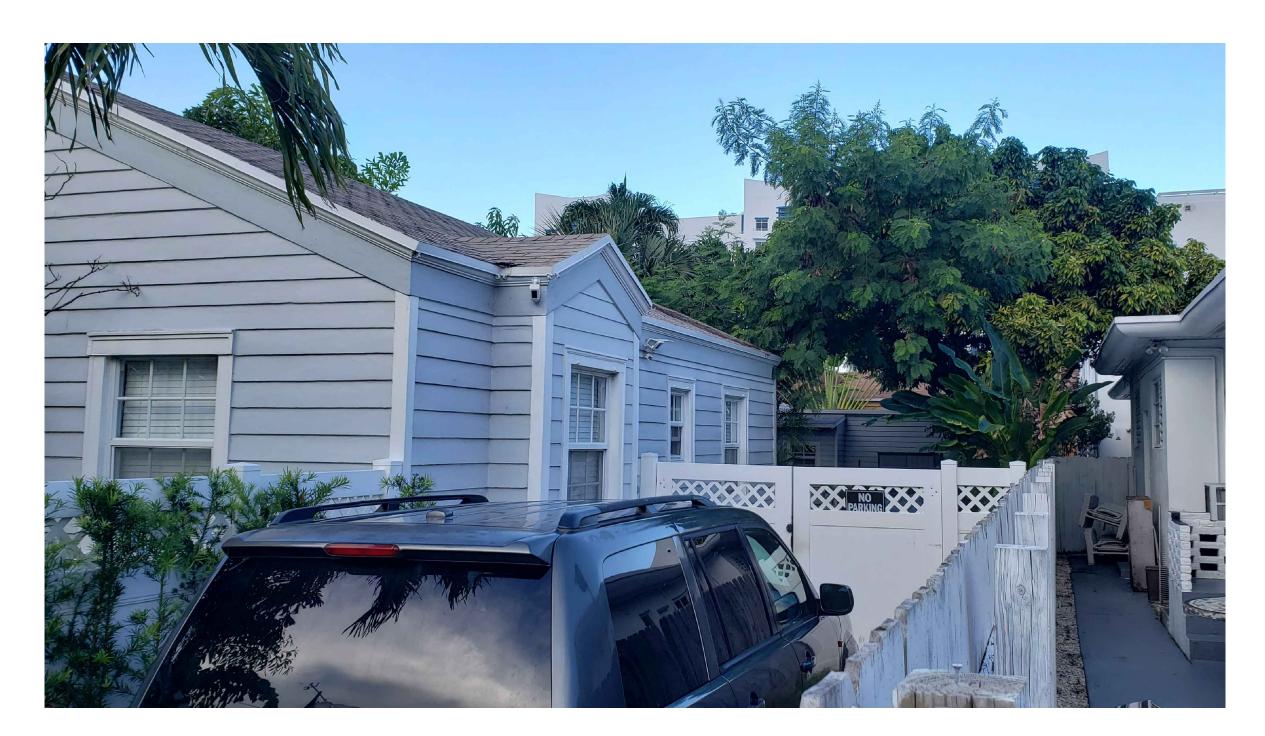
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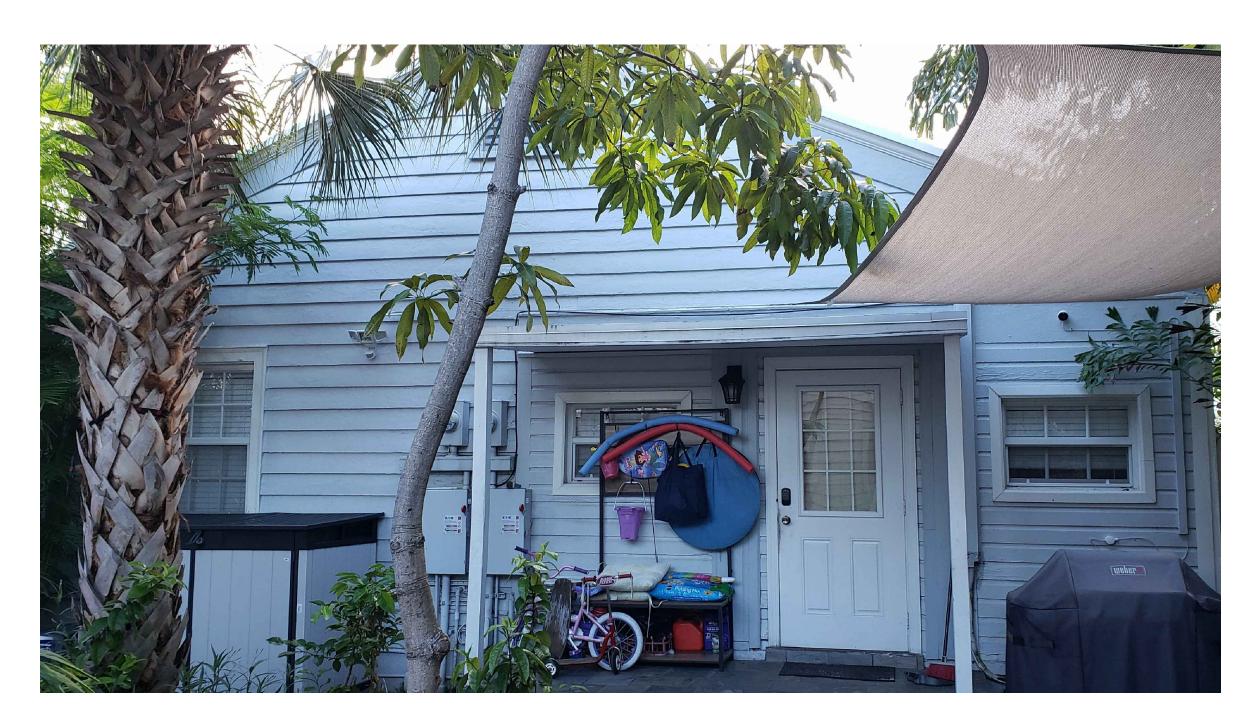
DRB.9



WEST VIEW (FRONT)



SOUTH VIEW (SIDE)



EAST VIEW (BACK)




NORTH VIEW (SIDE)

EXISTING RESIDENCE (BLDG "A") FINAL SUBMITTAL: 02.08.21

Scale SHOWN



WEST VIEW (FRONT)

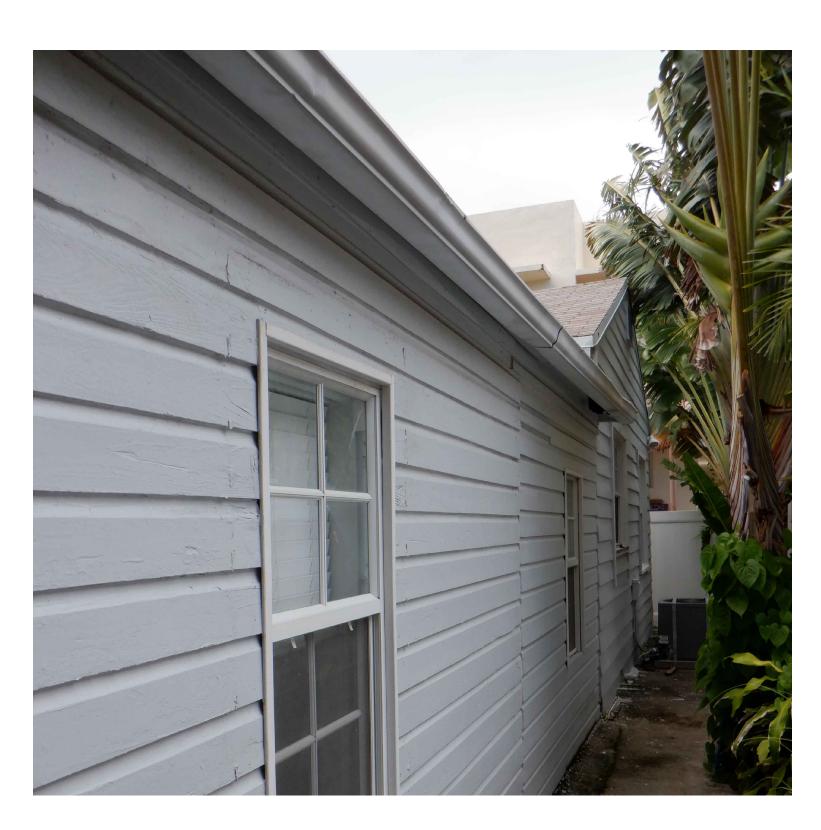

EAST VIEW (BACK)



SOUTH VIEW (SIDE)




NORTH VIEW (SIDE)

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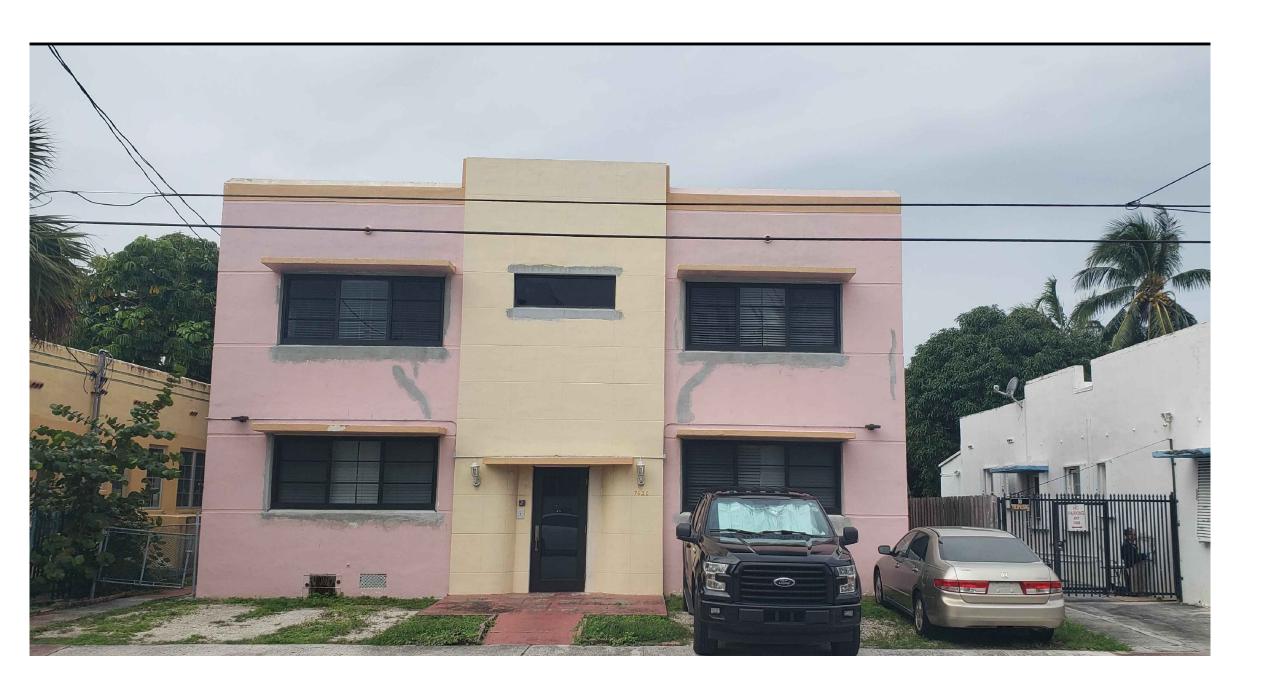
AA-26001560 Sheet No. DRB.11




#1 = 405 76 th St.

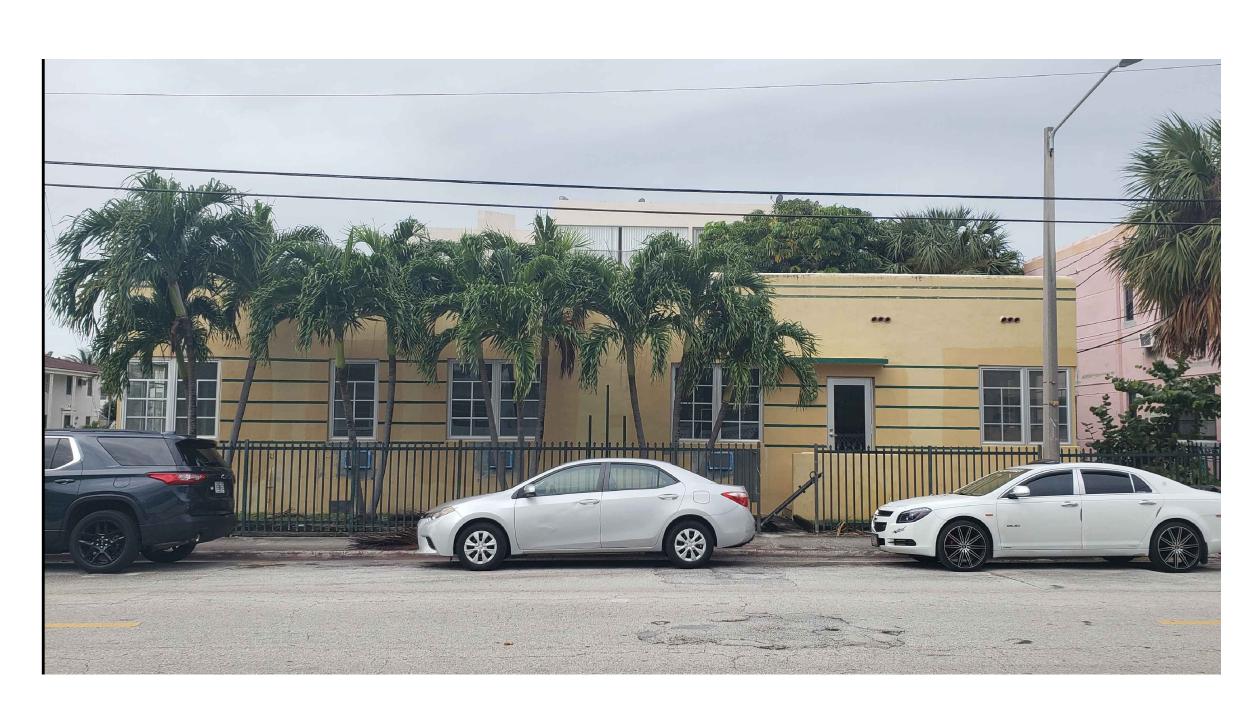

#3= 7628 ABBOTT AVENUE



#2= 7620 ABBOTT AVENUE

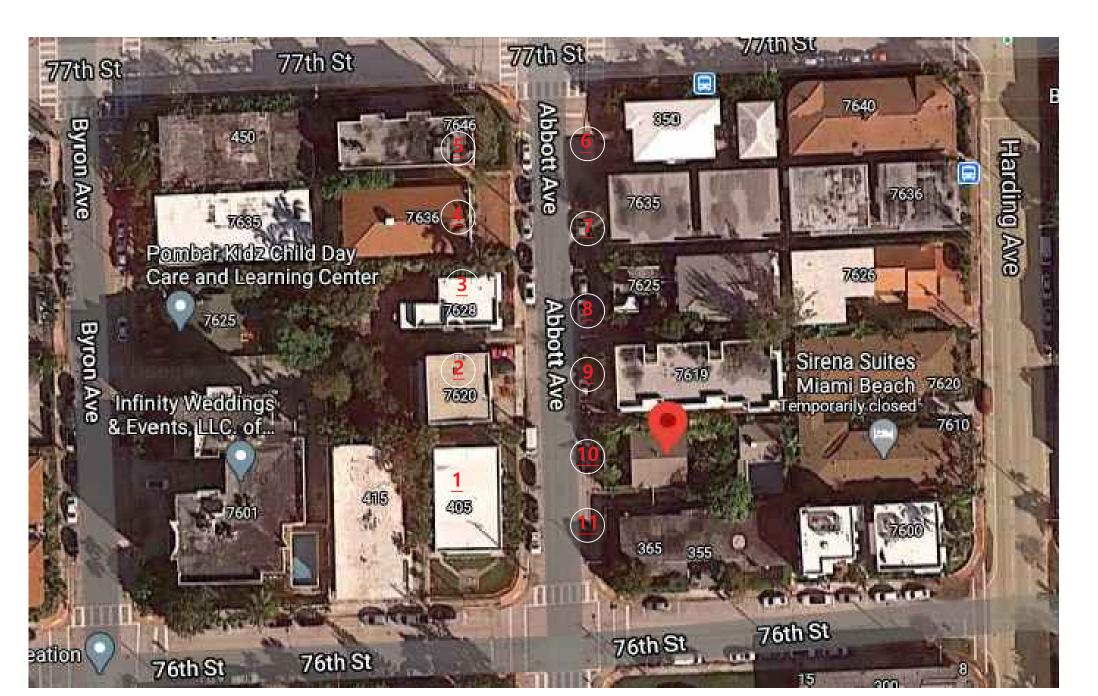

KEY PLAN



FINAL SUBMITTAL: 02.08.21

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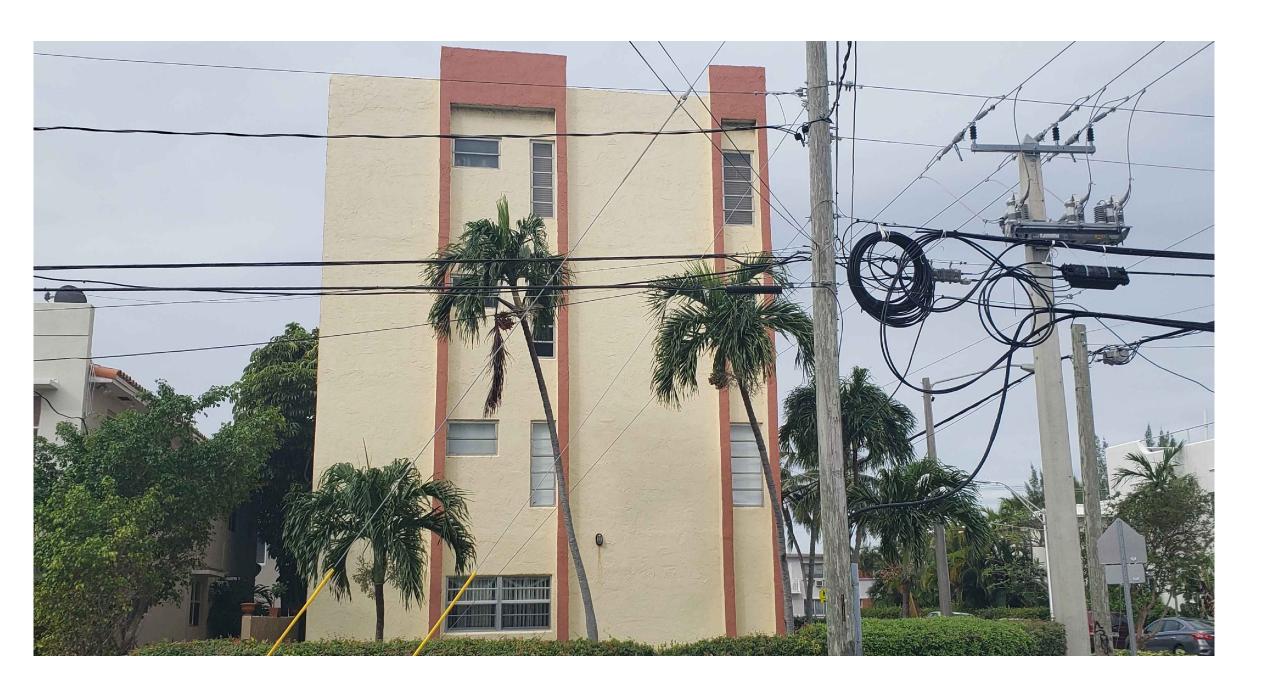
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AA-26001560 Sheet No. DRB.12

#4= 7636 ABBOTT AVENUE



#6 = 350 77 th St.



#5= 7646 ABBOTT AVENUE



#7= 7635 ABBOTT AVENUE

NEIGHBORHOOD CONTEXT STUDY

FINAL SUBMITTAL: 02.08.21

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#8= 7625 ABBOTT AVENUE





#10= 7611 ABBOTT AVENUE



#11= 365 76th St.

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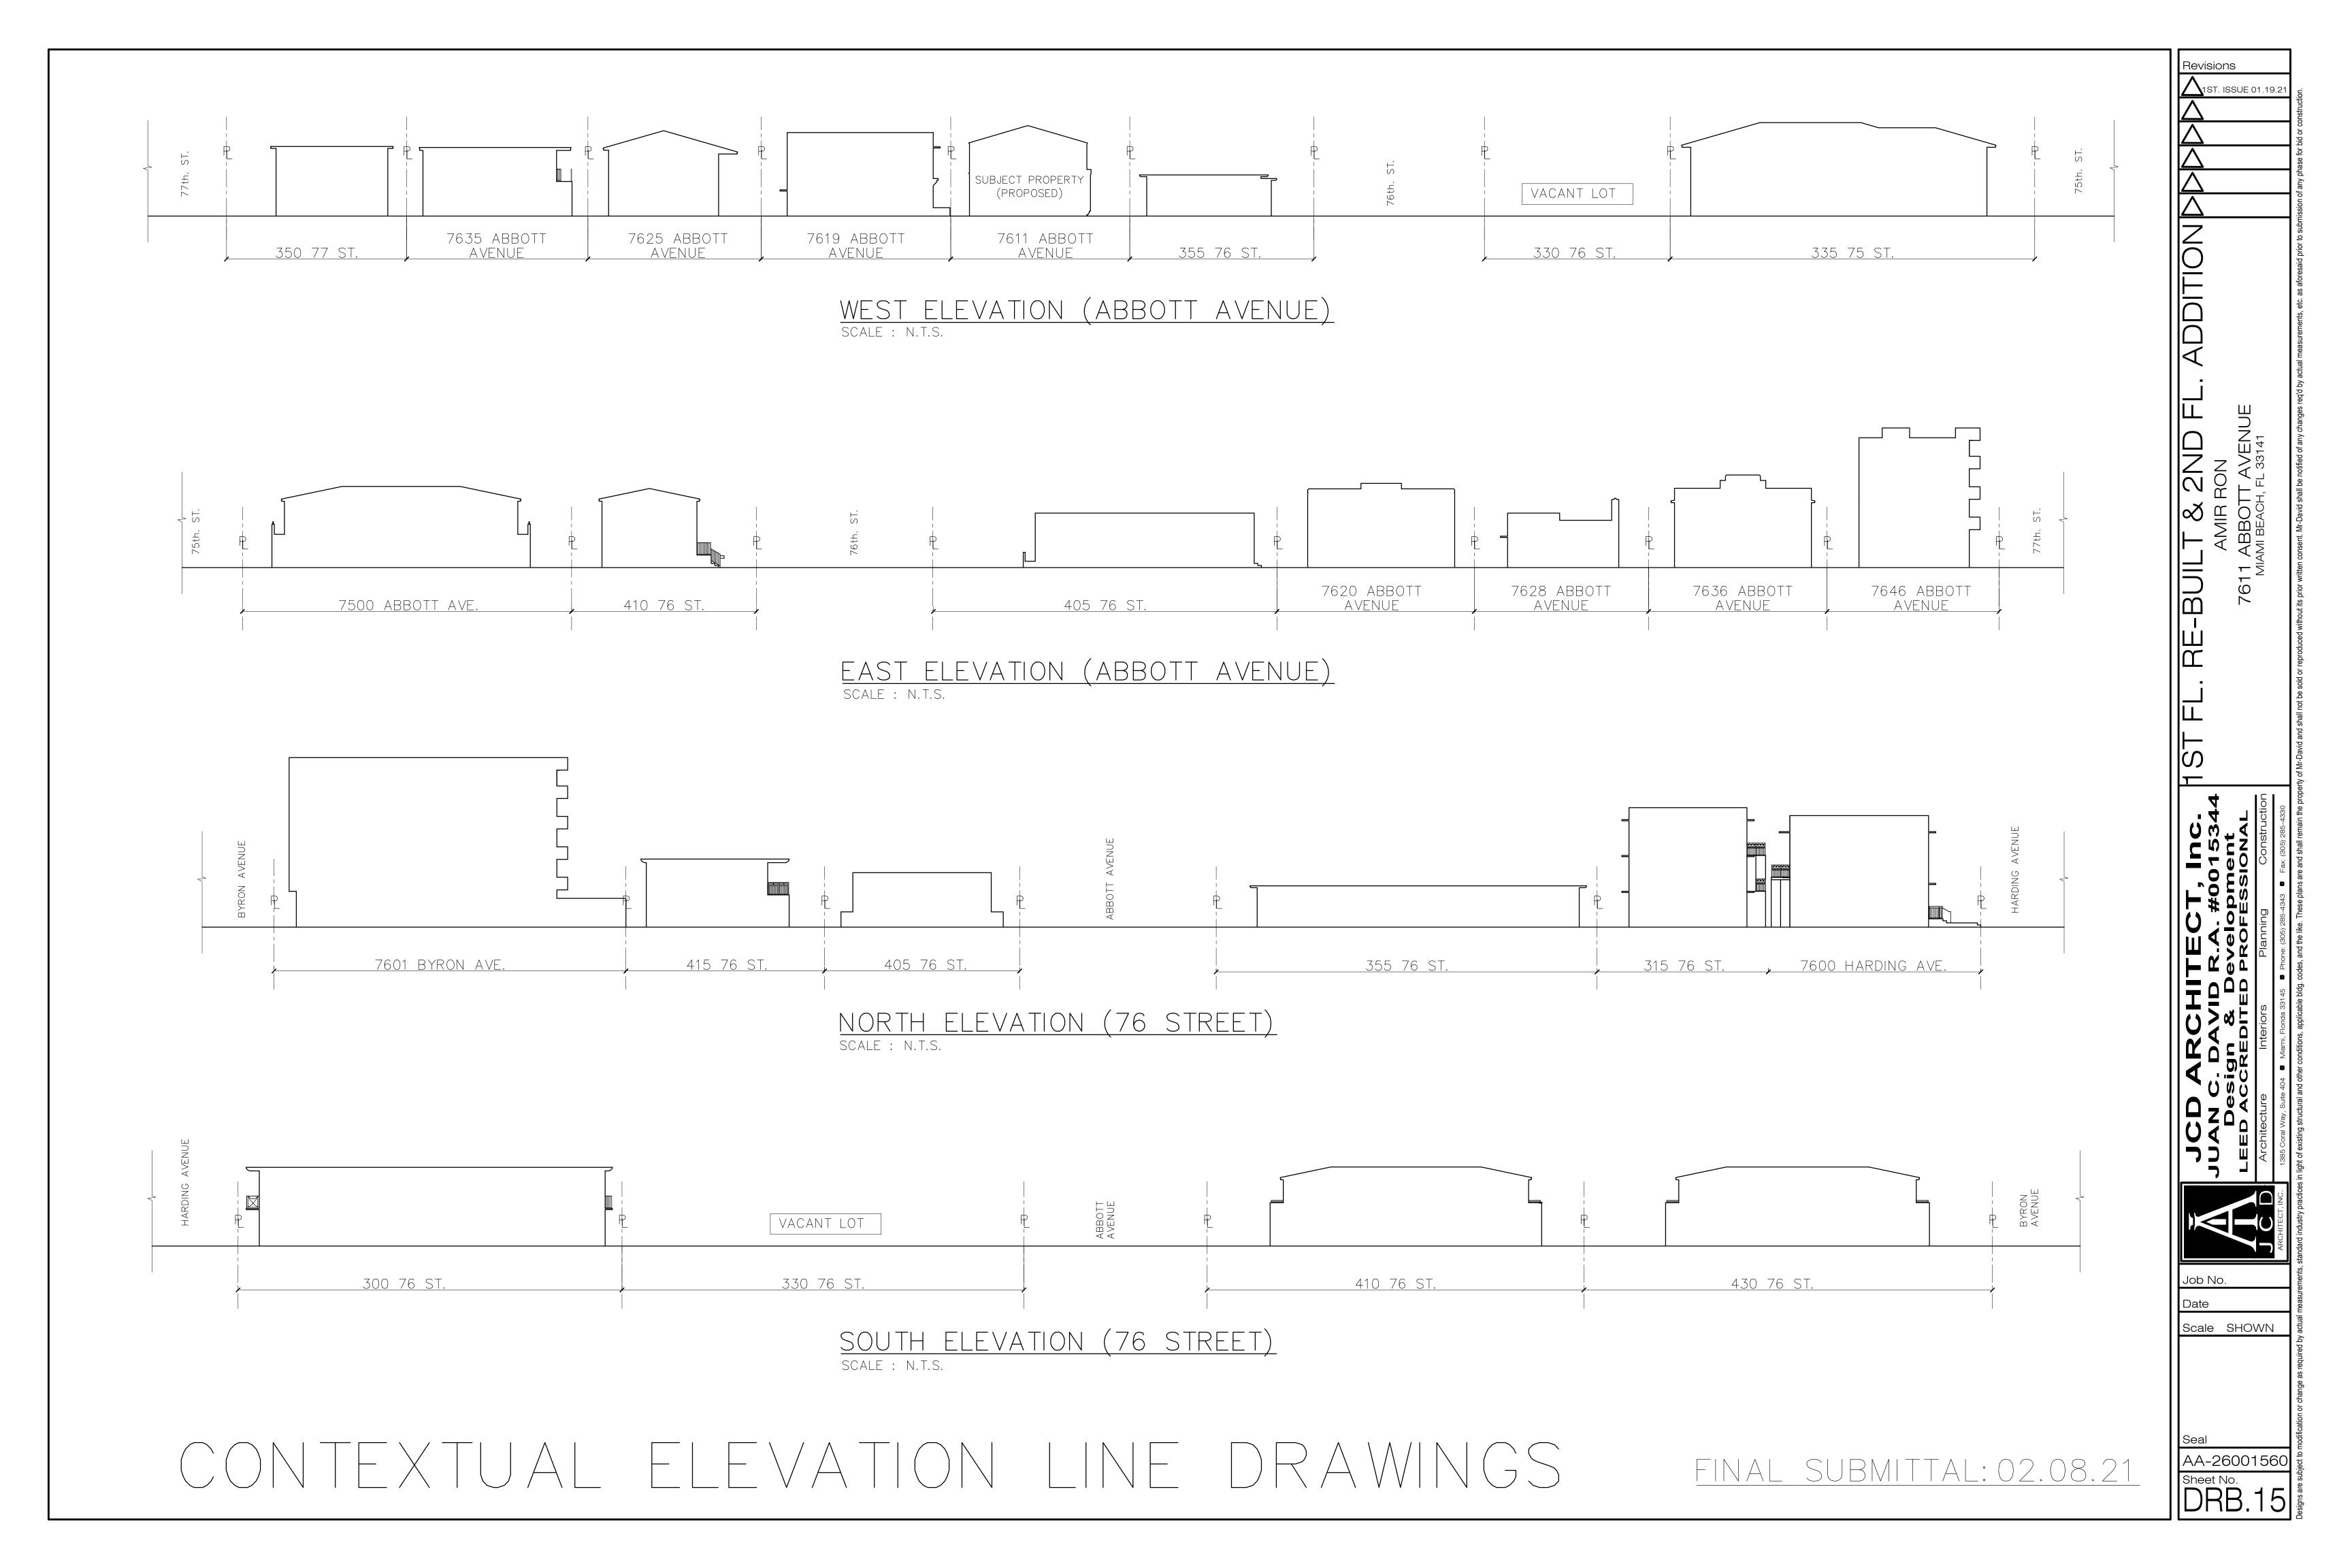
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Design & Development
ED ACCREDITED PROFESSIONAL

ARCHITECT, INC.

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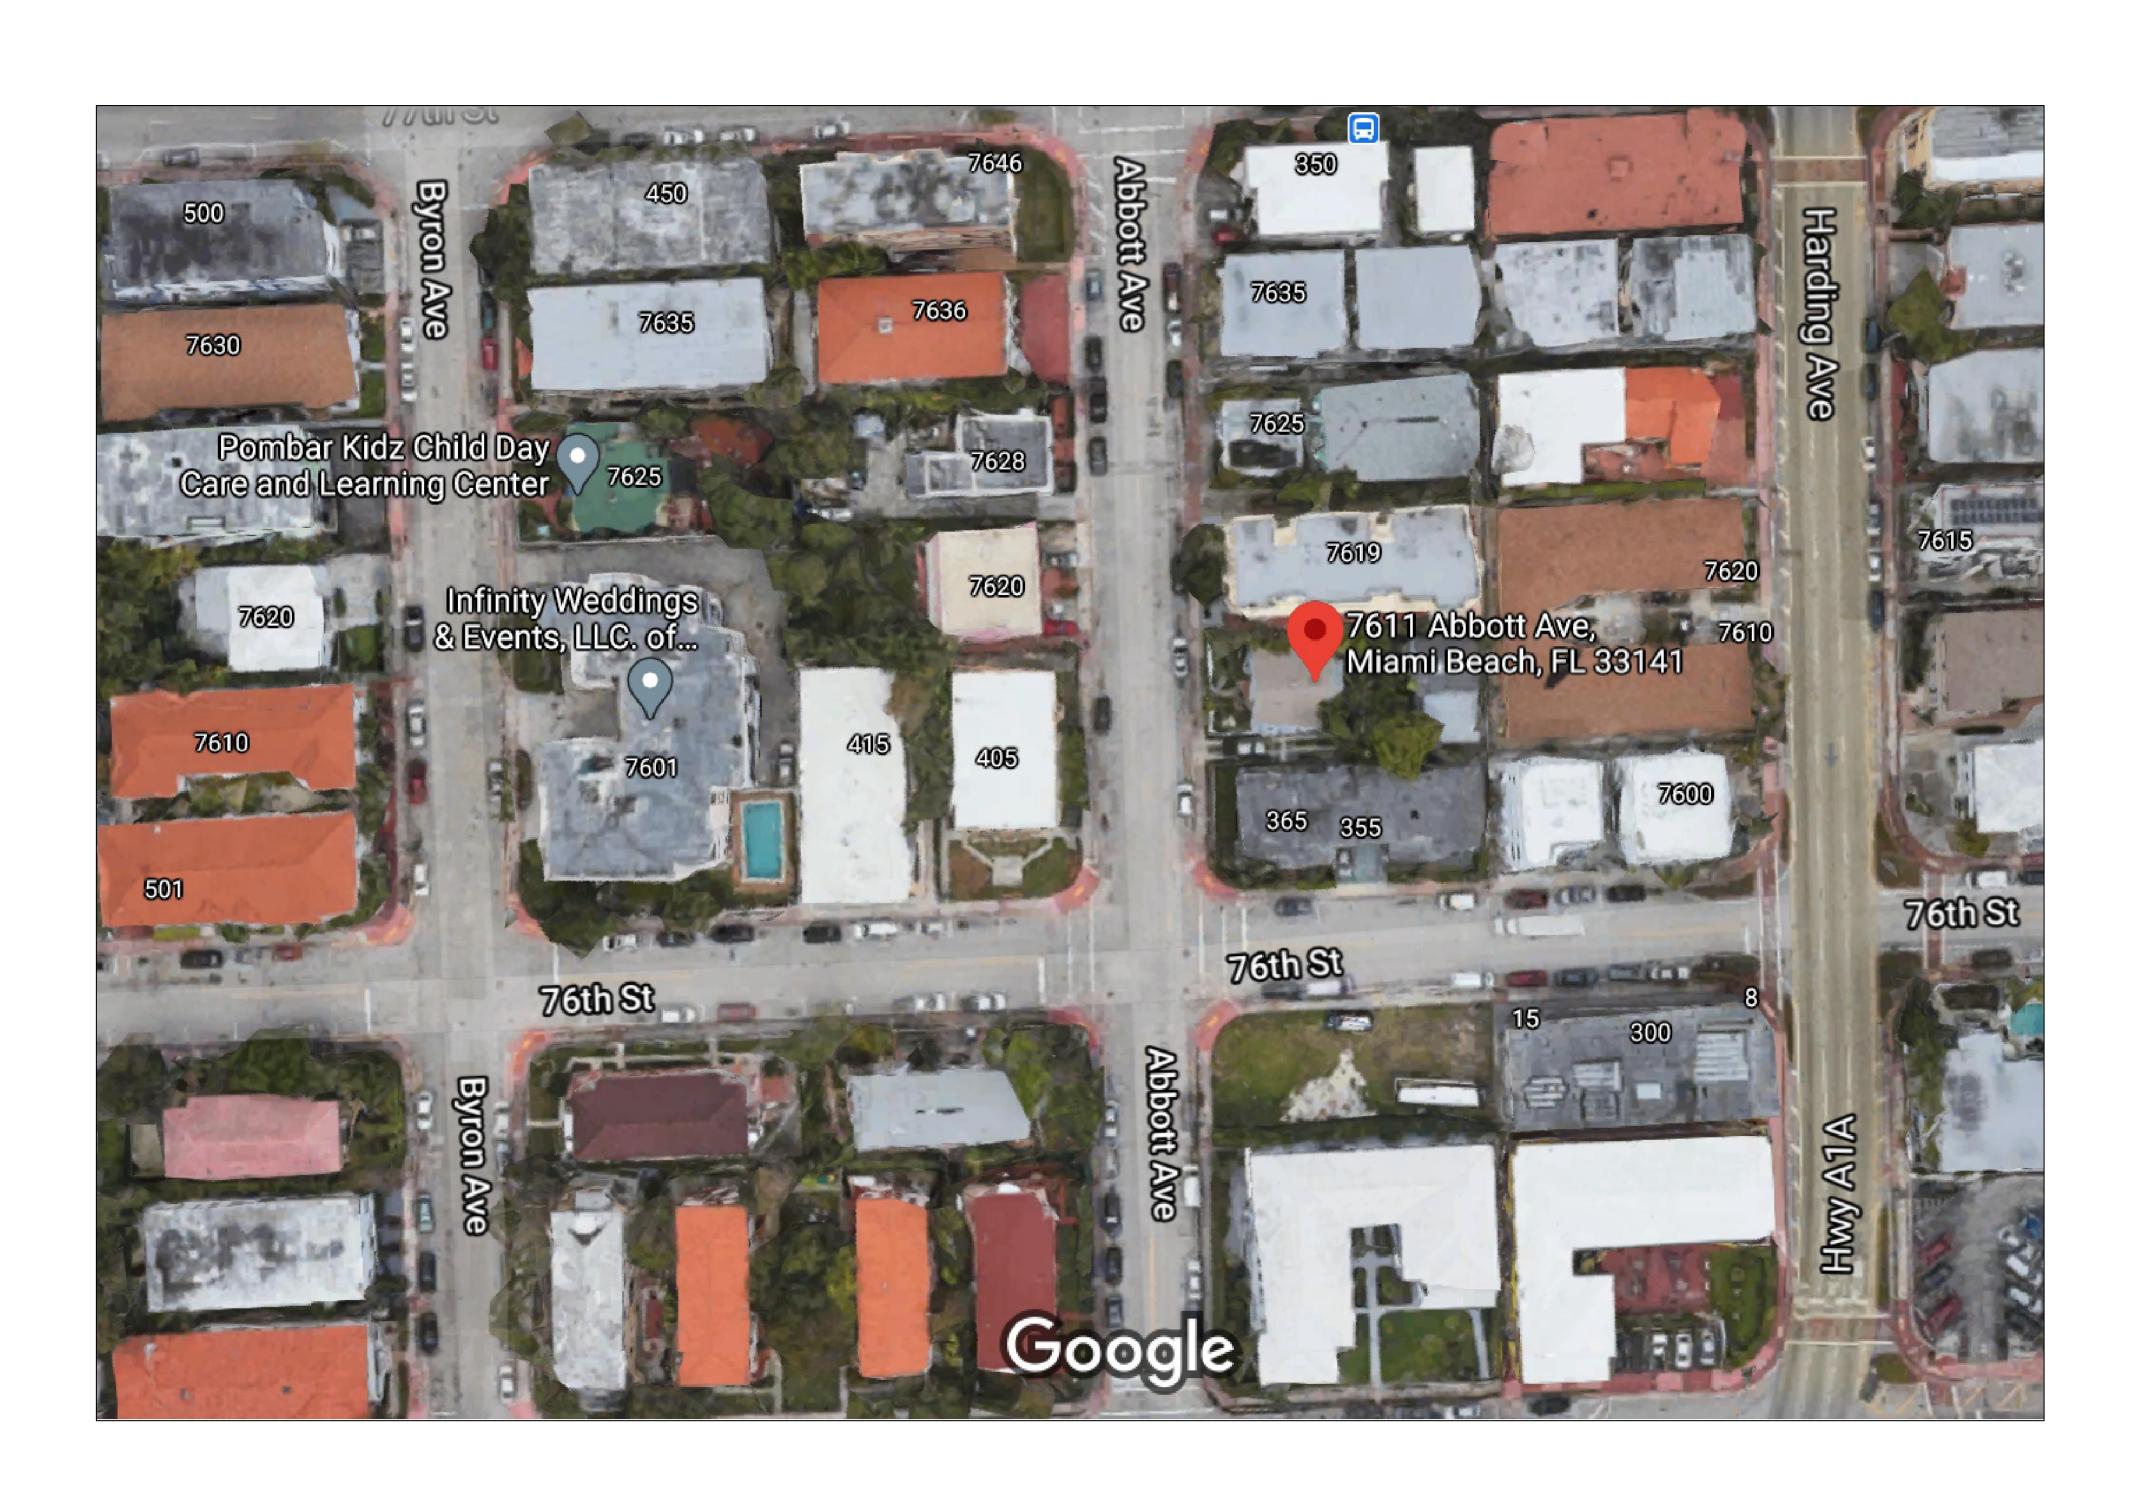
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1ST FLOOR RE-BUILT & 2ND FLOOR ADDITION

7611 ABBOTT AVENUE, MIAMI BEACH, FL 33141



DRAWING LIST:

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L-2	EXISTING TREE NOTES
LP-1	PLANTING PLANS
\(LP-2	PLANTING NOTES & DETAILS
(IR-1	IRRIGATION PLAN
(IR-2	IRRIGATION NOTES & DETAILS

A.PEREZ landscape architecture

ALEX PEREZ

10311 SW 142 COURT MIAMI, FL. 33186

CONSULTANT:

Revisions: 1 02/08/2021


PROJECT NO: DRAWN: CHECKED:

CADD FILE: DRAWING TITLE:

COVER

SHEET NO. L-0

COVER FINAL SUBMITTAL FEBRUARY 08, 2021

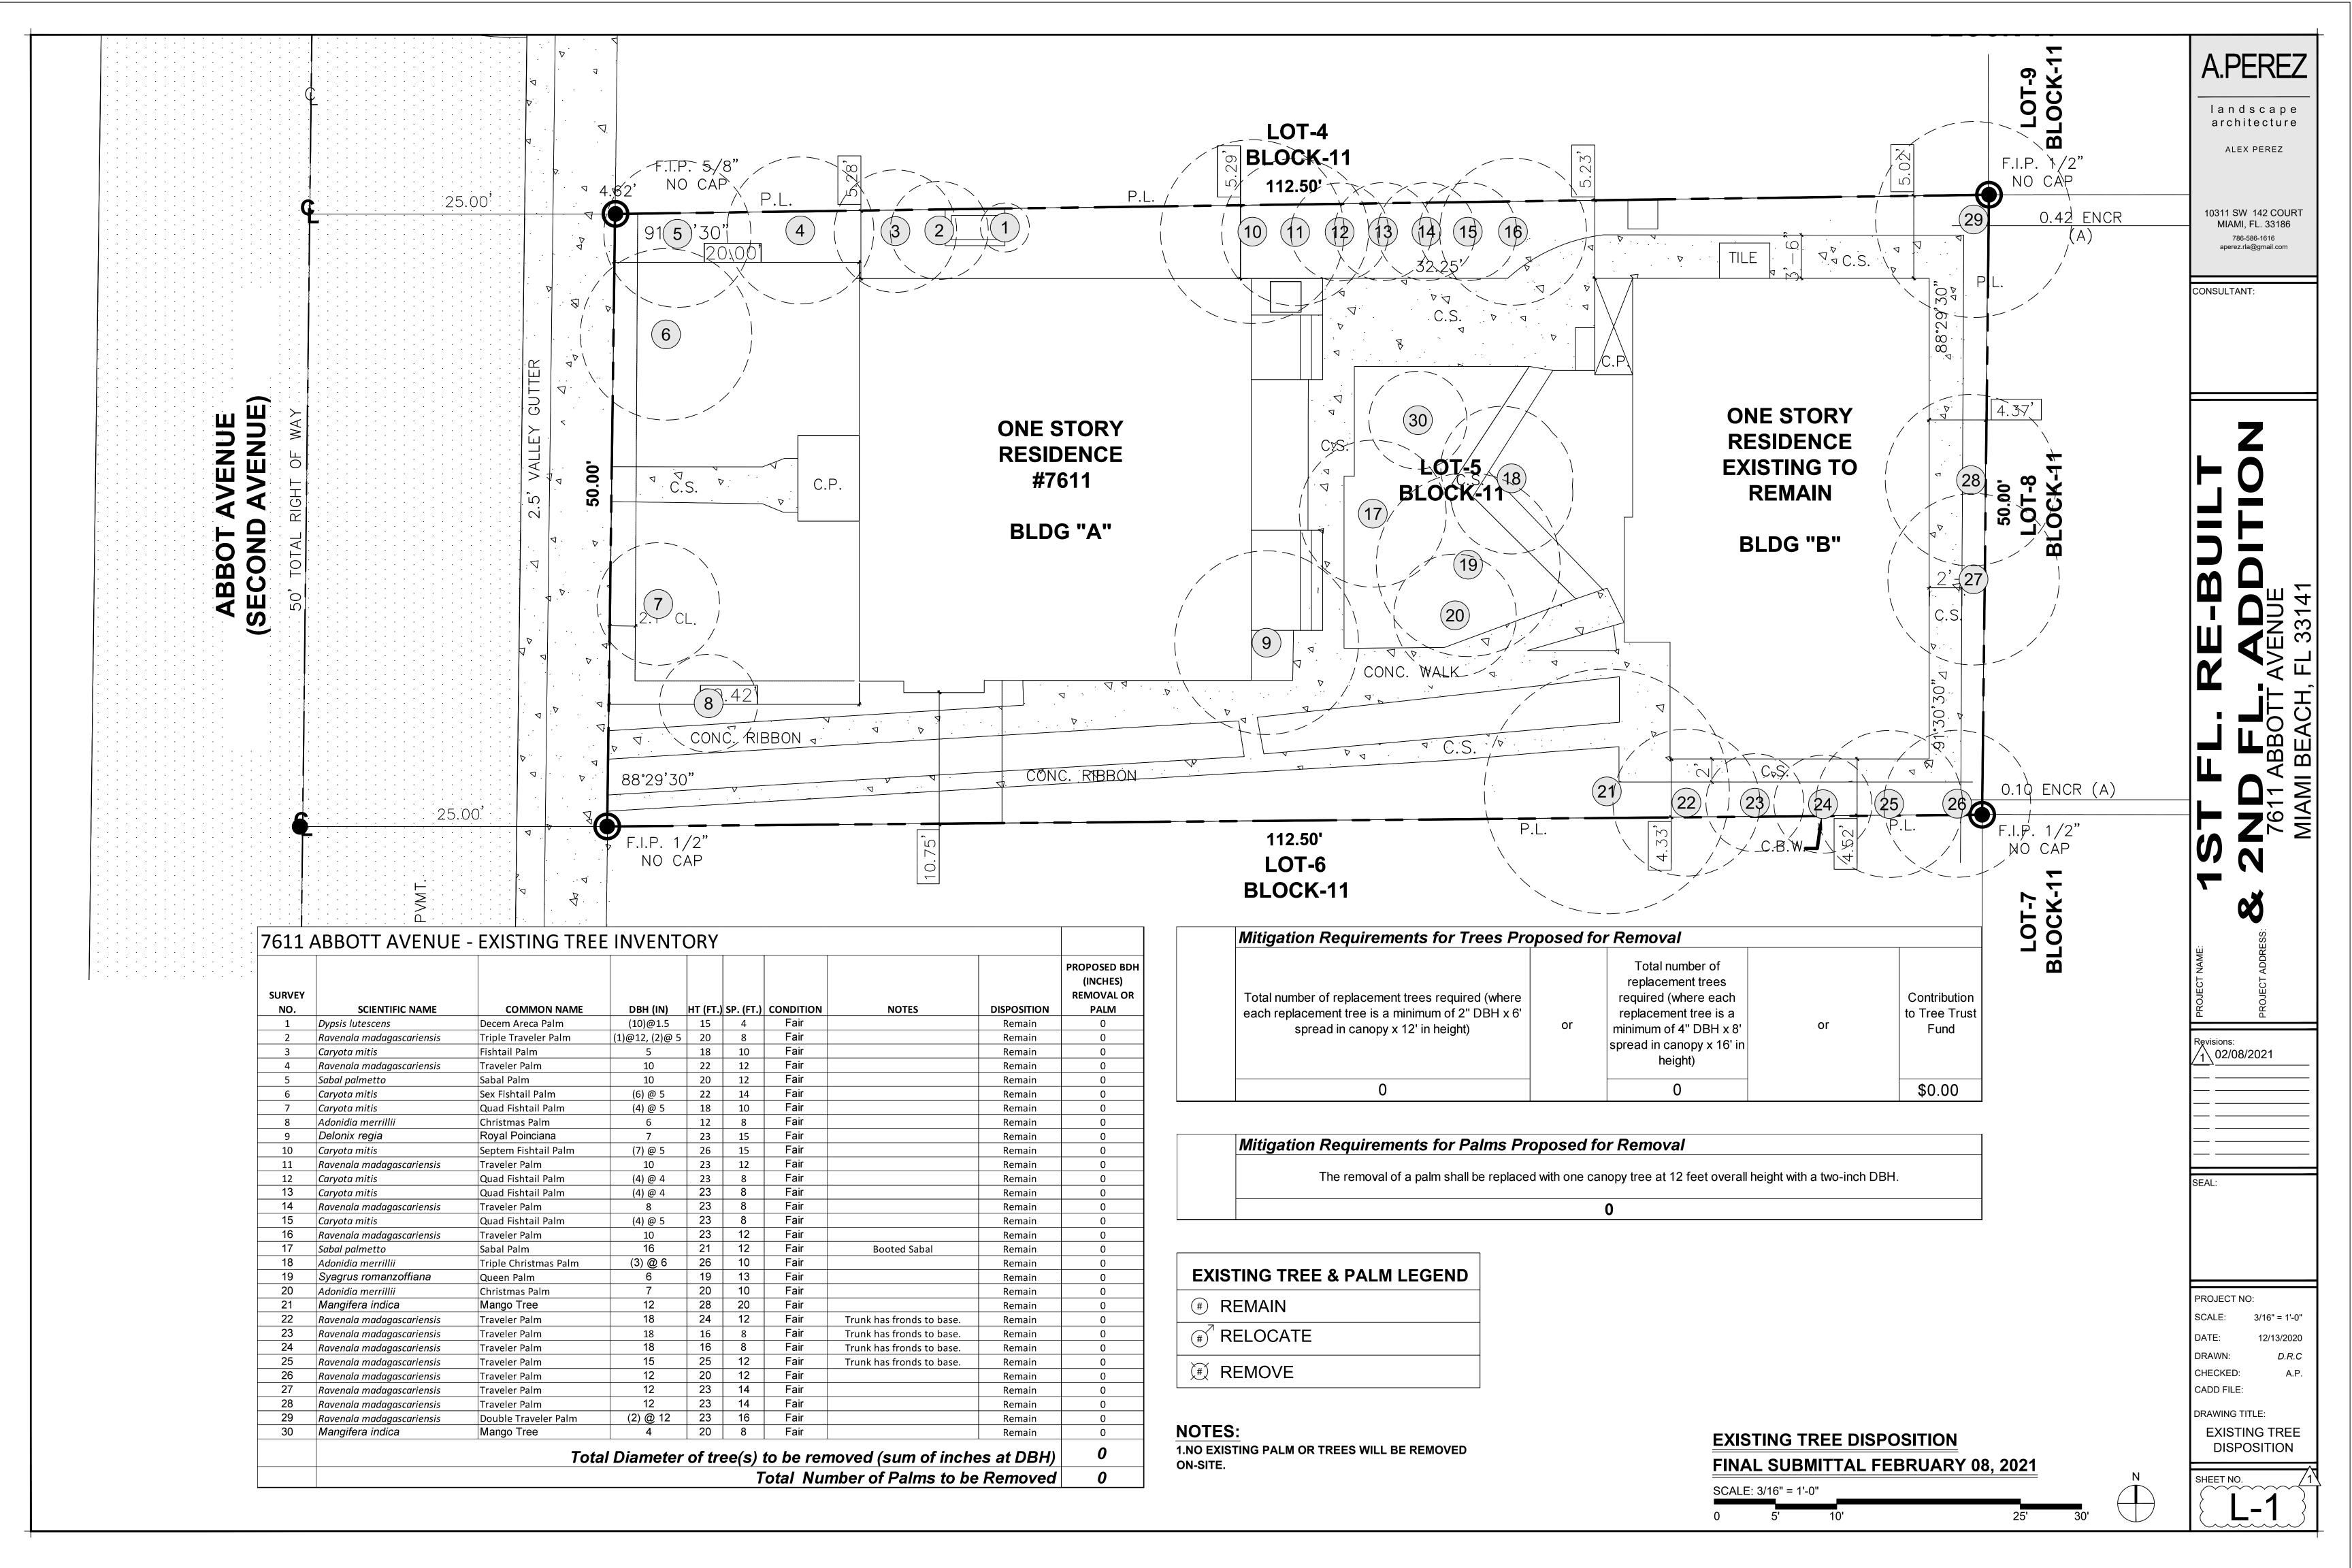

TREE / PALM PROTECTION NOTES

1. CONTRACTOR QUALIFICATIONS

- 1.1. CONTRACTOR MUST BE A LICENSED LANDSCAPE CONTRACTOR.
- 1.2. CONTRACTOR MUST HAVE A MINIMUM OF 10 YEARS OF PROVEN EXPERIENCE RELOCATING LARGE SPECIMEN TREES AND PALMS IN SOUTH FLORIDA.
- 1.3. CONTRACTOR MUST HAVE PROVEN EXPERIENCE RELOCATING TREES AND PALMS OF THE SAME SPECIES AND SIZE AS THOSE TO BE RELOCATED FOR THE CURRENT PROJECT.
- 1.4. CONTRACTOR MUST HAVE A CERTIFIED ARBORIST ON STAFF.

2. CONTRACTOR REQUIREMENTS

- 2.1. CONTRACTOR MUST VISIT THE JOBSITE AND INSPECT ALL TREES AND PALMS TO BE RELOCATED AS WELL AS EXISTING SITE CONDITIONS AND RESTRICTIONS PRIOR TO PREPARING BID.
- 2.2. CONTRACTOR MUST VERIFY AND ENSURE THAT ALL TREES AND PALMS IDENTIFIED ON THE PLANS AND THOSE TAGGED ON THE JOBSITE CORRESPOND AS TO NUMBER AND DESCRIPTION. ANY DISCREPANCIES MUST BE BROUGHT TO THE ATTENTION OF THE LANDSCAPE ARCHITECT IMMEDIATELY, PRIOR TO PREPARING BID.
- 2.3. CONTRACTOR MUST CONDUCT ALL WORK ASSOCIATED WITH RELOCATION AND MAINTENANCE OF TREES AND PALMS TO BE RELOCATED. NO WORK IS TO BE SUBCONTRACTED WITHOUT PRIOR WRITTEN CONSENT OF THE OWNER AND/OR LANDSCAPE ARCHITECT.
- 2.4. CONTRACTOR MUST DESIGNATE A COMPETENT, ENGLISH-SPEAKING SUPERVISOR OR FOREMAN TO OVERSEE AND DIRECT ALL RELOCATION AND MAINTENANCE ACTIVITIES AS OUTLINED IN THESE SPECIFICATIONS.
- 2.5. CONTRACTOR MUST SCHEDULE ROOT PRUNING TO PROVIDE THE MAXIMUM POSSIBLE TIME FOR NEW ROOT GROWTH. EVEN TREES AND PALMS THAT TYPICALLY DO NOT REQUIRE LONG (OR ANY) ROOT PRUNING WILL BENEFIT FROM MORE ROOT PRUNING TIME; THEREFORE, ALL TREES AND PALMS TO BE RELOCATED MUST BE ROOT PRUNED. CONTRACTOR MUST PROVIDE A ROOT PRUNE SCHEDULE FOR EACH TREE OR PALM TO BE RELOCATED AS AN ATTACHMENT TO THE BID.
- 2.6. CONTRACTOR MUST CALL SUNSHINE 811 TO HAVE ALL UNDERGROUND UTILITIES LOCATED UNDER OR IN THE VICINITY OF THE CURRENT OR FUTURE LOCATIONS OF ALL TREES AND PALMS TO BE RELOCATED PRIOR TO WORK COMMENCING.
- 2.7. CONTRACTOR MUST VERIFY WITH THE GENERAL CONTRACTOR THE ABSENCE OF ANY UNDERGROUND CONSTRUCTION OR OBSTRUCTIONS (*E.G.*, BULKHEADS, SEPTIC SYSTEMS, ETC.) IN THE CURRENT AND FUTURE LOCATIONS OF ALL TREES AND PALMS TO BE RELOCATED.
- 2.8. CONTRACTOR MUST ALERT THE LANDSCAPE ARCHITECT OF ANY TREES OR PALMS THAT WILL NOT SUCCESSFULLY RELOCATE DUE TO POOR HEALTH PRIOR TO BEGINNING ROOT PRUNING.
- 2.9. CONTRACTOR MUST FLAG ALL PROPOSED TRANSPLANT LOCATIONS FOR THE LANDSCAPE ARCHITECT'S APPROVAL A MINIMUM OF 15 DAYS PRIOR TO RELOCATION.
- 2.10. CONTRACTOR MUST ENSURE THAT ALL TREES AND PALMS TO BE RELOCATED ARE INSTALLED AT THE CORRECT GRADE OR ELEVATION, ACCORDING TO THE GRADING PLAN.
- 2.11. CONTRACTOR MUST ENSURE THAT ALL ROOT FLARES ARE EXPOSED AFTER RELOCATION.
- 2.12. CONTRACTOR MUST REMOVE ALL RESIDUAL ROOTS, STUMPS, AND PORTIONS THEREOF AND BACKFILL PITS FROM WHICH RELOCATED TREES AND PALMS WERE REMOVED WITH CLEAN FILL FLUSH WITH THE SURROUNDING GRADE.
- 2.13. CONTRACTOR MUST REPAIR ANY DAMAGE TO OTHER PLANTS, LAWN, HARDSCAPES, OR NEW CONSTRUCTION WITHIN THE RELOCATION AREA AT CONTRACTOR'S EXPENSE. HARDSCAPES INCLUDE BUT ARE NOT LIMITED TO CURBS, WALKS, ROADS, FENCES, SITE FURNISHINGS, ETC.
- 2.14. CONTRACTOR MUST PHOTOGRAPHICALLY DOCUMENT NEW ROOT GROWTH FOLLOWING EACH ROOT PRUNE AND SUBMIT THIS DOCUMENTATION TO THE LANDSCAPE ARCHITECT. THE PURPOSE OF THIS REQUIREMENT IS TO ENSURE THAT SUFFICIENT ROOT GROWTH HAS OCCURRED PRIOR TO THE SECOND AND SUBSEQUENT ROOT PRUNES AND FOLLOWING THE FINAL ROOT PRUNE PRIOR TO RELOCATION.
- 2.15. CONTRACTOR MUST INSTALL AND MAINTAIN PROTECTION FENCING AROUND EACH TREE AND PALM TO BE RELOCATED BOTH DURING ROOT PRUNING AND AFTER RELOCATION. PROTECTION FENCING MUST CONSIST OF GALVANIZED WELDED WIRE FABRIC OR PLASTIC MESH ATTACHED TO 4" X 4" POSTS INSERTED AROUND THE PERIMETER OF THE DRIPLINE OF THE TREE OR PALM. PROTECTION FENCING MUST BE PLUMB, TAUT, AND STURDY AT ALL TIMES AND MUST REMAIN IN PLACE THROUGHOUT THE ROOT PRUNING AND WARRANTY PERIODS, OR AS DIRECTED BY THE LANDSCAPE ARCHITECT.
- 2.16. CONTRACTOR MUST OBTAIN ALL NECESSARY OR REQUIRED PERMITS FOR THE RELOCATION AND TRANSPORTATION OF THE TREES AND PALMS TO BE RELOCATED.
- 2.17. CONTRACTOR MUST REPLACE ANY TREES OR PALMS SCARRED OR DAMAGED DURING RELOCATION, AT THE CONTRACTOR'S EXPENSE, WITH THE SAME OR SIMILAR SPECIES, SIZE, AND QUALITY. REPLACEMENT TREES OR PALMS MUST BE APPROVED BY THE LANDSCAPE ARCHITECT PRIOR TO PROCUREMENT, PREPARATION, AND/OR INSTALLATION. REPLACEMENT TREES AND PALMS MUST BE INSTALLED WITHIN 60 DAYS OF NOTICE.
- 2.18. CONTRACTOR MUST GUARANTEE ALL RELOCATED TREES AND PALMS FOR ONE YEAR FROM THE DATE OF RELOCATION TO THE FINAL LOCATION. GUARANTEE MUST INCLUDE TREE HEALTH AND SETTLING.
- 2.19. CONTRACTOR MUST PROVIDE ALL MATERIAL NECESSARY TO PERFORM THE WORK COVERED HEREIN, INCLUDING BUT NOT LIMITED TO BACKFILL MATERIAL, PROTECTION FENCING, FLAGGING, ADDITIVES AND SUPPLEMENTS, TEMPORARY IRRIGATION, BURLAP, WIRE, SHRINK WRAP, AND ALL NECESSARY TOOLS AND EQUIPMENT.

3. ROOT PRUNING SPECIFICATIONS

3.1. GENERAL

- 3.1.1. ALL TREES AND PALMS TO BE RELOCATED MUST BE WATERED DAILY FOR AT LEAST 2-3 DAYS PRIOR TO ANY ROOTS BEING CUT TO ENSURE THAT THEY ARE FULLY HYDRATED. EACH WATERING MUST THOROUGHLY SATURATE THE ROOTBALL TO ITS FULL DEPTH.
- 3.1.2. EACH TREE AND PALM MUST THEN BE WATERED EVERY OTHER DAY, NOT RELYING ON RAIN, DURING THE ENTIRE ROOT PRUNING PROCESS EITHER BY A TEMPORARY IRRIGATION SYSTEM OR BY HAND. EACH WATERING MUST THOROUGHLY SATURATE THE ROOTBALL TO ITS FULL DEPTH.
- 3.1.3. TREE AND PALM RELOCATION ACTIVITIES MUST BE SCHEDULED SO THAT REMOVAL AND REPLANTING TAKE PLACE IN THE SAME 24-HOUR PERIOD. NO TREES OR PALMS MAY BE "STOCKPILED" ONSITE OR OFFSITE FOR ANY PERIOD OF TIME WITHOUT PRIOR WRITTEN APPROVAL OF THE LANDSCAPE ARCHITECT. WHEN ALLOWED, APPROVAL FOR THE METHOD OF "STOCKPILING" MUST BE OBTAINED FROM THE LANDSCAPE ARCHITECT.
- 3.1.4. ALL DIGGING IN THE ROOT ZONE DURING THE ROOT PRUNE PROCESS MUST BE DONE BY HAND; NO MACHINERY WILL BE ALLOWED. PRUNING OF ROOTS MUST BE DONE BY HAND WITH CLEAN, SHARP TOOLS. DO NOT PAINT CUT ROOTS WITH TREE PAINT OR ANY KIND OF SEALANT.
- 3.1.5. MYCORRHIZA (ROOTS® TRANSPLANT OR EQUIVALENT) MUST BE INCORPORATED INTO THE BACKFILL

SOIL PRIOR TO BACKFILLING AS PER MANUFACTURER'S RECOMMENDATIONS.

- 3.1.6. AFTER EACH ROOT PRUNE, EACH SECTION OF ROOTBALL THAT IS PRUNED MUST BE WRAPPED WITH BLACK PLASTIC AND THE TRENCH BACKFILLED WITH ORIGINAL EXCAVATED SOIL. A TREE RING WITH A MINIMUM HEIGHT OF 6" MUST BE CONSTRUCTED 6-12" OUTSIDE THE OUTERMOST EDGE OF THE ROOTBALL AND AROUND THE ENTIRE PERIMETER OF THE ROOTBALL TO DIRECT IRRIGATION WATER AND ANY ADDED SUPPLEMENTS DOWN INTO THE ROOTBALL DURING ROOT REGENERATION.
- 3.1.7. ONCE THE TREE RING IS CONSTRUCTED AFTER EACH ROOT PRUNE, A HIGH-PHOSPHORUS ROOT STIMULANT MUST BE LIBERALLY APPLIED TO THE SURFACE OF THE ROOTBALL AND THOROUGHLY WATERED IN TO ENCOURAGE NEW ROOT GROWTH.

3.2. TREE

- 3.2.1. PRIOR TO ANY ROOTS BEING CUT, ALL MAJOR ROOTS MUST BE IDENTIFIED TO DETERMINE THE ROOTBALL DIAMETER BASED ON THE RELATIVE LOCATION AND SIZE OF THE ROOTS.
- 3.2.2. MANY TREE RELOCATION SPECIFICATIONS USE "GENERAL RULES" TO CALCULATE MINIMUM ROOTBALL DIAMETER, SUCH AS MULTIPLYING THE DIAMETER AT BREAST HEIGHT (DBH) OF THE TREE BY A FACTOR OF 10 OR ALLOWING A MINIMUM OF 9"-12" OF ROOTBALL FOR EVERY 1" OF TREE CALIPER. OTHERS LIST UNREALISTIC MINIMUM SIZES FOR THE ROOTBALLS OF VARIOUS TREE CALIPERS OR HEIGHTS. IN MANY CASES, SUCH APPROACHES RESULT IN ROOTBALLS THAT ARE EITHER TOO LARGE OR TOO SMALL FOR A GIVEN TREE. THE FOLLOWING TABLE LISTS MINIMUM ROOTBALL DIAMETERS BASED ON REAL-WORLD EXPERIENCE OF TREE RELOCATION SPECIALISTS IN SOUTH FLORIDA:

CALIPER	MIN. ROOTBALL	CALIPER	MIN. ROOTBA
(inches)	DIA. (feet)	(inches)	DIA. (feet)
1 - 4	3	12 - 14	8
4 - 5	4	15 - 17	10
6 - 7	5	18 - 24	12 - 15
8 - 9	6	25 - 30	15 - 25
10 -11	7	30 +	as needed

- 3.2.3. WHENEVER POSSIBLE, ROOTBALLS MUST BE CIRCULAR IN SHAPE WITH AN EQUAL DISTANCE FROM THE TRUNK TO THE EDGE OF THE ROOTBALL ALL AROUND.
- 3.2.4. MINIMUM ROOTBALL DEPTH MUST BE 24"-36" FOR ALL TREES TO BE RELOCATED, WITH THE ACTUAL DEPTH TO BE DETERMINED ONLY AFTER A THOROUGH EXAMINATION OF ALL ROOTS DURING THE INITIAL ROOT INSPECTION AND BASED ON THE ABSENCE OF MAJOR ROOTS AT THE BOTTOM OF THE ROOTBALL. ROOTBALLS DEEPER THAN 36" MAY BE REQUIRED FOR LARGE SPECIMEN TREES, DEPENDING ON THE RELATIVE LOCATIONS AND DEPTHS OF THE MAJOR ROOTS AS OBSERVED DURING THE INITIAL ROOT INSPECTION.
- 3.2.5. AS A GENERAL RULE, MINIMUM ROOT PRUNE TIME FOR TREES WITH A DBH OF LESS THAN 10" IS 12 WEEKS. THE FIRST ROOT PRUNE MUST BE ON TWO OPPOSING SIDES OF THE ROOTBALL, WITH THE SECOND ROOT PRUNE ON ONE OF THE OTHER TWO SIDES DONE A MINIMUM OF 6 WEEKS LATER, AND A THIRD ROOT PRUNE ON THE LAST SIDE DONE A MINIMUM OF 3 WEEKS AFTER THAT. THE SECOND AND THIRD ROOT PRUNES MAY ONLY BE DONE WHEN HEALTHY NEW ROOT GROWTH FROM EARLIER ROOT PRUNES IS EVIDENT (SEE SECTION 2.14 ABOVE FOR SPECIFICATIONS ON PHOTOGRAPHICALLY DOCUMENTING NEW ROOT GROWTH DURING THE ROOT PRUNE PROCESS). MORE TIME MAY BE NEEDED DURING THE COOLER MONTHS OF THE YEAR.
- 3.2.6. AS A GENERAL RULE, MINIMUM ROOT PRUNE TIME FOR TREES WITH A DBH OF 10" OR GREATER IS 24 WEEKS. THE FIRST ROOT PRUNE MUST BE ON TWO OPPOSING SIDES OF THE ROOTBALL, WITH THE SECOND ROOT PRUNE ON ONE OF THE OTHER TWO SIDES DONE A MINIMUM OF 12 WEEKS LATER, AND A THIRD ROOT PRUNE ON THE LAST SIDE DONE A MINIMUM OF 6 WEEKS AFTER THAT. THE SECOND AND THIRD ROOT PRUNES MAY ONLY BE DONE WHEN HEALTHY NEW ROOT GROWTH FROM EARLIER ROOT PRUNES IS EVIDENT (SEE SECTION 2.14 ABOVE FOR SPECIFICATIONS ON PHOTOGRAPHICALLY DOCUMENTING NEW ROOT GROWTH DURING THE ROOT PRUNE PROCESS). MORE TIME MAY BE NEEDED DURING THE COOLER MONTHS OF THE YEAR.
- 3.2.7. CERTAIN HARDWOOD TREES AND GYMNOSPERMS REQUIRE LONGER ROOT PRUNING TIMES. THESE INCLUDE, BUT ARE NOT LIMITED TO, THE FOLLOWING:
 - AVOCADO (PERSEA AMERICANA)
 - BLACK OLIVE (BUCIDA BUCERAS)
 - BRIDALVEIL (CAESALPINIA GRANADILLO)
 - CASSIAS (ALL SPECIES OF CASSIA)
 - LIGNUM VITAE (GUAIACUM SANCTUM & G. OFFICINALE)
 PODOCARPUS (PODOCARPUS SP.)
 - LIVE OAK (QUERCUS VIRGINIANA)
 - MAHOGANY (SWIETENIA MAHAGONI)
 - MANGO (MANGIFERA INDICA)
 - PIGEON PLUM (COCCOLOBA DIVERSIFOLIA)
 - SWEET ACACIA (ACACIA FARNESIANA)
 VERAWOOD (BULNESIA ARBOREA)
 - VERAWOOD (BULNESIA ARBOREA)
 WILD TAMARIND (LYSILOMA LATISILIQUUM & L. SABICU)

FOR THESE TREES, THE MINIMUM ROOT PRUNE TIMES DISCUSSED IN SECTIONS 3.2.5 AND 3.2.6 ABOVE MAY BE INSUFFICIENT. ONLY WHEN SUFFICIENT NEW ROOT GROWTH HAS TAKEN PLACE FOLLOWING AN EARLIER ROOT PRUNE CAN THE NEXT ROOT PRUNE BE DONE, AND ONLY WHEN SUFFICIENT NEW ROOT GROWTH HAS TAKEN PLACE FOLLOWING THE FINAL ROOT PRUNE MAY THE TREE BE RELOCATED (SEE SECTION 2.14 ABOVE FOR SPECIFICATIONS ON PHOTOGRAPHICALLY DOCUMENTING NEW ROOT GROWTH DURING THE ROOT PRUNE PROCESS).

3.1. <u>PALMS</u>

3.1.1. THE FOLLOWING TABLE LISTS MINIMUM ROOTBALL DIAMETERS FOR VARIOUS SPECIES OF PALMS BASED ON REAL-WORLD EXPERIENCE OF RELOCATION SPECIALISTS IN SOUTH FLORIDA:

PALM SPECIES
SABAL / CABBAGE PALM
QUEEN & FOXTAIL PALMS
ROYAL & COCONUT PALMS
CANARY DATE PALM
SLOW-GROWING PALMS
(see sec. 3.3.4)

36" diameter 12" from trunk in all directions 18 - 24" from trunk in all directions 24" from trunk in all directions 24" from trunk in all directions

ROOTBALL SPECIFICATIONS

- 3.1.2. PALM ROOTBALLS MUST BE A MINIMUM OF 24" DEEP. WHENEVER POSSIBLE, ROOTBALLS MUST BE CIRCULAR IN SHAPE WITH AN EQUAL DISTANCE FROM THE TRUNK TO THE EDGE OF THE ROOTBALL ALL AROUND..
- 3.1.3. AS A GENERAL RULE, MINIMUM ROOT PRUNE TIME FOR PALMS IS 6-8 WEEKS. THE FIRST ROOT PRUNE MUST BE ON TWO OPPOSING SIDES OF THE ROOTBALL, WITH THE SECOND ROOT PRUNE ON ONE OF

THE OTHER TWO SIDES DONE A MINIMUM OF 3-4 WEEKS LATER, AND A THIRD ROOT PRUNE ON THE LAST SIDE DONE A MINIMUM OF 4.5-6 WEEKS AFTER THAT. THE SECOND AND THIRD ROOT PRUNES MAY ONLY BE DONE WHEN HEALTHY NEW ROOT GROWTH FROM EARLIER ROOT PRUNES IS EVIDENT (SEE SECTION 2.14 ABOVE FOR SPECIFICATIONS ON PHOTOGRAPHICALLY DOCUMENTING NEW ROOT GROWTH DURING THE ROOT PRUNE PROCESS). MORE TIME MAY BE NEEDED DURING THE COOLER MONTHS OF THE YEAR.

- 3.1.4. CERTAIN PALMS, IN PARTICULAR THOSE THAT ARE SLOW GROWING, REQUIRE LONGER ROOT PRUNING TIME. THESE INCLUDE, BUT ARE NOT LIMITED TO, THE FOLLOWING:
- ALL SPECIES OF ARCHONTOPHOENIX
- ALL SPECIES OF CORYPHA
- AMERICAN OIL PALMS (ALL SPECIES OF ATTALEA)
- BISMARCK PALM (*BISMARCKIA NOBILIS*)
- CUBAN & CARIBBEAN COPERNICIA
- CUBAN BELLY PALM (GASTROCOCOS CRISPA)
- GINGERBREAD/DOUM PALMS (ALL SPECIES OF HYPHAENE)

 DALMAYDA DALMS (ALL SPECIES OF BODASSYIO)
- PALMYRA PALMS (ALL SPECIES OF *BORASSUS*)
- SATAKE PALM (SATAKENTIA LIUKIUENSIS)
 SAW PALMETTO (SERENOA REPENS)
- SILVER PALM (COCCOTHRINAX ARGENTATA)
- ZOMBIE PALM (ZOMBIA ANTILLARUM)

FOR THESE PALMS, THE MINIMUM ROOT PRUNING TIME IS 4-6 MONTHS OR GREATER. ONLY WHEN SUFFICIENT NEW ROOT GROWTH HAS TAKEN PLACE FOLLOWING AN EARLIER ROOT PRUNE CAN THE NEXT ROOT PRUNE BE DONE, AND ONLY WHEN SUFFICIENT NEW ROOT GROWTH HAS TAKEN PLACE FOLLOWING THE FINAL ROOT PRUNE MAY THE TREE BE RELOCATED (SEE SECTION 2.14 ABOVE FOR SPECIFICATIONS ON PHOTOGRAPHICALLY DOCUMENTING NEW ROOT GROWTH DURING THE ROOT PRUNE PROCESS).


4. CANOPY PRUNING SPECIFICATIONS

4.1. <u>TRE</u>

- 4.1.1. PRIOR TO RELOCATION, THE CANOPY OF EACH TREE TO BE RELOCATED MUST BE SELECTIVELY PRUNED TO REMOVE CROSSING, DEAD, DISEASED, BROKEN, AND LOW-HANGING BRANCHES THAT MAY INTERFERE WITH CONSTRUCTION ACTIVITIES, OR THAT MAY INTERFERE OR RESTRICT STRAPPING OR LIFTING THE TREE DURING RELOCATION.
- 4.1.2. FOR TREES BEING RELOCATED ONSITE, THE CANOPY MAY BE SELECTIVELY THINNED AND REDUCED BY NO MORE THAN 1/3 OF THE OVERALL CANOPY MASS, AT THE DIRECTION OF THE LANDSCAPE ARCHITECT; HOWEVER, THE BASIC SHAPE, FORM, AND CHARACTER OF THE TREE MUST BE PRESERVED.
- 4.1.3. FOR TREES BEING RELOCATED OFFSITE, THE CANOPY MUST BE PRUNED, AT THE DIRECTION OF THE LANDSCAPE ARCHITECT, TO FIT ON THE TRAILER FOR TRANSPORT. EVERY EFFORT MUST BE MADE TO RETAIN AS MANY LARGE BRANCHES AS POSSIBLE AND TO PRESERVE AS MUCH OF THE SHAPE, FORM, AND CHARACTER OF THE TREE AS POSSIBLE TO THE WIDEST LOAD WIDTH ALLOWABLE BY THE FLORIDA DEPARTMENT OF TRANSPORTATION. CONTRACTOR MUST OBTAIN ALL NECESSARY PERMITS AND ESCORTS TO TRANSPORT WIDE LOADS, PER FLORIDA LAW.
- 4.1.4. ALL CANOPY PRUNING MUST BE CONDUCTED FOLLOWING ANSI A-300 TREE PRUNING STANDARDS AND BEST MANAGEMENT PRACTICES.
- 4.1.5. ALL DEBRIS GENERATED DURING CANOPY PRUNING MUST BE REMOVED OFFSITE AND DISPOSED.

4.2. PALMS

- 4.2.1. IT IS WELL KNOWN THAT SOME PALMS SURVIVE RELOCATION BETTER WHEN ALL OF THE LEAVES ARE REMOVED (*E.G.*, CABBAGE PALM, *SABAL PALMETTO*), AND THAT OTHER PALMS BENEFIT FROM HAVING THEIR LEAVES CUT IN HALF DURING RELOCATION (*E.G.*, COCONUT PALM, *COCOS NUCIFERA*). BOTH OF THESE HORTICULTURAL PRACTICES, WHILE TRUE, ARE ONLY APPLICABLE WHEN PALMS ARE NOT ROOT PRUNED. LEAVES DO NOT NEED TO BE CUT IN HALF OR REMOVED FROM PALMS THAT ARE ADEQUATELY ROOT PRUNED. ON OCCASION WHEN SUFFICIENT ROOT PRUNING TIME IS NOT AVAILABLE, PALMS TO BE RELOCATED MAY HAVE THEIR LEAVES CUT IN HALF OR REMOVED ENTIRELY AT THE DIRECTION OF THE LANDSCAPE ARCHITECT.
- 4.2.2. PALM LEAVES MUST BE TIED UP WITH 2-PLY BIODEGRADABLE TWINE PRIOR TO RELOCATION TO PREVENT MECHANICAL DAMAGE DURING THE RELOCATION PROCESS.
- 4.2.3. PALM TRUNKS SHALL ONLY BE 'CLEANED UP' ACCORDING TO THE LANDSCAPE ARCHITECT'S SPECIFICATIONS SPECIFIC TO EACH PALM.

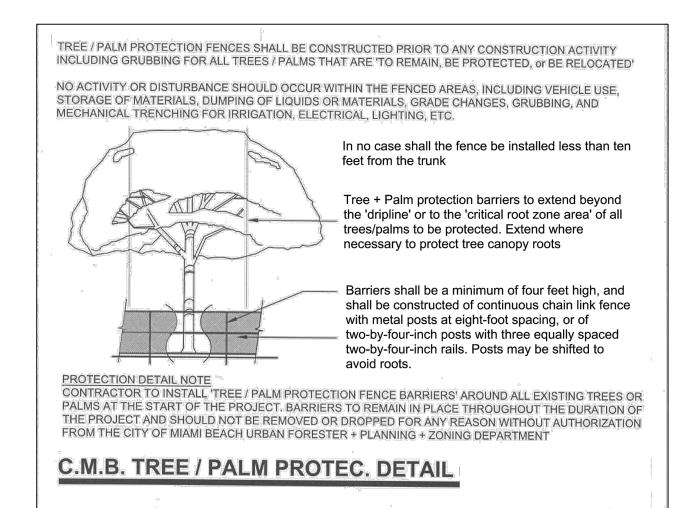

EXISTING TREE NOTES & DETAIL

FINAL SUBMITTAL FEBRUARY 08, 2021

A.PEREZ

landscape architecture

ALEX PEREZ

10311 SW 142 COURT MIAMI, FL. 33186 786-586-1616 aperez.rla@gmail.com

CONSULTANT:

ROJECT ADDRESS:

SEAL:

PROJECT NO:

SCALE: 3/16" = 1'-0"

DATE: 12/13/2020

DRAWN: *D.R.C*

A.P.

CADD FILE:

DRAWING TITLE:


EXISTING TREE


NOTES

CHECKED:

SHEET NO.

L-2

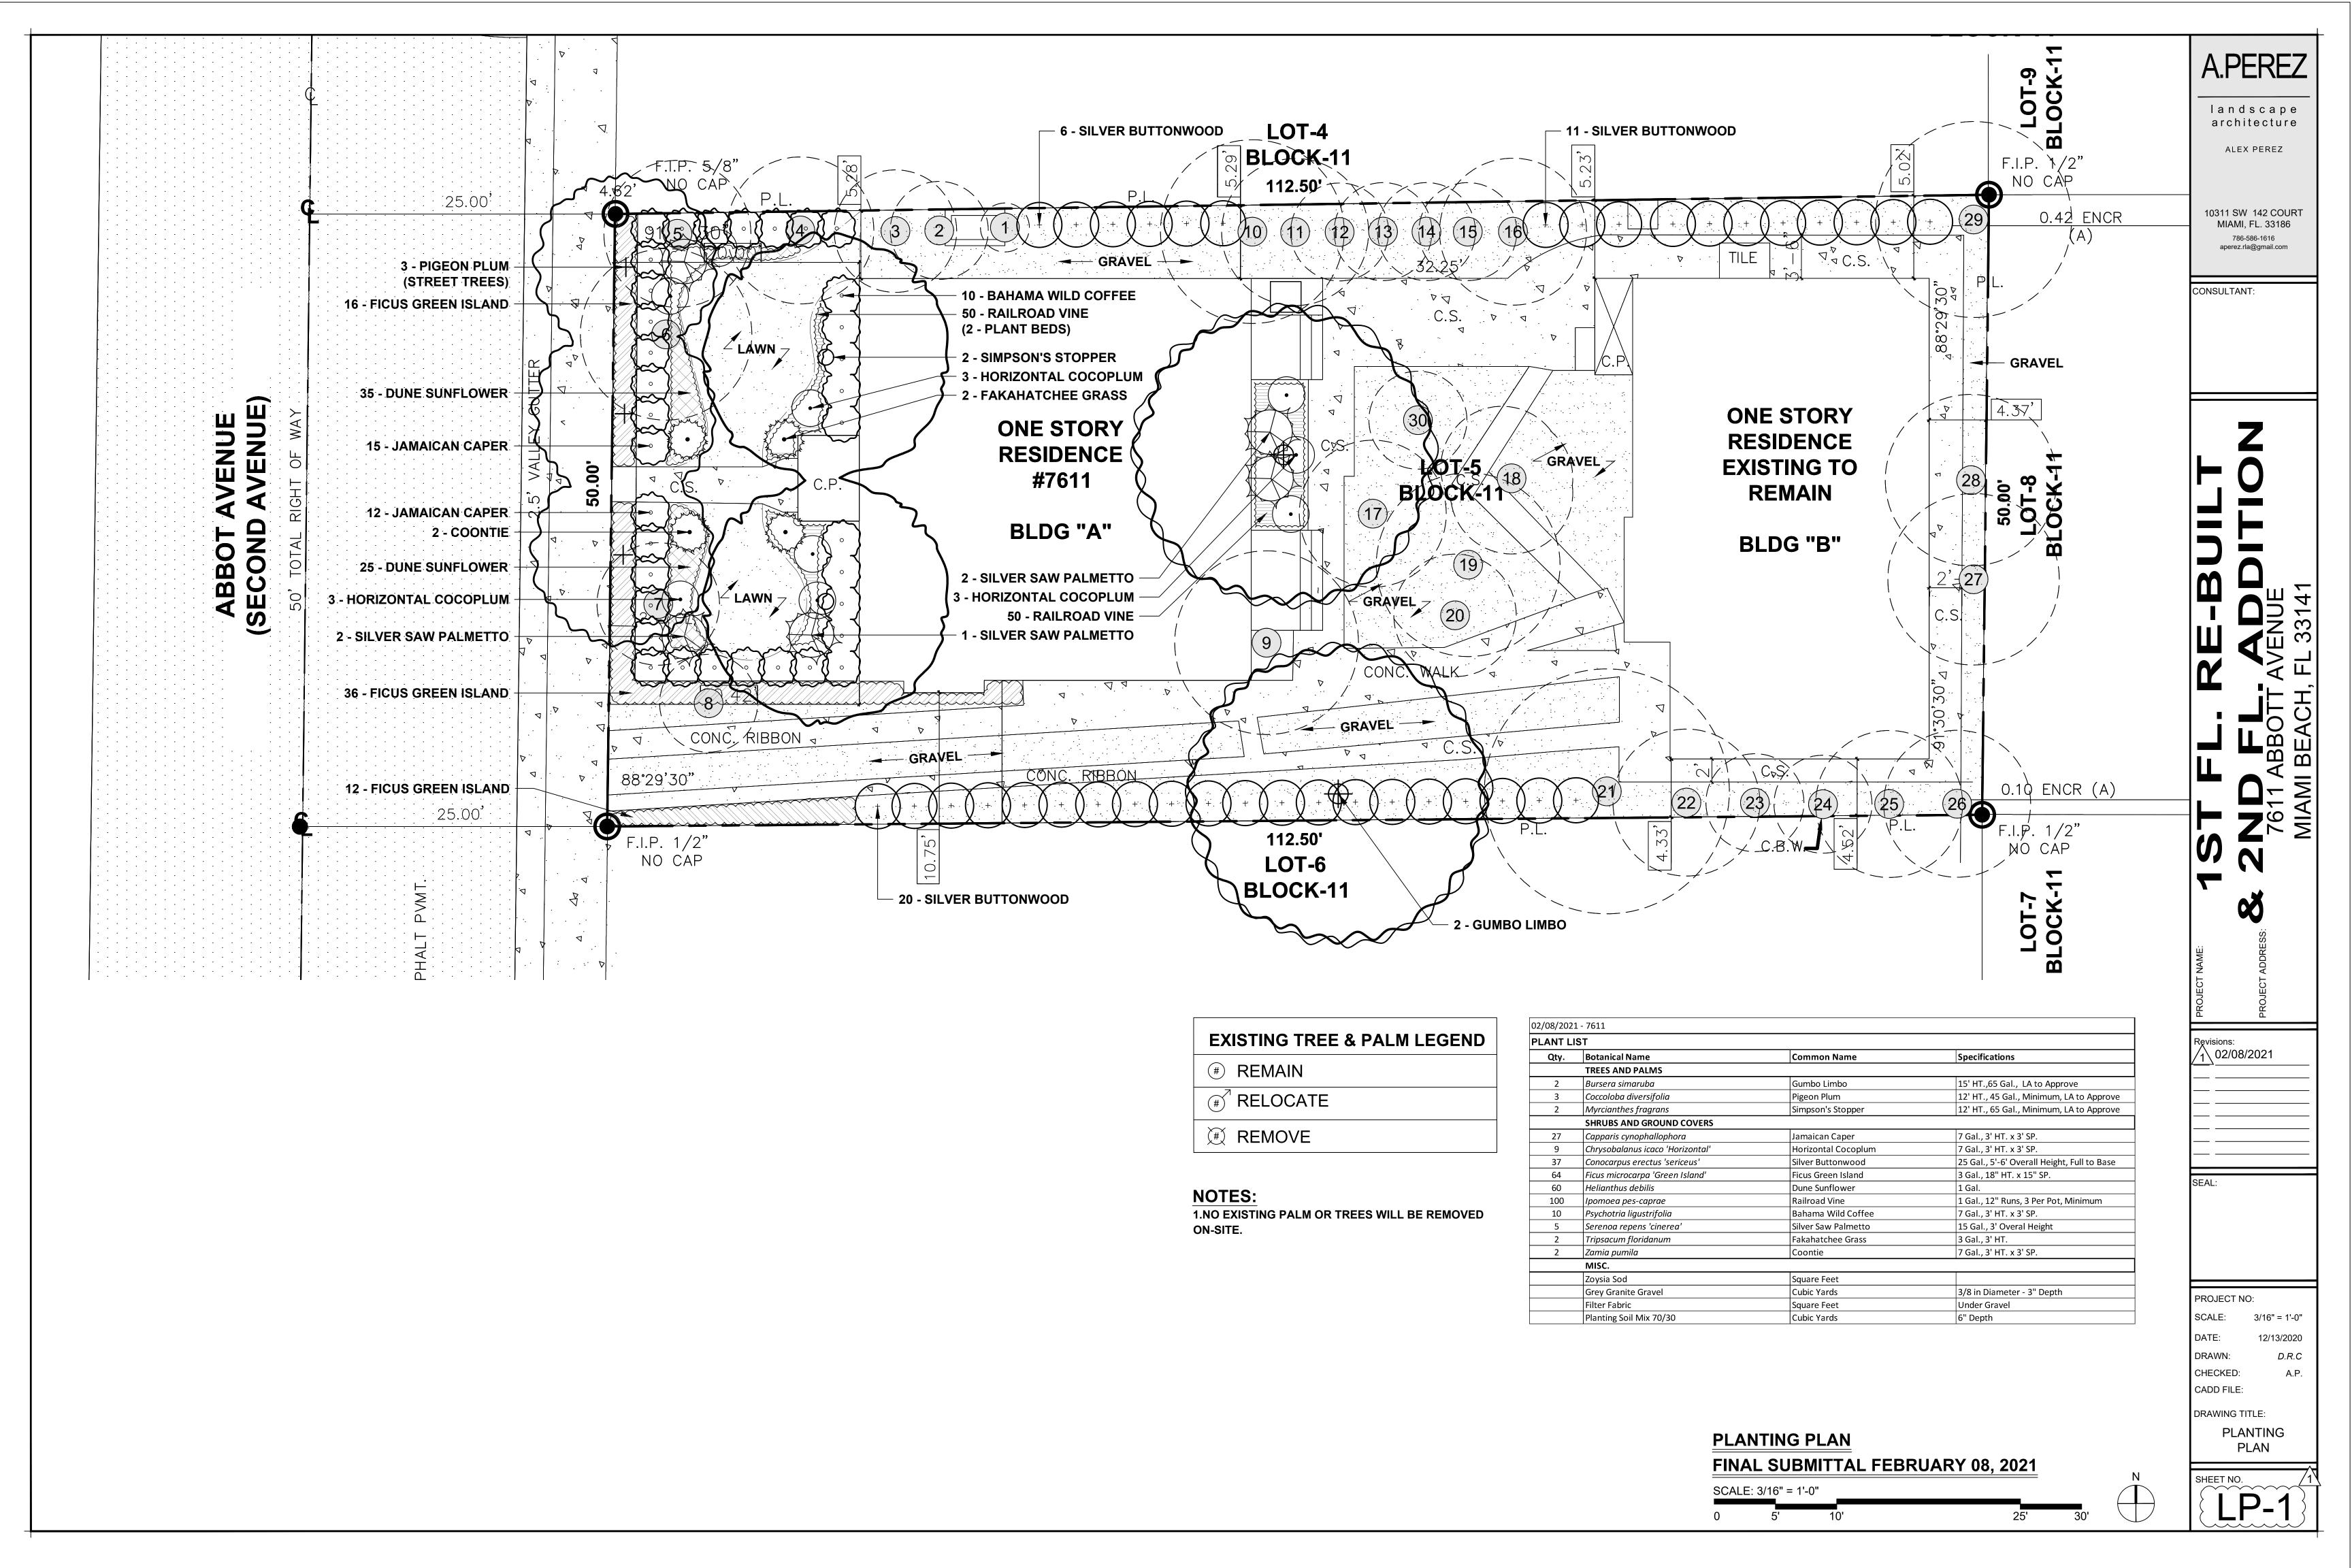

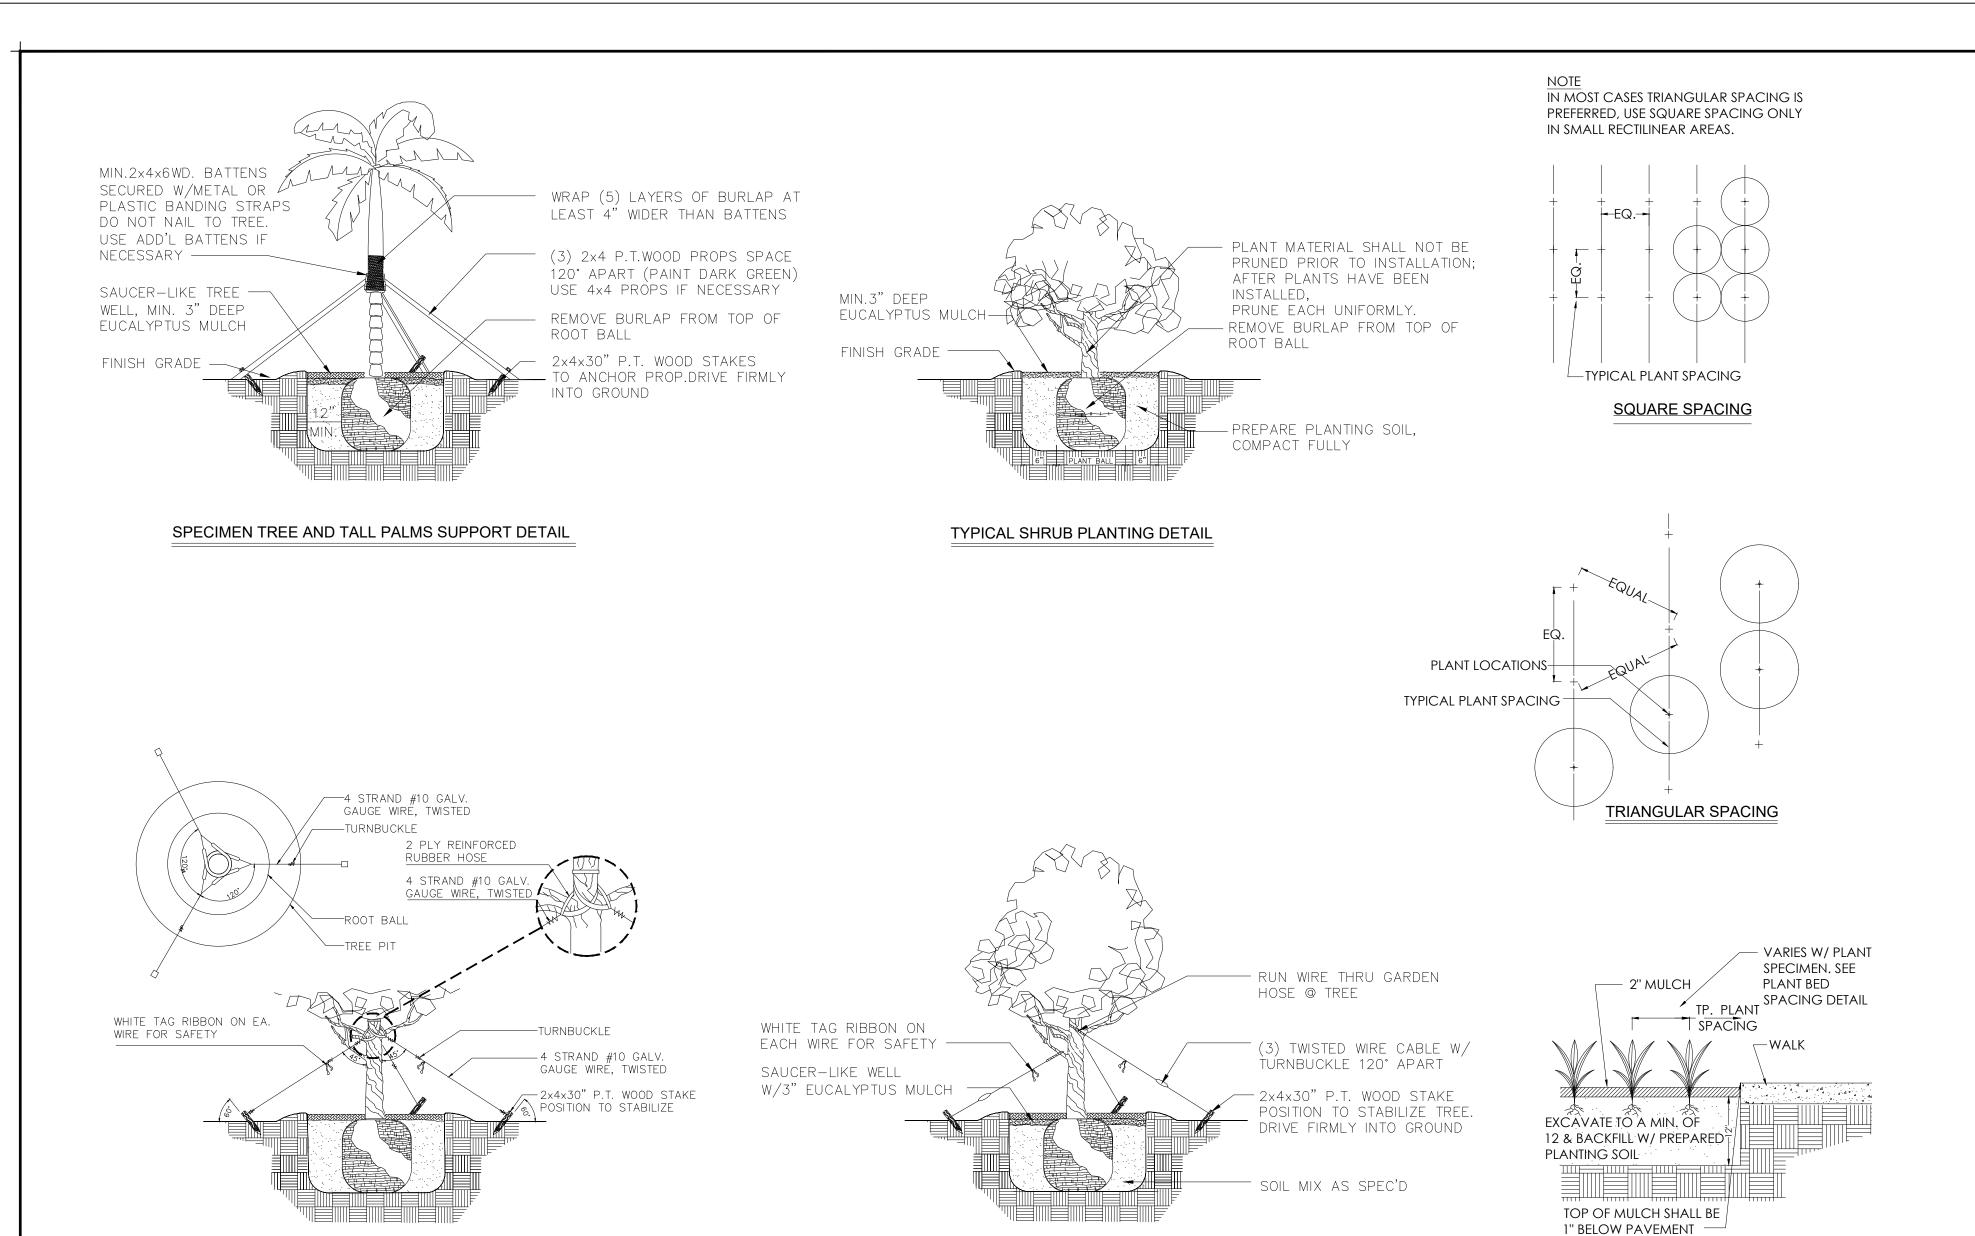

GENERAL LANDSCAPE NOTES:

- 1. ALL PLANT MATERIAL IS TO BE FLORIDA NO. 1 OR BETTER. FLORIDA DEPARTMENT OF AGRICULTURE GRADES AND STANDARDS, PARTS I & II 1973, 1975 RESPECTIVELY.
- 2. ALL PLANTING BEDS TO BE TOPPED WITH 2"MIN. "GRADE A" CYPRESS OR EUCALYPTUS MULCH, UNLESS OTHERWISE NOTED.
- 3. ALL TREES TO BE STAKED IN A GOOD WORKMANLIKE MANNER. NO NAIL STAKING PERMITTED. (REFER TO PLANTING DETAILS .)
- 4. LANDSCAPE PLAN SHALL BE INSTALLED IN COMPLIANCE WITH ALL LOCAL CODES.
- 5. ALL TREE HOLDS TO BE BACK FILLED AROUND AND UNDER ROOT BALL WITH PLANTING SOIL. ALL SHRUB BEDS TO BE INSTALLED WITH PLANTING SOIL. (SEE SPECS)
- 6. SOD SHALL BE "FLORATAM" ST. AUGUSTINE (UNLESS OTHERWISE NOTED) SOLID SOD LAID WITH ALTERNATIVE AND ABUTTING JOINTS, WITH 2" TOP SOIL MINIMUM IF REQUIRED. (SEE SPECS)
- 7. ALL TREES, SHRUBS AND GROUND COVERS SHALL BE GUARANTEED FOR TWELVE MONTHS FROM DATE OF FINAL ACCEPTANCE. ALL PALMS ARE TO BE GUARANTEED FOR ONE YEAR.
- 8. ALL PLANTING BEDS SHALL BE WEED AND GRASS FREE.

TREE PLANTING AND GUYING DETAIL

- 9. ALL TREES, PALMS, SHRUBS AND GROUNDCOVER PLANTS SHALL BE FERTILIZED AT INSTALLATION WITH LONG LASTING FERTILIZER, ACCORDING TO MANUFACTURES RECOMMENDATIONS. (SUBMIT SAMPLE FOR APPROVAL.) (SEE SPEC)
- 10. PLANTING PLAN SHALL TAKE PRECEDENCE OVER PLANT LIST IN CASE OF DISCREPANCIES. (NOTIFY LANDSCAPE ARCHITECT FOR DIRECTION.)
- 11. LANDSCAPE CONTRACTOR SHALL LOCATE AND VERIFY ALL UNDERGROUND UTILITIES PRIOR TO DIGGING.
- 12. NO CHANGE SHALL BE MADE WITHOUT THE PRIOR CONSENT OF THE LANDSCAPE ARCHITECT.
- 13. ALL MATERIAL IS SUBJECT TO AVAILABILITY AT TIME OF INSTALLATION.
 SUBSTITUTIONS MAY BE MADE AFTER CONSULTATION WITH LANDSCAPE
 ARCHITECT.
- 14. ALL NEWLY PLANTED AREAS TO RECEIVE 100% COVERAGE BY AUTOMATIC IRRIGATION SYSTEM. (REFER TO IRRIGATION PLAN.)
- 15. ALL PLANTING BEDS TO RECEIVE NEW PLANTING SOIL (1/3 EVERGLADES PEAT, 1/3 SAND, 1/3 CYPRESS SAWDUST & CHOPS) MINIMUM 6" DEEP. (REFER TO PLANTING DETAILS.)
- 16. CONTRACTOR WILL VISIT SITE TO FAMILIARIZED HIMSELF WITH THE SCOPE OF WORK PRIOR TO SUBMITTING A BID.
- 17. LANDSCAPE CONTRACTOR TO COORDINATE HIS WORK WITH THE GENERAL CONTRACTOR, THE IRRIGATION CONTRACTOR, AND THE ELECTRICAL CONTRACTOR.

- 18. ALL EXISTING PLANT MATERIAL TO REMAIN SHALL BE PROTECTED. (REFER TO DEMOLITION PLAN.)
- 19. ALL TREES TO BE RELOCATED WILL GET ROOT PRUNED 30 DAYS MIN. (OR MORE IF REQUIRED BY THE SPECIES). UPON RELOCATION, THIN OUT (UNDER LANDSCAPE ARCHITECT'S DIRECTION) 30% OF THE TREE CANOPY TO BE RELOCATED.

PLANTING DETAIL

- 20.AFTER REMOVAL OR RELOCATION OF EXISTING TREES AND PALMS, BACKFILL TREE PIT WITH PLANTING SOIL AND SOD DISTURBED AREA, AS REQUIRED.
- 21.ALL TREES ON SOD AREAS SHALL RECEIVE A MULCH RING 2' IN DIAMETER TYPICAL.
- 22.ALL TREES SHALL HAVE A 2" CALIPER AT D.B.H. MINIMUM FOR A 10' HEIGHT TREE.
- 23.ALL 1 GALLON MATERIAL TO HAVE A 12" SPREAD MINIMUM, ALL 3 GALLON MATERIAL TO HAVE A 20-24" SPREAD MINIMUM.

TREE BRACING NOTES:

SMALL TREE SUPPORT DETAIL

2" AND LARGER CALIPER TREES BRACED BY GUYING -

- 1. CHOOSE THE CORRECT SIZE AND NUMBER OF STAKES AND SIZE OF HOSE AND WIRE. GUYING SHALL BE COMPLETED WITHIN 48 HOURS OF PLANTING THE TREE.
- 2. CUT LENGTHS OF STAKING HOSE TO EXTEND 2 INCHES PAST TREE TRUNK WHEN WRAPPING AROUND.
- 3. SPACE STAKES EVENLY ON OUTSIDE OF WATER RING AND DRIVE EACH FIRMLY INTO THE GROUND. STAKES SHOULD BE DRIVING AT A 30 DEGREE ANGLE WITH THE POINT OF THE STAKE TOWARD THE TREE UNTIL 4 TO 5 INCHES ARE LEFT SHOWING.
- 4. PLACE THE HOSE AROUND THE TREE TRUCK JUST ABOVE THE LOWEST BRANCH.
- 5. THREAD THE WIRE THROUGH THE HOSE AND PAST THE STAKE, ALLOWING APPROXIMATELY 2 FEET OF EACH OF THE TWO ENDS BEYOND THE STAKE BEFORE CUTTING THE WIRE.
- 6. TWIST WIRE AT RUBBER HOSE TO KEEP IT IN PLACE.
- 7. PULL WIRE DOWN AND WIND BOTH ENDS AROUND STAKE TWICE. TWIST WIRE BACK ONTO ITSELF TO SECURE IT BEFORE CUTTING OFF THE EXCESS.
- 8. THE ABOVE PROCEDURES ARE TO BE FOLLOWED FOR EACH STAKE, KEEPING THE TREE STRAIGHT AT ALL TIMES. THERE SHOULD BE A 1 TO 3 INCH SWAY IN THE TREE (THE WIRES SHOULD NOT BE PULLED TIGHT) FOR BEST ESTABLISHMENT.
- 9. FLAG THE GUY WIRES WITH SURVEYOR'S FLAGGING OR APPROVED EQUAL FOR SAFETY.
- 10. GUYS ARE NOT TO BE REMOVED UNTIL APPROVED BY LANDSCAPE CONTRACTOR.

02/08/202	1 - 7611		
PLANT L	IST		
Qty.	Botanical Name	Common Name	Specifications
	TREES AND PALMS		
2	Bursera simaruba	Gumbo Limbo	15' HT.,65 Gal., LA to Approve
3	Coccoloba diversifolia	Pigeon Plum	12' HT., 45 Gal., Minimum, LA to Approve
2	Myrcianthes fragrans	Simpson's Stopper	12' HT., 65 Gal., Minimum, LA to Approve
	SHRUBS AND GROUND COVERS		
27	Capparis cynophallophora	Jamaican Caper	7 Gal., 3' HT. x 3' SP.
9	Chrysobalanus icaco 'Horizontal'	Horizontal Cocoplum	7 Gal., 3' HT. x 3' SP.
37	Conocarpus erectus 'sericeus'	Silver Buttonwood	25 Gal., 5'-6' Overall Height, Full to Base
64	Ficus microcarpa 'Green Island'	Ficus Green Island	3 Gal., 18" HT. x 15" SP.
60	Helianthus debilis	Dune Sunflower	1 Gal.
100	Ipomoea pes-caprae	Railroad Vine	1 Gal., 12" Runs, 3 Per Pot, Minimum
10	Psychotria ligustrifolia	Bahama Wild Coffee	7 Gal., 3' HT. x 3' SP.
5	Serenoa repens 'cinerea'	Silver Saw Palmetto	15 Gal., 3' Overal Height
2	Tripsacum floridanum	Fakahatchee Grass	3 Gal., 3' HT.
2	Zamia pumila	Coontie	7 Gal., 3' HT. x 3' SP.
	MISC.		
	Zoysia Sod	Square Feet	
	Grey Granite Gravel	Cubic Yards	3/8 in Diameter - 3" Depth
	Filter Fabric	Square Feet	Under Gravel
	Planting Soil Mix 70/30	Cubic Yards	6" Depth

	LANDSCAPE LEGEND		
	INFORMATION REQUIRED TO BE PERMANENTLY AFFIXED TO PLANS		
	Zoning District RM-1 Lot Area 5,650 S.F.	Acres	<u>13</u>
	OPEN SPACE	REQUIRED/ ALLOWED	PROVIDED
A.	Square feet of required Open Space as indicated on site plan:		
	Lot Area =5,650 s.f.x30 % =1,695 s.f.	1,695	2,398
В.	Square feet of parking lot open space required as indicated on site plan:		
	Number of parking spaces4 x 10 s.f. parking space =	40	40
C.	Total square feet of landscaped open space required: A+B=	1,735	2,438
	LAWN AREA CALCULATION		
A.	Square feet of landscaped open space required	1,695	2,438
В.	Maximum lawn area (sod) permitted=30 % x1,695 s.f.	509	252
	TREES		
A.	Number of trees required per lot or net lot acre, less existing number of		
	trees meeting minimum requirements=		
	28 trees x13 net lot acres - number of existing trees=	4	4 PROPOSEI
	% Natives required: Number of trees provided x 30% =	2	4
C.	% Low maintenance / drought and salt tolerant required:		
_	Number of trees provided x 50%=	2	4
D.	Street Trees (maximum average spacing of 20' o.c.)		
_	50 linear feet along street divided by 20'=	3	3
Ŀ.	Street tree species allowed directly beneath power lines:		
	(maximum average spacing of 20' o.c.):		
	NA linear feet along street divided by 20'=	0	0
	<u>SHRUBS</u>		
A.	Number of shrubs required: Sum of lot and street trees required x 12=	0.4	90
	% Native shrubs required: Number of shrubs provided x 50%=	<u>84</u> 42	80 80
	LARGE SHRUBS OR SMALL TREES	L	
A.	1		0.7
D	x 10%= % Native large shrubs or small trees required. Number of large shrubs or	9	37
D.	% Native large shrubs or small trees required: Number of large shrubs or	F	0.7
	small trees provided x 50%=	5	37

PLANTING NOTES & DETAILS
FINAL SUBMITTAL FEBRUARY 08, 2021

A.PEREZ

landscape architecture

ALEX PEREZ

10311 SW 142 COURT MIAMI, FL. 33186 786-586-1616 aperez.rla@gmail.com

CONSULTANT:

1ST FL. RE-BUILT
2ND FL. ADDITIO
7611 ABBOTT AVENUE
MIAMI BEACH, FL 33141

PROJECT ADD

SEAL:

PROJECT NO:

SCALE: 3/16" = 1'-0"

DATE: 12/13/2020

DRAWN: *D.R.C*

CADD FILE:


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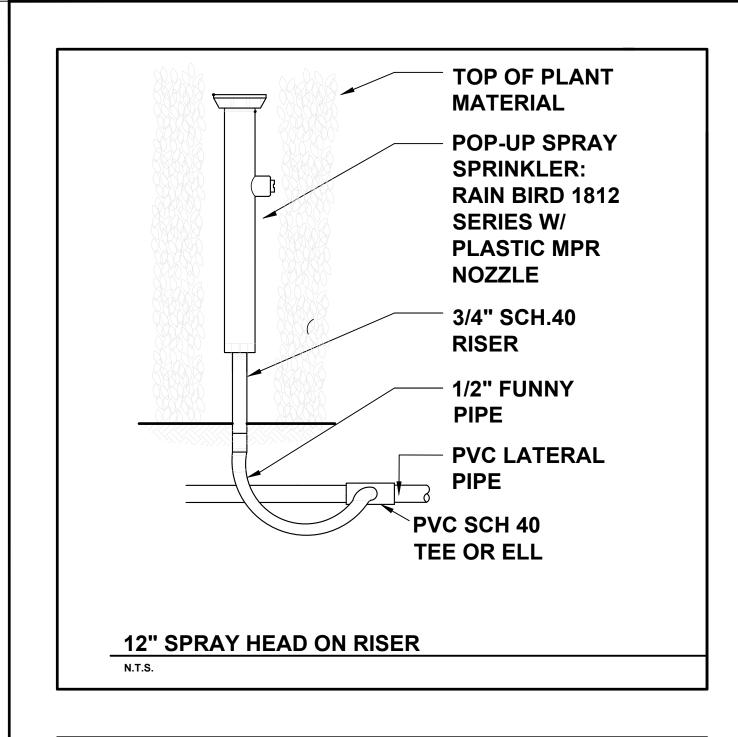
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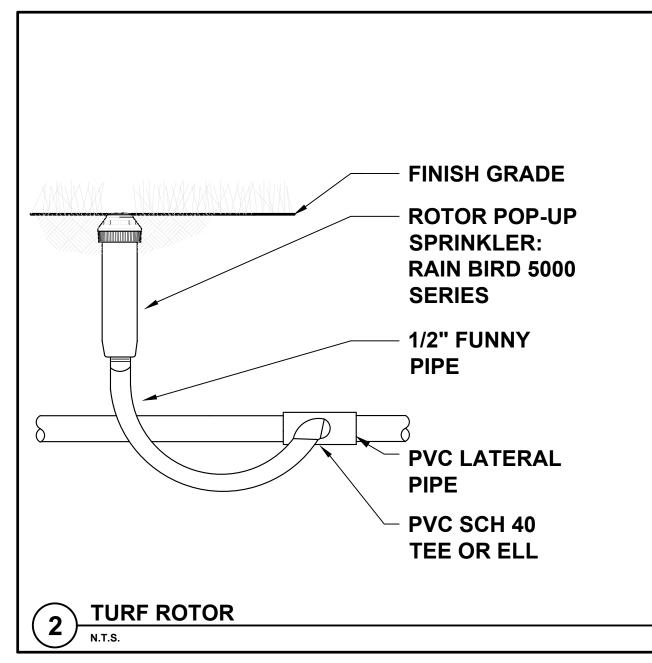
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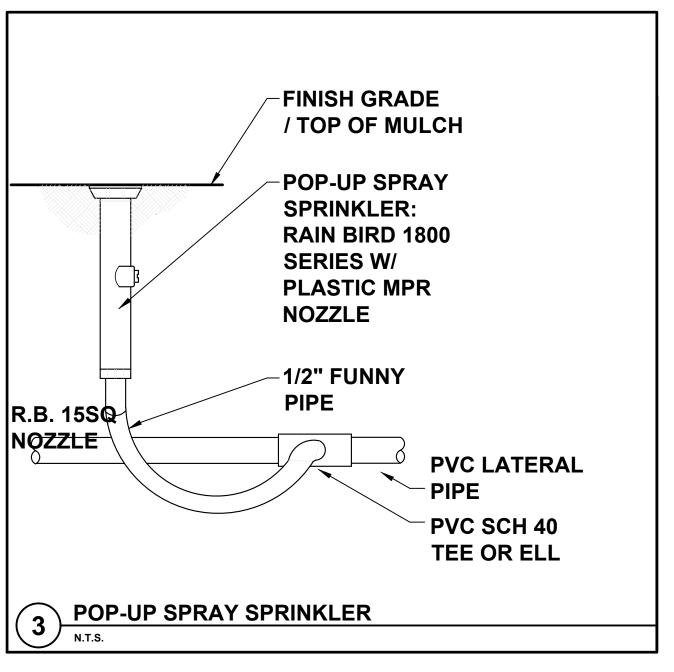
PLANTING NOTES & DETAILS


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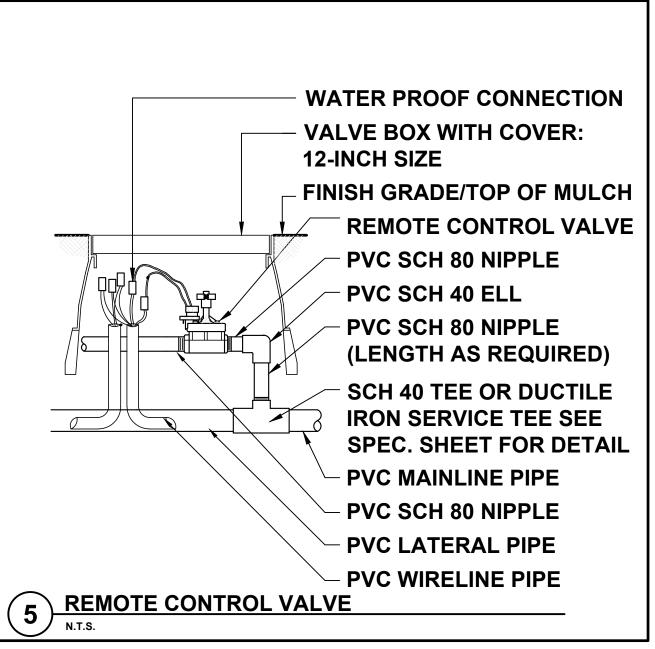











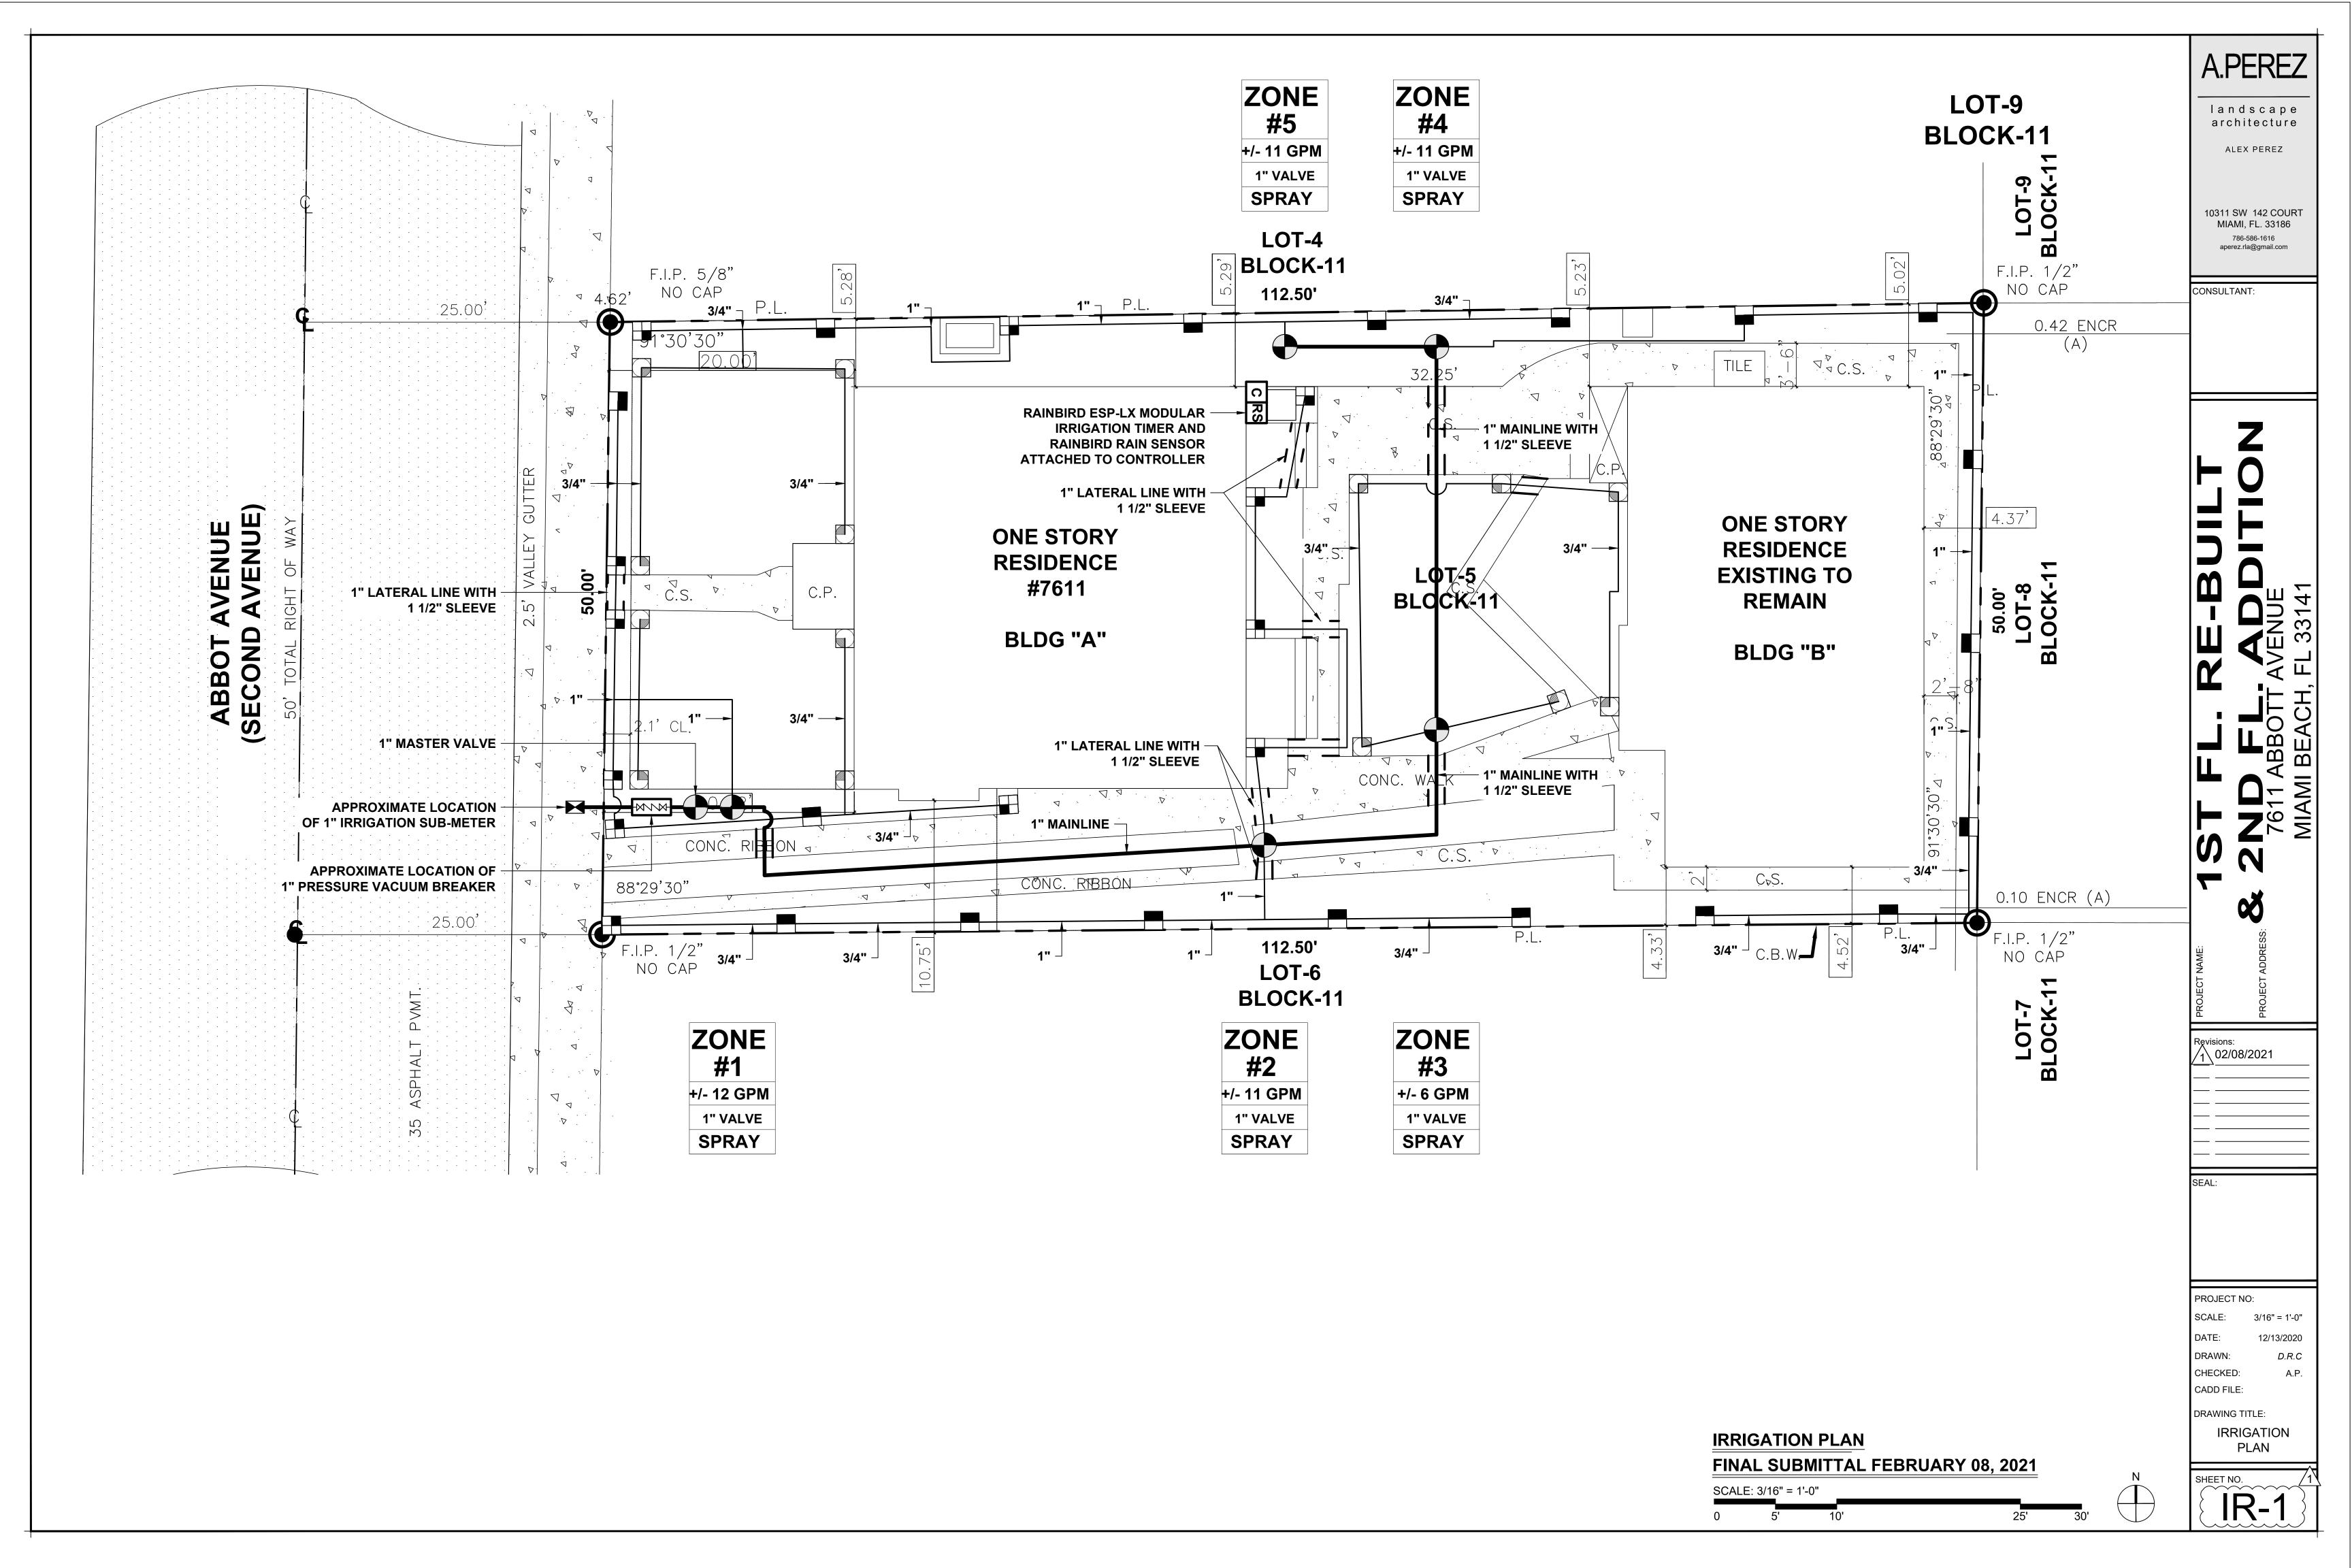

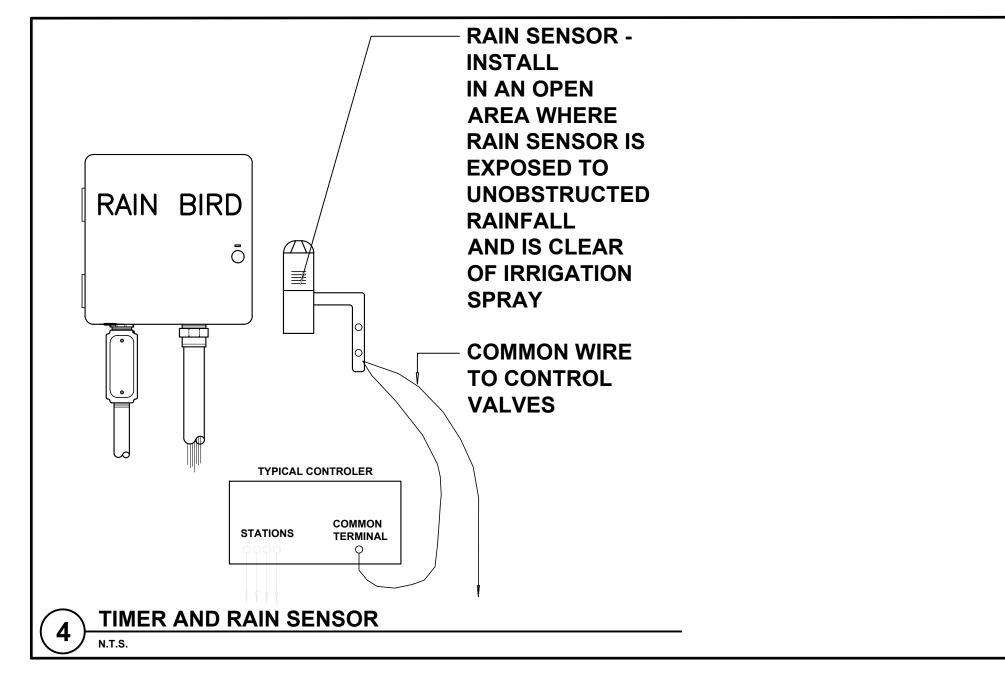

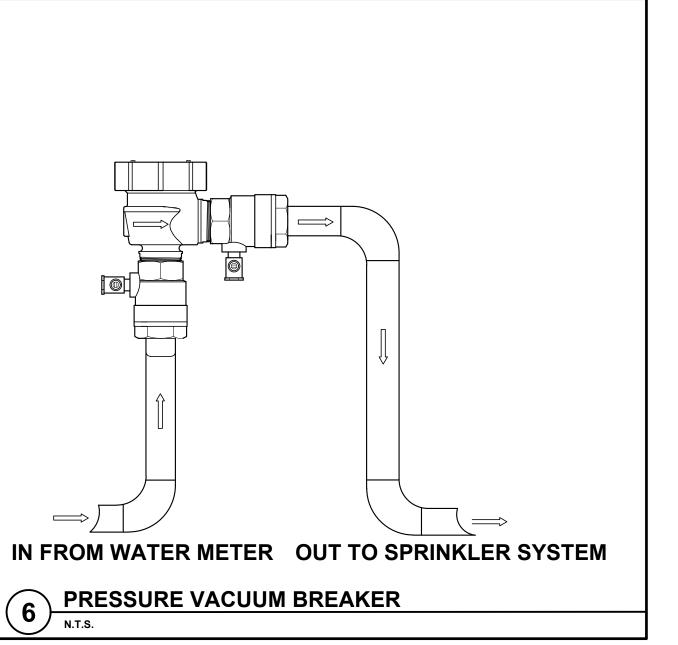

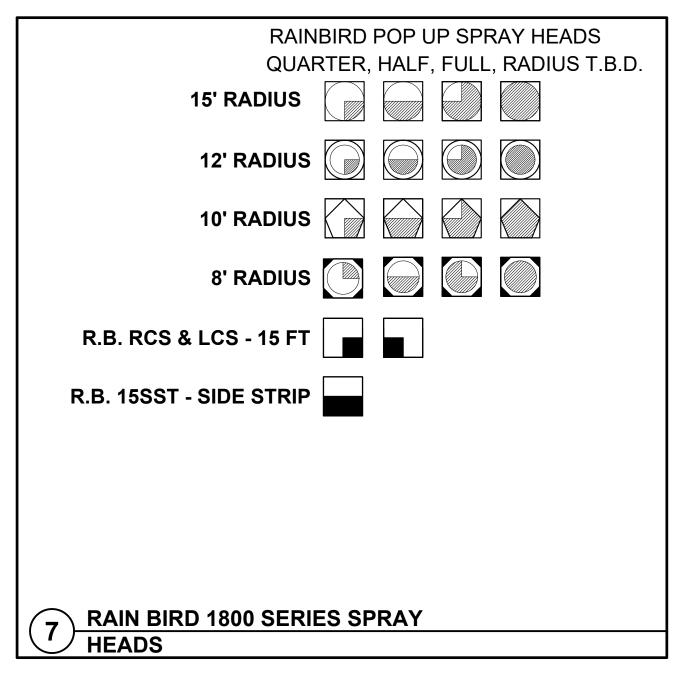

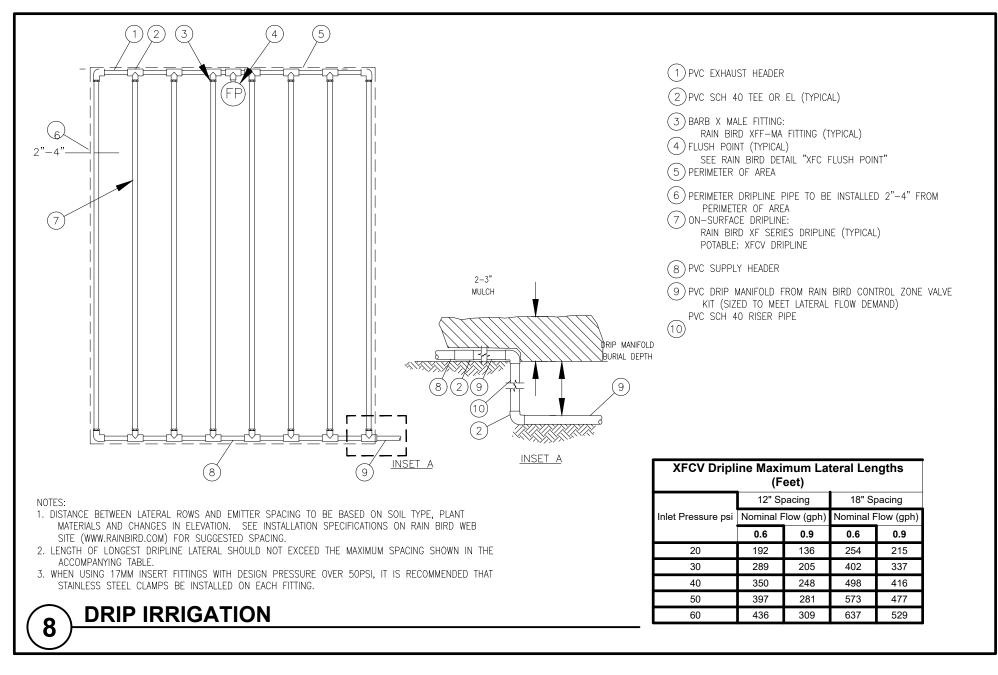


IRRIGATION NOTES

- 1. Pipe sizes shall conform to those shown on the drawings. No substitutions of smaller pipe sizes shall be permitted, but substitutions of larger sizes may be approved. All damaged and rejected pipe shall be removed from the site at the time of said rejection.
- 2. All mainline, lateral line and control wire conduit under paving shall be installed in separate sleeves. Sleeves shall be a minimum of twice (2X) the diameter of the pipe to be sleeved.
- 3. Install all backflow prevention devices and all piping between the point of connection and the backflow preventer as per local codes.
- 4. Final location of the backflow preventer and automatic controller shall be approved by the owner's authorized representative.
- 5. 120 VAC electrical power source at controller location shall be provided by others. The electrical contractor shall make the final connection from the electrical source to the controller.
- 6. All sprinkler heads shall be set perpendicular to finish grade unless otherwise specified.
- 7. The irrigation contractor shall flush and adjust all sprinkler heads and valves for optimum spray with minimal overspray onto walks, streets, walls, etc.
- 8. This design is diagramatic. All piping, valves, etc., shown within paved areas is for design clarification only and shall be installed in planting areas wherever possible. The contractor shall locate all valves in shrub areas where possible.
- 9. It is the responsibility of the irrigation contractor to familiarize himself with all grade differences, location of walls, retaining walls, structures and utilities. The irrigation contractor shall repair or replace all items damaged by his work. He shall coordinate his work with other contractors for the location and installation of pipe sleeves through walls, under roadways and paving, etc.

- 10. Do not willingly install the sprinkler system as shown on the drawings when it is obvious in the field that unknown obstructions, grade differences or differences in the area dimensions exist that might not have been considered in the engineering. such obstructions or differences should be brought to the attention of the owner's authorized representative. In the event this notification is not performed, the irrigation contractor shall assume full responsibility for any revisions
- 11. All sprinkler equipment not otherwise detailed or specified shall be installed as per manufacturer's recommendations and specifications. 12. The irrigation contractor shall install check valves on all heads in areas where finish grade exceeds 4:1, where post valve shut-off draining, of the irrigation head occurs or as directed by the owner's authorized representative.
- 13. The contractor shall provide 1800 PCS (pressure compensating screens) as necessary to reduce or eliminate overspray onto streets, walks or other areas as directed by the owner's authorized representative. 14. All control wires shall be installed in PVC conduit.
- 15. All remote control valves, gate valves, quick couplers, control wire and computer cable pull points shall be installed in approved valves boxes with covers.

IRRIGATION LEGEND

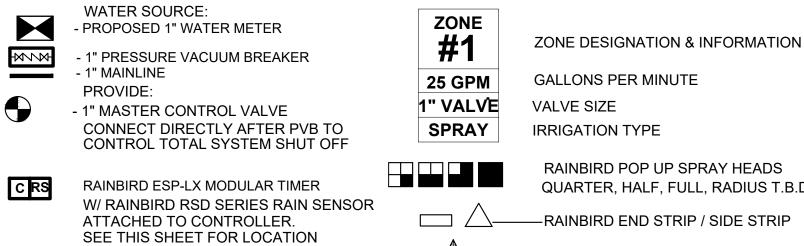

- I MASTER CONTROL VALVE		V/ (E V E G).2E
CONNECT DIRECTLY AFTER PVB TO CONTROL TOTAL SYSTEM SHUT OFF	SPRAY	IRRIGATION TYPE
RAINBIRD ESP-LX MODULAR TIMER W/ RAINBIRD RSD SERIES RAIN SENSOR		RAINBIRD POP UP SPRAY HEADS QUARTER, HALF, FULL, RADIUS T.B.D.
ATTACHED TO CONTROLLER. SEE THIS SHEET FOR LOCATION		—RAINBIRD END STRIP / SIDE STRIP
ELECTRIC VALVES - RAINBIRD PEB SERIES OR APPROVED EQUAL, IN VALVE BOX		RAINBIRD BUBBLER
1" PVC Main Supply Line- Sch 40		ES PECTION IS REQUIRED BY MIAMI DADE PRIOR (FILLING. A FINAL INSPECTION IS REQUIRED P
	TILLINGTI DAGN	I ILLINO. AT INAL INST LCTION IS NEQUINED F

FLORIDA BUILDING CODE- APPENDIX F PIPE INSTALLATION-DEPTH OF COVER		FLORIDA BUILDING CODE- APPENDIX F PART V- A-6		
VEHICLE	TRAFFIC AREAS	WATER PIPE SIZE	SLEEVE SIZE	
PIPE SIZE (INCHES)	DEPTH OF COVER (INCHES)	3/4"	1 1/2"	
1/2" TO 2 1/2"	18" TO 24"	1"	2"	
3" TO 5"	24" TO 30"	1 1/4"	2 1/2"	
6" OR GREATER	30 TO 36"	1 1/2"	3"	
NON-TRAFFIC AI	ND NON-CULTIVATED AREAS	2"	4"	
PIPE SIZE (INCHES)	DEPTH OF COVER (INCHES)	3"	6"	
1/2" TO 1 1/4"	6" TO 12"	4"	8"	
1 1/2" TO 2"	12" TO 18"	SLEEVES TO EXTEND A MIN. 3' BEYOND ALL PAVED AREAS, BACKFILL AND COMPACTION		
2 1/2" TO 3"	18" TO 24"			
4" OR LARGER	24" TO 36"	PER APPENDIX F		

SPECIAL NOTES
A ROUGH INSPECTION IS REQUIRED BY MIAMI DADE PRIOR TO
TRENCH BACKFILLING. A FINAL INSPECTION IS REQUIRED PRIOR
TO COMPLETION OF THE IRRIGATION WORK. SOUTH FLORIDA
WATER MANAGEMENT WATER RESTRICTIONS, 'PHASE II
RESTRICTIONS' ARE IN EFFECT. NEW LANDSCAPE SHALL BE
EXEMPT PER SFWMD FOR A PERIOD OF SIXTY DAYS AFTER
INSTALLATION WITH CONTRACTOR AND/OR OWNER TO
ASSUME RESPONSIBILITY AFTER THAT INITIAL PERIOD.

LANDSCAPE and IRRIGATION NOTE
1. THE PROPOSED LANDSCAPE and IRRIGATION DESIGN MEETS AND EXCEEDS THE
LANDSCAPE CODE REQUIREMENTS AS STIPULATED IN CHAPTER 18-A, MIAMI DADE
COUNTY LANDSCAPE ORDINANCE.

2. EXISTING SITE CONDITIONS HAVE BEEN FIELD VERIFIED BY LANDSCAPE ARCHITECT.

3. ALL LANDSCAPE AREAS TO BE 100% COVERED BY A FULLY AUTOMATIC IRRIGATION SYSTEM WITH RAIN SENSOR. SEE THIS SHEET FOR IRRIGATION LAYOUT.

LANDSCAPED AREA

1" PVC Main Supply Line- Sch 40

LATERAL LINE (Sch. 40)

PIPE CROSSING

IRRIGATION NOTES & DETAILS FINAL SUBMITTAL FEBRUARY 08, 2021 A.PEREZ landscape architecture

ALEX PEREZ

10311 SW 142 COURT

MIAMI, FL. 33186

786-586-1616

aperez.rla@gmail.com

CONSULTANT:

02/08/2021

PROJECT NO: SCALE: 3/16" = 1'-0" DATE: 12/13/2020 D.R.C DRAWN: A.P. CHECKED:

DRAWING TITLE: **IRRIGATION** NOTES & DETAILS

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SHEET NO.