

6342/6360 NBR

MIAMI BEACH, FL

SITE ADDRESS:

6342 AND 6360 NORTH BAY ROAD MIAMI BEACH, FL 33141

TEAM:

LANDSCAPE ARCHITECT:

ARCHITECT:

CFZ DESIGN (239) 898-7549

SEAL;

Carolina Digitally signed by Carolina Monteiro Date: 2020.12.07 10.53:46 -05'00' CARO, LIC MAH. F. 3333 Carolina Monteiro Date: 2020.12.07 11.00 its each Street, MAH. F. 3333 Carolina Monteiro do Silva Licola (March 273)

DRAWING TITLE:

FRONT LANDSCAPE **ELEVATION** 

| ISSUE: DATE: | PRE-DRB SUBMITTAL | 11/16/20 | | FINAL DRB SUBMITTAL | 12/07/20 |

SCALE: AS SHOWN PROJ NO: 2026

SHEET NO: L.300



SEE 1/L.301

MATCH LINE,

2

+5.90' NGVD

PROPOSED BASKETBALL COURT W/

SIDE FENCE & SLIDING GATE

+5.90'

DRIVEWAY

**EXTENSION** 

NGVD

6342/6360 NBR MIAMI BEACH, FL SITE ADDRESS: 6342 AND 6360 NORTH BAY ROAD MIAMI BEACH, FL 33141 TEAM: LANDSCAPE ARCHITECT: ARCHITECT: CFZ DESIGN (239) 898-7549 Carolina Digitally signed by Carolina Monteiro Date: 2020.12.07 10:54:14-05'00' DRAWING TITLE: LANDSCAPE SITE SECTION ISSUE: DATE:
PRE-DRB SUBMITTAL 11/16/20
FINAL DRB SUBMITTAL 12/07/20

SCALE: AS SHOWN PROJ NO: 2026


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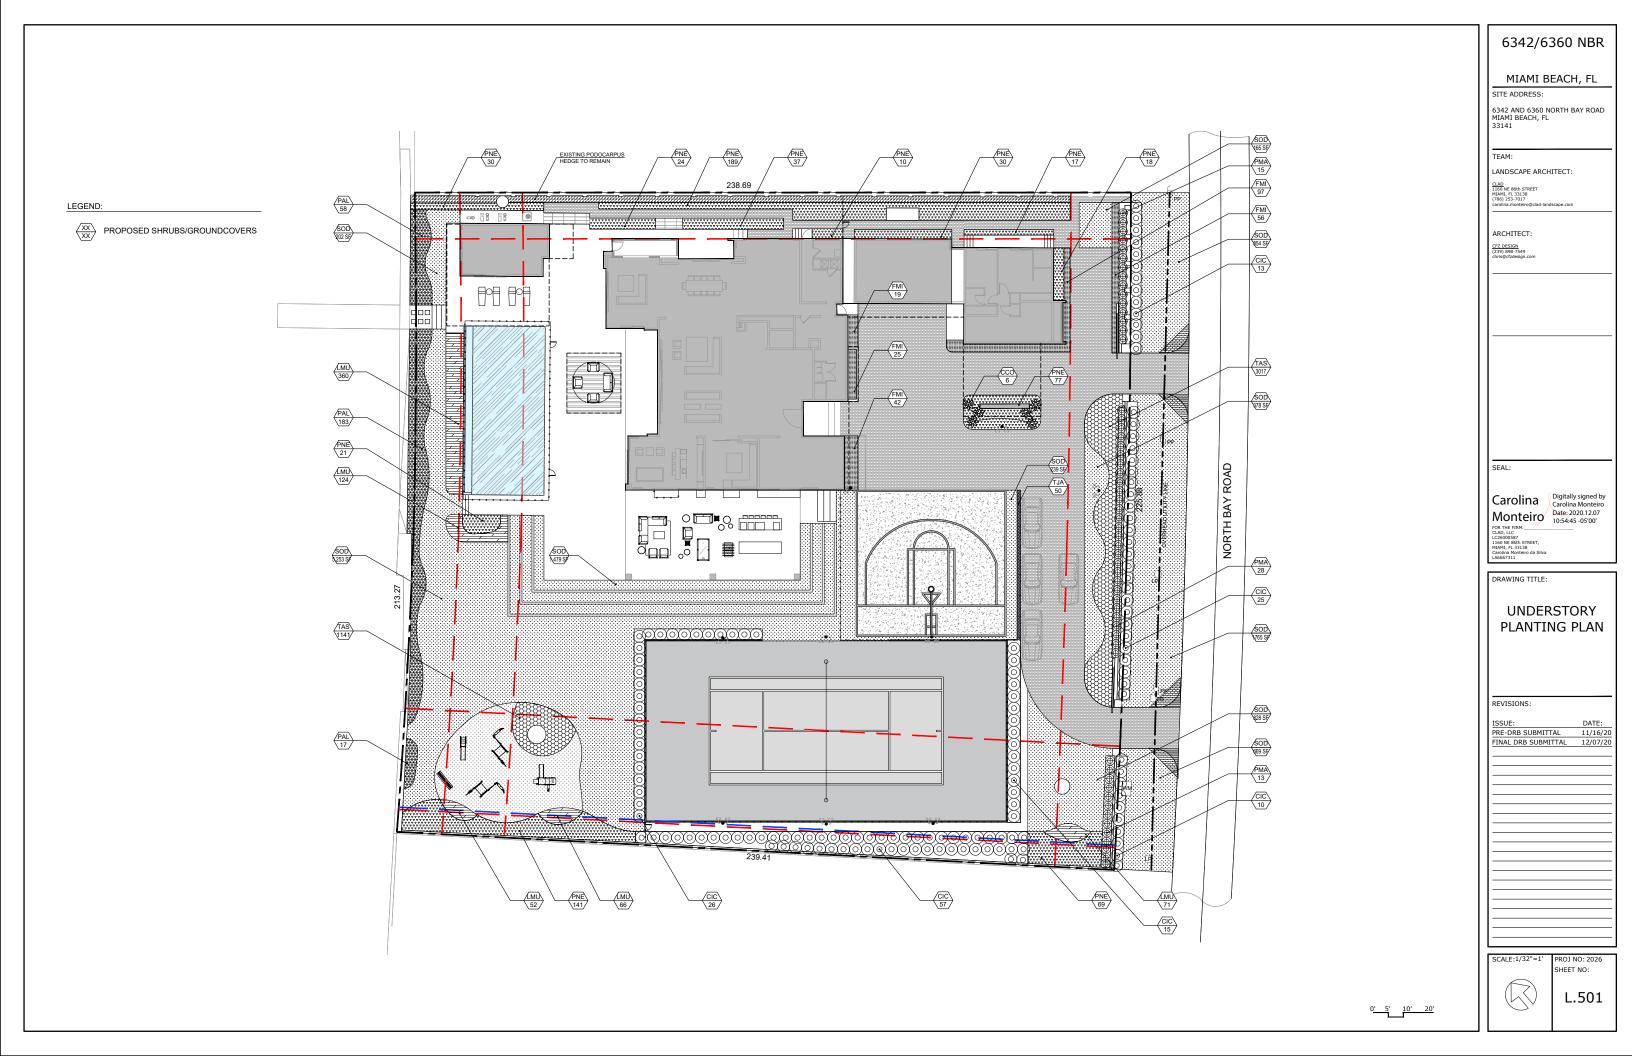
L.301

ADJUSTED GRADE +5.85' NGVD

+3.73' NGVD GRADE
(CROWN OF ROAD)

PLANTING AREA & N. BAY
PROPERTY WALL ROAD



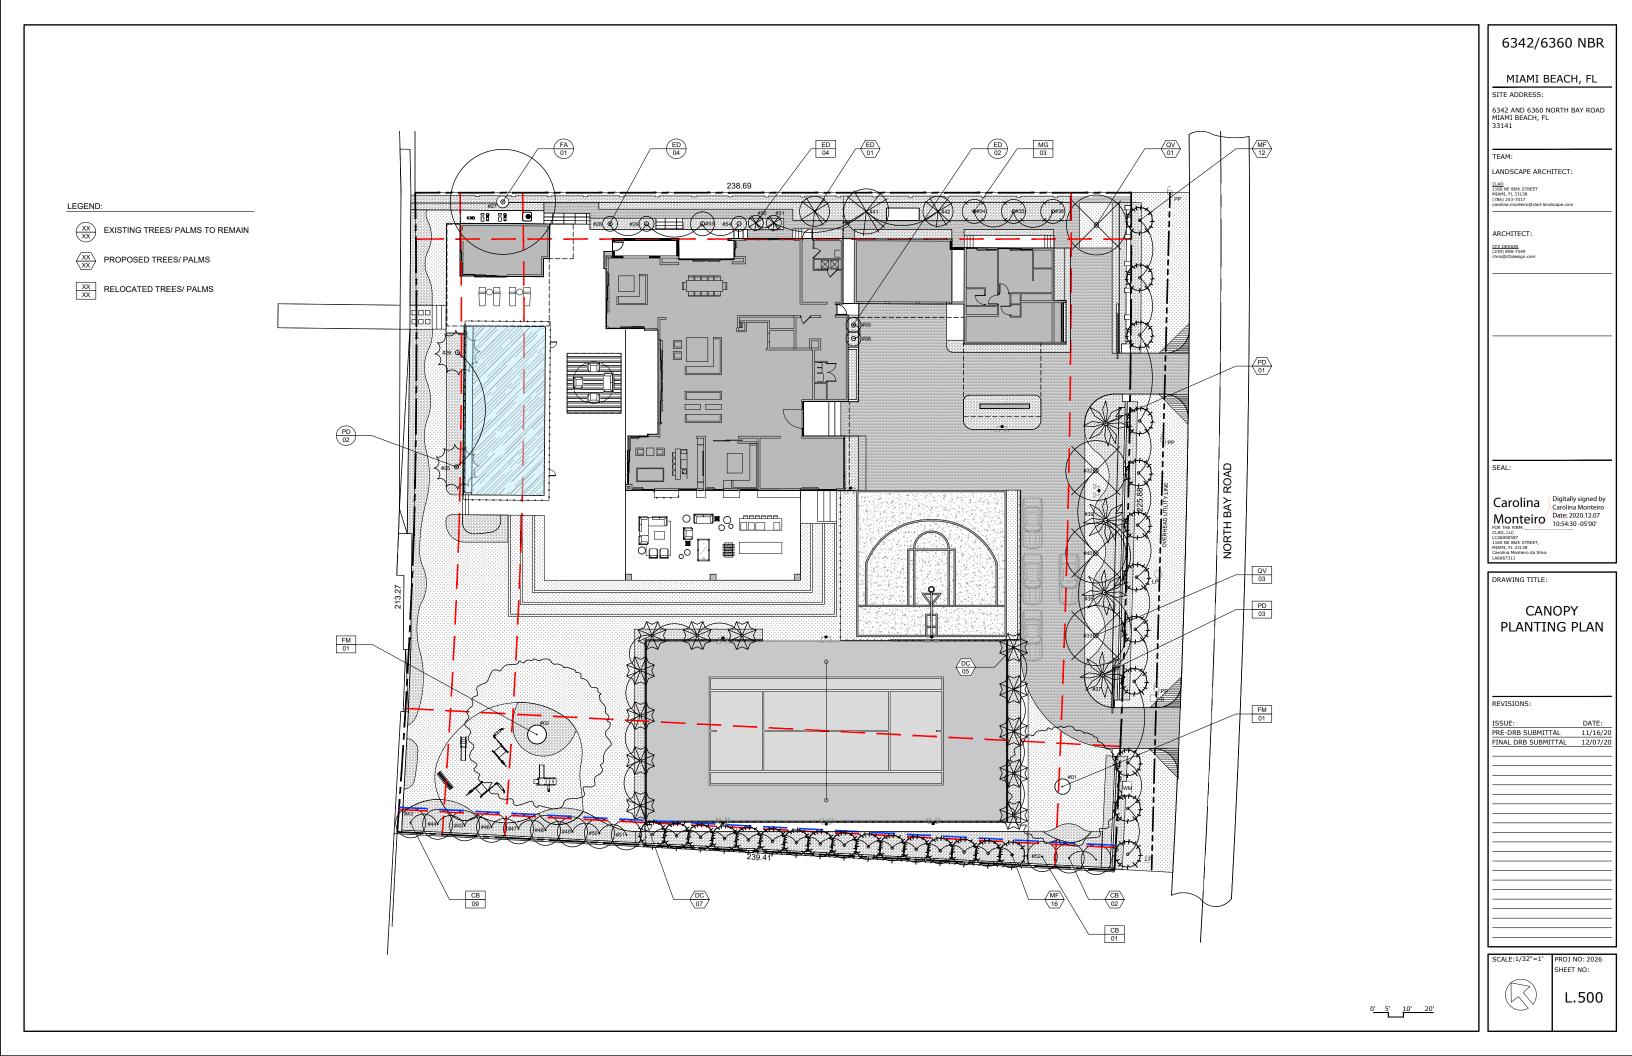

LANDSCAPE SCHEDULE - CANOPY SITE						
SYMBOL	QTY	PROPOSED MATERIAL	DESCRIPTION AND NOTES	NATIVE		
STREET TREES						
MF	12	Myrcianthes fragrans	16' HT (MIN), 8' SP, 4" CALIPER, BUSH	Υ Υ		
		SIMPSON'S STOPPER TREE	FG, MIN 4' CLEAR TRUNK			
<u>TREES</u>						
СВ	2	Calophyllum brasiliense	20' HT, 10' SP	N		
		BRAZILIAN BEAUTY LEAF	FG			
MF	16	Myrcianthes fragrans	16' HT (MIN), 8' SP, 4" CALIPER, BUSH	Y		
		SIMPSON'S STOPPER TREE	FG, MIN 4' CLEAR TRUNK			
QV	1	Quercus virginiana	20' HT, 16' SP	Y		
		LIVE OAK	FG			
ED	1	Elaeocarpus decipiens	18' HT, 10' SP	N		
		JAPANESE BLUEBERRY	FG			
		PALM	<u>ns</u>			
DC	16	Dypsis cabadae	18' OA, 12' SP, MULTI-TRUNK	N		
		CABADA PALM	FG			
PD	1	Phoenix dactylifera	30' QA	N		
		DATE PALM	FG	<u> </u>		

		LANDSCAPE SCHEDULI LARGE S		
	1			1
CIC	146	Chrysobalanus icaco 'Green Tip'	6' HT, 4' SP. 48" O.C, FULL	_ Y
		GREEN TIP COCOPLUM	25G	
		SHRU		1
PMA	56	Podocarpus macropyllus	8' HT, 3' SP, 36" O.C, FULL	N
		PODOCARPUS	25G	
PAL	258	Pennisetum alopecuroides	30" HT, 30" \$P, 24" O.C, FULL	N
		FOUNTAIN GRASS	3G	
PNE	663	Psychotria nervosa 'Little Psycho'	24" HT, 24" O.C	Y
		DWARF WILD COFFEE	7G	
FMI	239	Ficus microcarpa 'Green Island'	24" HT, 18" O.C	N
		GREEN ISLAND FICUS	7G	
		ACCE	NTS	•
ссо	6	Cyathea cooperi	4' HT, 4' SP	N
		AUSTRALIAN TREE FERN	15G	
	•	GROUNDO	COVERS	
TAS	4158	Trachelospermum asiaticum	6" HT, 6" O.C	N
		Asiatic Jasmine	1G	
LMU	673	Linope muscari 'Super Blue'	12" HT , 12" O.C	N
LIVIŲ		LIRIOPE	1G	
		VINE	<u>ES</u>	
TJA	50	Trachelospermum jasminoides	3' TRELLIS, 12" O.C, TRAIN TO FENCE	N
		CONFEDERATE JASMINE	3G	
	•	SO	<u>D</u>	
SOD	11,773 SF	Zoysia ssp.	STAGGERED AND BUTTED JOINTS	N
		GEO ZOYSIA		

#### CITY OF MIAMI BEACH LANDSCAPE LEGEND

	LANDSCAPE LEGEND		
	INFORMATION REQUIRED TO BE PERMANENTLY AFFIXED TO PLANS		
	Zoning District RS-3 Lot Area 52,316 SF Acres	1.20	
٨	OPEN SPACE	REQUIRED/ ALLOWED	PROVIDED
Α.	Square feet of required Open Space as indicated on site plan:  Lot Area =52,316 s.f.x50 % = _26,091 s.f.	26,158	40,805
В.	Square feet of parking lot open space required as indicated on site		10,003
	Number of parking spaces N/A x 10 s.f. parking space =	N/A	N/A
C.	Total square feet of landscaped open space required: A+B=		
Α.	LAWN AREA CALCULATION Square feet of landscaped open space required		
В.	Maximum lawn area (sod) permitted= 50 % x 26,091 s.f.	13,046	8,544
	TREES		
Α.	Number of trees required per lot or net lot acre, less existing number		
	of trees meeting minimum requirements=  52 trees x - (26) number of existing trees=	26	20*
В.	% Natives required: Number of trees provided x 30% =	6	17
	% Low maintenance / drought and salt tolerant required:		
_	Number of trees provided x 50%=	10	17
D.	Street Trees (maximum average spacing of 20' o.c.)  226' linear feet along street divided by 20'=	NI /A	NI / A
E.	Street tree species allowed directly beneath power lines:	N/A	N/A
	(maximum average spacing of 20' o.c.):		
	linear feet along street divided by 20'= 11.3 rounded	t <sub>'</sub> 12	12
	<u>SHRUBS</u>		
Α.	Number of shrubs required: Sum of lot and street trees required x 12=	768	1,216
В.	% Native shrubs required: Number of shrubs provided x 50%=	608	663
	LARGE CURING OR CAMALL TREES		
Α.	LARGE SHRUBS OR SMALL TREES  Number of large shrubs or small trees required: Number of required		
Λ.	shrubs x 10%=	77	146
В.	% Native large shrubs or small trees required: Number of large shrubs		
	or small trees provided x 50%=	73	146

\*LANDSCAPE PLANS HAVE A DEFICIT OF 6 REQUIRED LOT TREES. A CONTRIBUTION OF \$12,000 WILL BE GIVEN TO THE TREE TRUST FUND TO COMPENSATE FOR THE MISSING TREES.

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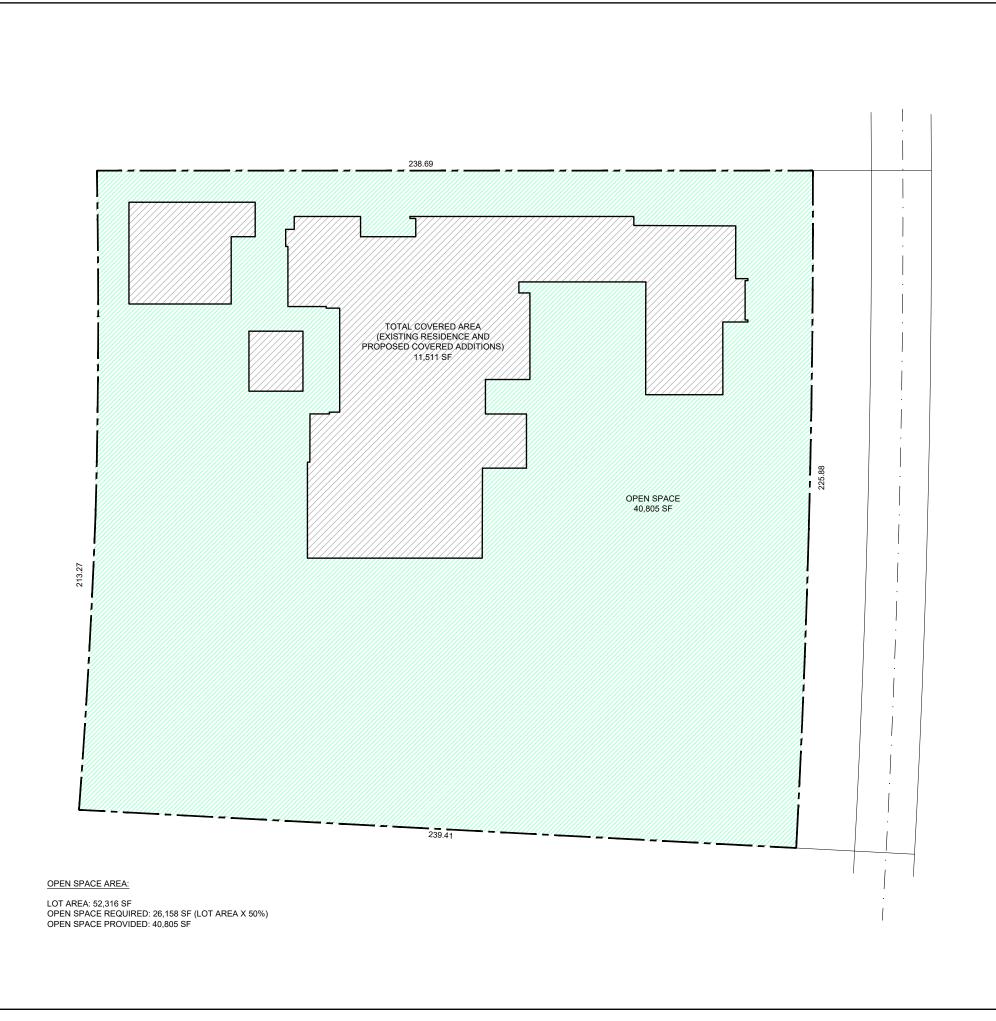
PLANTING
SCHEDULE AND
LANDSCAPE
LEGEND

REVISIONS:
ISSUE: DATE:
PRE-DRB SUBMITTAL 11/16/20
FINAL DRB SUBMITTAL 12/07/20

DRAWING TITLE:

PROJ NO: 2026
SHEET NO:

L.502



6342/6360 NBR

MIAMI BEACH, FL

SITE ADDRESS:

6342 AND 6360 NORTH BAY ROAD MIAMI BEACH, FL 33141

TEAM:

LANDSCAPE ARCHITECT:

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DRAWING TITLE:

REQUIRED OPEN SPACE DIAGRAM

REVISIONS:

 ISSUE:
 DATE:


 PRE-DRB SUBMITTAL
 11/16/20

 FINAL DRB SUBMITTAL
 12/07/20

0' 5' 10' 20'

PROJ NO: 2026 SHEET NO:

L.503

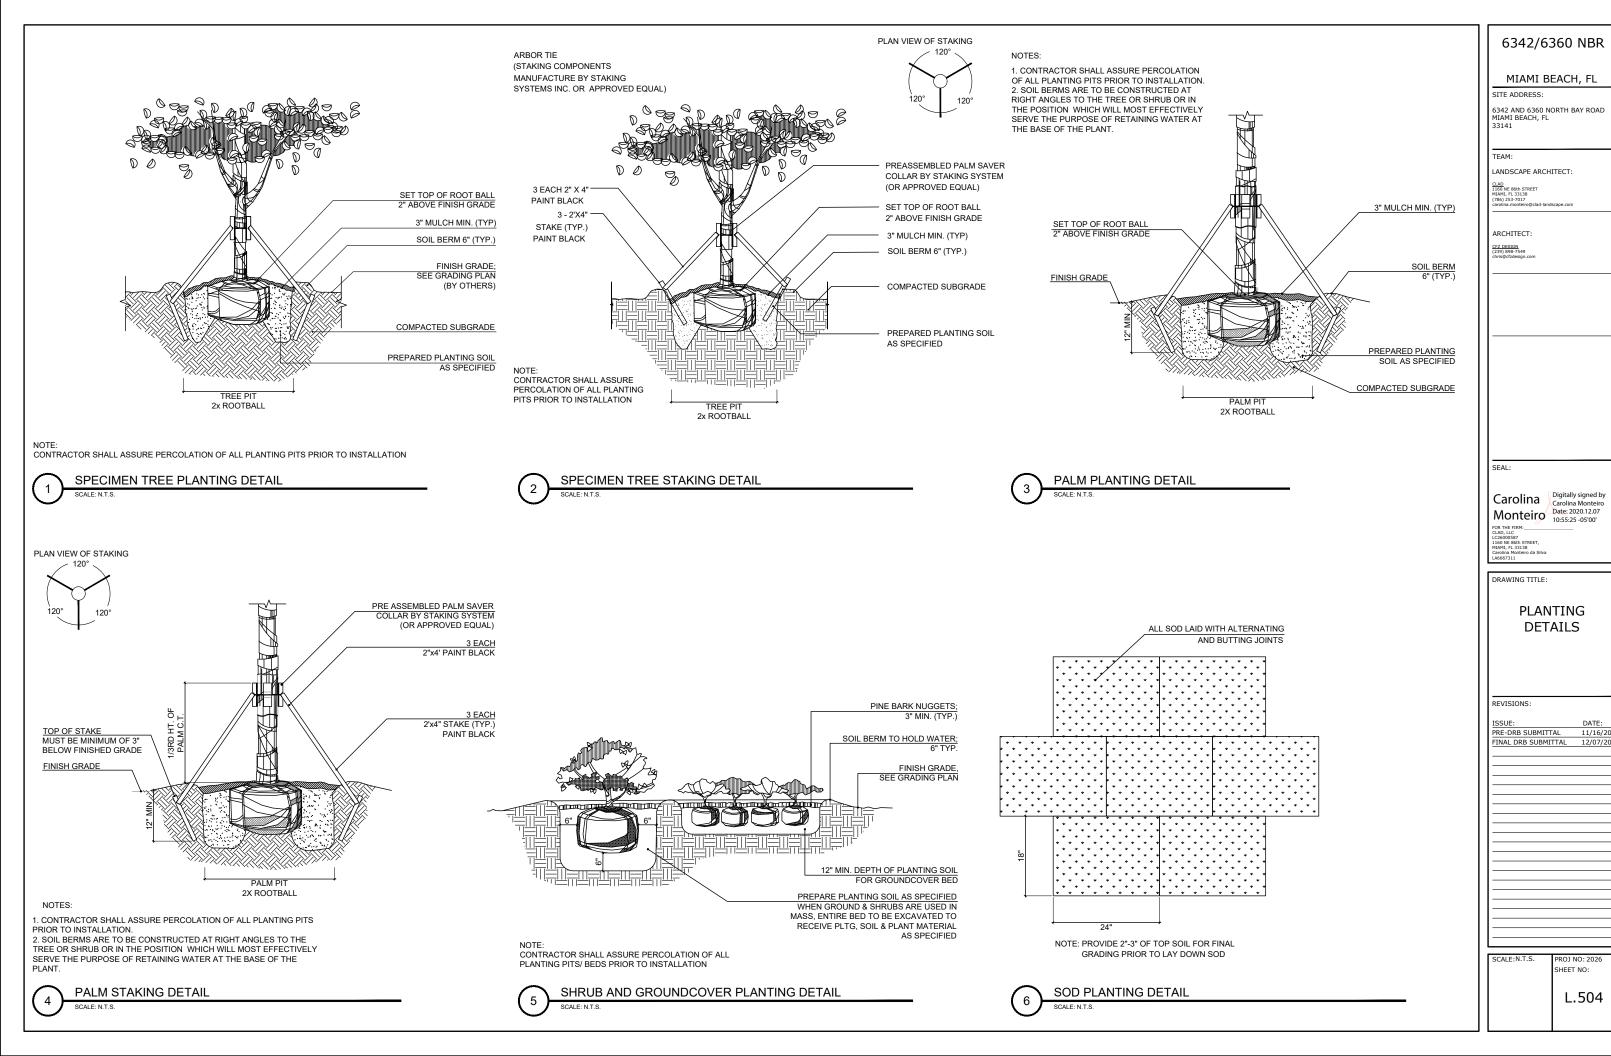

### overall plant selection

Existing Trees



### overall plant selection

Trees & Palms

Existing Southern Magnolia (Magnolia grandiflora) Simpson's Stopper Tree (Myrcianthes fragrans) Date Palm Cabada Palm (Phoenix dactylifera) (Dypsis cabadae)

# overall plant selection

Shrubs



# overall plant selection

Accents, Groundcovers & Vines

