# 4880 Pine Tree Drive Illustrated Responses for DRB Continuance



MTTR MGMT 291 NE 61st St Miami FL 33137

This booklet represents the adjustments and changes in project design as a response to the issues that were of concern to the CMB DRB board members and neighbors during the February Design Review Board meeting. It is of utmost importance to us that the issues are addressed in a responsible manner and in coordination with Staff and under the allowances of the City Ordinance. This booklet is supplementary to the main submittal.


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- 2. Opening Up the Understory.
- 3. Treatment of North and South Property Lines and Setbacks.
- 4. Improving Privacy.
- 5. Building Shadow Management.
- 6. Centralization of Elevator.
- 7. Height Waiver Reductions.
- 8. Landscape Enhancement I & II.

# Improving Street Presence I

#### Improving Street Presence Part 1: Making the Street Setback Larger

We added an extra 5' to the front (Setback), to a total of 25' from property line, bringing it closer to the two-story set-back. Whereas 20' is allowable by the massing-setback of a one-story structure. The Two-Story portion of the structure is currently set back at 61'-8" from street, double the minimum.

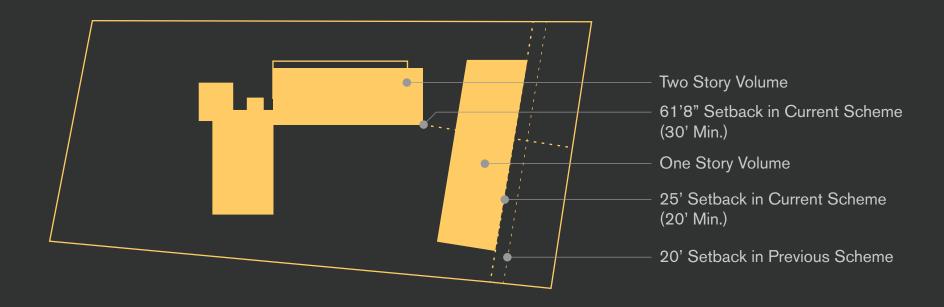


# Improving Street Presence II

#### Improving Street Presence Part 2: Adding Meaningful Trees to the Front Yard

In this developed version we included specimen-size trees to the front setback to increase presence of meaningful plant life for the streetscape. The trees are two 18' native White Geiger trees. a 20' specimen Hong Kong Orchid, two 10' Frangipani Trees and a 20' native specimen Strangler Fig – in addition to two 25' Queen Palms and a Pigmy Date Palm. The total amount of trees/plants in the street setback is 42.




# Improving Street Presence II

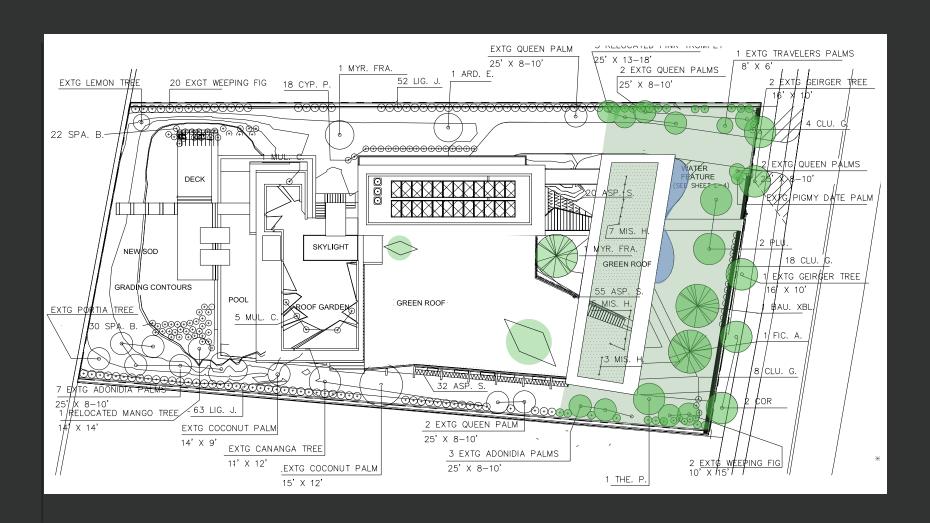

# Improving Street Presence III

#### Improving Street Presence Part 3: Mid-Century Inspired Louver Redesign


We provided a significant development for the street-facing louver system to improve the building's character. It is now made of a warmer color/material and its pattern is dynamic and mid-century inspired. It is also kinetic in the louver/fins angle to provide a variation in openness, which also translates into a variation of pattern – from straight down (wide open) to curvilinear wave pattern (when closed).

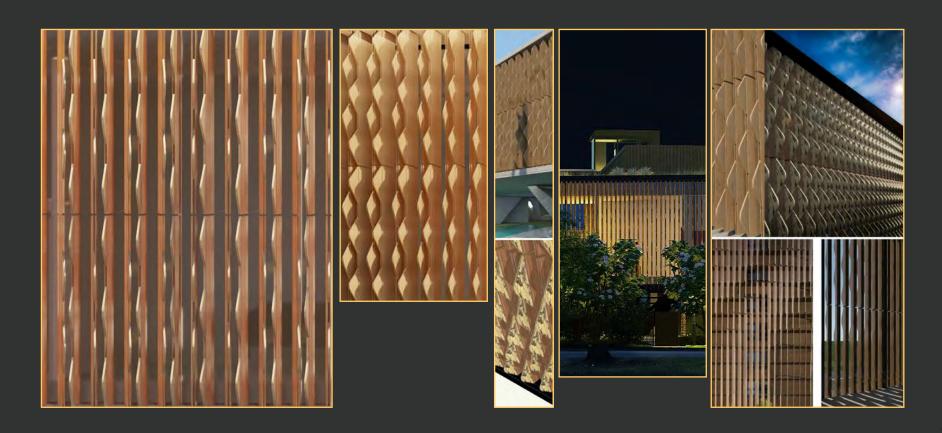

# Opening Up the Understory

#### **Understory Redesign**

We have redesigned the understory to address the 'open it up by 30% and make it lighter'. As a result we have a much lighter, natural light-filled understory that is more open, including enhanced understory landscaping and a more varied palette of natural materials. The supports are farther between and we added a perforation to the roof in addition to the previous one – now with larger open areas. This supports the intent of the code for the understory, and we believe it is now a good example of a flood-resistant space. The spaces we enclosed are true vertical circulation elements as prescribed, the remaining areas being strictly about support.

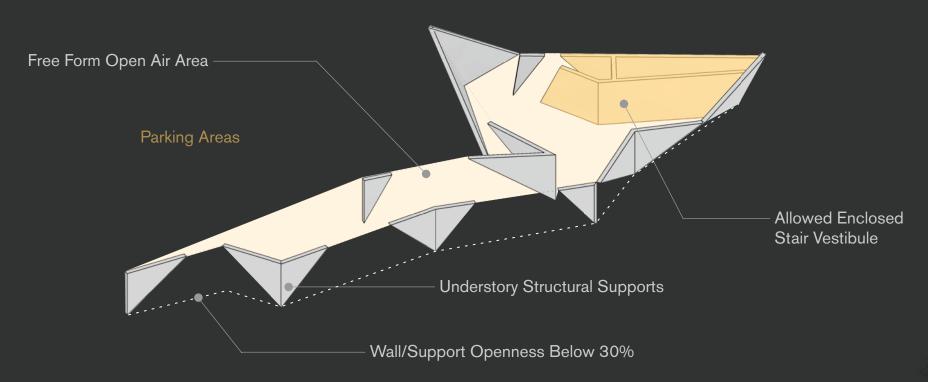


# Opening Up the Understory




# Opening Up the Understory



# Opening Up the Understory: Plan

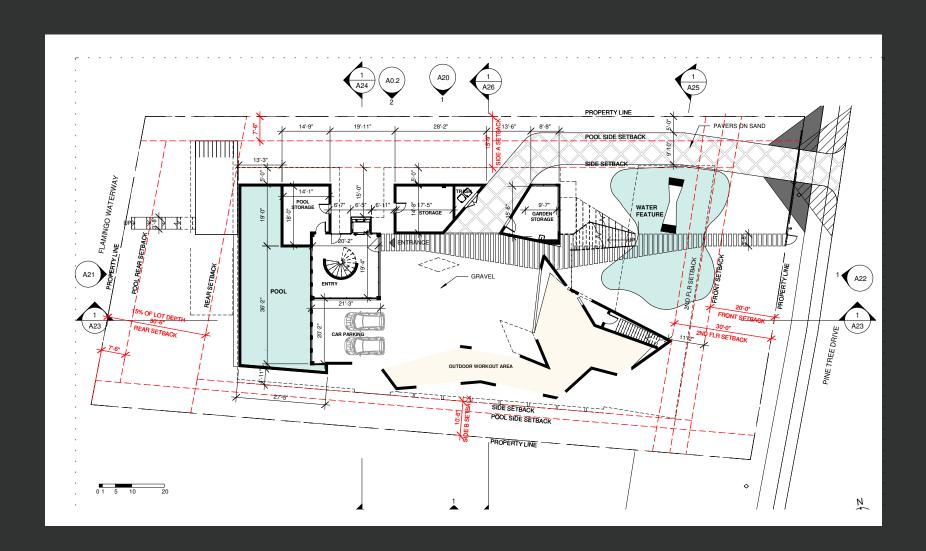

# Opening Up the Understory: Landscape Plan

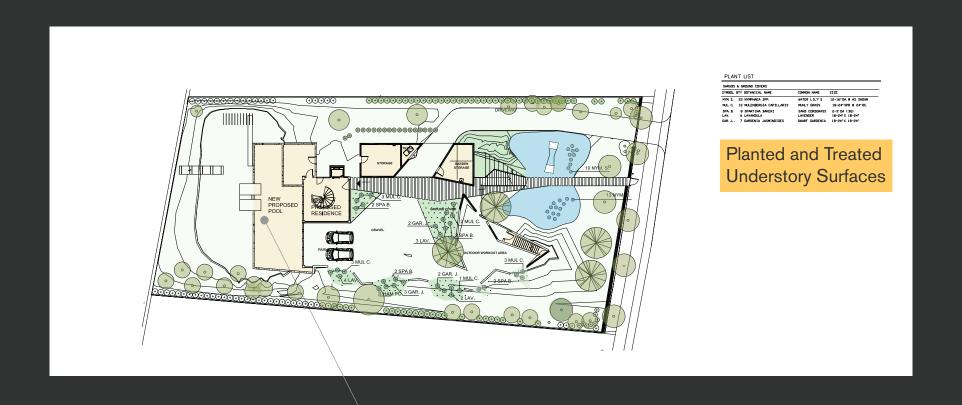


Allowed Enclosed Vestibule, Allowed Mech/Storage or Below Pool

## Treatment of North and South Property Lines and Setbacks

# Mitigating Effects on North and South Properties: Maximizing the Setback to the North and Buffering to the South

In response to the Staff's suggestion that we switch the maximization between N and S setbacks (the South facing side of the project having the lowest building mass) we responded by doing just that. We pushed the building to the South, making the setback with the North property effectively 15'-9" (previously 10'-6"). This, in combination with lowering 2' the height of the north-south building bar (2' from max available height through waiver – discussed below) and increased planting quantity and height (discussed in landscape section below), should minimize the shade and volume impact to the North. While this move has entailed relocating the driveway to the North, the intent was to mirror the North neighbor's driveway for a limited length to the advantage of the street scape so there is more uninterrupted green frontage which is consolidated with the South Property Line. The South property line has been enhanced by added planting buffers, which blend well with the smaller facing portion of the natural wood facades ~ and no vehicular movement.

# Treatment of North and South Property Lines and Setbacks

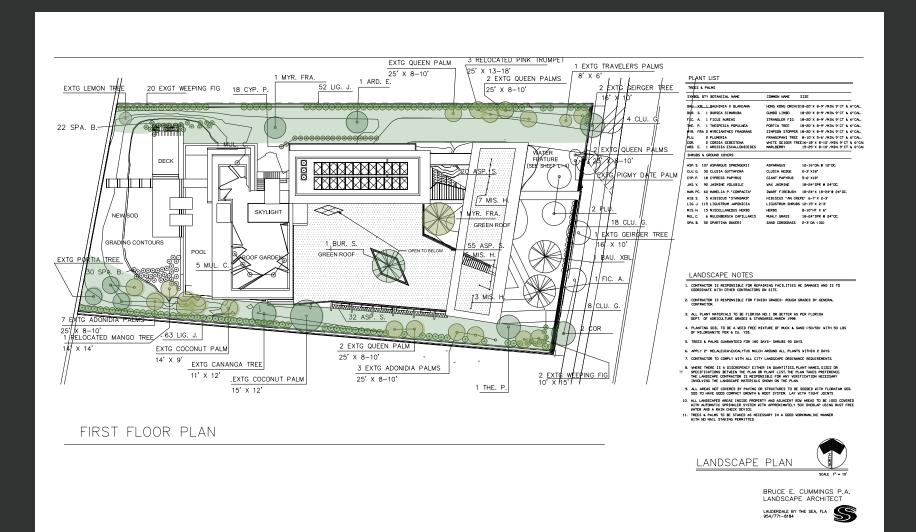


# Improving Privacy

#### Privacy in North Elevation by Using Translucent Glass

In addition to the before mentioned increased landscape screening – in quantity and in size, we have also used translucent glass to provide



visual privacy in select areas: bathrooms and balconies. Translucent glass is highly diffusive and prevents visual recognition while allowing light to go through. It also decreases reflectivity. The increase of setback distance, reduced massing height, landscaping and material treatment are intended to provide screening and privacy at the viewing angles shown from adjacent property, in addition to the screening provided by trees. The rooms are 20'-9" from property line.

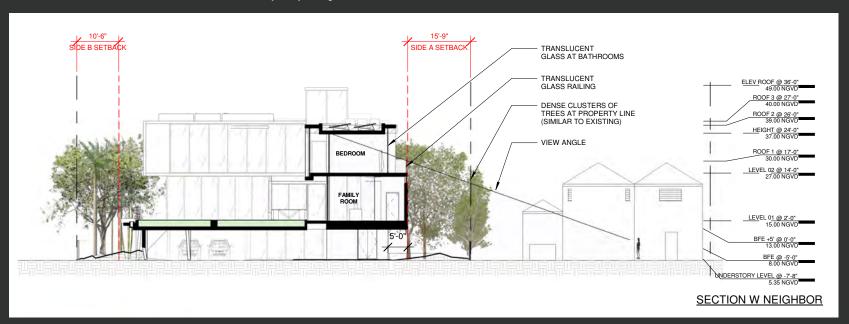

# **Building Shadow Management**

#### **Building Shadow on Neighbor During the Year**

We are improving the performance of shadow coverage to the North (sun leans to the South in Northern Hemisphere) in this scheme by doing the following: reducing building height, placing building farther away by increasing setback and providing better layered landscape coverage and size. The shadow studies indicate that the building doesn't cast shadows on neighboring pool most of the year (75%), from February 3rd to November 6th, after that the shadows ranging from minor to partial. On the most prohibitive day of the year (December 21st) the shadow on neighboring property is partial and significantly reduced from previous scheme, as shown in Sun Studies.

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# **Building Shadow Management**



**December 21st** 



February 3rd



March 21st




June 21st

### Further Centralization of Elevator

#### **Relocation of Elevator Farther South**

The increase of the North setback has also resulted in the elevator being more central to the site than in the previous scheme. The Elevator is 30'-9" from the property line. This is one of the Waiver requests of the application.

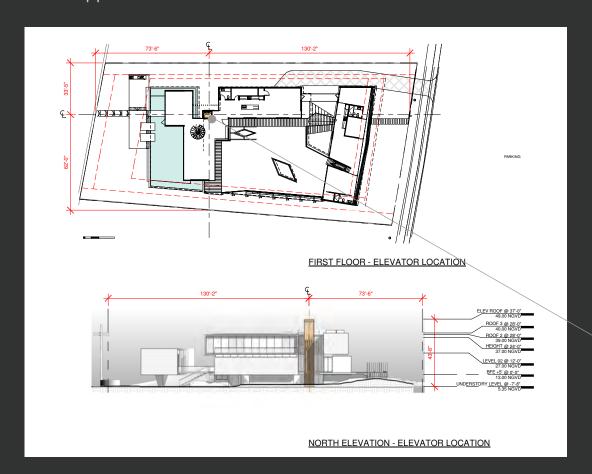


Elevator has moved 5' +/-Centrally to Site

# Height Waiver Reductions

#### Height Reduction in Building Massing to the North and to the West


This scheme requires reduced height waivers than previously requested. On the North side of building we are requesting only a 2' increase (previously a 4' increase) and on the water side massing (West) we are requesting 3' (previously 4').

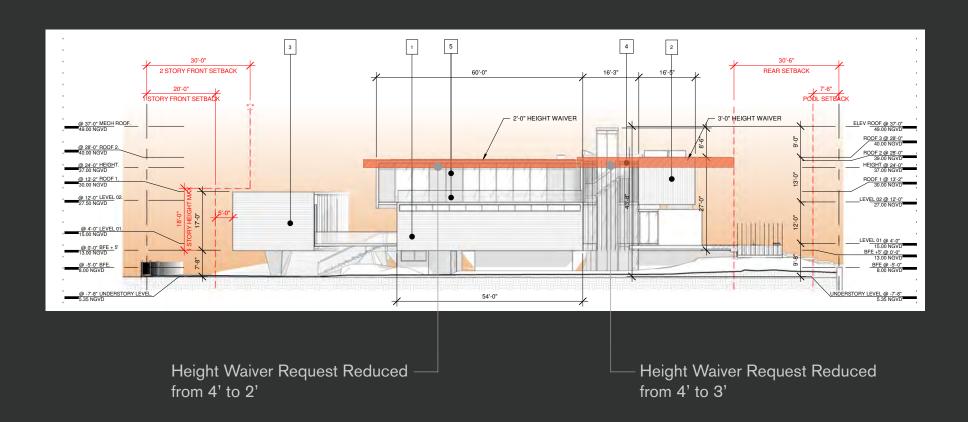

## Landscape Enhancement I

#### Improved Mitigation of Existing Trees and Addition of New Trees and Plants

We are keeping more of the original trees and relocating more trees than in the previous scheme. In the previous submittal we were adding 5, now we are adding 11 trees. We were keeping 21 trees before, now we are keeping 51. Previously we were relocating 1 tree, now we are relocating 4. We reduced the amount of trees we are removing by 34. In addition to the beneficial location of to the new trees, we are planting an elevated extensive roof-yard over understory to reduce heat island effect and maximize green coverage, as well as an extensive planted roof for one of the living volumes.

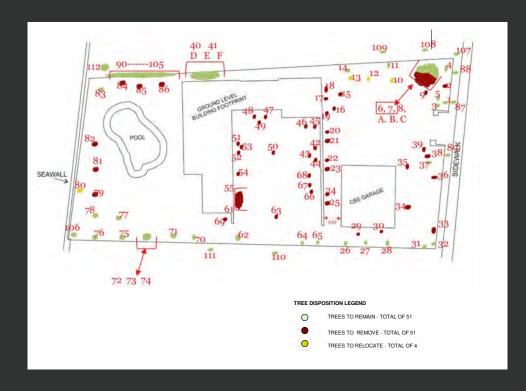


Our Tree Mitigation
has Improved Substantially
in this Current Scheme

## Landscape Enhancement II

#### Increased Screening on North and South Sides, Specimens on Street

We have increased screening on north (by 72 tree/plants plus existing 28) and south (by 64 plants plus existing 19) sides and raised the height of new planting. On the North side we have 100 trees/plants that range between 8' and 25' including a new 20' tall native and specimen Simpson Stopper and on the South we have 83 trees/plants that range between 10' and 25' including a 20' Portia Tree and a 14' Mango Tree. On the street side we have four new signature trees – in addition to the new and existing (total 42 trees/plants), and placed some new meaningful natives and specimens to improve the street scape. They include a 20' native specimen Strangler Fig, 2 native 15' White Geiger trees, a specimen 20' Hong Kong Orchid and two Frangipani trees.

# Landscape Enhancement II

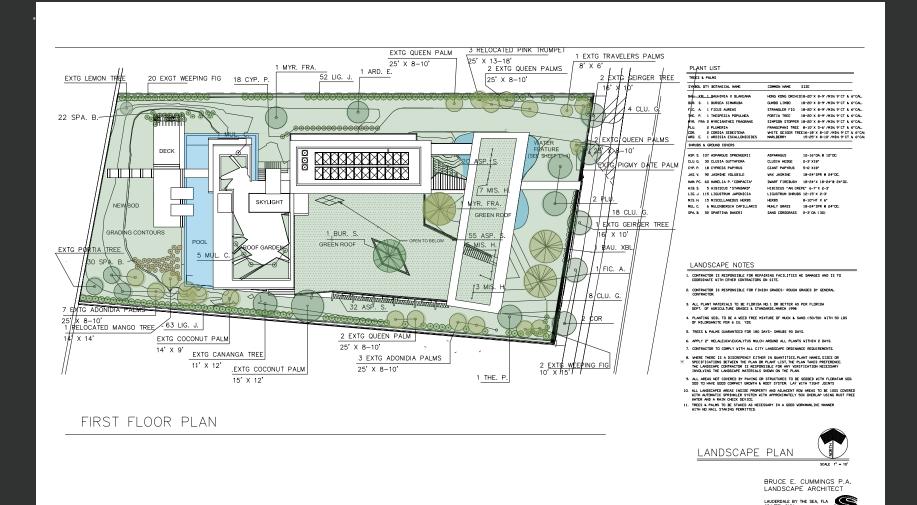

# **4880 PINE TREE DRIVE**

ARCHITECTURE SET


CONTINUANCE FINAL SUBMITTAL

MARCH 30, 2020



#### **DRAWING LIST**

A0	TITLE SHEET
A0.1	DESIGN REVISIONS DIAGRAM
A0.2	DESIGN REVISION DIAGRAM 2
A1	SURVEY 1 OF 2
A2	SURVEY 2 OF 2
А3	ZONING DATA SHEET
A4	CONTEXT PLAN
A5	CONTEXT ELEVATIONS
A6	CONTOUR PLAN
A7	UNIT SIZE DIAGRAMS
A8	PERVIOUS DIAGRAM
A9	LOT COVERAGE
A10	SITE PHOTOS
A11	CONTEXT PHOTOS
A12	DEMOLITION PLAN
A13	SITE PLAN
A14	UNDERSTORY PLAN
A15	LEVEL 1
A16	LEVEL 2
A17	VESTIBULE PLAN
A18	ROOF PLAN
A19	SOUTH ELEVATION OF FLOR
A20	NORTH ELEVATION
A21	WEST ELEVATION
A22	EAST ELEVATION
A23	SECTION A
A24	SECTION B
A25	SECTION C
A26	SECTION D
A27	EXTERIOR COVERED AREA
A28	SIDE YARD A SECTION
A29	SIDE YARD SECTION
A30 A31	REAR YARD SECTION
	FRONT YARD SECTION WAVER DIAGRAM - HEIGHT
A32 A33	WAVER DIAGRAM - HEIGHT WAIVER DIAGRAM - ELEVATOR LOCATION
A33 A34	EXPLODED AXO FLOOR RATIO
A34 A35	MATERIAL PALETTE
A36	OUTDOOR WORKOUT AREA
A36 A37	NORTH PRIVACY
A37 A38	SUN STUDY
A39	AXONOMETRICS
A39 A40	RENDERINGS - STREET PRESENCE VOLUME
A40 A41	DYNAMIC SCREEN W/ INDIVIDUAL ROTATING ELEMENTS
A41 A42	RENDERINGS
A42 A43	RENDERINGS
A+0	IZEMPEIZINOO

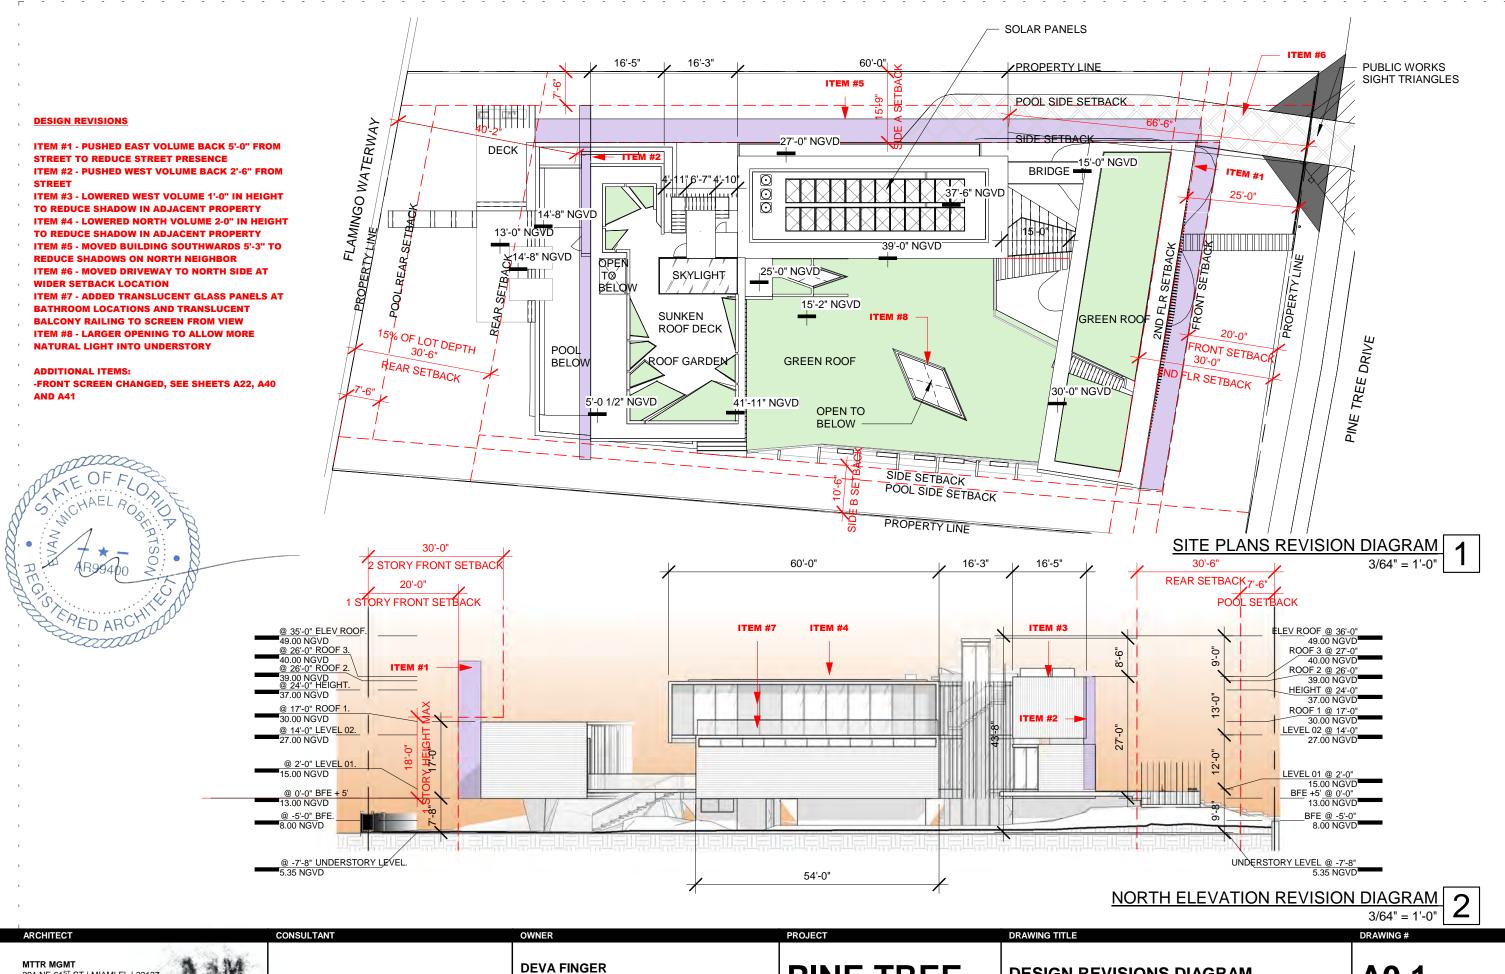

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4880 PINE TREE DR | MIAMI BEACH| FL | 33140

**PINE TREE** 

**DESIGN REVISIONS DIAGRAM** 03.30.2020 3/64" = 1'-0"

**A0.1** 


1804


#### **DESIGN REVISIONS FROM PREVIOUS**

ITEM #1 - REVISED OUTLINE OF UNDERTORY WALLS TO MAKE IT MORE OPEN.

ITEM #2 - CHANGED LOCATION OF OPENING TO ABOVE AND ADDED ANOTHER OPENING ITEM #3 - CHANGED HEIGHT OF SCREEN TO NOT EXTEND

PAST THE ROOF LINE

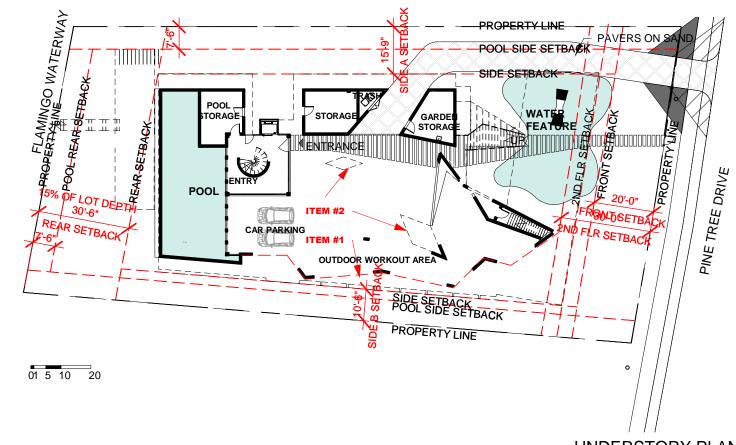

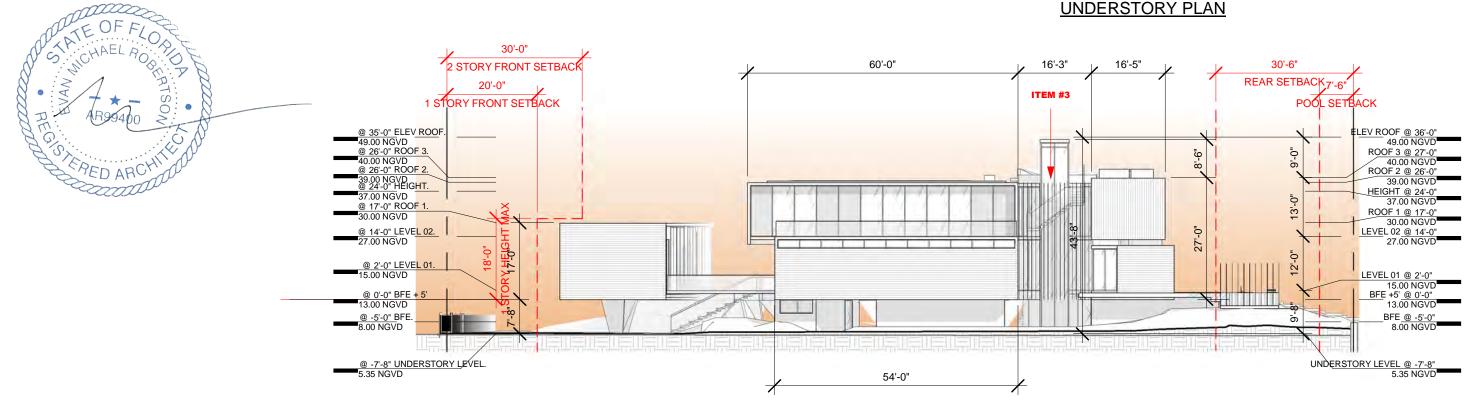

NORTH ELEVATION

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PINE TREE

**DESIGN REVISION DIAGRAM 2** 

As indicated

03.30.2020

A0.2

1804

DRAWING #



AFA & COMPANY, INC.
PROFESSIONAL LAND SURVEYORS AND MAPPERS FLORIDA CERTIFICATE OF AUTHORIZATION No. LE 7498 13050 SW 133RD COURT MIAMI, FLORIDA 33186 E-MAIL: AFACOMBELLSOUTH NET PH: 305-234-0588 FX: 206-495-0778

TREE LEGEND: 1 Queen Palm D=0.70', H=20', SP=10' 2. Christmas Palm D=0.80', H=20, SP-8 3. Oueen Pslm D=0.35', H=10', SP-5 4. Palm D-0.70', H-20', SP-8' 5. Palm D-0.80', H-25', SP-15' 6 Palm D=0.90' H=25' SP=15 7. Palm D-0.80', H-25', SP-15' 8. Palm D-0.80', H-25', SP-15' 9 Palm D-080', H-25', 5P-15' 10. Ficus D-0.85, H-30', SP-20' 11. Queen Palm D-0.85', H-30', 6P-20' 12. Ficus D-9.80', H-25', SP-20' 13. Ficus D-9.80', H-25', SP-20' 14. Christmas Palm D=10', H=20', SP=15 15. Christmas Palm D-0.60', H-10', SP-10 16. Queen Palm D-0.40', H-10', SP-10' 17. Figus D=0.50', H=20', SP=10' 18. Coconut Palm D=11', H=35', SP=20' 19. Guesn Palm D=0.35', H=10', SP=10' 20. Christmas Palm D=0.70', H=25', SP=10' 21. Christmas Palm D=0.80', H=25', SP=10' 22. Christmas Palm D=0.40', H=20', SP=10' 23. Christmas Palm D=0.40', H=20', SP=10' 24. Christmas Palm D=0.80', H=35', SP=20' 25. Christmas Palm D-0.80', H-35', SP-20' 25. Christmas Palm D-0.80', H-35', SP-20' 27. Christmas Palm D-0.80', H-35', SP-20' 28. Christmas Palm D-0.80', H-35', SP-20' 29 Civiatrosa Patro D-080' H-35' SP-20' 30. Christmas Palm D-080', H-35', SP-20' 31 Figus D-13', H-15', SP-15' \$2, Flous D=2.5', H=25', 8P=20' \$3, Flous D=4.0', H=35', 5P=35' \$4, Flous D=0.55', H=20', SP=10' 35. Christmas Palm D-0.85, H-20', SP-15' 36. Ousen Palm D-10', H-25', SP-15' 37. Flous D=0.70', H=20', SP=15' SR. Christmas Palm D-0.70', H-20', SP-12' 59. Christmas Palm D-0.60', H-15', SP-12' 40. Ficus D-11', H-20', SP-10' 41. Ficus D-11', H-20', SP-10' 42. Christmas Palm D-0.70', H-30', SP-15' 44. Queen Palm D-0.35', H-10', SP-5' 45. Christmas Paim D-0.60', H-30', 5P-10'

46. Christmas Palm D=0.70', H=30', SP=15' 47. Christmas Palm D=0.70', H=20', SP=10' 48. Christmaa Palm D-0.70', H-20', SP-10' 49. Queen Palm D-035', H-10', SP-8' 50. Ficus D-0.70', H-15', SP-10' 51. Christmas Palm D=0.50', H=25', SP=10' 52. Christmas Palm D=0.50', H=25', SP=10' 53. Christmas Palm D-0.50', H-25', 5F-10' 54. Christmas Palm D-0.50', H-25', 8P-10' 55. Christmas Palm D-0.50', H-25', 8P-10' 56. Christmas Palm D-0.50', H-25', SP-10' 57. Christmas Palm D-0.50', H-25', SP-10' 58. Christmas Paim D-0.50', H-25', SP-10' 59. Christmas Paim D-0.50', H-25', SP-10' 60. Christmas Paim D-0.50', H-25', SP-10' 61. Christmas Palm D-0.50', H-25', SP-10' 62. Coconut Palm D-10', H-25', SP-15' 63. Avocado D-0.70', H-25', 8P-20' 64. Queen Palm D-0.80', H-25', SP-20' 65. Queen Palm D-0.80', H-25', SP-20' 66. Coconut Palm D-10', H-35', 8P-20' 67. Coconut Palm D-10', H-35', SP-20' 68. Ficus D-0.40', H-20', SP-15' 69. Christmas Palm D=0.35', H=25', SP=10' 70. Flous D=10', H=30', SP=10' 71. Coconut Palm D=0.70', H=35', SP=25' 72. Christmas Palm D=0.80', H=25', SP=10' 73 Christmas Palm D=080' H=25' SP=10' 74. Christmas Palm D=0.80', H=25', SP=10' 74. Christmas Palm D=0.85', H=25', SP=8' 76. Christmas Palm D=0.60', H=25', SP=8' 77. Christmas Palm D=0.60', H=25', SP=8' 77. Christmas Patin D-0.80', H-25', SP-8'
79. Christmas Patin D-0.80', H-15', SP-8'
80. Mango D-0.70', H-15', SP-8'
81. Christmas Patin D-0.80', H-20', SP-8'
82. Christmas Patin D-0.80', H-20', SP-8'
83. Lemon D-0.40', H-10', SP-10' 85. Christmas Palm D-0.60', H-30', SP-20 86. Christmes Palm D-0.60', H-15', SP-10' 87. Ficus D-0.50', H-15', SP-10' 88. Ficus D-0.50', H-15', SP-10' 89. Ficus D=0.50', H=15', SP=10'

#### **Property Information**

#### PROPERTY ADDRESS:

4880 Pine Tree Drive Miami Beach, Florida 33140

#### CERTIFIED ONLY TO:

Deva Finger

#### LEGAL DESCRIPTION:

Lots 24 and 25, Less the Southerly 1/2 of Lot 24, Block 32, of: "LAKE VIEW SUBDIVISION", according to the Plat Thereof as Recorded in Plat Book 14, Page 42, of the Public Records of Miami-Dade County, Florida.

#### **ELEVATION INFORMATION** National Flood Insurance Program FEMA Elev. Reference to NGVD 1929

Comm Panel 120651 Panel # 0309 "AE" Firm Zone: Date of Firm: 09-11-2009 Base Flood Eley. 8.00' 6.52 F.Floor Elev. Garage Elev. 5.06 "L" Suffix: Elev. Reference to NGVD 1929

JOB#	19-1223
DATE	11-08-2019
PB	14-42

#### Surveyors Notes:

- #I Land Shown Hereon were not abstracted for Easement and for Right of Way Records. The Easement / Right of Way Show on Survey are as per plat of record unless otherewise noted #2 Benchmark: Miami-Dade County Public Works Dep.
- #3 Bearings as Shown hereon are Based upon
- West 47th Street, N90°00'00"E #4 Please See Abbreviations #5 Drawn By: A. Torres
- #6 Date: 7-26-18; 10-5-18; 11-8-19
- #7 Completed Survey Field Date: 7-25-18; 10-1-18; 11-8-19 #8 Disc No 2019, Station Surveying Scion
- #9 Last Revised:
- #10 Zoned Building setback line not determined

#### Surveyor's Notes:

- #11 The herein captioned Property was surveyed and described based
- on the Legal Description Provided by Client #12 This Certification is Only for the lands as Described, it is not a certification of Title, Zoning, Easements, or Freedom of encumbrances. ABSTRACT NOT REVIEWED.
- #13 There may be additional Restrictions not Shown on this survey that may be found in the Public Records of Said County Examination of ABSTRACT OF TITLE will have to be made to determine recorded instruments, if any affecting this property.
- #14 Accuracy: The expected use of land, as classified in the Standards of Practice (5J-17 052), is residential. The minimum relative distance accuracy for this type of boundary survey is 1.0 foot in 10,000.00' feet, the accuracy obtained by measurement and calculation of a closed geometric figure was found to exceed
- #15 Foundation and / or footing that may cross beyond the boundary lines of the parcel herein described are not shown hereon.
- #16 Not valid without the signature and original seal of a Flonda Licensed Surveyor and Mapper, additions or deletions to survey maps or reports by other than the signing party or parties.
- #17 Contact the appropriate authority prior to any design work on the herein described parcel for building and zoning information. #18 Underground Utilities are not depicted hereon, contact the appropriate authority prior to any design work or construction
- on the property herein described. Surveyor shall be notified as to any deviation from utilities shown hereon. #19 Ownership subject to Opinion of Title



Professional Surveyors & Mappers LB 7498 13050 S.W. 133rd Court Miami Florida, 33186 E-mail: afaco@bellsouth.net Ph: (305) 234-0588 Fax: (206) 495-0778

This certifies that the survey of the property described hereon was made under my super vision & that the survey meets the Standards of Practice set forth by the Florida Board of Professional Land Surveyors & Mappers in Chapter 5J-17.052 of Florida Administrative Code, pursuant to Section. 472.027, Florida Statutes. & That the Sketch hereon is a true and accurate representation thereof to the best of my knowledge and Belief, subject to notes

onal Surveyor & Mapper #5526 State of Florida Not Valid unless Signed & Stamped with Embossed Seal

Location Sketch



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4880 PINE TREE DR | MIAMI BEACH| FL | 33140


**PINE TREE** 

SURVEY 1 OF 2

DRAWING #

03.30.2020

# Boundary Survey

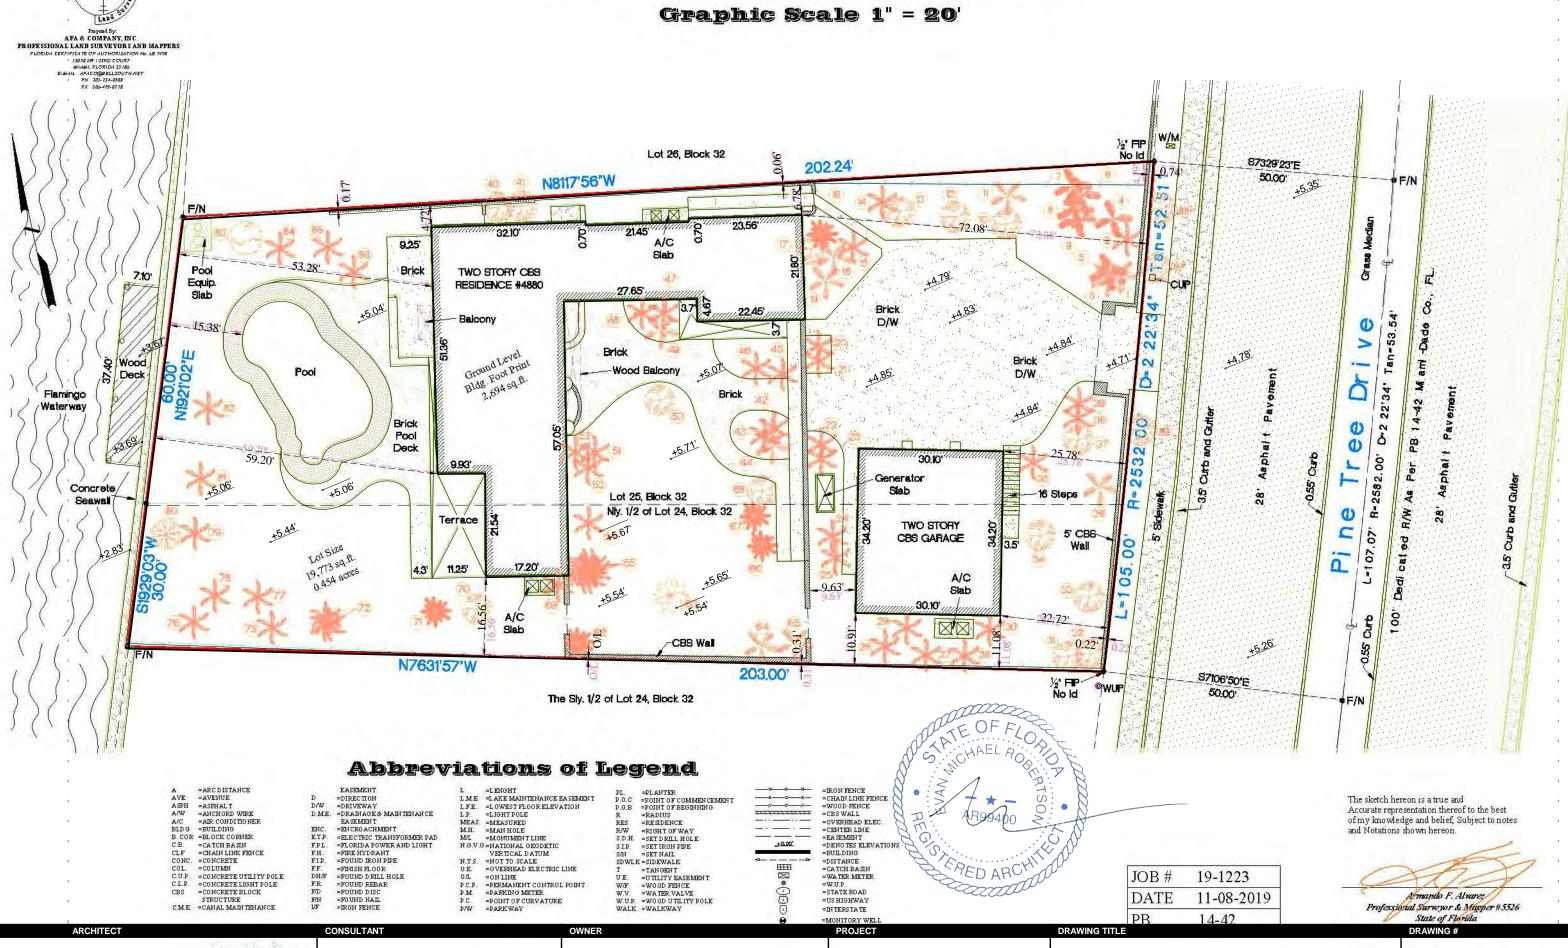

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AFA &

**DEVA FINGER** 4880 PINE TREE DR | MIAMI BEACH| FL | 33140 **PINE TREE** 

**SURVEY 2 OF 2** 

1" = 20'-0"

**A2** 

1804



Planning Department, 1700 Convention Center Drive Miami Beach, Florida 33139, www.miamibeachfl.gov 305,673,7550

#### SINGLE FAMILY RESIDENTIAL - ZONING DATA SHEET


ITEM	Zoning Information						
	Address: 4880 PINE TREE DRIVE, MIAMI BEACH, FL, 33140						
2	Folio number(s):	02-3222-022-1770	02-3222-022-1770				
	Board and file numbers :	DRB19-0468					
	Year built:	1938	Zoning District:	RS-3			
	Based Flood Elevation:	8.00 NGVD	Grade value in NGVD:	4.60 NGVD			
=	Adjusted grade (Flood+Grade/2):	6,30 FEET	Free board:	13.00 NGVD			
	Lot Area:	19,773 SF					
	Lot width:	105 FEET	Lot Depth:	203 FEET			
	Max Lot Coverage SF and %:	5,931 SF 30%	Proposed Lot Coverage SF and %:	4,969 SF 25%			
0	Existing Lot Coverage SF and %:	3,727 SF 19%	Lot coverage deducted (garage-storage) SF:	N/A			
1	Front Yard Open Space SF and %:	1,862 SF 88%	Rear Yard Open Space SF and %:	2,210 SF 80%			
2	Max Unit Size SF and %:	9,887 SF 50%	Proposed Unit Size SF and %:	7,637 SF 39%			
3	Existing First Floor Unit Size:	2,694 SF	Proposed First Floor Unit Size:	4,046 SF			
4	Existing Second Floor Unit Size	3,727 SF	Proposed Second Floor volumetric Unit Size SF and % (Note: to exceed 70% of the first floor of the main home require DRB Approval)	2,713 SF 67%			
.5			Proposed Second Floor Unit Size SF and %:	2,713 SF 67%			
16			Proposed Roof Deck Area SF and % (Note: Maximum is 25% of the enclosed floor area immediately below):	570 SF 21%			

		Required	Existing	Proposed	Deficiencies
1.7	Height:	24 FEET + 3 FEET WAIVER	20 FEET	27 FEET	
8	Setbacks:				
9	Front First level:	20'-0"	22.72 FEET	25'-0"	
20	Front Second level:	30'-0"	22.72 FEET	61'-8"	
1	Side 1:	10'-6"	4.72 FEET	10'-6' <sup>c</sup>	
2	Side 2 or (facing street):	15'-9"	10.91 FEET	15'-9"	
3	Rear:	30'-6"	53, 28 FEET	41'-2"	
	Accessory Structure Side 1:	7'-6"	N/A	7'-6"	
4	Accessory Structure Side 2 or (facing street) :	N/A	N/A	N/A	
5	Accessory Structure Rear:	7'-6"	N/A	16'-5"	
6	Sum of Side yard :	26'-3"	15.63 FEET	26'-3"	
7	Located within a Local Historic District?			NO	
8	Designated as an individual Historic Single Family Residence Site?			NO:	
29	Determined to be Architecturally Significant?			NO.	



If not applicable write N/A

All other data information should be presented like the above format

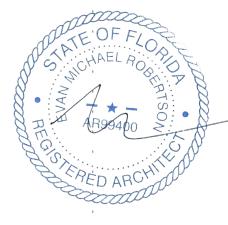

**DEVA FINGER** 


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4880 PINE TREE DR | MIAMI BEACH| FL | 33140

**PINE TREE** 

**ZONING DATA SHEET** 03.30.2020

**A3** 

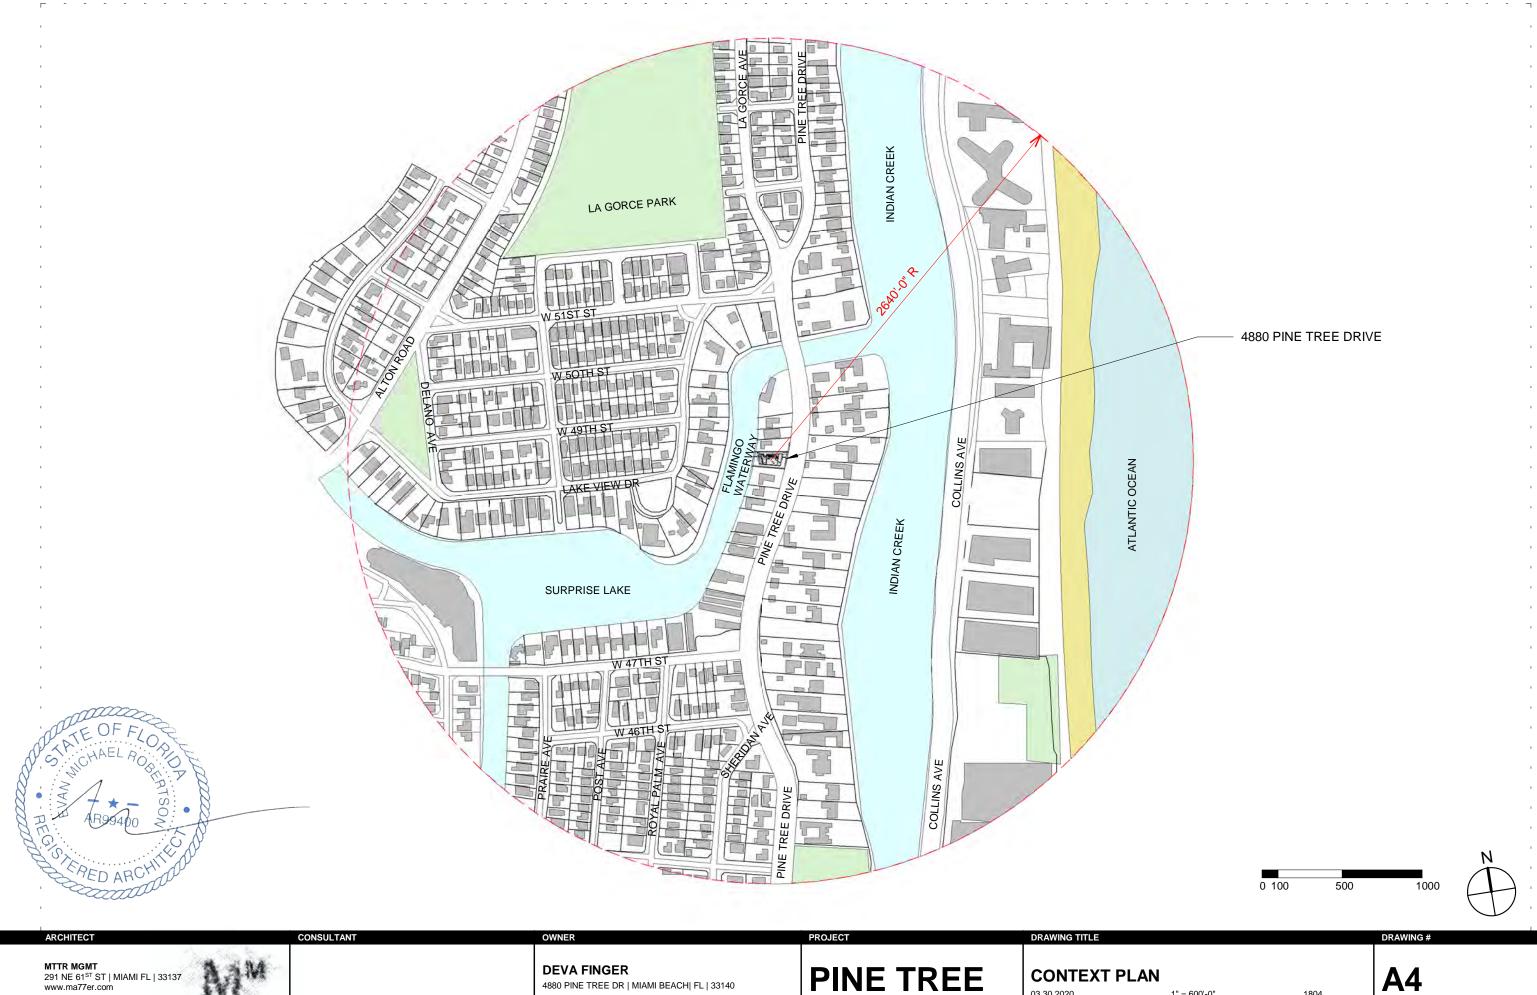

03.30.2020 1" = 600'-0"






ARCHITECT CONSULTANT OWNER PROJECT DRAWING TITLE


MTTR MGMT
291 NE 61 ST ST | MIAMI FL | 33137
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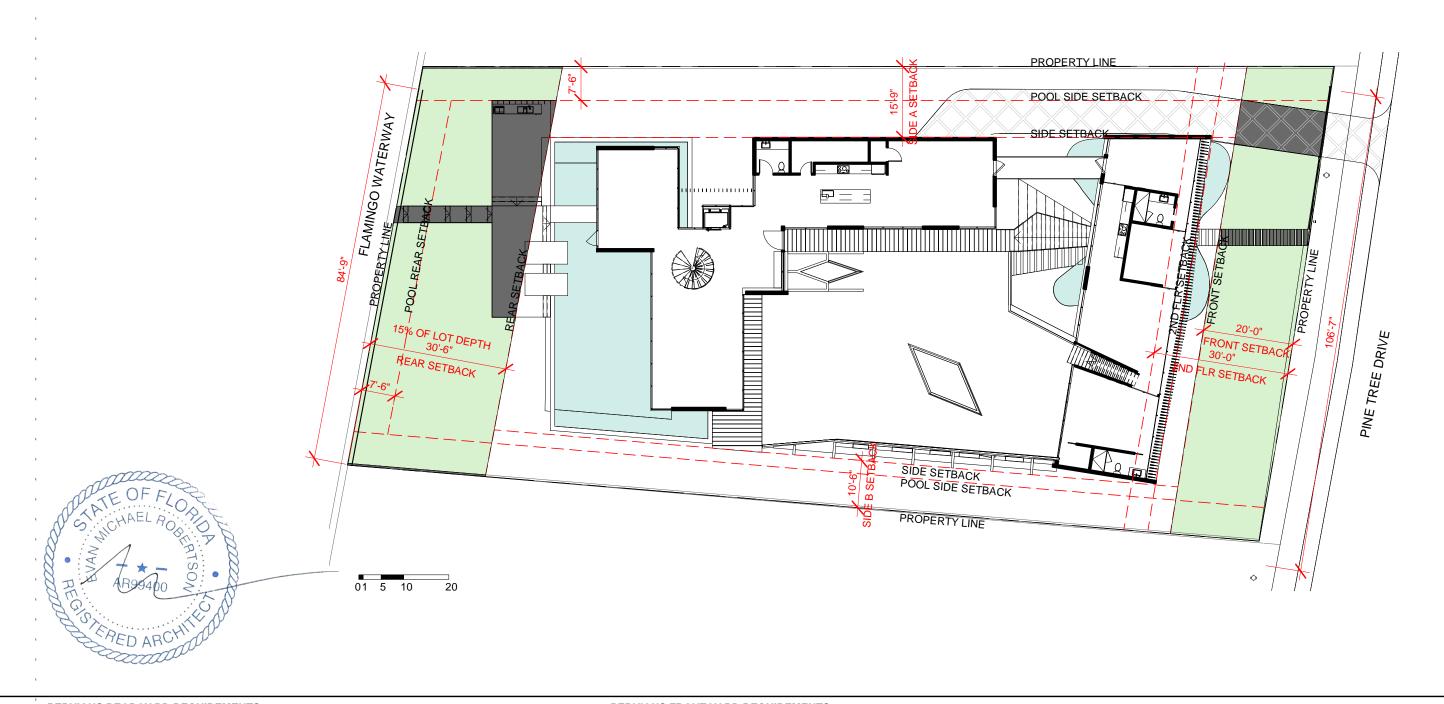
DEVA FINGER
4880 PINE TREE DR | MIAMI BEACH| FL | 33140

PROJECT DRAWING TITLE

CONTEXT ELEVATIONS
03.30.2020 3/64" = 1'-0" 1804



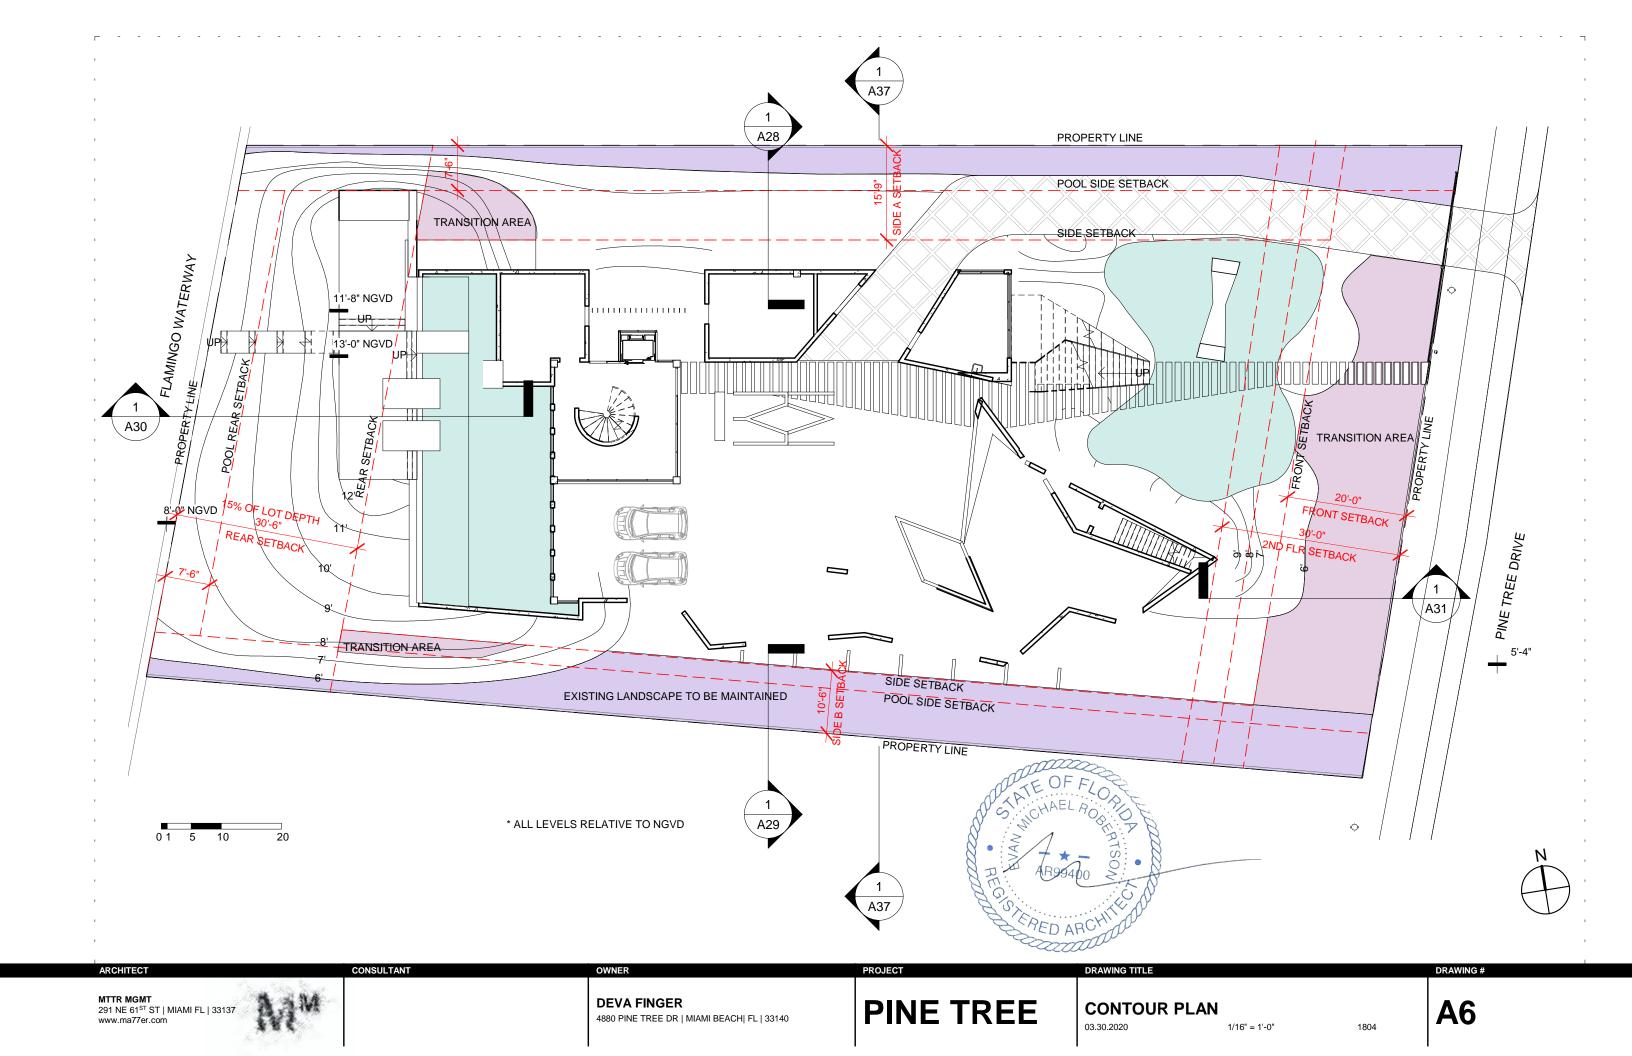

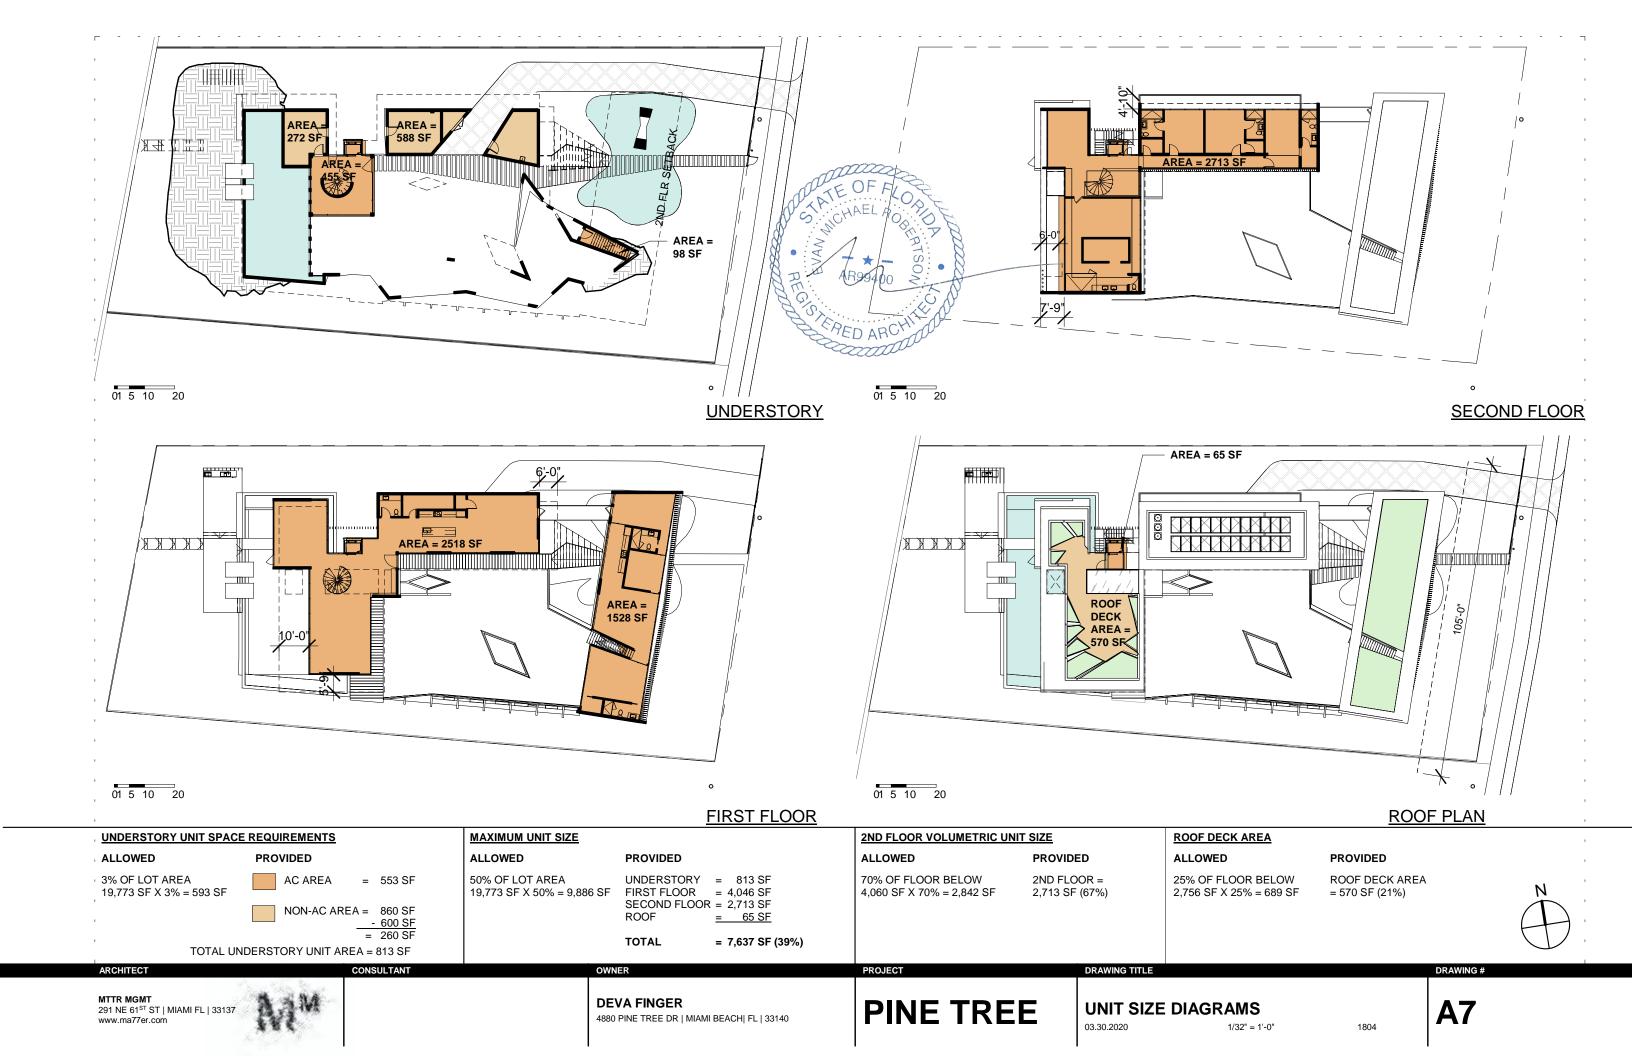

#### PERVIOUS REAR YARD REQUIREMENTS PERVIOUS FRONT YARD REQUIREMENTS ALLOWED **PROVIDED ALLOWED PROVIDED** 70% OF REAR YARD AREA 50% OF FRONT YARD AREA SODDED OR LANDSCAPED SODDED OR LANDSCAPED 2,779 SF X 70% = 1,945 SF 2,210 SF 80% 2,116 SF X 50% = 1,058 SF 1,862 SF 88% IMPERVIOUS 571 SF PAVERS 242 SF



DRAWING TITLE **PINE TREE DEVA FINGER A8 PERVIOUS DIAGRAM** 


03.30.2020


3/64" = 1'-0"

1804

4880 PINE TREE DR | MIAMI BEACH| FL | 33140

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**LOT COVERAGE** 

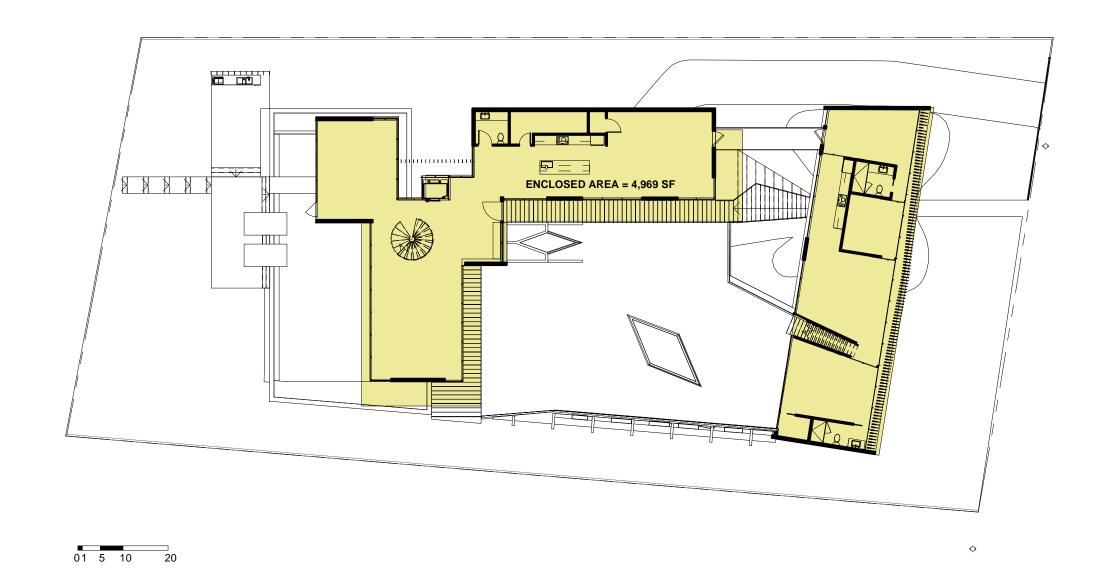ALLOWED

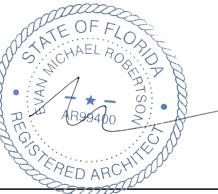30% OF LOT AREA 19,773 SF X 30% = 5,931 SF

PROVIDED

LOT COVERAGE AREA 4,969 SF (25%)



DRAWING TITLE **DEVA FINGER** 

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**PINE TREE** 

**LOT COVERAGE** 03.30.2020

3/64" = 1'-0"

**A9** 


DRAWING #









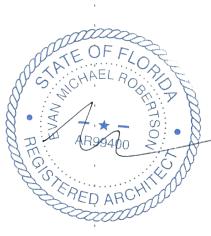

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**DEVA FINGER** 

4880 PINE TREE DR | MIAMI BEACH| FL | 33140

**PINE TREE** 


SITE PHOTOS 03.30.2020

**A10** 







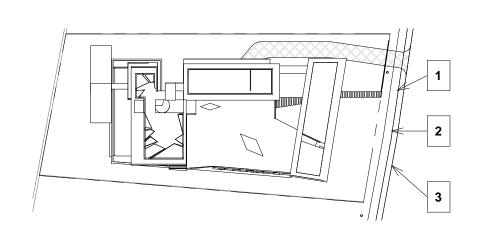


MTTR MGMT 291 NE 61<sup>ST</sup> ST | MIAMI FL | 33137 www.ma77er.com


**DEVA FINGER** 

4880 PINE TREE DR | MIAMI BEACH| FL | 33140

**PINE TREE** 

**CONTEXT PHOTOS** 03.30.2020 1" = 60'-0" **A11** 

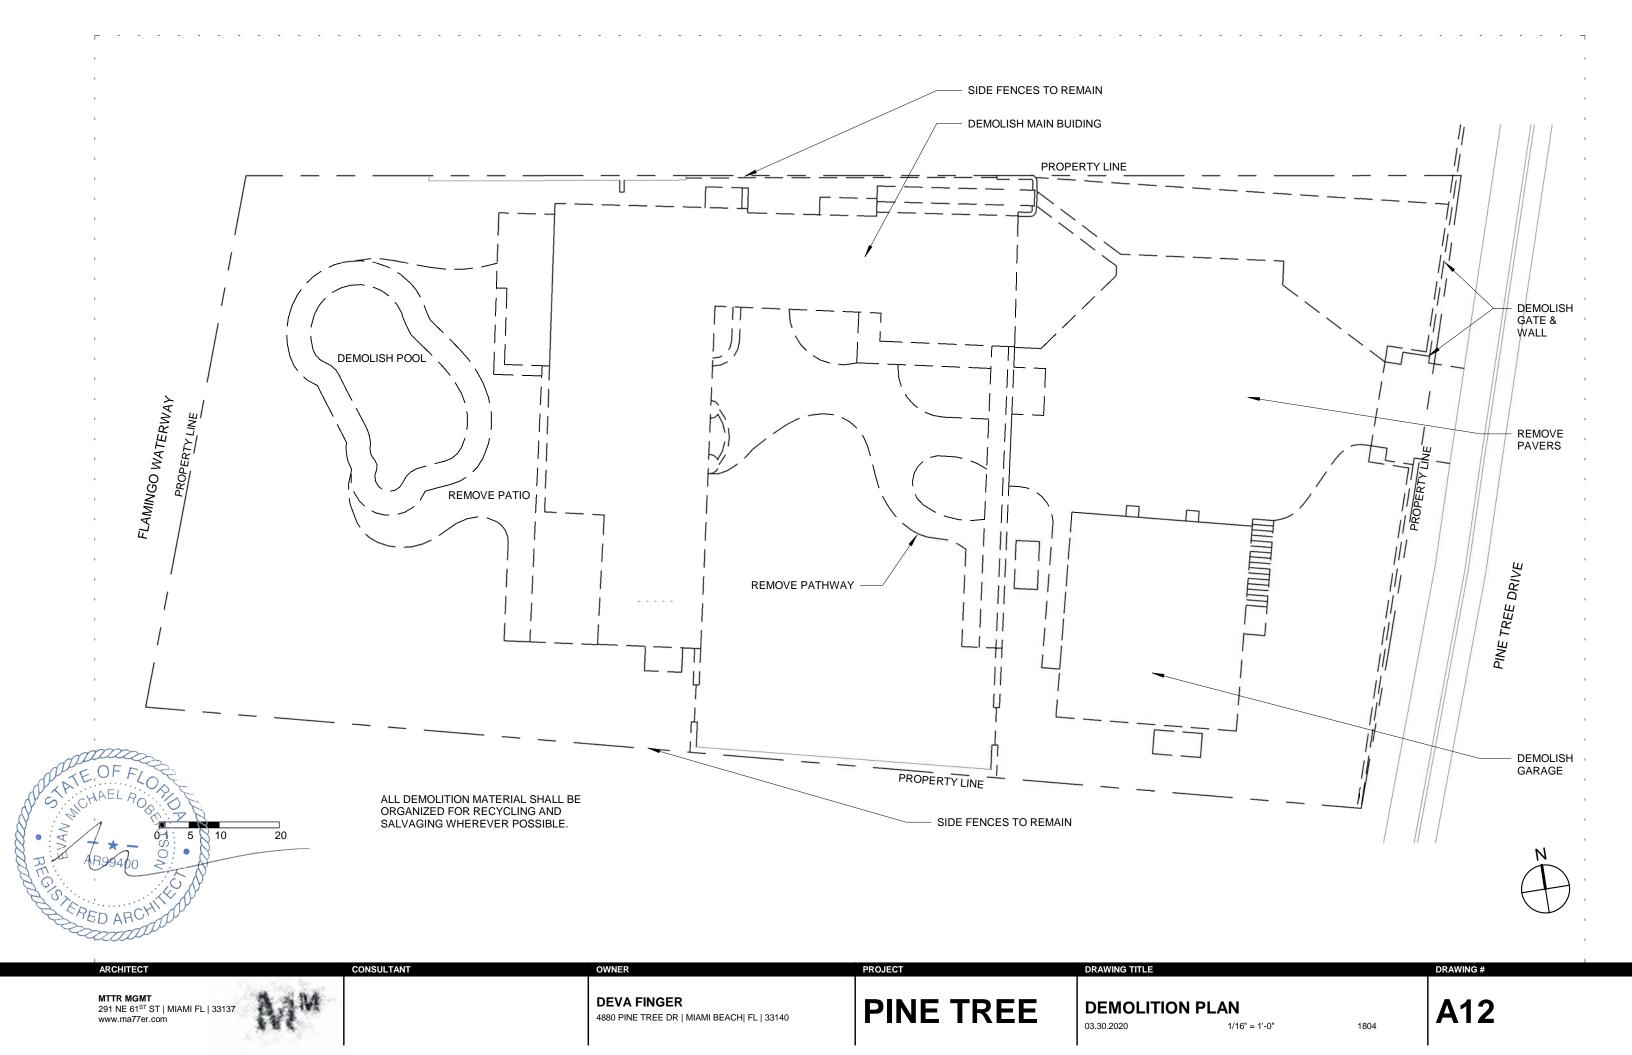

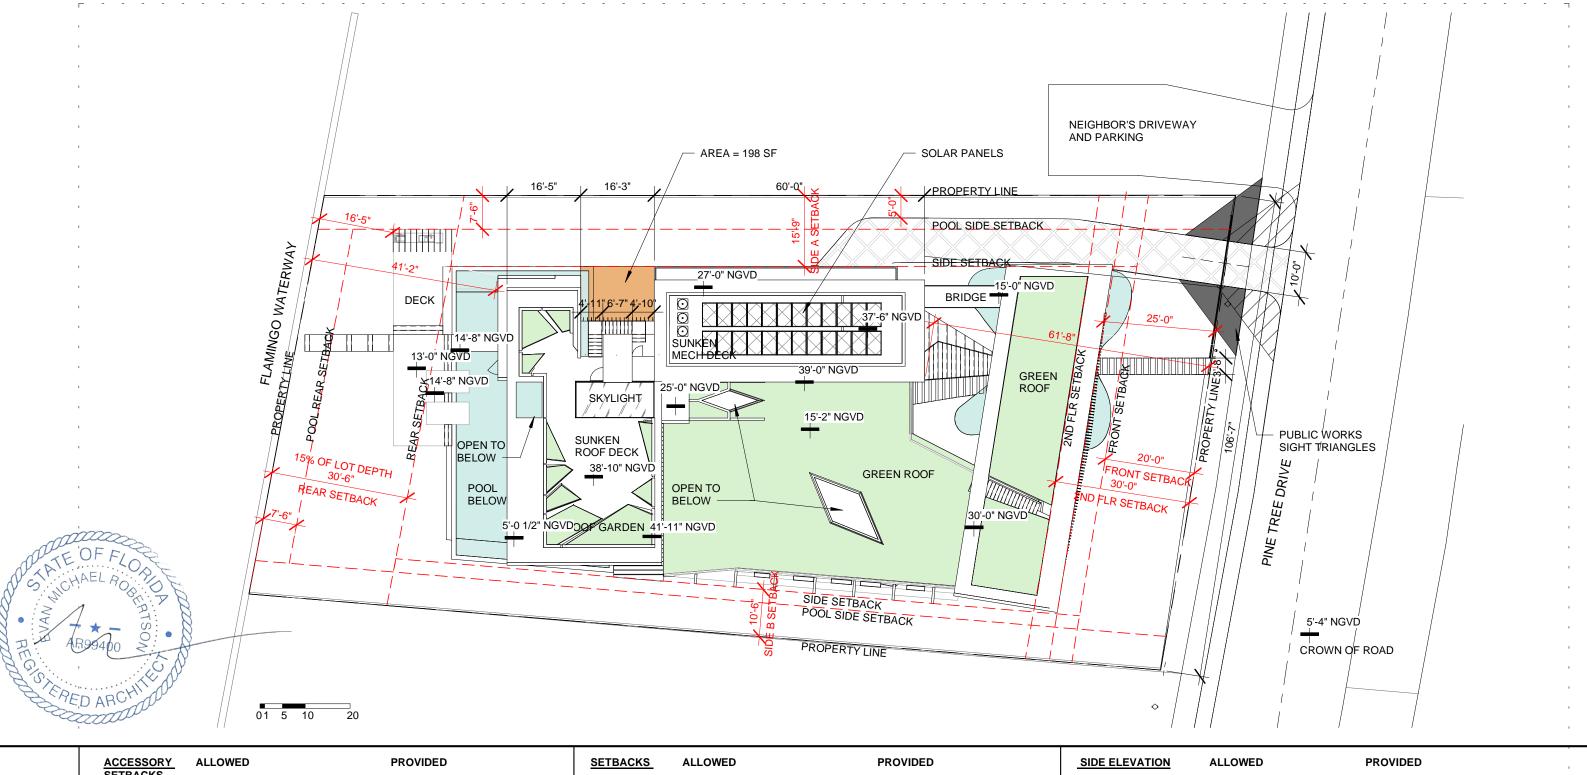


ACCESSORY SETBACKS	ALLOWED	PROVIDED	SETBACKS	ALLOWED	PROVIDED	SIDE ELEVATION	ALLOWED	PROVIDED	
SIDE:	7'-6"	7'-6"	FRONT:	ONE STORY: 20' 0" TWO STORY: 30'-0"	25'-0" 61'-8"	2 STORY MAX ALLOWABLE LENGTH	60'-0" MAX	60'-0"	1
REAR:	7'-6"	16'-5"	SIDE:	25% OF LOT WIDTH 105' X 25% = 26.25 SIDE B 10% LOT WIDTH = 10.5' SIDE A = 15.75' MIN. 15% OF LOT DEPTH	10'-6" 15'-9"	AREA OF COURTYARD	1%OF LOT AREA 19,773 SF X 1%: 197.7 SF	198 SF	$\bigcap_{i=1}^{N} A_{i}$
				203' X 15% = 30.5'	41'-2"				
ARCHITECT		CONSULTANT	OWNER		PROJECT	DRAWING TITLE		DRAWING #	


MTTR MGMT 291 NE 61<sup>ST</sup> ST | MIAMI FL | 33137 www.ma77er.com DEVA FINGER 4880 PINE TREE DR | MIAMI BEACH| FL | 33140


PINE TREE


SITE PLAN 03.30.2020 A13


3/64" = 1'-0"

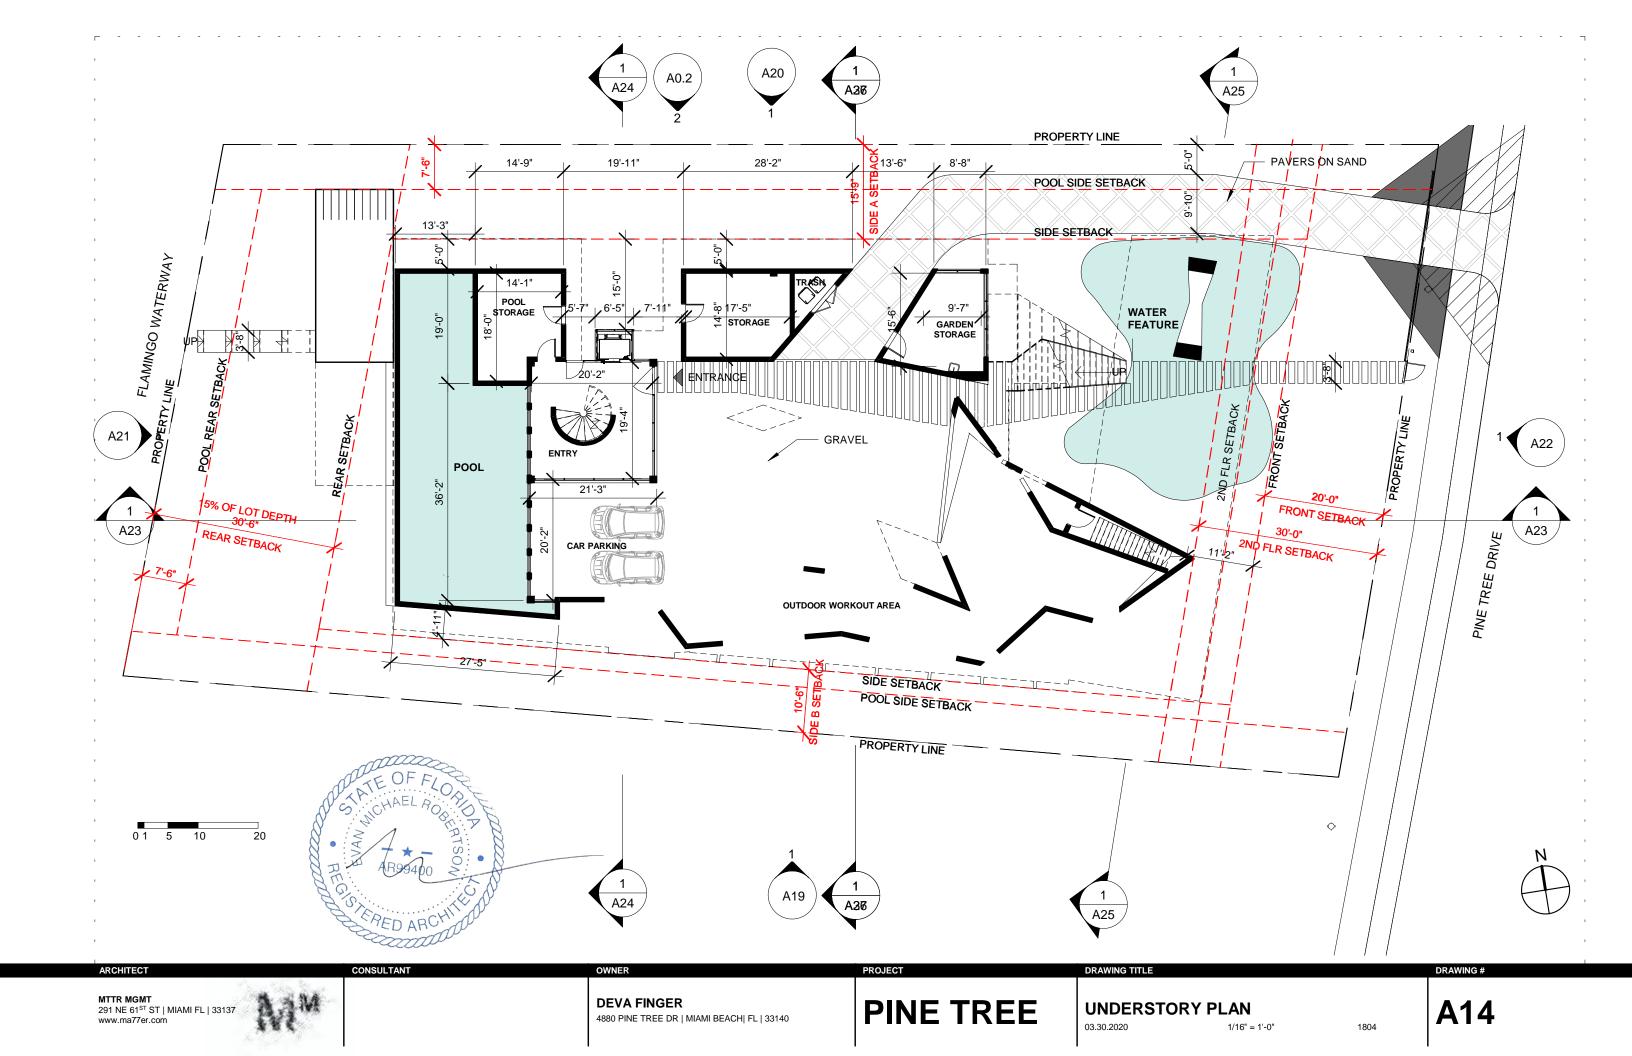


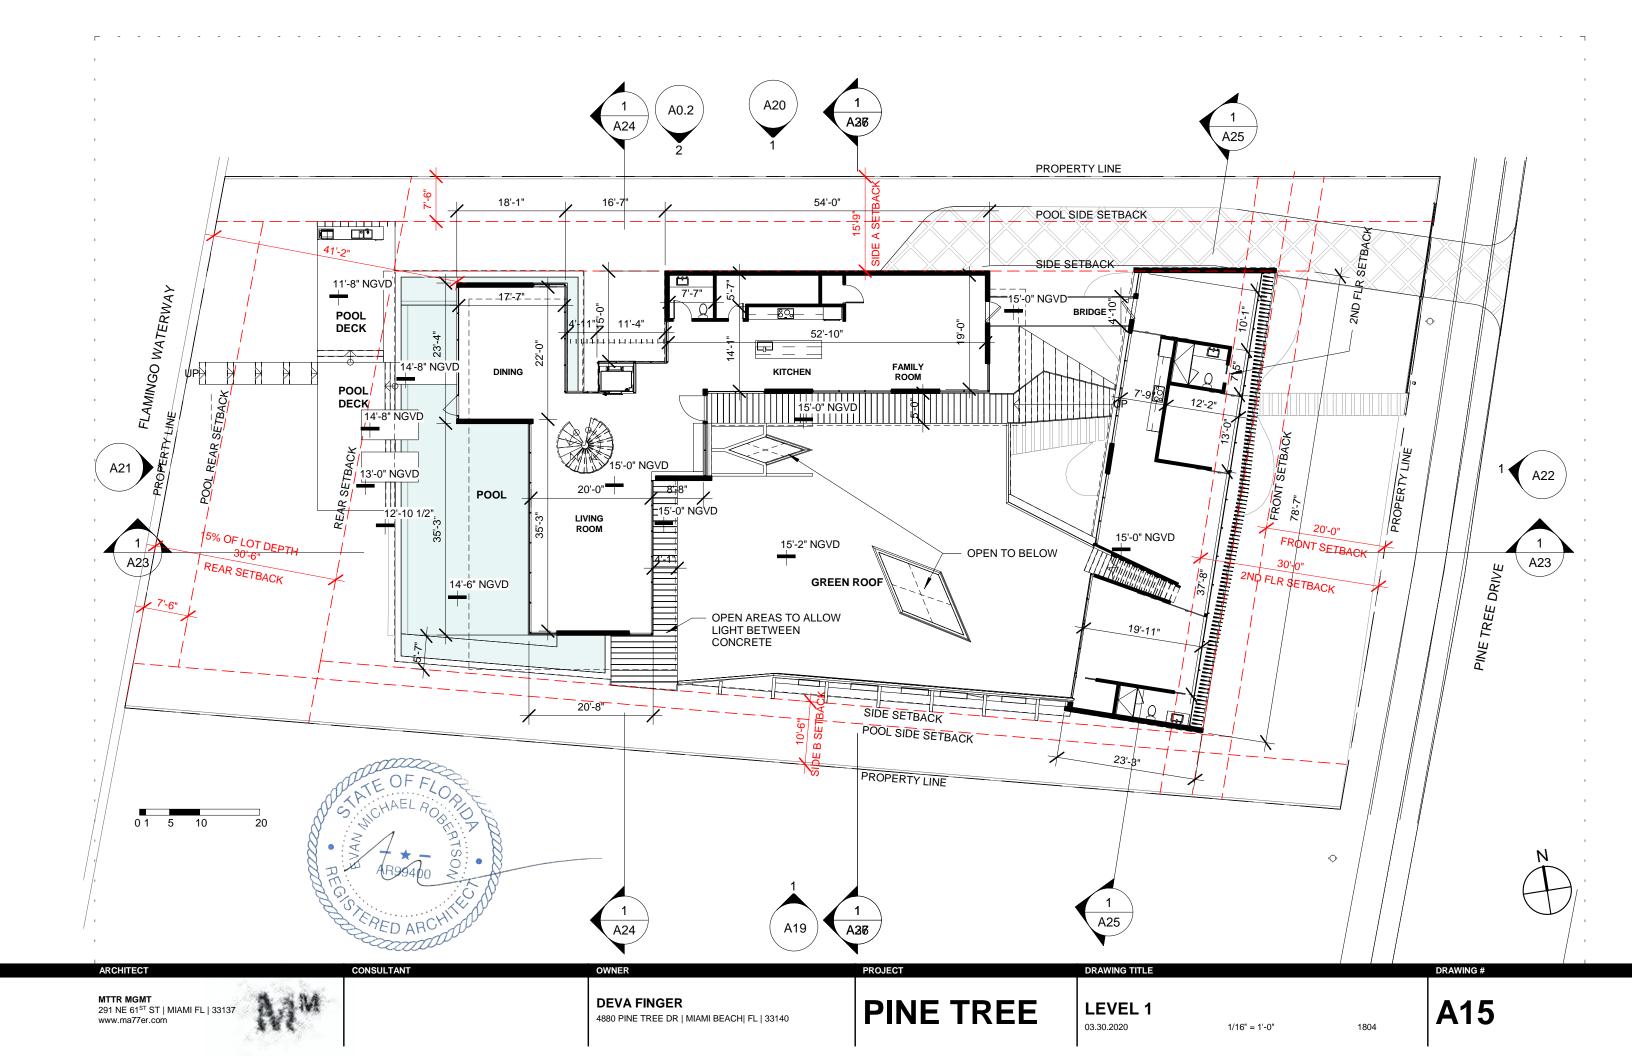

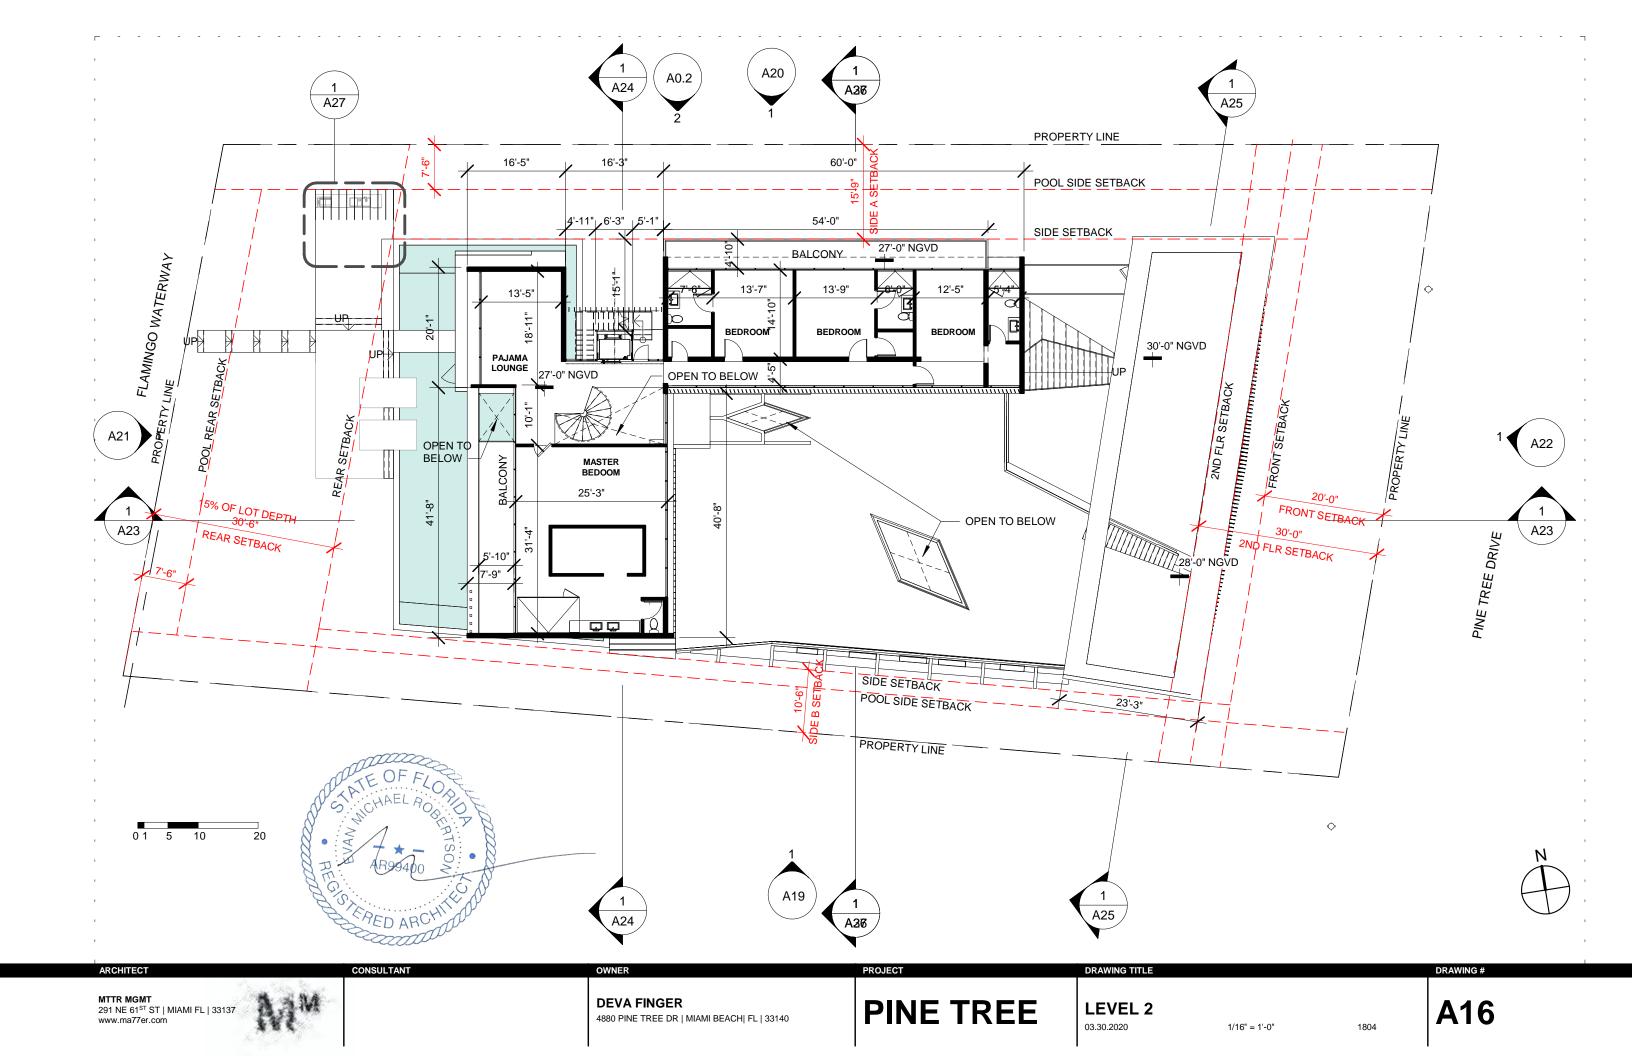

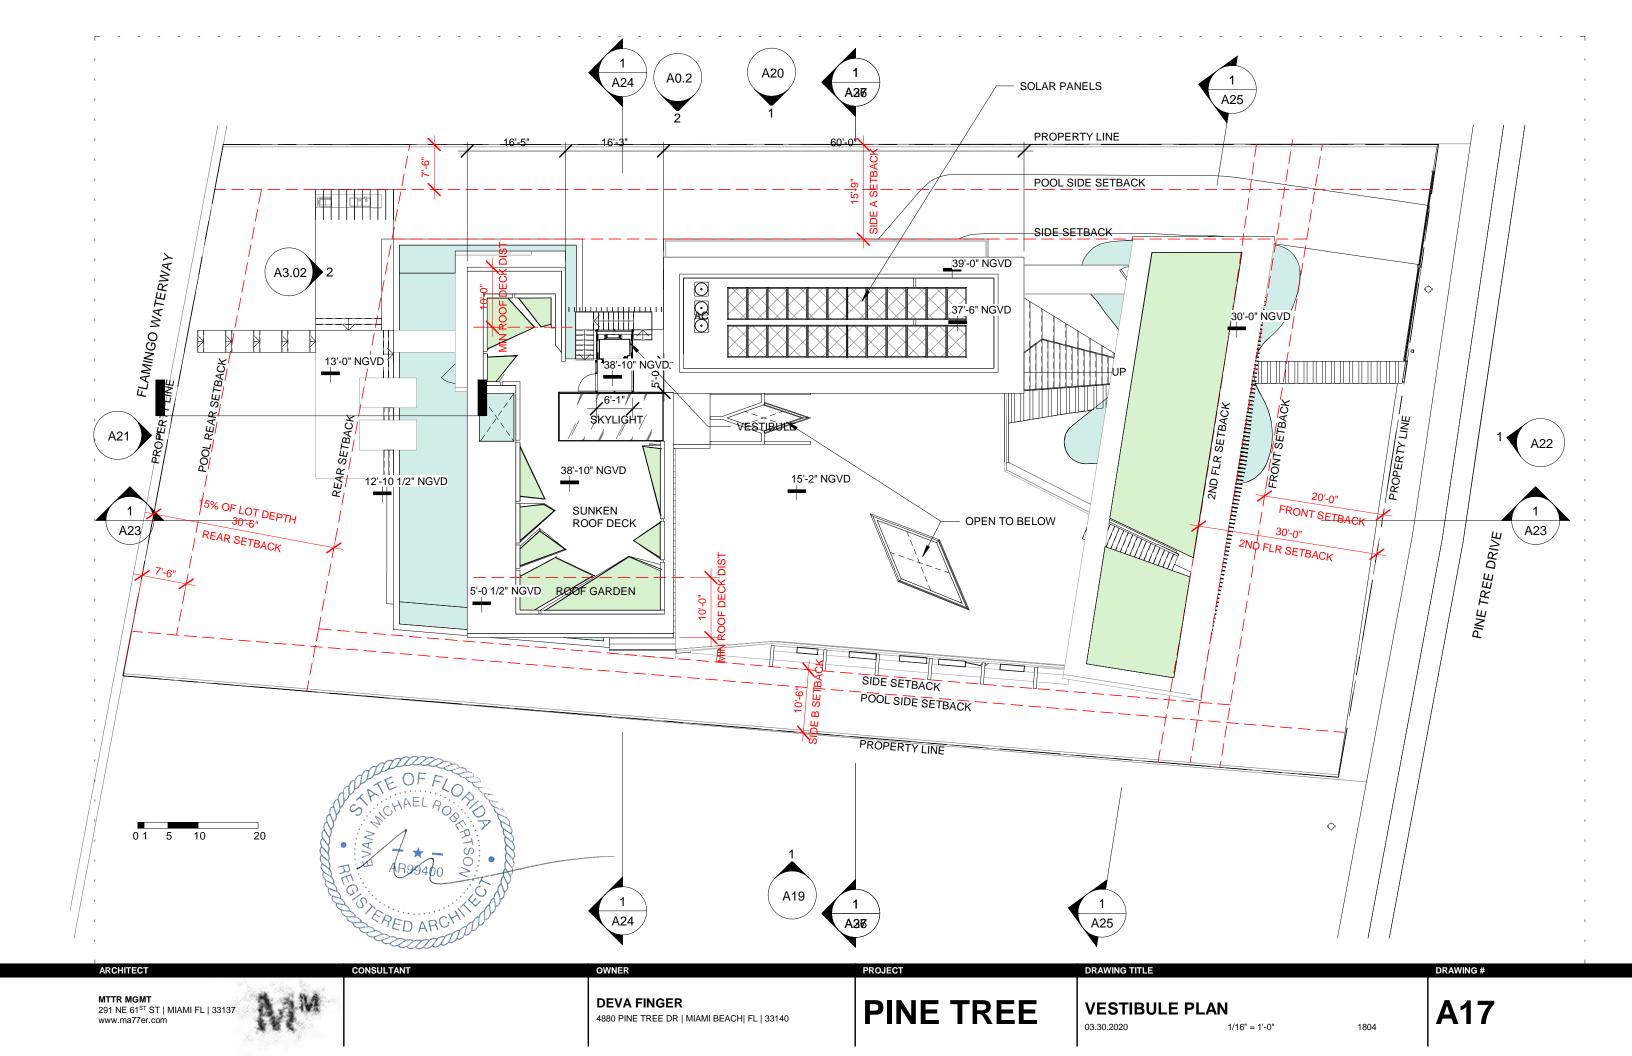

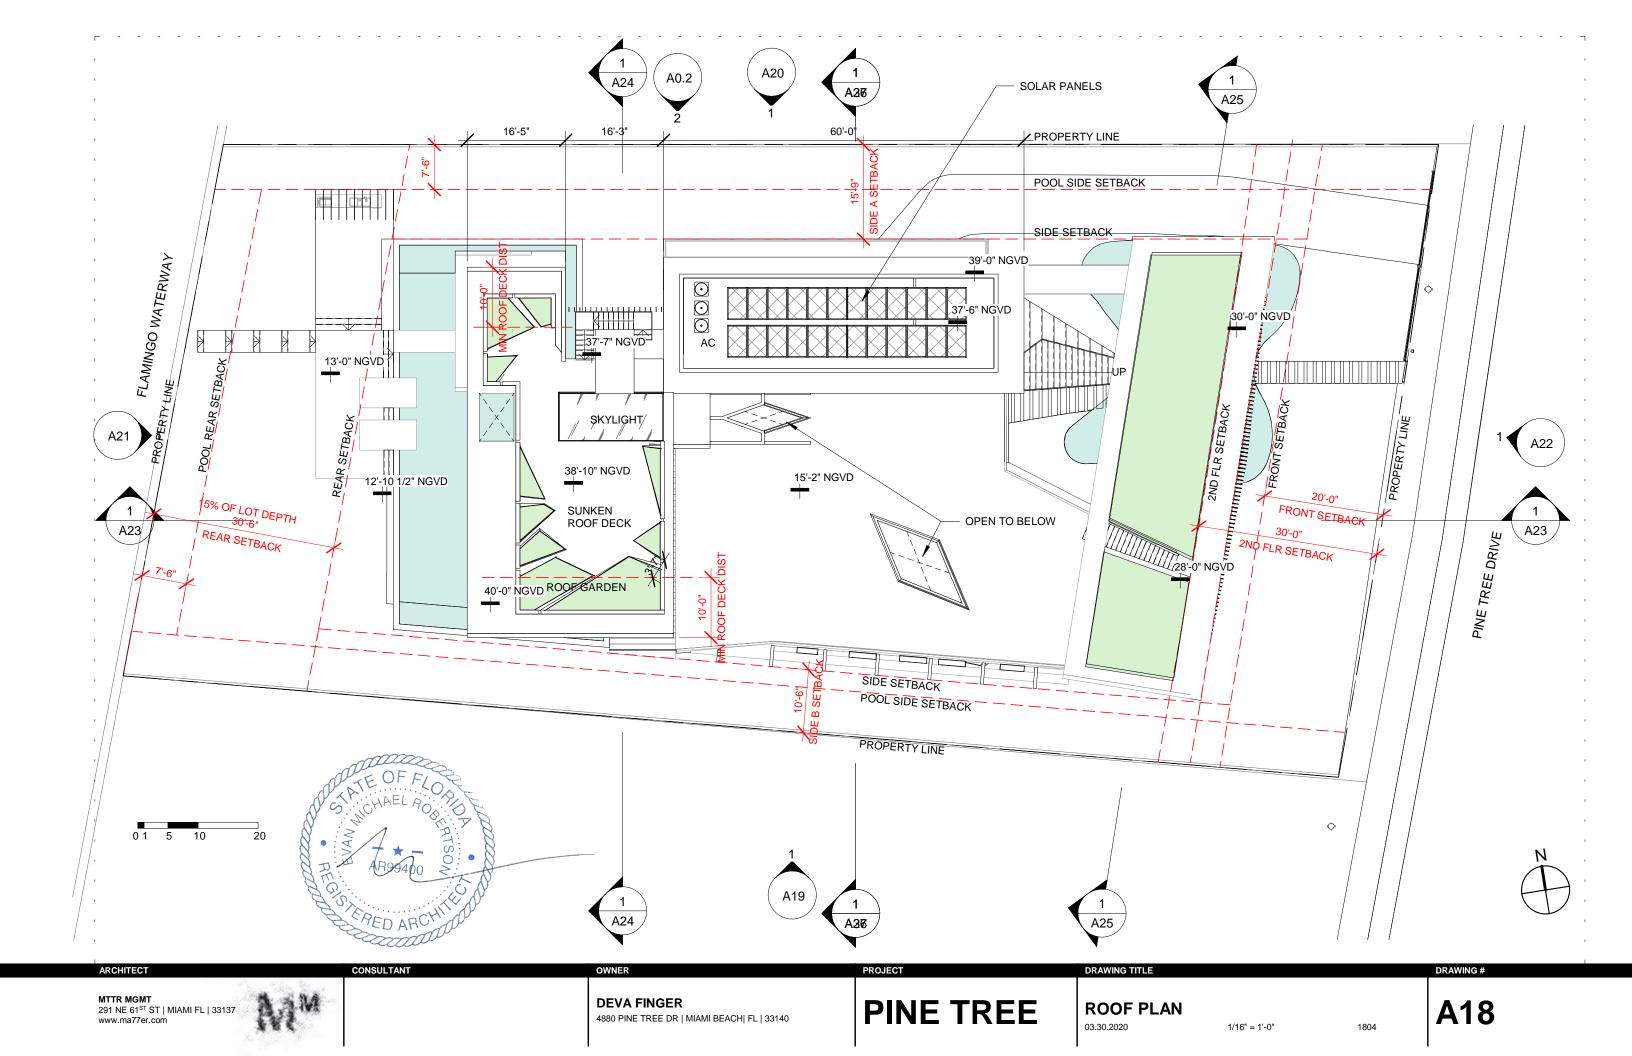

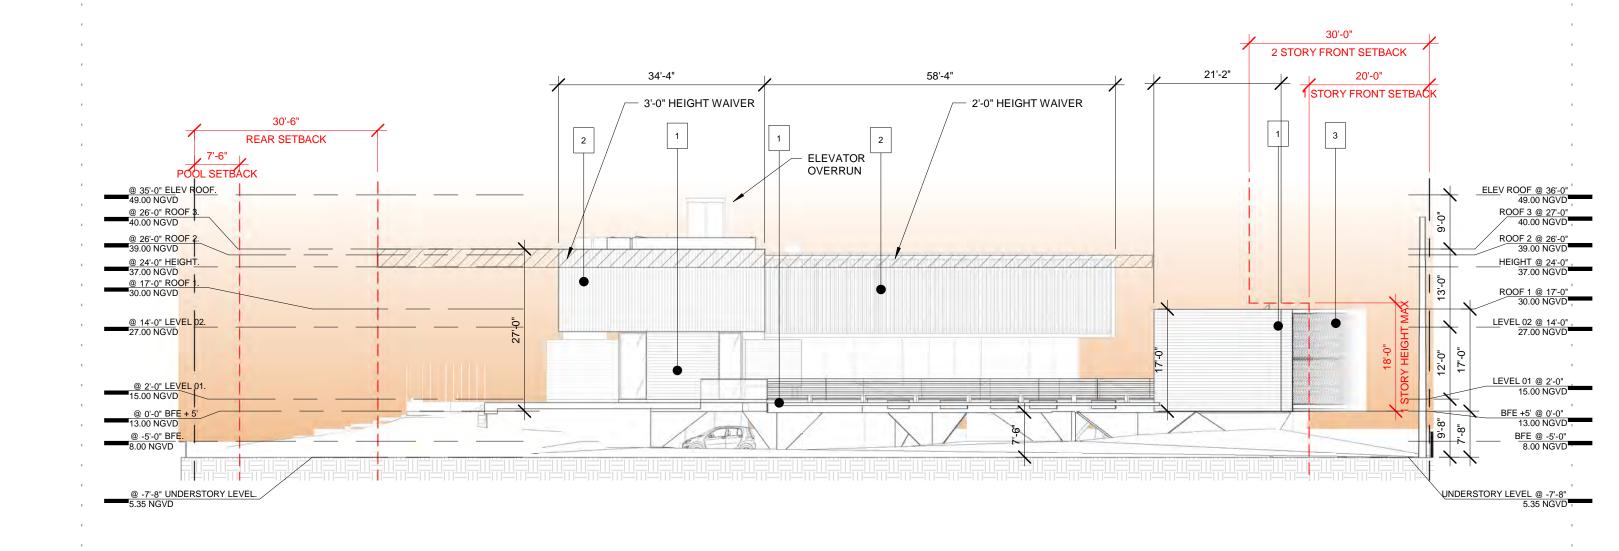





BOARD-FORMED CONCRETE




CHARRED WOOD




WOOD COLORED SCREEN



TRANSLUCENT GLASS

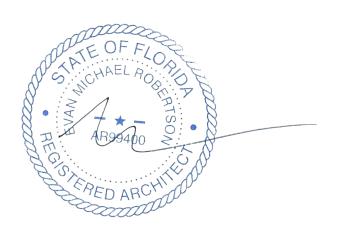

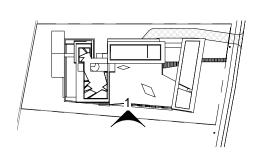

1804


DRAWING TITLE

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**DEVA FINGER** 4880 PINE TREE DR | MIAMI BEACH| FL | 33140 **PINE TREE** 

**SOUTH ELEVATION** 03.30.2020

1/16" = 1'-0"

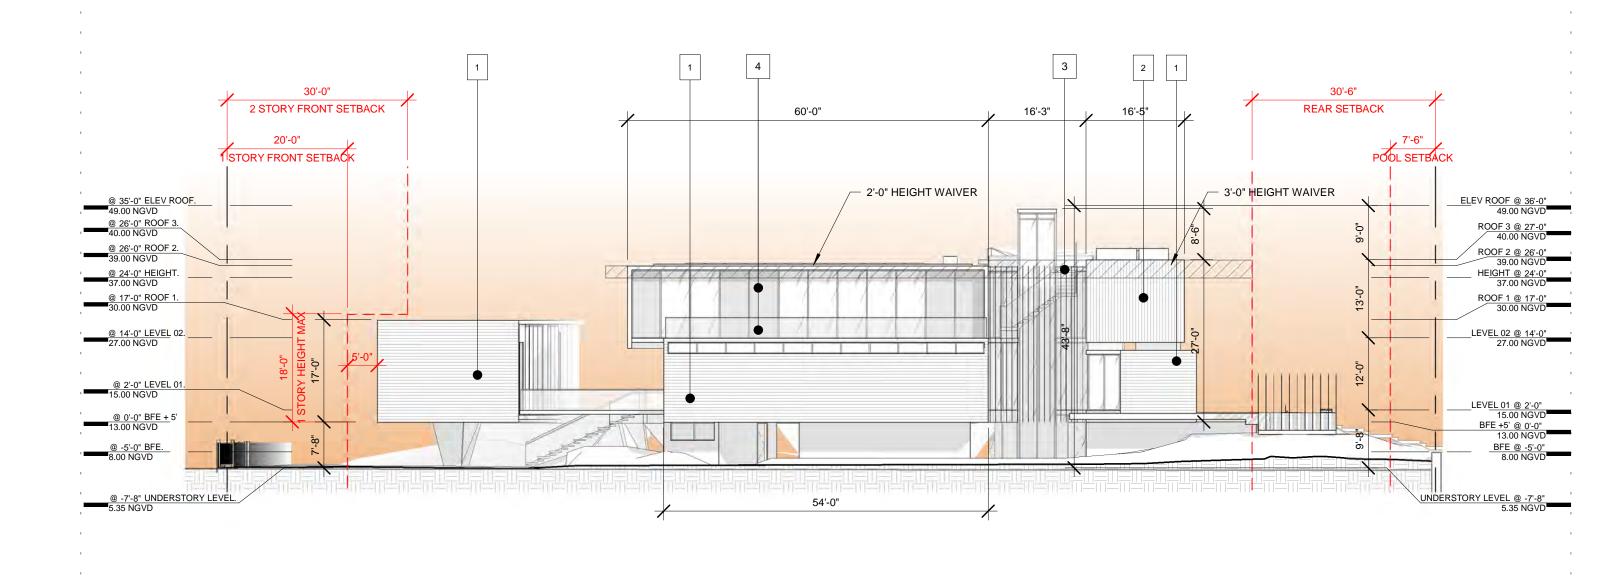

#### **MATERIALS LEGEND**




BOARD-FORMED CONCRETE





CHARRED WOOD



WOOD COLORED SCREEN

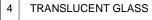

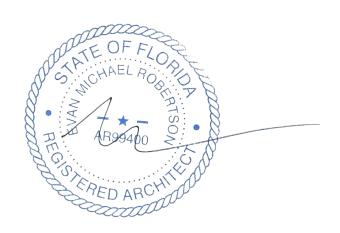

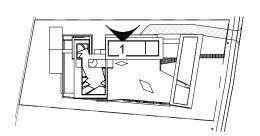

20

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CONSULTANT


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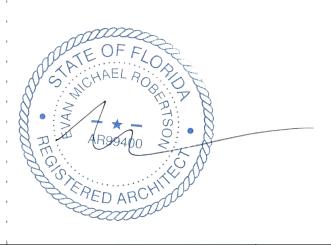
**DEVA FINGER** 

4880 PINE TREE DR | MIAMI BEACH| FL | 33140

**PINE TREE** 


NORTH ELEVATION 03.30.2020 1/16" = 1'-0"



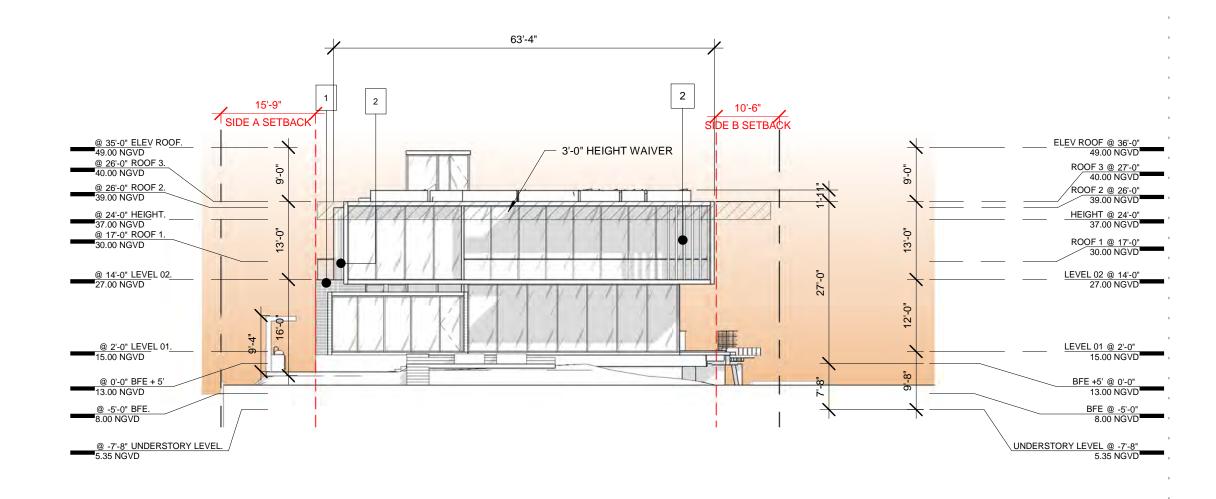

#### MATERIALS LEGEND

BOARD-FORMED CONCRETE CHARRED WOOD WOOD COLORED SCREEN TRANSLUCENT GLASS

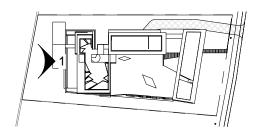

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CONSULTANT

DRAWING TITLE

03.30.2020

**DEVA FINGER** 

4880 PINE TREE DR | MIAMI BEACH| FL | 33140


**PINE TREE** 


**WEST ELEVATION** 

1/16" = 1'-0"

**A21** 


1804

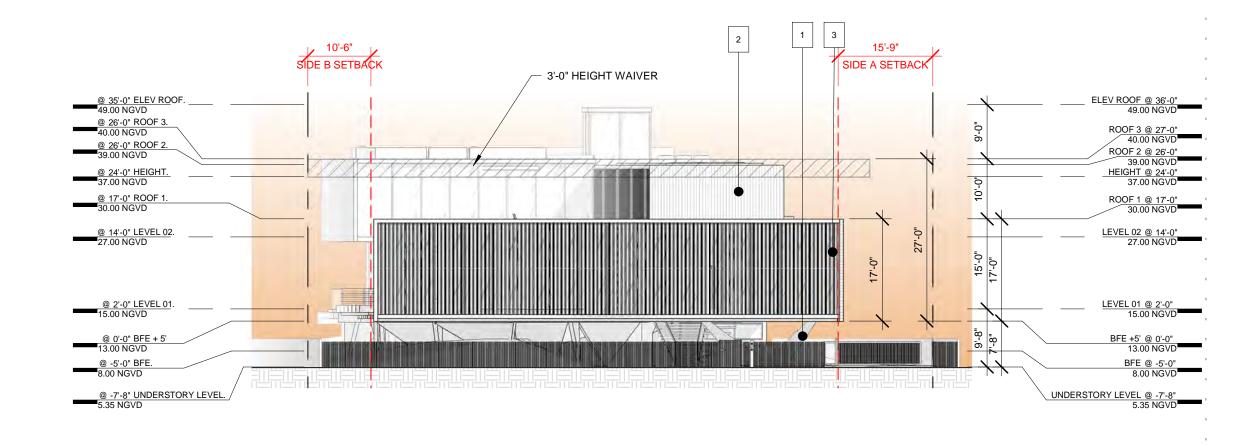

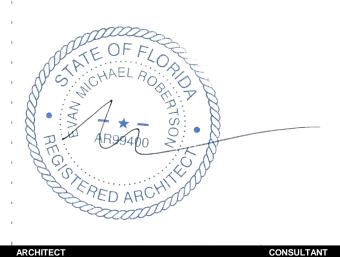

#### MATERIALS LEGEND



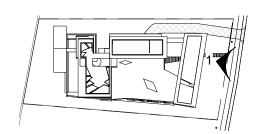

1804

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**DEVA FINGER** 4880 PINE TREE DR | MIAMI BEACH| FL | 33140 **PINE TREE** 


**EAST ELEVATION** 


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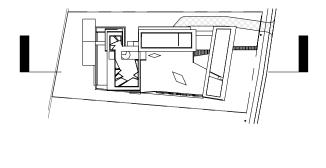
03.30.2020

**A22** 

1/16" = 1'-0"



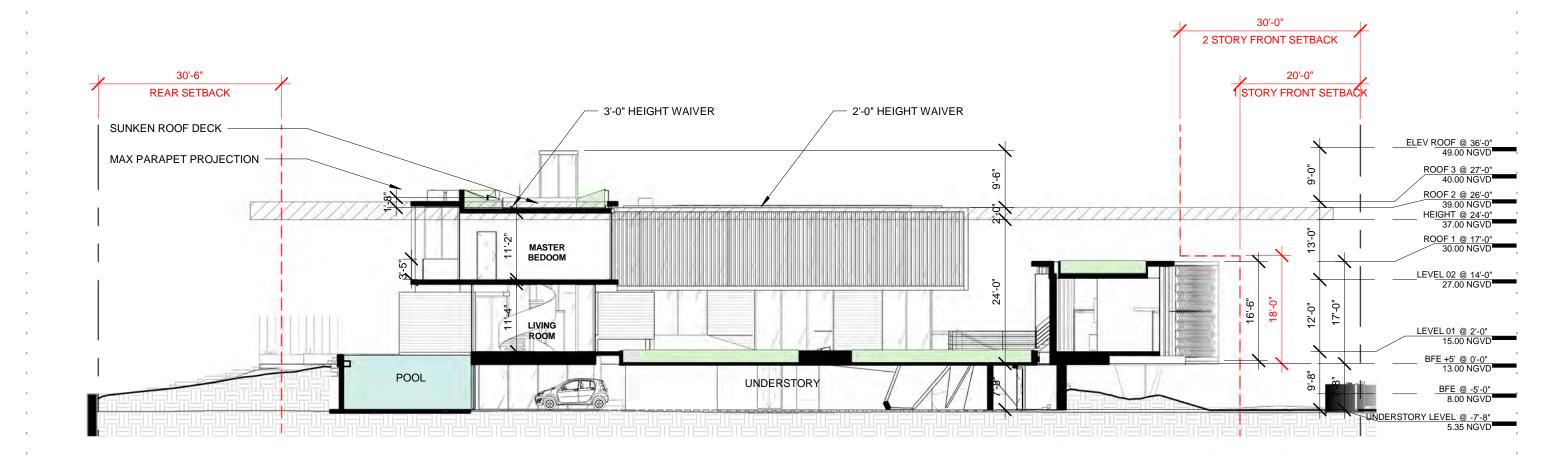

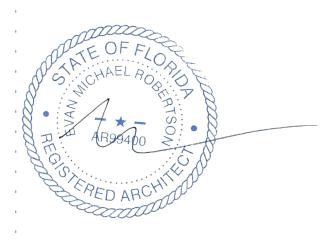

1804

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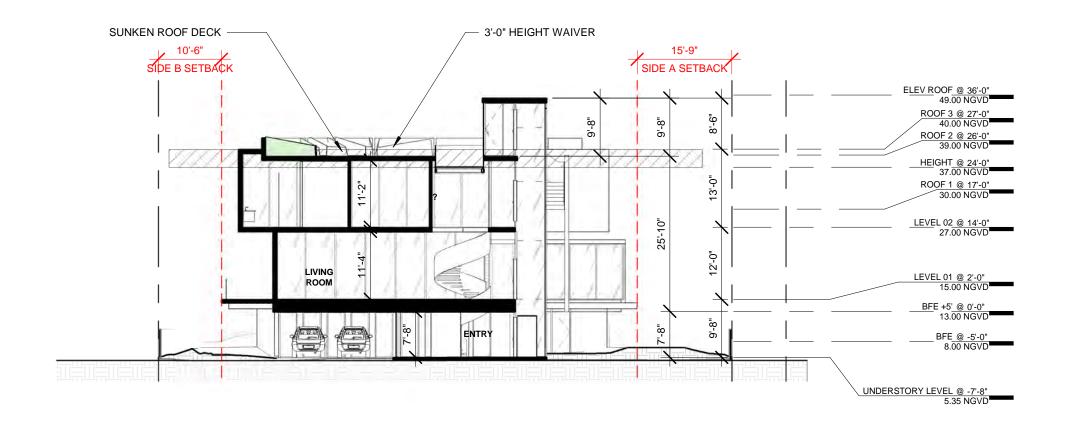
CONSULTANT


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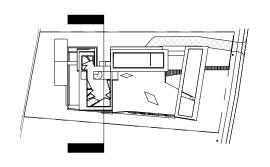
**SECTION A** 

**A23** 

**DEVA FINGER** 4880 PINE TREE DR | MIAMI BEACH| FL | 33140 **PINE TREE** 03.30.2020





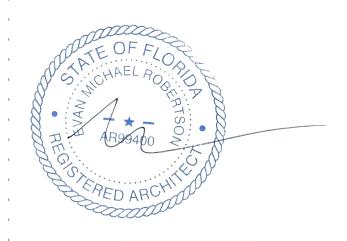

**DEVA FINGER** 


**PINE TREE** 


**SECTION B** 03.30.2020


DRAWING TITLE

**A24** 1804

4880 PINE TREE DR | MIAMI BEACH| FL | 33140

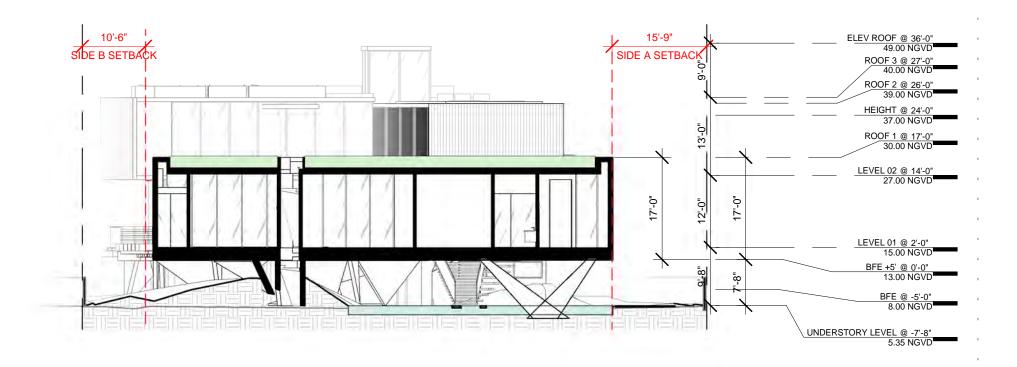

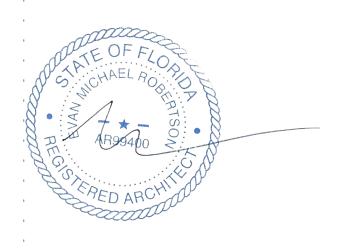

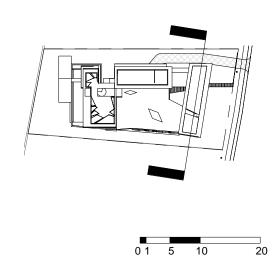

ARCHITECT CONSULTANT OWNER PROJECT DRAWING TITLE


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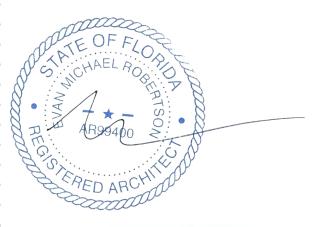
DEVA FINGER
4880 PINE TREE DR | MIAMI BEACH| FL | 33140


PROJECT DRAWING TITLE

SECTION C
03.30.2020 As indicated 1804

A25



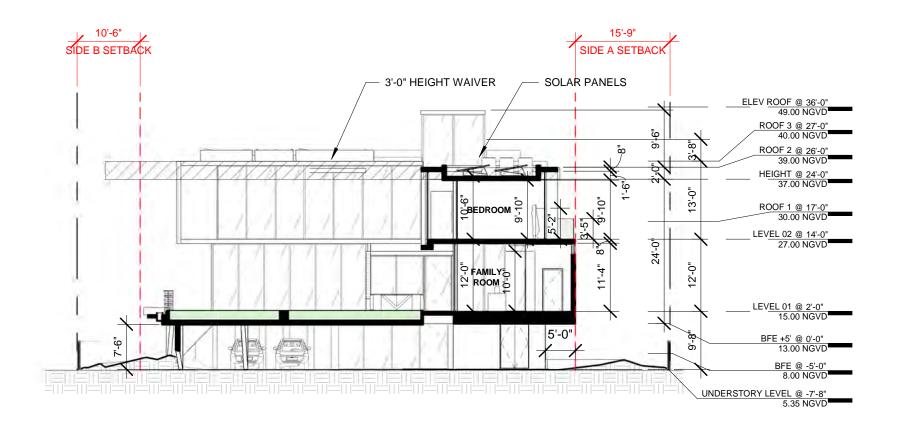

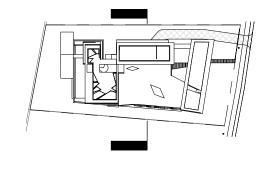

1804

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CONSULTANT


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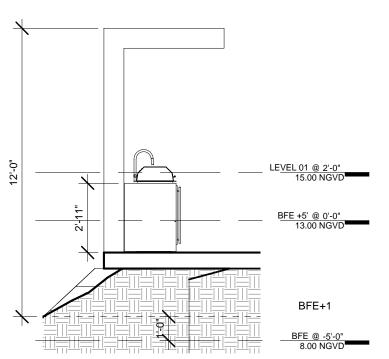
**DEVA FINGER** 


**PINE TREE** 

**SECTION D** 03.30.2020

1/16" = 1'-0"



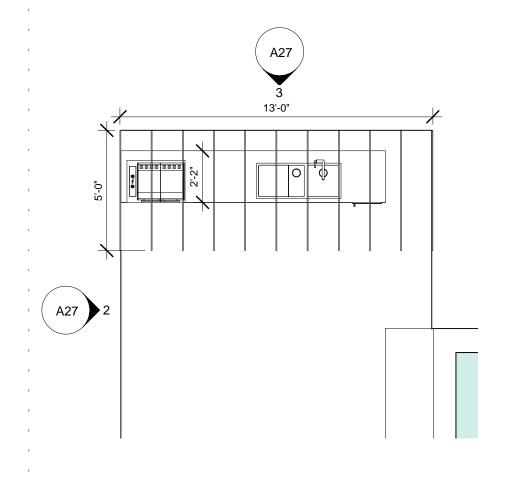

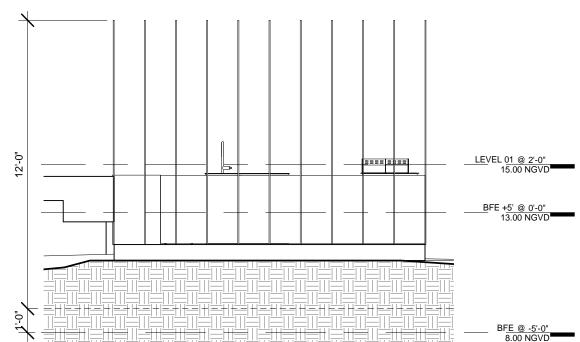




EXTERIOR COVER SIDE ELEVATION 1/4" = 1'-0" 2

 $\frac{\text{EXTERIOR COVER REAR ELEVATION}}{1/4" = 1' - 0"} 3$ 

1804

ARCHITECT CONSULTANT OWNER PROJECT DRAWING TITLE DRAWING #

MTTR MGMT 291 NE 61<sup>ST</sup> ST | MIAMI FL | 33137 www.ma77er.com

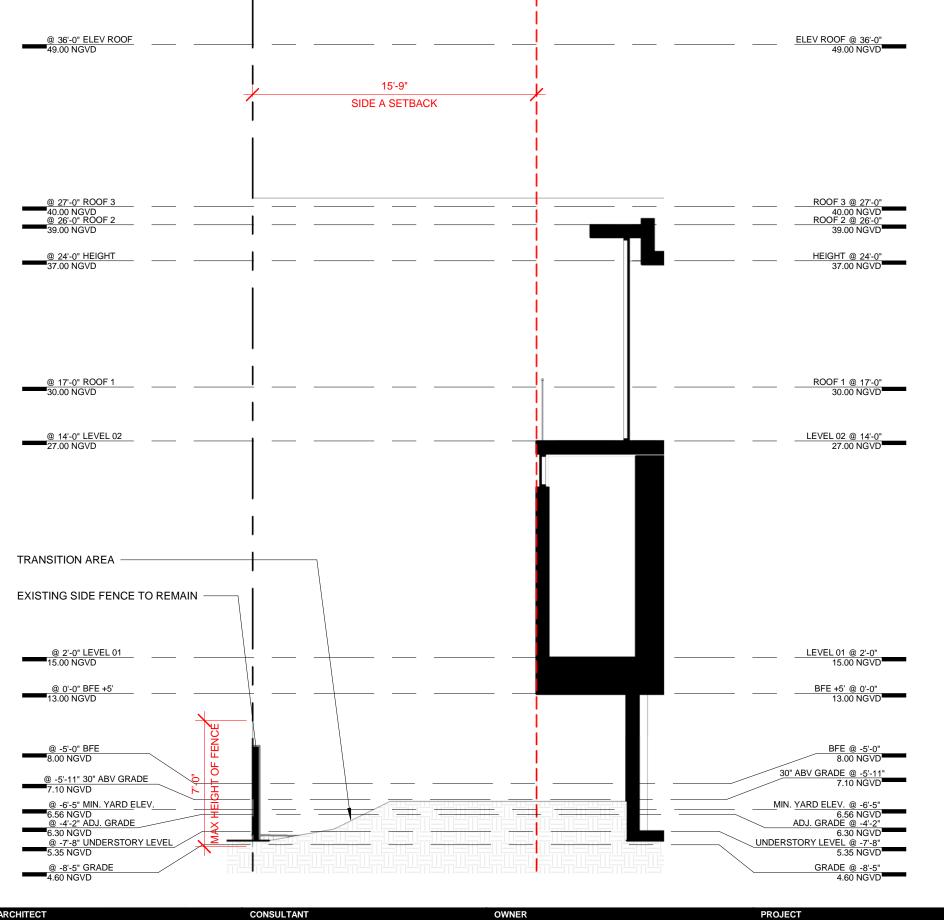

#### **DEFINITIONS**

**GRADE** MEANS THE CITY SIDEWALK ELEVATION AT THE CENTERLINE OF THE FRONT OF THE PROPERTY.

GRADE = 4.60 NGVD

**GRADE, ADJUSTED** MEANS THE MIDPOINT ELEVATION BETWEEN GRADE AND THE MINIMUM REQUIRED FLOOD ELEVATION FOR A LOT OR LOTS. (8.00-4.60)/2 +4.60 = 6.30

ADJUSTED GRADE = 6.30 NGVD

#### CODE

THE **MINIMUM ELEVATION** OF A REQUIRED YARD SHALL BE NO LESS THAN FIVE (5) FEET NAVD (6.56 FEET NGVD), WITH THE EXCEPTION OF DRIVEWAYS, WALKWAYS, TRANSITION AREAS, GREEN INFRASTRUCTURE (E.G., VEGETATED SWALES, PERMEABLE PAVEMENT, RAIN GARDENS, AND RAINWATER/STORMWATER CAPTURE AND INFILTRATION DEVICES), AND AREAS WHERE EXISTING LANDSCAPING IS TO BE PRESERVED, WHICH MAY HAVE A LOWER ELEVATION.


INTERIOR SIDE YARDS (LOCATED BETWEEN THE FRONT SETBACK LINE AND REAR PROPERTY LINE). THE MAXIMUM ELEVATION SHALL NOT EXCEED ADJUSTED GRADE, OR 30 INCHES ABOVE GRADE, WHICHEVER IS GREATER

WITHIN THE REQUIRED REAR OR SIDE YARD, FENCES, WALLS AND GATES SHALL NOT EXCEED **SEVEN FEET**, AS MEASURED FROM GRADE

CENTRAL AIR CONDITIONERS, EMERGENCY GENERATORS AND OTHER MECHANICAL EQUIPMENT. ACCESSORY CENTRAL AIR CONDITIONERS, GENERATORS AND ANY OTHER MECHANICAL EQUIPMENT, INCLUDING ATTACHED SCREENING ELEMENTS, MAY OCCUPY A REQUIRED SIDE OR REAR YARD, IN SINGLE-FAMILY, PROVIDED THAT:

(1)THEY ARE NOT CLOSER THAN  ${\bf FIVE}$   ${\bf FEET}$  TO A REAR OR INTERIOR SIDE LOT LINE

(2)THE MAXIMUM HEIGHT OF THE EQUIPMENT INCLUDING ATTACHED SCREENING ELEMENTS, SHALL NOT EXCEED FIVE FEET ABOVE CURRENT FLOOD ELEVATION, WITH A MAXIMUM HEIGHT NOT TO EXCEED TEN FEET ABOVE GRADE.

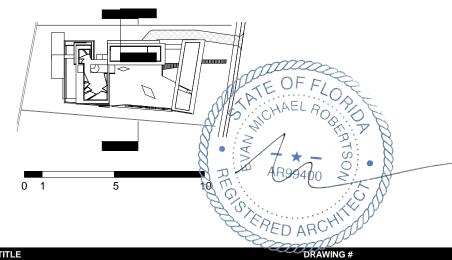

1804


ARCHITECT CONSULTANT OWNER PROJECT DRAWING TITLE DRAWING

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DEVA FINGER
4880 PINE TREE DR | MIAMI BEACH| FL | 33140

PINE TREE

SIDE YARD A SECTION

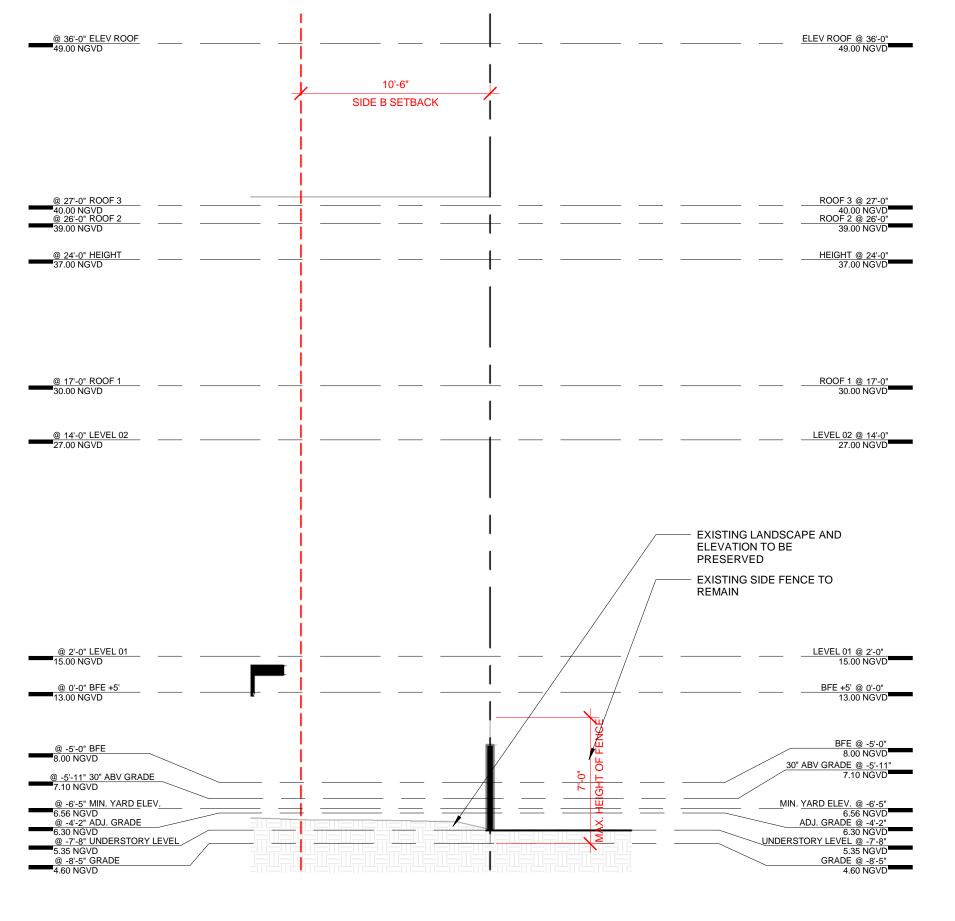

#### **DEFINITIONS**

**GRADE** MEANS THE CITY SIDEWALK ELEVATION AT THE CENTERLINE OF THE FRONT OF THE PROPERTY.

GRADE = 4.60 NGVD

**GRADE, ADJUSTED** MEANS THE MIDPOINT ELEVATION BETWEEN GRADE AND THE MINIMUM REQUIRED FLOOD ELEVATION FOR A LOT OR LOTS. (8.00-4.60)/2 +4.60 = 6.30


ADJUSTED GRADE = 6.30 NGVD

#### CODE

THE **MINIMUM ELEVATION** OF A REQUIRED YARD SHALL BE NO LESS THAN FIVE (5) FEET NAVD (6.56 FEET NGVD), WITH THE EXCEPTION OF DRIVEWAYS, WALKWAYS, TRANSITION AREAS, GREEN INFRASTRUCTURE (E.G., VEGETATED SWALES, PERMEABLE PAVEMENT, RAIN GARDENS, AND RAINWATER/STORMWATER CAPTURE AND INFILTRATION DEVICES), AND AREAS WHERE EXISTING LANDSCAPING IS TO BE PRESERVED, WHICH MAY HAVE A LOWER ELEVATION.

INTERIOR SIDE YARDS (LOCATED BETWEEN THE FRONT SETBACK LINE AND REAR PROPERTY LINE). THE MAXIMUM ELEVATION SHALL NOT EXCEED ADJUSTED GRADE, OR 30 INCHES ABOVE GRADE, WHICHEVER IS GREATER

WITHIN THE REQUIRED REAR OR SIDE YARD, FENCES, WALLS AND GATES SHALL NOT EXCEED **SEVEN FEET**, AS MEASURED FROM GRADE

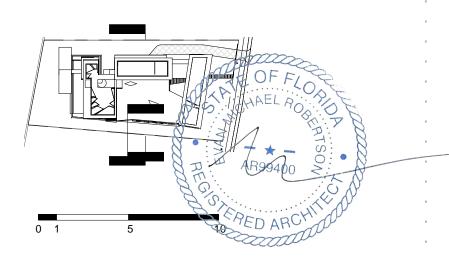

1804

ARCHITECT CONSULTANT OWNER PROJECT DRAWING TITLE DRAWING


MTTR MGMT 291 NE 61<sup>ST</sup> ST | MIAMI FL | 33137 www.ma77er.com


DEVA FINGER
4880 PINE TREE DR | MIAMI BEACH| FL | 33140

PINE TREE

SIDE YARD B SECTION

03.30.2020 3/16" = 1'-0"

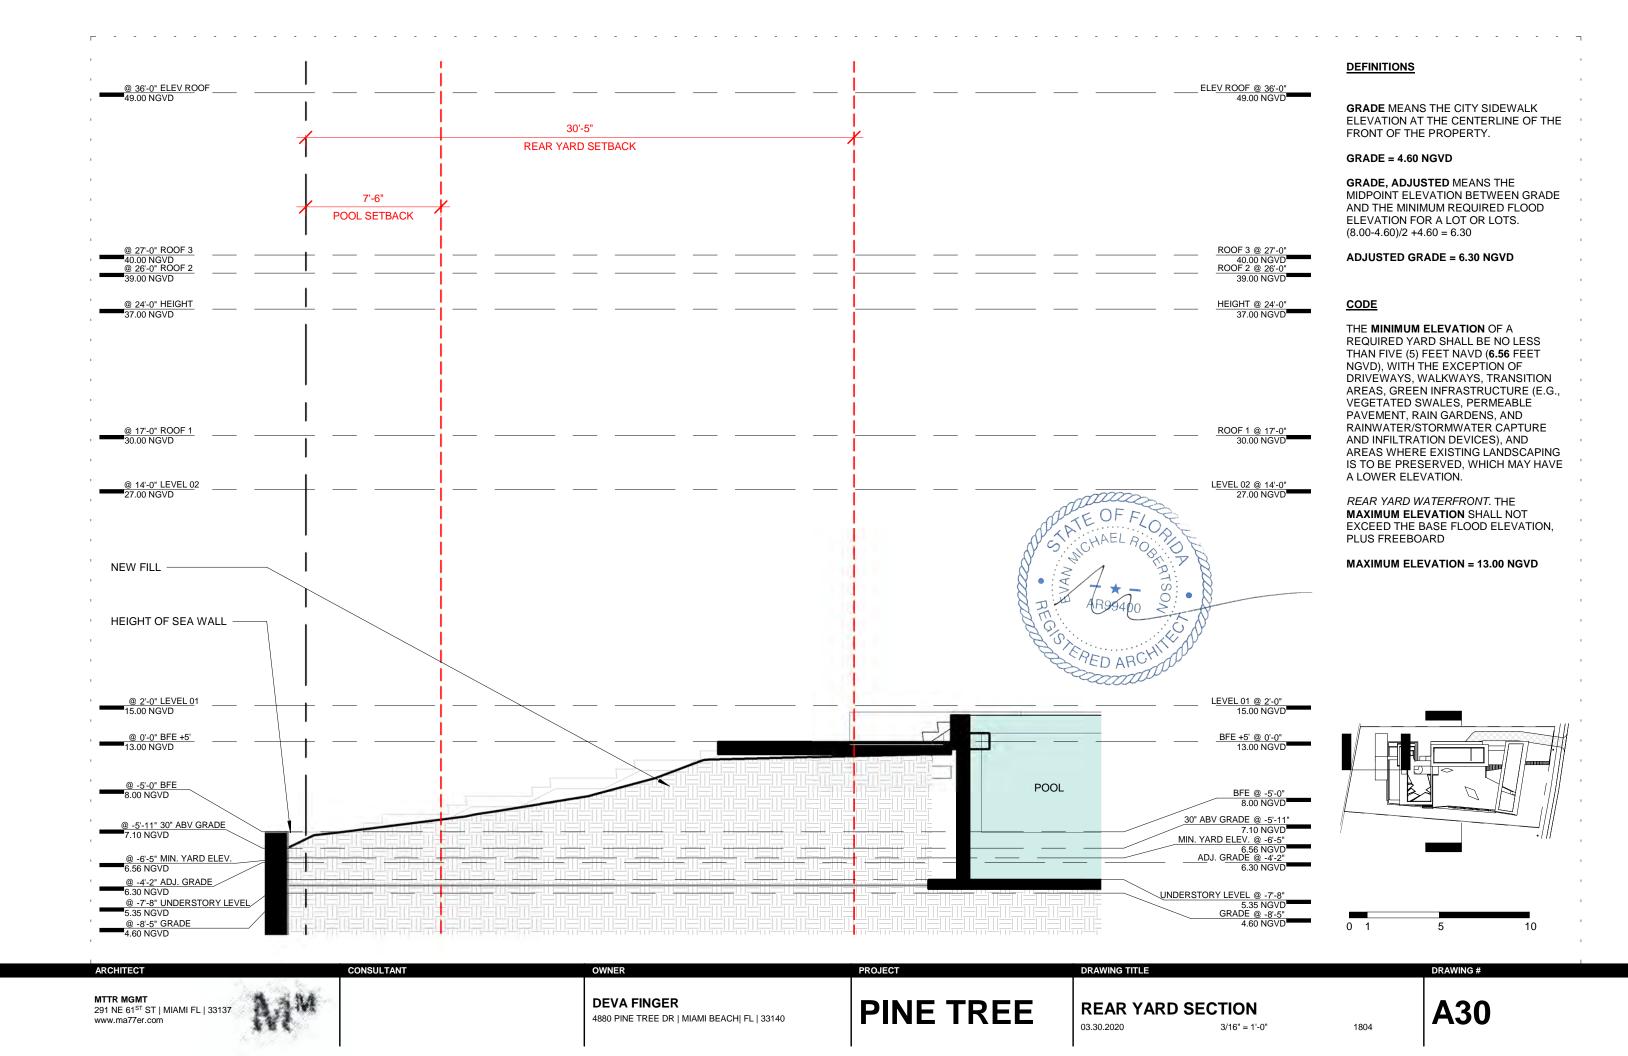

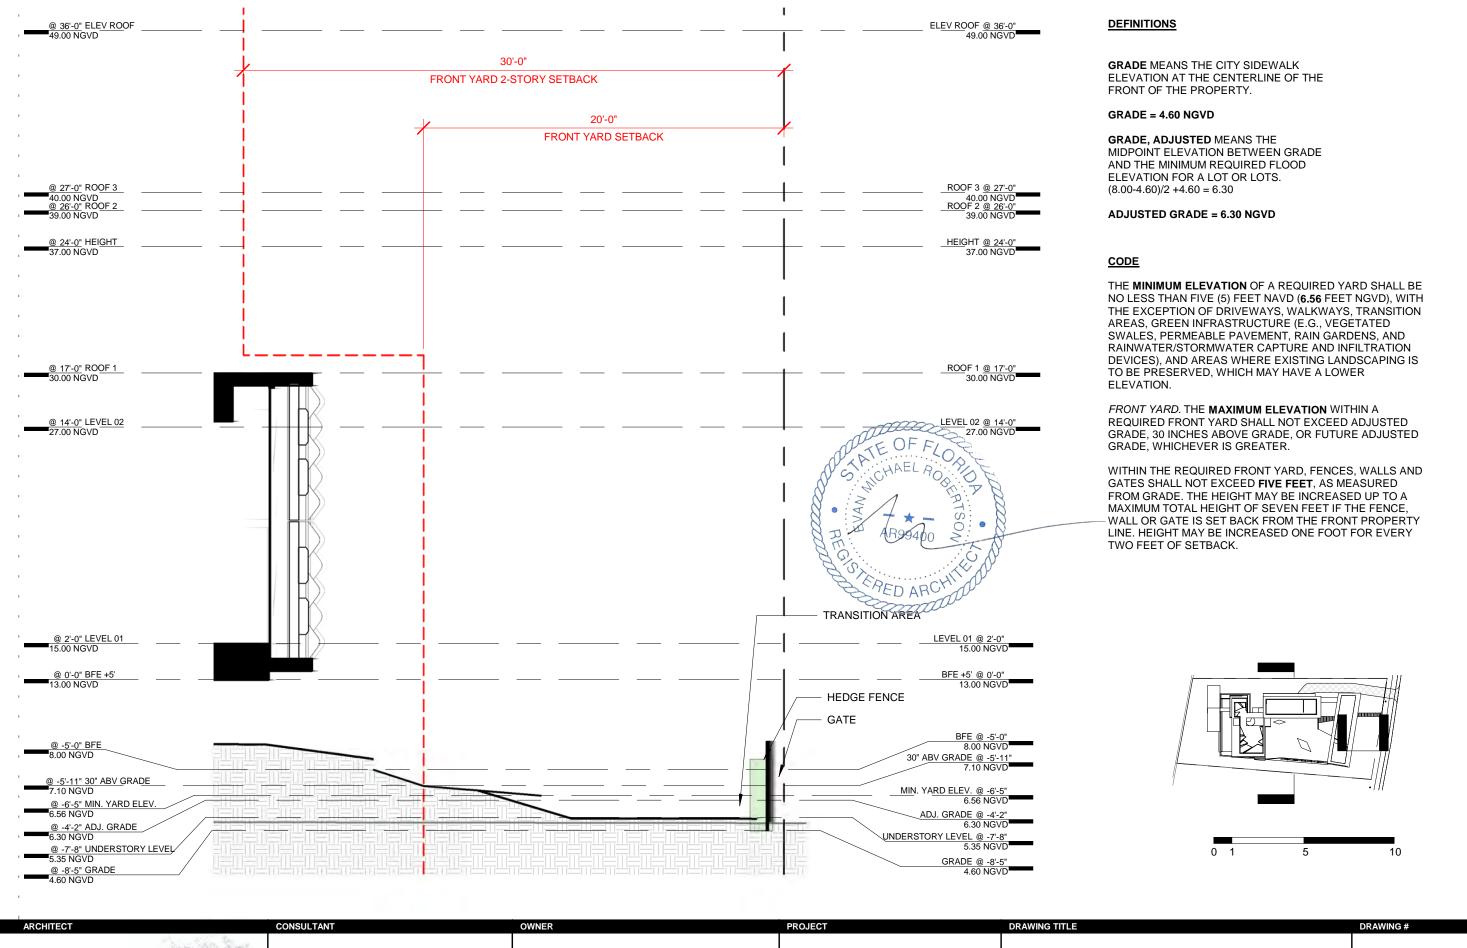



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 DEVA FINGER
 4880 PINE TREE DR | MIAMI BEACH| FL | 33140
 FRONT YARD SECTION

 03.30.2020
 3/16" = 1'-0"
 1804




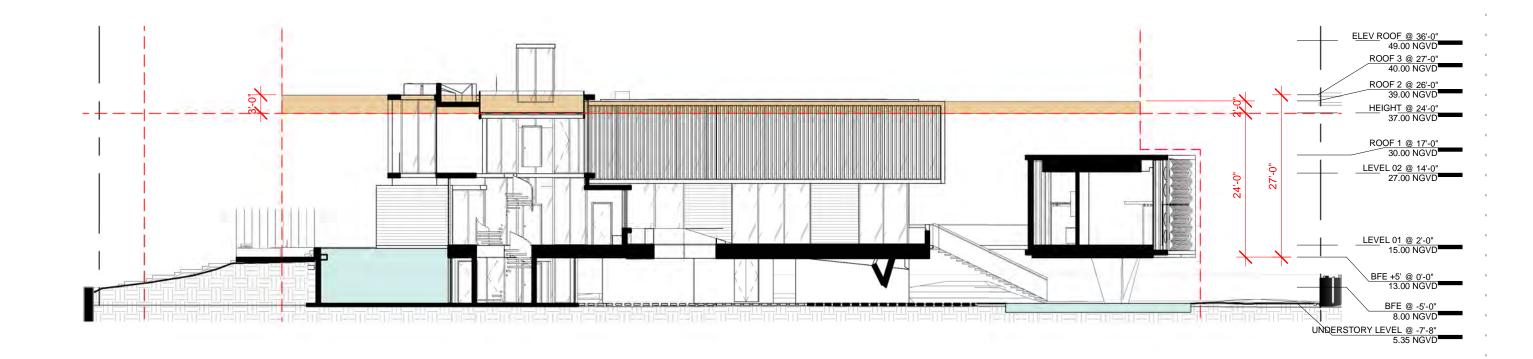


CONSULTANT DRAWING TITLE DRAWING # **DEVA FINGER** 

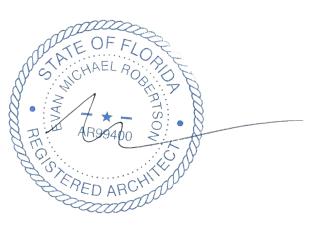
MTTR MGMT 291 NE 61<sup>ST</sup> ST | MIAMI FL | 33137 www.ma77er.com

1804

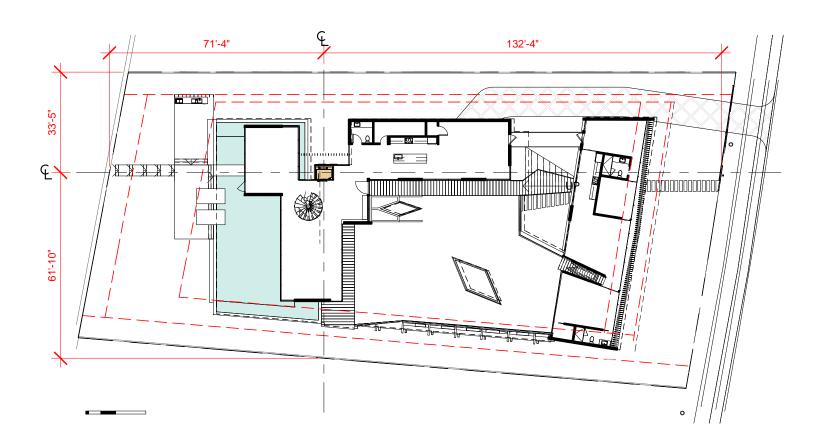

# **FIRST FLOOR - ELEVATOR LOCATION**

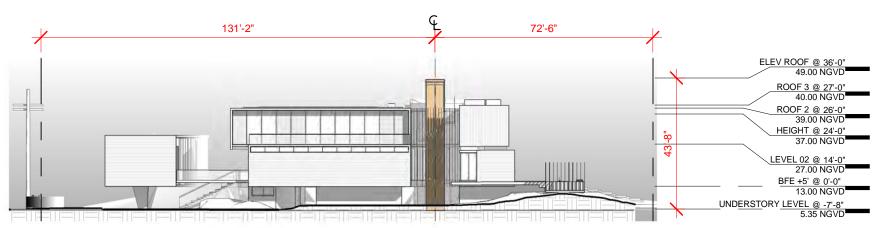

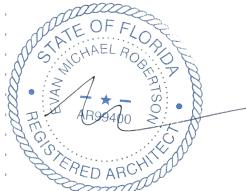

# **NORTH ELEVATION - ELEVATOR LOCATION**

ARCHITECT CONSULTANT OWNER PROJECT DRAWING TITLE DRAWING #


MTTR MGMT
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DEVA FINGER
4880 PINE TREE DR | MIAMI BEACH| FL | 33140

PROJECT DRAWING TITLE

WAIVER DIAGRAM - ELEVATOR
LOCATION
1/32" = 1'-0"
1804

A33

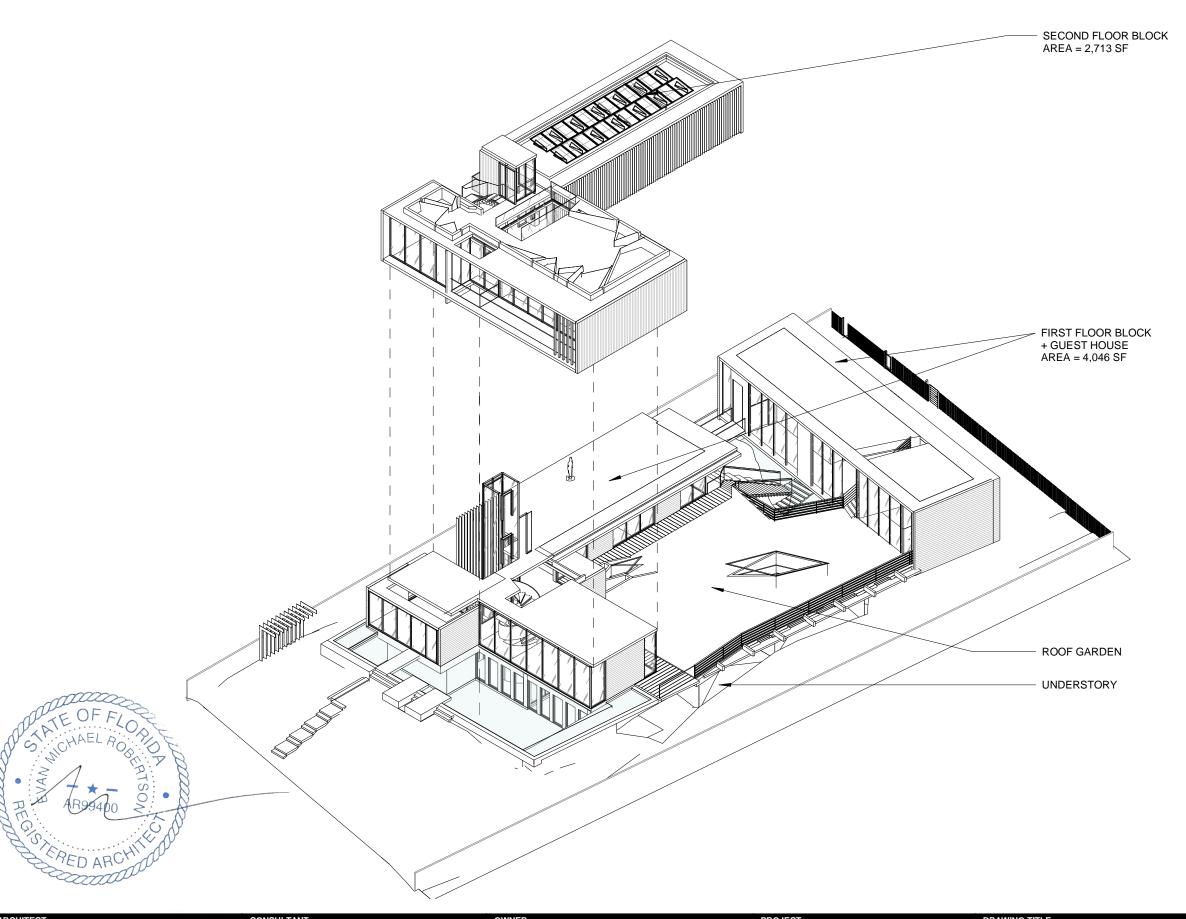

ARCHITECT CONSULTANT OWNER PROJECT DRAWING TITLE DRAWING #

MTTR MGMT 291 NE 61<sup>ST</sup> ST | MIAMI FL | 33137 www.ma77er.com





CHARRED WOOD TEAK WOOD SCREEN





TRANSLUCENT GLASS

BOARD-FORMED CONCRETE


MTTR MGMT 291 NE 61<sup>ST</sup> ST | MIAMI FL | 33137 www.ma77er.com


**DEVA FINGER** 4880 PINE TREE DR | MIAMI BEACH| FL | 33140 **PINE TREE** 

**MATERIAL PALETTE** 





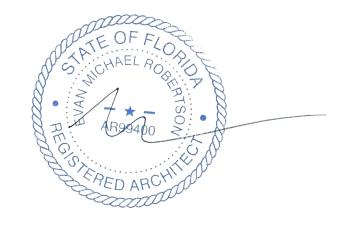

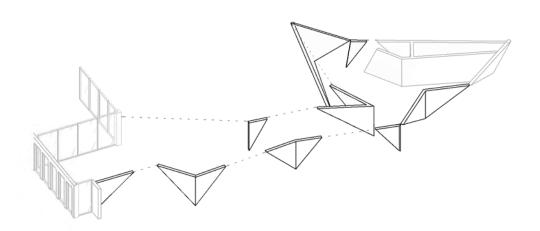

**OUTDOOR WORKOUT AREA** 

**OUTDOOR WORKOUT AREA** 

ALLOWED

PROVIDED

50% OF WORKOUT AREA 1769 SF X 50% = 884 SF

OPEN AREA 1160 SF (66%)

1804

MTTR MGMT 291 NE 61<sup>ST</sup> ST | MIAMI FL | 33137 www.ma77er.com


**DEVA FINGER** 4880 PINE TREE DR | MIAMI BEACH| FL | 33140 **PINE TREE** 

**OUTDOOR WORKOUT AREA** 

**A36** 

03.30.2020

3/32" = 1'-0"

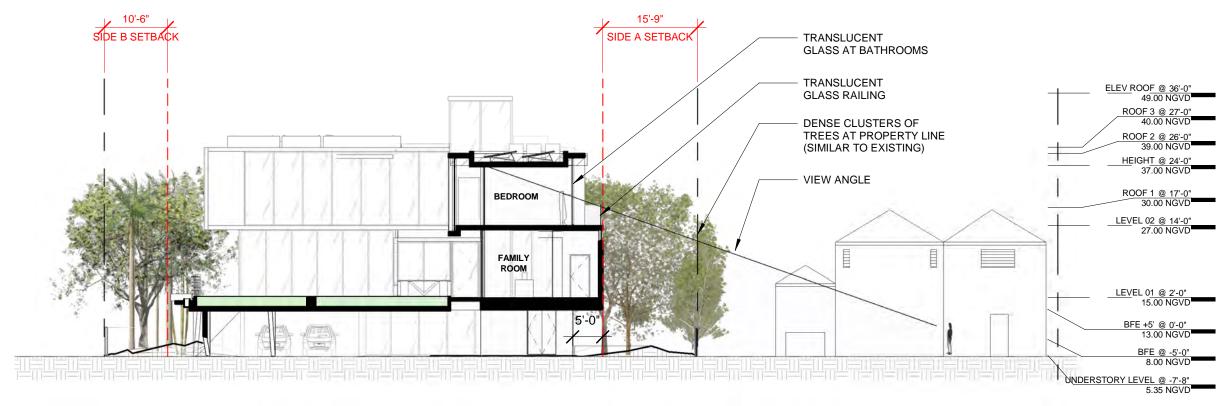


### **SECTION W NEIGHBOR**







TRANSLUCENT GLASS

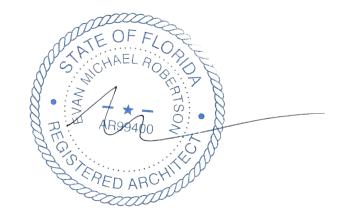


ARCHITECT DRAWING TITLE

291 NE 61<sup>ST</sup> ST | MIAMI FL | 33137 www.ma77er.com


**DEVA FINGER** 4880 PINE TREE DR | MIAMI BEACH| FL | 33140 **PINE TREE** 

**NORTH PRIVACY** 03.30.2020 1/16" = 1'-0"



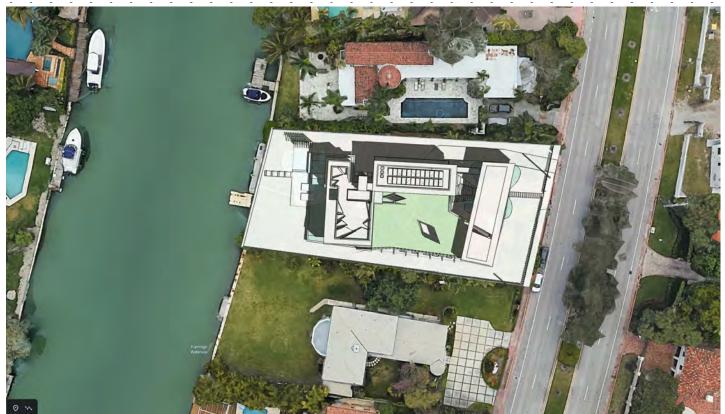

1 - FEBRUARY 3RD 2 - MARCH 21ST

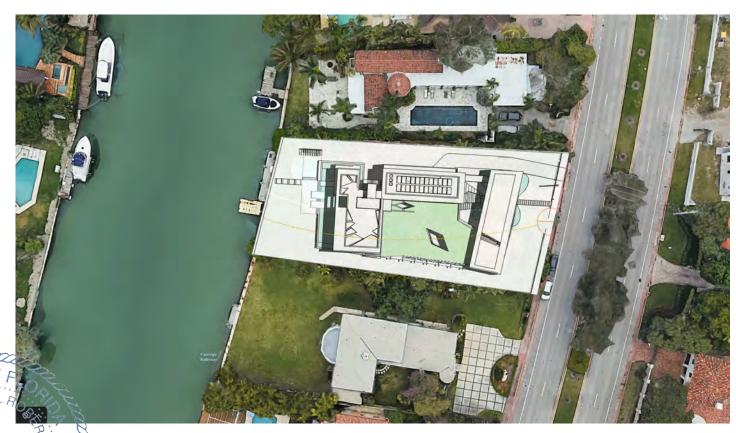



3 - JUNE 21ST 4 - DECEMBER 21ST

**SUN STUDY** 

**PINE TREE** 03.30.2020 **A38** 

MTTR MGMT
PE 291 NEGAT STIMIAMI FL | 33137

**DEVA FINGER** 4880 PINE TREE DR | MIAMI BEACH| FL | 33140















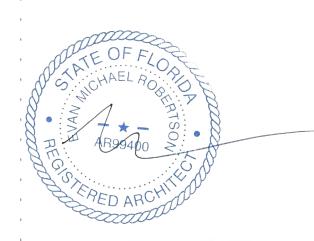

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**DEVA FINGER** 4880 PINE TREE DR | MIAMI BEACH| FL | 33140 PINE TREE

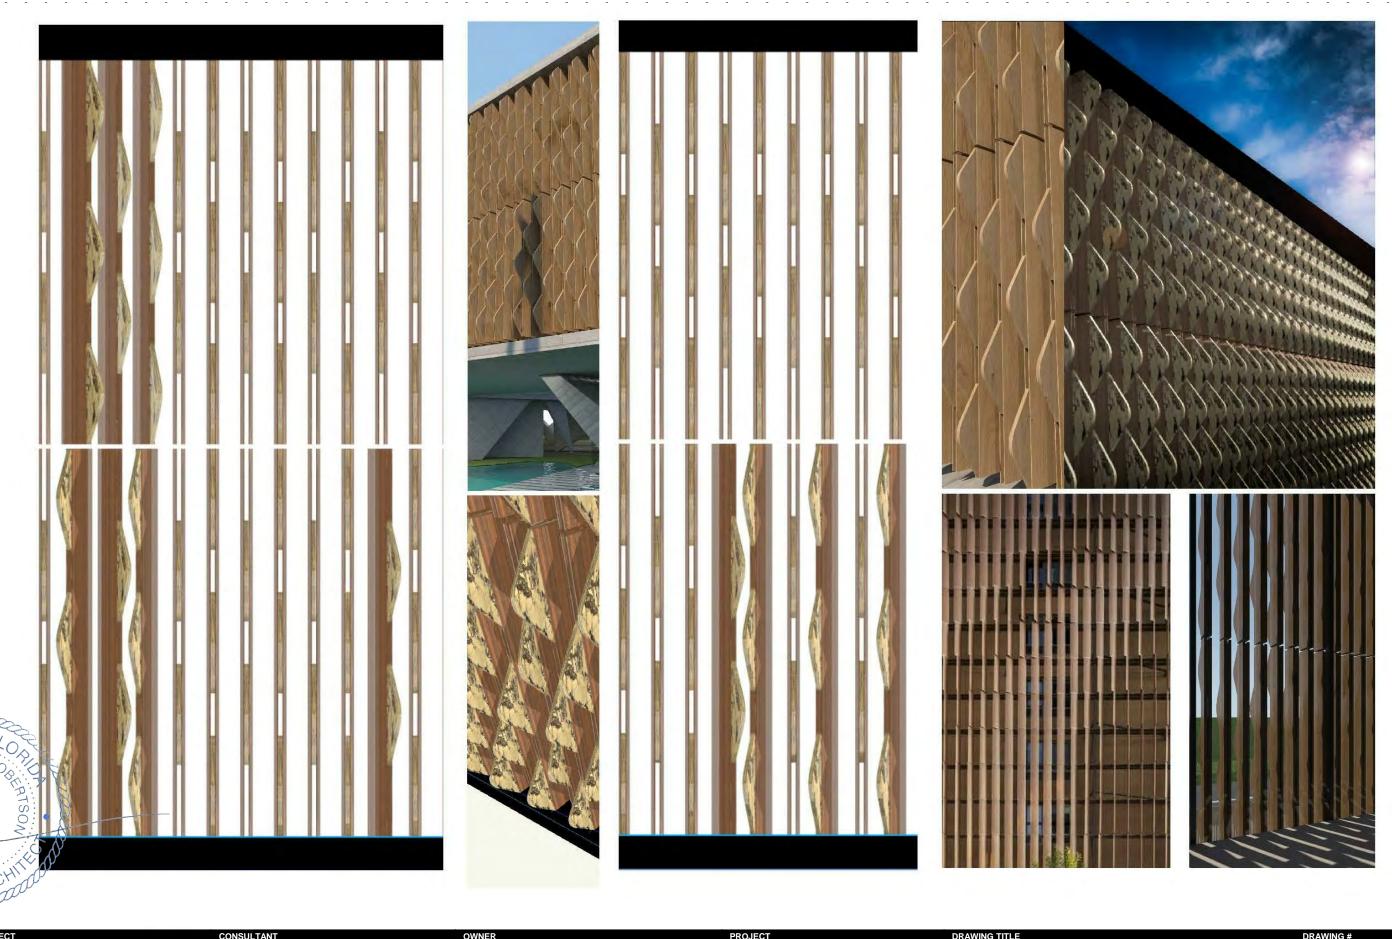

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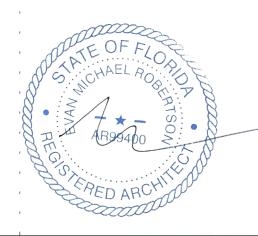
DEVA FINGER
4880 PINE TREE DR | MIAMI BEACH| FL | 33140

PINE TREE

DYNAMIC SCREEN W/ INDIVIDUAL ROTATING ELEMENTS







**DEVA FINGER** 4880 PINE TREE DR | MIAMI BEACH| FL | 33140 **PINE TREE** 









ARCHITECT CONSULTANT OWNER PROJECT DRAWING TITLE DRAWING

# **4880 PINE TREE DRIVE**

LANDSCAPE SET

CONTINUANCE SUBMITTAL

MARCH 9, 2020



### LANDSCAPE DRAWING LIST

L0	TITLE SHEET
L1	TREE SURVEY 1 OF 2
L2	TREE SURVEY 2 OF 2
L3	LANDSCAPE PLAN
L4	LANDSCAPE PLAN FOR UNDERSTOR'
L5	LANDSCAPE LEGEND
L6	TREE DISPOSITION PLAN

EXHIBIT - ARBORIST REPORT



AFA & COMPANY, INC.
PROFESSIONAL LAND SURVEYORS AND MAPPERS FLORIDA CERTIFICATE OF AUTHORIZATION No. 1B 7498 13050 SW 133RD COURT MIAMI, FLORIDA 33186 E-MAIL: AFACO@BELLSOUTHNET PH: 305-234-0588 FX: 206-495-0778

1 Queen Palm D-0.70', H-20', SP-10' 2 Christmas Palm D-0.80', H-20, SP-8 3. Ousen Palm D-0.35', H-10', SP-5 4. Palm D-0.70', H-20', SP-8' 5. Palm D-0.80', H-25', SP-15' 6 Palm D=0.80' H=25' SP=15 7. Palm D=0.80', H=25', SP=15' 8. Palm D=0.80', H=25', SP=15' 9 Palm D-080', H-25', 5P-15 10. Ficus D=0.85', H=30', SP=20' 11. Queen Palm D=0.85', H=30', SP=20' 12. Ficus D=0.80', H=25', SP=20' 13. Ficus D=0.80', H=25', SP=20' 14. Christmas Palm D=10', H=20', SP=15 15. Christmas Palm D-0.60', H-10', SP-10 16. Queen Palm D-0.40', H-10', SP-10' 17. Ficus D-0.50', H-20', SP-10' 18. Coconut Palm D-11', H-35', SP-20' 19. Queen Palm D-0.35', H-10', SP-10' 20. Christmas Palm D=0.70', H=25', SP=10' 21. Christmas Palm D=0.80', H=25', SP=10' 22. Christmas Palm D=0.40′, H=20′, SP=10′ 23. Christmas Palm D=0.40′, H=20′, SP=10′ 24. Christmas Palm D=0.80′, H=35′, SP=20′ 24. Christmas Palm D-0.80', H-35', SP-20' 25. Christmas Palm D-0.80', H-35', SP-20' 27. Christmas Palm D-0.80', H-35', SP-20' 28. Christmas Palm D-0.80', H-35', SP-20' 29 Civistresa Palm D-080' H-35' SP-20 30. Christmas Pain D-0.80', H-35', SP-20' 31 Figus D-13', H-15', SP-15' 32. Ficus D=2.3', H=25', 8P=20' 33. Ficus D=4.0', H=35', 5P=35' 34. Ficus D=0.55', H=20', 8P=10' 35. Christmas Palm D=0.85, H=20', SP=15' 36. Oueen Palm D=10', H=25', SP=15' 37. Figus D=0.70', H=20', SP=15' 38. Christmas Palm D-0.70', H-20', SP-12' 39. Christmas Palm D-0.60', H-15', SP-12' 40. Ficus D-11', H-20', SP-10' 41. Ficus D-11', H-20', SP-10' 42. Christmas Palm D-0.70', H-30', SP-15' 44. Queen Palm D=0.35', H=10', SP=5' 45. Christmas Palm D-0.60', H-30', 5P-10'

TREE LEGEND:

46. Christmas Palm D=0.70', H=30', SP=15' 47. Christmas Palm D=0.70', H=20', SP=10' 48 Chrisimaa Palm D-0.70', H-20', SP-10 49. Queen Palm D=035', H=10', SP=8' 50. Ficus D=0.70', H=15', SP=10' 51. Christmas Palm D=0.50', H=25', SP=10' 52. Christmas Palm D=0.50', H=25', SP=10' 53. Christmas Palm D-0.50′, H-25′, SP-10′ 54. Christmas Palm D-0.50′, H-25′, SP-10′ 55. Christmas Palm D-0.50′, H-25′, SP-10′ 56. Christmas Palm D-0.50', H-25', SP-10' 57. Christmas Palm D-0.50', H-25', SP-10' 58. Christmas Paim D-0.50°, H-25°, SP-10° 59. Christmas Paim D-0.50°, H-25°, SP-10° 60. Christmas Paim D-0.50°, H-25°, SP-10° 61. Christmas Palm D-0.50', H-25', SP-10' 62. Coconut Palm D-10', H-25', SP-15' 63. Avocado D-0.70', H-25', SP-20' 64. Queen Palm D-0.80', H-25', SP-20' 65. Queen Palm D-0.80', H-25', SP-20' 66. Coconut Palm D=10', H=35', 8P=20' 67. Coconut Palm D=10', H=35', SP=20' 68. Ficus D=0.40', H=20', SP=15' 69. Christmas Palm D=0.35', H=25', SP=10' 70. Ricus D=10', H=30', SP=10' 71. Coconut Palm D=0.70', H=35', SP=25' 72. Christmas Palm D=0.80', H=25', SP=10' 73 Christmas Paim D=0.80' H=25' SP=10' 75. Christmas Palm D-0.25', H-25', SP-8' 76. Christmas Palm D-0.60', H-25', SP-8' 77. Christmas Palm D-0.60', H-25', SP-8' 77. Christmas Patin D-0.60', H-25', SP-6'
79. Christmas Patin D-0.60', H-15', SP-6'
80. Mango D-0.70', H-15', SP-6'
81. Christmas Patin D-0.60', H-20', SP-8'
82. Christmas Patin D-0.60', H-20', SP-6'
83. Lemon D-0.40', H-10', SP-10' 84. Christmas Palm D=0.60', H=20', SP=10' 85. Christmas Palm D=0.60', H=30', SP=20' 86. Christmas Palm D-0.60', H-15', SP-10' 87. Ficus D-0.50', H-15', SP-10' 88. Ficus D-0.50', H-15', SP-10' 89. Ficua D=0.50', H=15', SP=10'

# **Property Information**

#### PROPERTY ADDRESS:

4880 Pine Tree Drive Miami Beach, Florida 33140

#### CERTIFIED ONLY TO:

Deva Finger

#### LEGAL DESCRIPTION:

Lots 24 and 25, Less the Southerly 1/2 of Lot 24, Block 32, of: "LAKE VIEW SUBDIVISION", according to the Plat Thereof as Recorded in Plat Book 14, Page 42, of the Public Records of Miami-Dade County, Florida.

#### **ELEVATION INFORMATION** National Flood Insurance Program FEMA Elev. Reference to NGVD 1929

Comm Panel 120651 Panel # 0309 "AE" Firm Zone: Date of Firm: 09-11-2009 Base Flood Elev. 8.00' F.Floor Elev. 6.52 5.06 Garage Elev.  $^{\prime\prime}L^{\prime\prime}$ Suffix:

Elev. Reference to NGVD 1929

JOB#	19-1223
DATE	11-08-2019
PB	14-42

#### Surveyors Notes:

- #I Land Shown Hereon were not abstracted for Fasement and for Right of Way Records. The Easement / Right of Way Show on Survey are as per plat of record unless otherewise noted. #2 Benchmark: Miami-Dade County Public Works Dep.
- #3 Bearings as Shown hereon are Based upon West 47th Street, N90°00'00"E #4 Please See Abbreviations
- #5 Drawn By: A. Torres
- #6 Date: 7-26-18; 10-5-18; 11-8-19
- #7 Completed Survey Field Date: 7-25-18; 10-1-18; 11-8-19 #8 Disc No 2019, Station Surveying Scion
- #9 Last Revised
- #10 Zoned Building setback line not determined

#### Surveyor's Notes:

- #11 The herein captioned Property was surveyed and described based on the Legal Description Provided by Client. #12 This Certification is Only for the lands as Described, it is not a
- certification of Title, Zoning, Easements, or Freedom of encumbrances. ABSTRACT NOT REVIEWED.
- #13 There may be additional Restrictions not Shown on this survey that may be found in the Public Records of Said County Examination of ABSTRACT OF TITLE will have to be made to determine recorded instruments, if any affecting this property. #14 Accuracy:
- The expected use of land, as classified in the Standards of Practice (5J-17.052), is residential. The minimum relative distance accuracy for this type of boundary survey is 1.0 foot in 10,000.00' feet, the accuracy obtained by measurement and calculation of a closed geometric figure was found to exceed
- #15 Foundation and / or footing that may cross beyond the boundary lines of the parcel herein described are not shown hereon.
- #16 Not valid without the signature and original seal of a Florida Licensed Surveyor and Mapper, additions or deletions to survey maps or reports by other than the signing party or parties.
- #17 Contact the appropriate authority prior to any design work on the herein described parcel for building and zoning information. #18 Underground Utilities are not depicted hereon, contact the appropriate authority prior to any design work or construction
- on the property herein described. Surveyor shall be notified as to any deviation from utilities shown hereon. #19 Ownership subject to Opinion of Title.

Company, Inc. Land

Professional Surveyors & Mappers LB 7498 13050 S.W. 133rd Court Miami Florida, 33186 E-mail: afaco@bellsouth.net Ph: (305) 234-0588 Fax: (206) 495-0778

This certifies that the survey of the property described hereon was made under my super vision & that the survey meets the Standards of Practice set forth by the Florida Board of Professional Land Surveyors & Mappers in Chapter 5J-17.052 of Florida Administrative Code, pursuant to Section 472.027, Florida Statutes. & That the Sketch hereon is a true and accurate representation thereof to the best of my knowledge and Belief, subject to notes

nal Surveyor & Mapper #5526 State of Florida Not Valid unless Signed & Stamped with Embossed Seal

Biscayne Bay West 47th Street

Location Sketch

291 NE 61ST ST | MIAMI FL | 33137

www.ma77er.com

LANDSCAPE ARCHITECT BRUCE E. CUMMINGS P.A. LAUDERDALE-BY-THE-SEA, FL 954/771-8184

4880 PINE TREE DR | MIAMI BEACH| FL | 33140

**DEVA FINGER** 

**PINE TREE** 

TREE SURVEY 1 OF 2

DRAWING #

03 30 2020

1804

#### Sheet 2 of 2

# Boundary Survey

Graphic Scale 1" = 20'



#### Abbreviations of Legend

A	=ARC DISTANCE
AVE	=AVENUE
ASPH	=ASPHALT
A/W	=ANCHORD WIRE
A/C	=AIR CONDITIONER
BLDG	=BUILDING
B. COR	=BLOCK CORNER
C.B.	=CATCH BASIN
CLF	=CHAIN LINK FENCE
CONC.	=CONCRETE
COL.	=COLUMN
C.U.P.	=CONCRETE UTILITY POLE
C.L.P.	=CONCRETE LIGHT POLE
CBS	=CONCRETE BLOCK
	STRUCTURE
C.M.E.	=CANAL MAINTENANCE

	EASEMENT
D	=DIRECTION
D/W	=DRIVEWAY
D.ME.	=DRAINAGE & MAINTENANCE
	EA SEMEN T
ENC.	=ENCROACHMENT
E.T.P.	=ELECTRIC TRANSFORMER PAD
F.P.L.	=FLORIDA POWER AND LIGHT
F.H.	=FIRE HYDRANT
FIP.	=FOUND IRON PIPE
F.F.	=FINISH FLOOR
DH/F	=FOUND DRILL HOLE
F.R.	=FOUND REBAR
THE .	

19	L	=LENGHT
- 33	LME	
200	LFE	=LOWEST FLOOR ELEVATION
- 9	LP.	=LIGHT POLE
- 10	MEAS.	=MEASURED
93	M.H.	=MAN HOLE
- 6	M/L	=MONUMENT LINE
	N.G.V.C	=NATIONAL GEODETIC
		VERTICAL DATUM
10	N.T.S.	=NOT TO SCALE
550	0 E.	=0 VERHEAD ELECTRIC LINE
	0/L	=ON LINE
	P.C.P.	=PERMANENT CONTROL POINT
	P.M.	=PARKING METER
	P.C.	=POINT OF CURVATURE
	P/W	=PARKWAY

PL.	=PL ANTER
P.O.C	=POINT OF COMMENCEMENT
P.O.B	=POINT OF BEGINNING
R	=RADIUS
RES	=RESIDENCE
R/W	=RIGHT OF WAY
S.D.H.	=SET DRILL HOLE
S.I.P.	=SET IRON PIPE
S/N	=SET NAIL
SDWLE	=SIDEWALK
T	= TANGENT
UE.	=UTILITY EASEMENT
W/F	=WOOD FENCE
W.V.	=WATER VALVE
W.U.P.	=WOOD UTILITY POLE
WALK	=WALKWAY



Accurate representation thereof to the best of my knowledge and belief. Subject to notes and Notations shown hereon.

DATE 11-08-2019
PB 14-42

PB 14-42

PB State of Florida

Not Valid unless Signed & Statinged with Embossed Seal



**MTTR MGMT** 291 NE 61<sup>ST</sup> ST | MIAMI FL | 33137

www.ma77er.com




LANDSCAPE ARCHITECT BRUCE E. CUMMINGS P.A. LAUDERDALE-BY-THE-SEA, FL 954/771-8184 DEVA FINGER
4880 PINE TREE DR | MIAMI BEACH| FL | 33140

PINE TREE

TREE SURVEY 2 OF 2

The sketch hereon is a true and

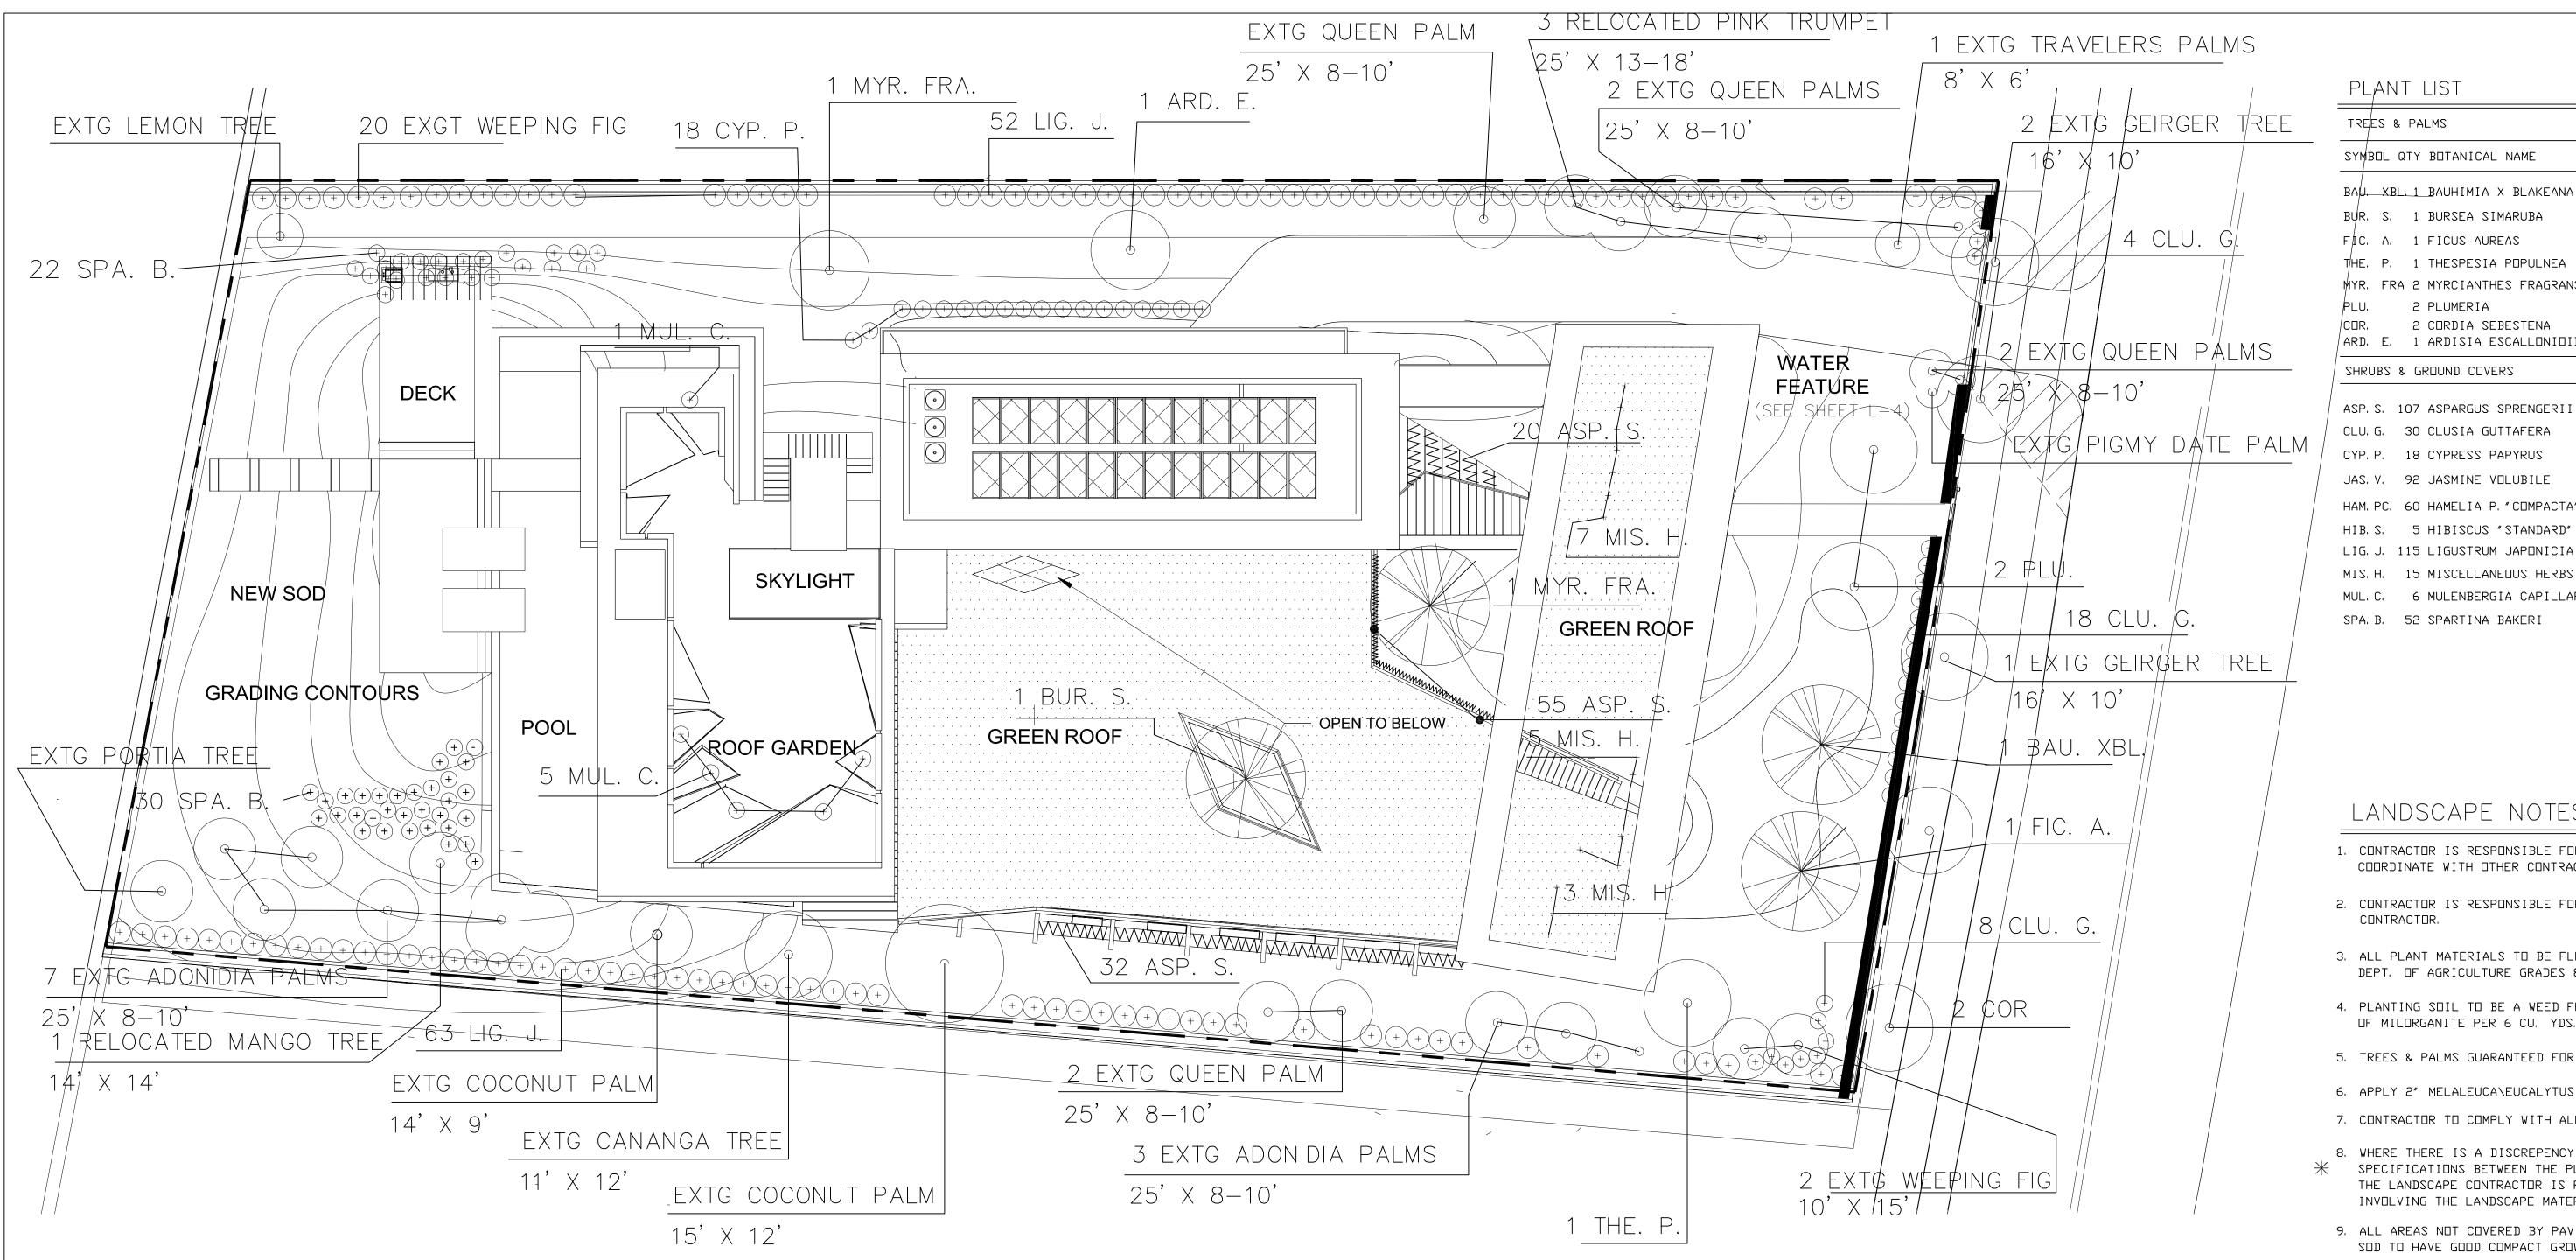

FIRST FLOOR PLAN

# PLANT LIST

# TREES & PALMS

BAUL XBL. 1 BAUHIMIA X BLAKEANA

HONG KONG ORCHID18-20'X 8-9'/MIN. 9'CT & 6"CAL

COMMON NAME

18-20' X 8-9' /MIN, 9' CT & 6" CAL 18-20' X 8-9' /MIN, 9' CT & 6" CAL

2-3′ X18″

15-25' X 8-10' /MIN, 9' CT & 6" CAL

12-16″□A. @ 12″□C.

18-24"SPR @ 24"OC.

THE, P. 1 THESPESIA POPULNEA MYR. FRA 2 MYRCIANTHES FRAGRANS 2 PLUMERIA 2 CORDIA SEBESTENA

ASPARAGUS

ARD. E. 1 ARDISIA ESCALLONIDIDES

SHRUBS & GROUND COVERS

ASP. S. 107 ASPARGUS SPRENGERI CLU. G. 30 CLUSIA GUTTAFERA CYP. P. 18 CYPRESS PAPYRUS JAS. V. 92 JASMINE VOLUBILE HAM. PC. 60 HAMELIA P. "COMPACTA"

CLUSIA HEDGE GIANT PAPYRUS WAX JASMINE

DWARF FIREBUSH 18-24" X 18-24" @ 24" DC. HIBISCUS "AN. CREPE" 6-7' X 2-3" LIGUSTRUM SHRUBS 12-15' X 2-3' 8-10"HT X 6"


MUHLY GRASS 18-24"SPR @ 24"OC.

MIS. H. 15 MISCELLANEOUS HERBS MUL. C. 6 MULENBERGIA CAPILLARIS SPA. B. 52 SPARTINA BAKERI SAND CORDGRASS 2-3' DA (3G)

# LANDSCAPE NOTES

- 1. CONTRACTOR IS RESPONSIBLE FOR REPAIRING FACILITIES HE DAMAGES AND IS TO COORDINATE WITH OTHER CONTRACTORS ON SITE.
- 2. CONTRACTOR IS RESPONSIBLE FOR FINISH GRADES- ROUGH GRADES BY GENERAL CONTRACTOR.
- 3. ALL PLANT MATERIALS TO BE FLORIDA NO. 1 OR BETTER AS PER FLORIDA DEPT. OF AGRICULTURE GRADES & STANDARDS, MARCH 1998
- 4. PLANTING SOIL TO BE A WEED FREE MIXTURE OF MUCK & SAND (50/50) WITH 50 LBS OF MILORGANITE PER 6 CU. YDS.
- 5. TREES & PALMS GUARANTEED FOR 180 DAYS- SHRUBS 90 DAYS.
- 6. APPLY 2" MELALEUCA\EUCALYTUS MULCH AROUND ALL PLANTS WITHIN 2 DAYS.
- 7. CONTRACTOR TO COMPLY WITH ALL CITY LANDSCAPE ORDINANCE REQUIREMENTS.
- 8. WHERE THERE IS A DISCREPENCY EITHER IN QUANTITIES, PLANT NAMES, SIZES OR  $\hspace{0.1cm} imes$  - Specifications between the plan or plant list, the plan takes preference. THE LANDSCAPE CONTRACTOR IS RESPONSIBLE FOR ANY VERIFICATION NECESSARY INVOLVING THE LANDSCAPE MATERIALS SHOWN ON THE PLAN.
- 9. ALL AREAS NOT COVERED BY PAVING OR STRUCTURES TO BE SODDED WITH FLORATAM SOD. SOD TO HAVE GOOD COMPACT GROWTH & ROOT SYSTEM. LAY WITH TIGHT JOINTS
- 10. ALL LANDSCAPED AREAS INSIDE PROPERTY AND ADJACENT ROW AREAS TO BE 100% COVERED WITH AUTOMATIC SPRINKLER SYSTEM WITH APPROXIMATELY 50% OVERLAP USING RUST FREE WATER AND A RAIN CHECK DEVICE.
- 11. TREES & PALMS TO BE STAKED AS NECESSARY IN A GOOD WORKMANLIKE MANNER WITH NO NAIL STAKING PERMITTED.


LANDSCAPE PLAN

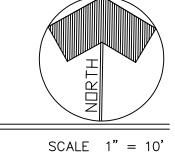

BRUCE E. CUMMINGS P.A. LANDSCAPE ARCHITECT

LAUDERDALE BY THE SEA, FLA 954/771-8184



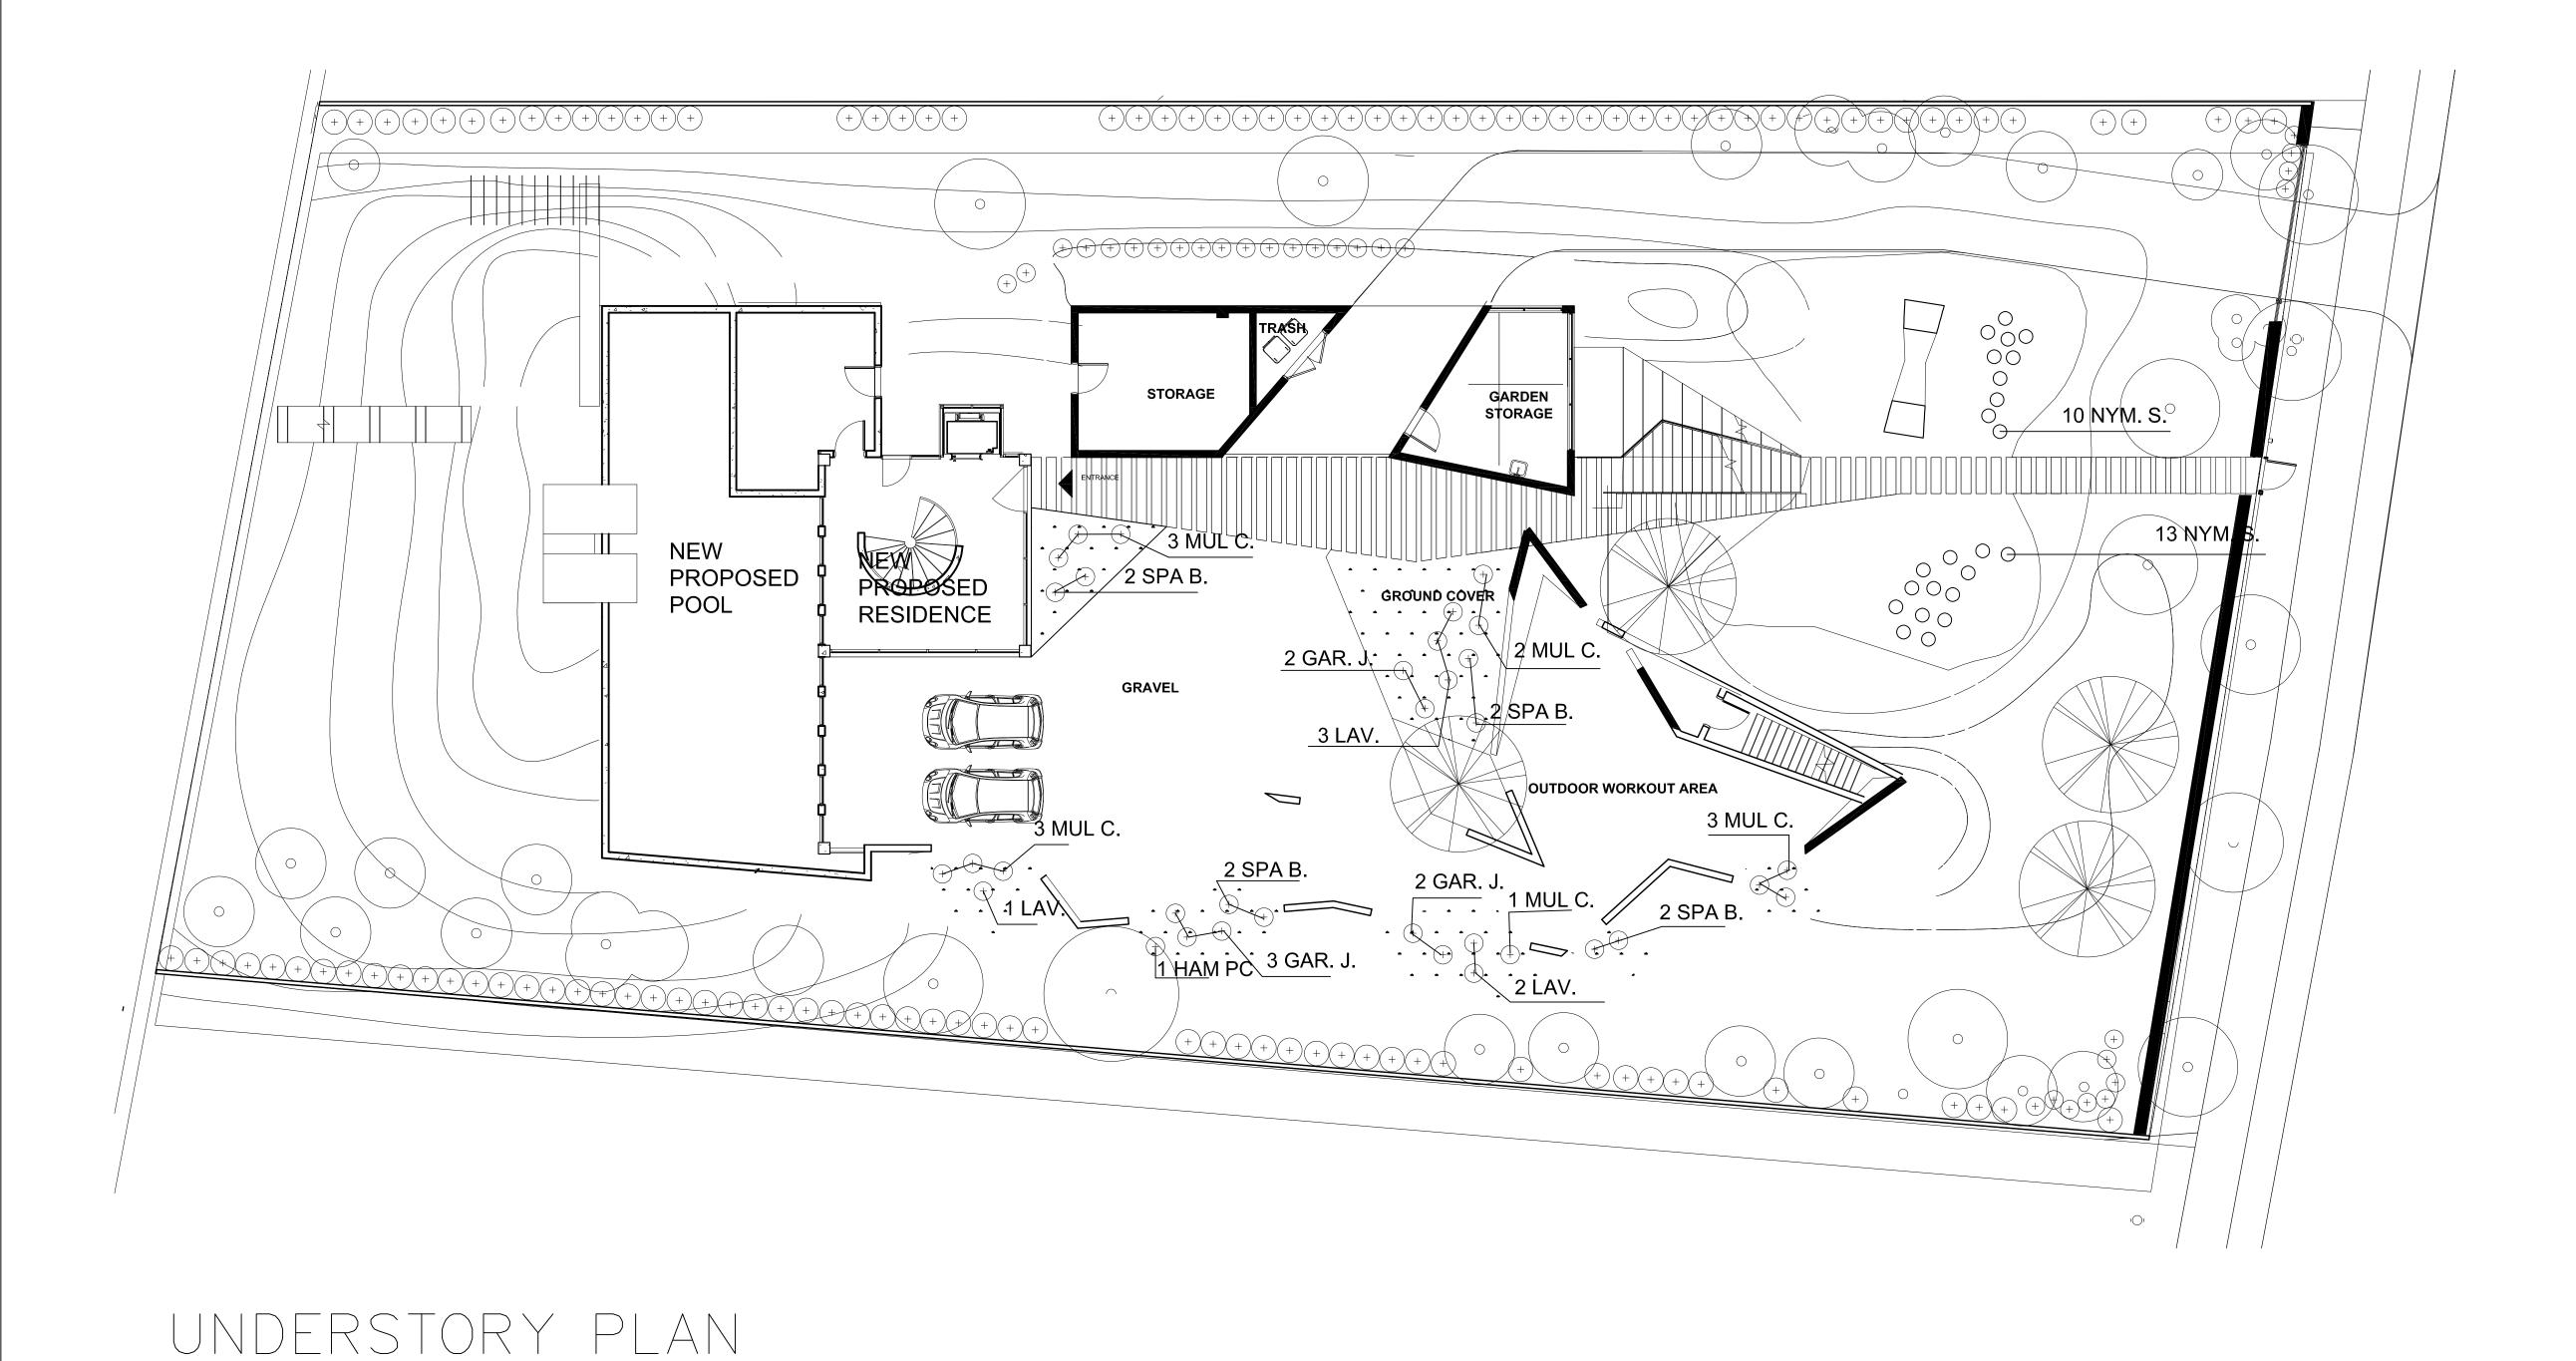

PLANT LIST

SHRUBS & GROUND COVERS

SYMBOL QTY BOTANICAL NAME

COMMON NAME

SIZE

NYM. S. 23 NYMPHAEA SPP.

WATER LILY'S 12-16" DA. @ AS SHOWN

MUL. C. 12 MULENBERGIA CAPILLARIS

MUHLY GRASS

18-24" SPR @ 24" DC.

SPA. B. 8 SPARTINA BAKERI

SAND CORDGRASS

2-3' DA (3G)

LAV. 6 LAVANDULA


LAVENDER

18-24" X 18-24"

GAR. J. 7 GARDENIA JASMINOIDES

DWARF GARDENIA 18-24" X 18-24"

LANDSCAPE PLAN

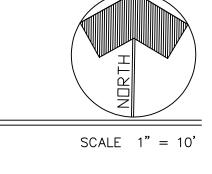

BRUCE E. CUMMINGS P.A. LANDSCAPE ARCHITECT

LAUDERDALE BY THE SEA, FLA 954/771—8184



# CITY OF MIAMI BEACH

# LANDSCAPE LEGEND

	LANDSCAFE LEGEND		
	INFORMATION REQUIRED TO BE PERMANENTLY AFFIXED TO PLANS	0.45	
	Zoning District RS-3 Lot Area 19,773 SF Acre	es	<b>-</b> %
		REQUIRED/	
	<u>OPEN SPACE</u>	ALLOWED	PROVIDED
A.	Square feet of required Open Space as indicated on site plan: Lot Area = $19,773$ s.f.x $50$ % = $9,887$ s.f.	9,887 SF	
В.	Square feet of parking lot open space required as indicated on site plan:		
	Number of parking spaces x 10 s.f. parking space =		
C.	Total square feet of landscaped open space required: A+B=		
	LAWN AREA CALCULATION		
·A.	Square feet of landscaped open space required	9,887 SF	
В.	Maximum lawn area (sod) permitted= 50 % x 9,887 s.f.	4,944 SF	
	TREES		
A.	Number of trees required per lot or net lot acre, less existing number of trees meeting minimum requirements=		
	5 trees x14 net lot acres - number of existing trees=	19 - 27 EX	39
В.	% Natives required: Number of trees provided x 30% =	12	12
C.	% Low maintenance / drought and salt tolerant required:		
_	Number of trees provided x 50%=	20	39
D.	Street Trees (maximum average spacing of 20' o.c.)  linear feet along street divided by 20'=		
E.	Street tree species allowed directly beneath power lines:		
	(maximum average spacing of 20' o.c.):		
	105 linear feet along street divided by 20'=	3 EX 3 NEW	6
	<u>SHRUBS</u>		
A.	Number of shrubs required: Sum of lot and street trees required x 12=	04	
	% Native shrubs required: Number of shrubs provided x 50%=	<u>91</u> 46	
	LARGE SHRUBS OR SMALL TREES		
A.	Number of large shrubs or small trees required: Number of required shrubs		
	x 10%=	10	
В.	% Native large shrubs or small trees required: Number of large shrubs or small trees provided x 50%=	81 <u>24</u>	
	smail trees provided x 30%=	5	

RCHITECT CONSULTANT OWNER PROJECT DRAWING TITLE DRAWING #

True Tree Service, LLC 4880 Pine Tree Drive (AR 06 December 2010

ø	SCIENTIFIC NAME	COMMON NAME	DBH	HGT	CAN	CRZ	CONDITION
1	Syagrus romanzoffiana	Queen palm	11"	15'	8'	11"	Good
2	Syagrus romanzoffiana	Queen palm	10"	14"	7	10"	Good
3	Phoenix roebelenii	Pygmy date palm		Unde		zed	
4 Syagrus romanzoffiana		Queen palm	8"	8" 13' 7'		8"	Good
5	Phoenix roebelenii	Pygmy date palm		Under-sized			
6	Ravenala madagascariensis	Travelers palm	8"	12"	6'	8"	Good
7	Ravenala madagascariensis	Travelers palm	10"	14"	6'	10"	Good
8	Ravenala madagascariensis	Travelers palm	11"	14"	6'	11	Good
A	Ravenala madagascariensis	Travelers palm	9"	12"	6'	9'	Good
В	Ravenala madagascariensis	Travelers palm	8"	13'	6'	8"	Good
C	Ravenala madagascariensis	Travelers palm	8"	12'	6'	8"	Good
9	Phoenix roebelenii	Pygmy date palm		-	Inder-si	zed	
10	Tabebula impetiginosa	Pink Trumpet	7.5"	25	18'	8	Good
11	Syagrus romanzoffiana	Queen palm	9"	16"	8'	9"	Good
12	Tabebula impetiginosa	Pink Trumpet	7	25'	16"	T	Good
13	Tabebuia impetiginosa	Pink Trumpet	7"	23'	13'	7	Good
14	Syagrus romanzoffiana	Queen palm	12"	20"	14'	12"	Good
15	Adonidia merrillii	Manila palm		1	Inder-s	zed	
16	Phoenix roebelenii	Pygmy date palm		ı	Inder-si	zed	
17	Ficus benjamina	Weeping Fig	6"	16"	6'	6"	Good
18	Cocos nucifera	Coconut palm	13"	20"	10'	13"	Fair
19	Phoenix roebelenii	Pygmy date palm		- 1	Inder-si	zed	
20	Adonidia memillii	Manila palm	7.5"	25	10"	8"	Good
21	Adonidia memilii	Manila palm	7"	25	10"	7	Good
22	Adonidia merrillii	Manila palm	6"	23'	10"	6	Good
23	Adonidia merrillii	Manila palm	6"	23'	8'	6"	Good
24	Cocos nucifera	Coconut palm	8"	28"	8"	8"	Good
25	Cocos nucifera	Coconut palm	T	28"	8'	7:	Good
26	Adonidia mernilli	Manila palm	9"	32"	81	9'	Good
27	Adonidia merrillii	Manila palm	8.5"	32"	8'	9	Good
28	Adonidia merrillii	Manila palm	7	30"	8'	7	Good
29	Adonidia merrillii	Manila palm	7"	30"	8'	7	Good
30	Adonidia memilii	Manila palm	7.5"	30"	8'	8'	Good

True Tree Service, LLC 4880 Pine Tree Drive (AR)

2	SCIENTIFIC NAME	COMMON NAME	DBH	HGT	CAN	CRZ	CONDITION
31	Ficus benjamina	Weeping Fig	5"	16"	10"	5	Poor
32	Ficus benjamina	Weeping Fig	22*	20"	18"	15	Poor
33	Coccoloba uvifera	Seagrape	Multi 20" / 21	35'	28'	41'	Poor
34	Bauhinia variegata	Bauhinia butterfly	6"	17	10"	6'	Good
35	Adonidia mernillii	Manila palm	12"	20'	15	12"	Good
36	Syagrus romanzoffiana	Queen palm	15"	15'	12'	15	Good
37	Bauhinia variegata	Bauhinia butterfly	8"	13'	15'	8'	Good
38	Adonidia memiliii	Manila palm	10"	12'	10"	10"	Good
39	Adonidia merrillii	Manila palm	9"	12'	10"	9'	Good
40	Ficus benjamina	Weeping Fig	Multi (4x) 4"	18"	8'	16"	Good
41	Ficus benjamina	Weeping Fig	Multi (2x) 4"	17	8'	8'	Good
D	Ficus benjamina	Weeping Fig	3"	16'	7	3'	Good
E	Ficus benjamina	Weeping Fig	Multi 3" /5"	181	8'	8'	Good
F	Ficus benjamina	Weeping Fig	Multi 3"/3.5"/3"	16"	8'	10"	Good
42	Adonidia merniliii	Manila palm	7.5*	25	14"	8'	Good
43	Ficus benjamina	Weeping Fig	Multi 3" / 4"	22'	16"	7	Good
44	Adonidis mernilii	Manila palm	4"	22'	12"	4	Good
45	Cocos nucifera	Coconut	9"	26'	8'	9'	Good
46	Ficus benjamina	Weeping Fig	5°	25'	7	5	Good
47	Adonidia mernilii	Manila palm	8"	28'	7	8'	Good
48	Adonidia merniliii	Manila palm	8"	27'	7	8'	Good
49	Phoenix roebelenii	Pygmy date palm		Under	-sized	_	
50	Ficus benjamina	Weeping Fig	Multi 7"/3"	14'	12"	10"	Good
51	Adonidis merrillii	Manila palm	6"	24'	10"	6'	Good
52	Adonidis mernilii	Manila palm	6.5°	23'	10'	7	Good
53	Adonidia merniliii	Manila palm	6.5*	24'	10"	7"	Good
54	Adonidia memiliii	Manila palm	Multi 6" / 6"	25	10'	12"	Good
55	Adonidia memiliii	Manila palm	6"	25'	9'	6'	Good
56	Adonidia memilii	Manila palm	6"	25'	9'	6'	Good
57	Adonidia merrillii	Manila palm	6"	14"	8'	6'	Good

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REMOVE
REMO 108 40 41 109 DEF 90----105 111 13 12 GROUND LEVEL BUILDING FOOTPRINT POOL 68 67 64 65 110 111 72 73 74

True Tree Service, LLC 4880 Pine Tree Drive ( 06 December 2019

#	SCIENTIFIC NAME	COMMON NAME	DBH	HGT	CAN	CRZ	CONDITION
59	Adonidia memilii	Manila palm	6"	20'	8	6	Good
10	Adonidia memilii	Manila palm	6°	25	10"	6	Good
1	Phoenix roebelenii	Pygmy date palm		Under	sized		-
2	Cocos nucifera	Coconut	12"	27	15'	12'	Good
33	Persea americana	Avocado	9"	18'	15	9'	Good
4	Syagrus romanzoffiana	Queen palm	10*	25	181	10'	Good
15	Syagrus romanzoffiana	Queen palm	10*	23'	18"	10'	Good
6	Syagrus romanzoffiana	Queen palm	9"	24	15'	9'	Good
7	Syagrus romanzoffiana	Queen palm	10°	24	15	10"	Good
8	Ficus benjamina	Weeping Fig	Multi 3"/6"	20"	15'	9'	Good
39	Adonidia memiliii	Manila palm	4.5*	25	10"	5	Good
0	Cananga odorata	Cananga tree	12"	30'	11'	12"	Fair
1	Cocos nucifera	Coconut	9"	30'	14'	9'	Good
	Adonidia memiliii	Manila palm	9"	18'	8'	9'	Good
	Adonidia memilii	Manila palm	9"	18'	8'	9'	Good
	Adonidia memilii	Manila palm	9"	18'	8'	9'	Good
	Adonidia memillii	Manila palm	4"	20'	8'	4	Good
3	Adonidia memillii	Manila palm	Multi 4" /5" /6"	23'	8'	15'	Good
7	Adonidia memilii	Manila palm	5.5*	16'	6'	6	Good
8	Adonidia memiliii	Manila palm	Multi 6" /6.5"	22"	8'	131	Good
9	Adonidia memiliii	Manila palm	7"	20'	8'	T	Good
10	Mangifera indica	Mango	Multi 8.5" / 5"	12'	14'	14"	Good
1	Adonidia mernillii	Manila palm	6.5*	16'	7	T	Good
12	Adonidia memiliii	Manila palm	6.5*	16'	7	7	Good
3	Citrus Limon	Lemon		Under	-sized		
4	Adonidia merrillii	Manila palm	7"	18'	6	7	Good
	Cocos nucifera	Coconut	8"	25	10"	8'	Poor
	Adonidia merrillii	Manila palm	7"	18'	6'	7	Good
	Cordia sebestena	Geiger tree	6"	16'	8'	6"	Good
3	Cordia sebestena	Geiger tree	6°	16'	10'	6'	Good
9	Cordia sebestena	Geiger tree	6"	16'	10'	6"	Good

rue Tree Service, LLC 380 Pine Tree Drive (A 5 December 2019 a g c | 7

ø	SCIENTIFIC NAME	COMMON NAME	DBH	HGT	CAN	CRZ	CONDITION
90*	Ficus benjamina	Weeping Fig	Multi (2x) 3"	16'	10	6'	Good
91*	Ficus benjamina	Weeping Fig	Multi (3x) 3"	17'	10	9"	Good
92*	Ficus benjamina	Weeping Fig	Multi 3" /4"	17	10	7	Good
93*	Ficus benjamina	Weeping Fig	3"	16"	10	31	Good
94*	Ficus benjamina	Weeping Fig	Multi (2x) 3"	18'	10	6'	Good
95*	Ficus benjamina	Weeping Fig	Multi (3x) 3"	18'	10	9"	Good
96*	Ficus benjamina	Weeping Fig	Multi 3" / 4"	18'	10	7	Good
97*	Ficus benjamina	Weeping Fig	Multi (3x) 3"	18'	10	9"	Good
98*	Ficus benjamina	Weeping Fig	4"	19'	10	4	Good
99*	Ficus benjamina	Weeping Fig	Multi (2x) 3"	18'	10	6"	Good
100*	Ficus benjamina	Weeping Fig	Multi (2x) 3" / 4"	20"	10	10"	Good
101*	Ficus benjamina	Weeping Fig	Multi (2x) 3"	18'	10	6'	Good
102*	Ficus benjamina	Weeping Fig	Multi (2x) 3"	17	10	6'	Good
103*	Ficus benjamina	Weeping Fig	Multi 3" /4"	18'	10	7	Good
104*	Ficus benjamina	Weeping Fig	Multi (3x) 3"	19"	10	9"	Good
105*	Ficus benjamina	Weeping Fig	Multi 5" /3"	21'	10	8"	Good
106*	Thespesia populnea	Portia tree	Multi (5x) 3"	15"	15'	15'	Good
_		Trees on adja	scent property	_		_	
107*	Callistemon citrinus	Red bottlebush	4"	12'	4	4	Good
108*	Roystonea regia	Royal palm	12"	16'	10'	12'	Good
109*	Livingstona chinensis	Fountain palm	10"	15	7	10"	Good
110*	Sabal palmetto	Cabbage palm	14"	23'	8'	14"	Good
111*	Dypsis lutescens	Areca		Unde	r-sized	_	
112*	Thespesia populnea	Portia tree	6'	16"	12"	8"	Good

TREE DISPOSITION LEGEND

TREES TO REMAIN - TOTAL OF 51

TREES TO REMOVE - TOTAL OF 51

TREES TO RELOCATE - TOTAL OF 4

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RCHITECT CONSULTANT OWNER PROJECT DRAWING TITLE DRAWING

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**DEVA FINGER** 4880 PINE TREE DR | MIAMI BEACH| FL | 33140 **PINE TREE** 

**TREE DISPOSITION PLAN** 03.30.2020 3/64" = 1'-0"

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