
Miami Beach, FL. 33140

SECOND SUBMITTAL - MAY 11TH 2020 BOARD OF ADJUSTMENT

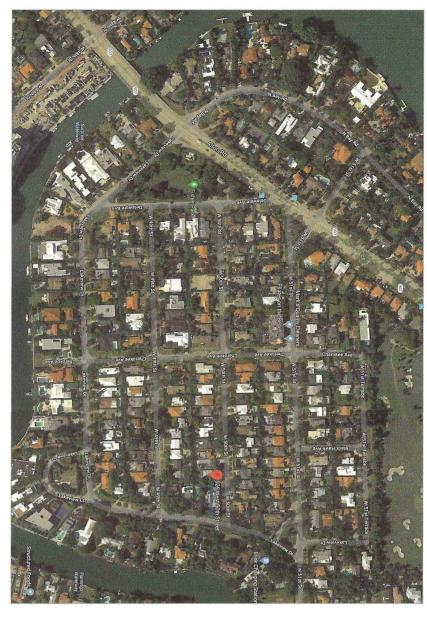

SCOPE OF WORK

SECOND STORY ADDITION TO EXISTING SINGLE STORY RESIDENCE NEW MASTER BEDROOM NEW MASTER BEDROOM NEW MASTER BATH NEW HIS AND HERS W.I.C.

INTERIOR REMODELING
EXISTING KITCHEN TO BE REMODELED
EXISTING TWO BATHS TO BE REMODELED
EXISTING WID TO BE RELOCATED
NEW STARS AND RAILING
NEW BATH
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NEW BATH

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SECTION ELEVATION DETAIL

THE DESCRIPTION HANDS:

A-1

THE STREET.


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5/06/20

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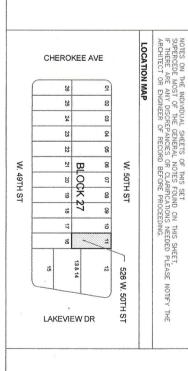
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WITER CLOSET
WATER HEATER
WELDED WIRE MESH



APPLICABLE CODES NPFA 101 LIFE SAFETY AND FFPC (5TH EDITION) FLORIDA BUILDING CODE 2017 (6TH EDITION) FLORIDA BUILDING CODE 2017 - EXISTING FLORIDA BUILDING CODE (FBC) TYPE OF REHABILITATION CLASSIFICATION OF WORK DING CODE 2017, EXISTING BUILDING - SECTION 504:

ABBREVIATIONS AS ANCHOR BOJI A/G AR CONCIDENS AFF ABONE FRUSH FLOOR AUBINALIA APPROXIMATE FOLIO NO. ZONING AS PER NFPA 101: MODIFICATION (43.2.2.1.3): THE RECONFIGURATION OF ANY SPACE; THE ADDITION, RELOCATION OR ELIMINATION OF ANY DOOR OR WINDOW, THE ADDITION OR ELIMINATION OF LOAD-BEARING ELEMENTS; THE RECONFIGURATION OR EXTENSION OF ANY SYSTEM; OF THE INSTALLATION OF ANY ADDITIONAL EQUIPMENT. ALTERATION - LEVEL 2: 504, 1 SCOPE: LEVEL 2 ALTERATIONS INCLUDE THE RECONFIGURATION OF SPACE, THE ADDITION OR ELIMINATION OF ANY DOOR OR WINDOW, THE RECONFIGURATION OR EXTENSION OF ANY SYSTEM, OR THE INSTALLATION OF ANY ADDITIONAL EQUIPMENT. 504,2 APPLICATION: LEVEL 2 ALTERATIONS SHALL COMPLY WITH THE PROVISIONS OF CHAPTER 7 FOR LEVEL 1 ALTERATIONS AS WELL AS THE PROVISIONS OF PROJECT LOCATION 526 W. 50TH STREET Miami, FL 33140 02-3222-022-0910 RS-4 TYPICAL UNDERGROUND UNDERWRITERS LAB. NDS PER SQUARE FOOT NDS PER SQUARE INCH SSURE TREATED A - 000 COVER PAGE A - 001 SURVEY A - 002 PROPOSED SITE PLAN A - 002 PROPOSED SITE PLAN A - 003 DEMOLITION SITE PLAN A - 003 THARDSCAPE PLAN A - 005 VARIANCE / WAIVER DIAGRAM A - 201 EXISTING ELEVATIONS A - 202 DEMOLITION ELEVATIONS A - 203 PROPOSED ELEVATIONS A - 101 EXISTING GROUND FLOOR PLAN A - 102 DEMOLITION GROUND FLOOR PLAN A - 103 PROPOSED GROUND FLOOR PLAN A - 104 PROPOSED SECOND FLOOR PLAN A - 401 PHOTOGRAPHS - EXISTING STRUCTURE A - 402 PHOTOGRAPHS - INTERIOR A - 403 PHOTOGRAPHS - CONTEXT / STREET A - 301 PROPOSED SECTION

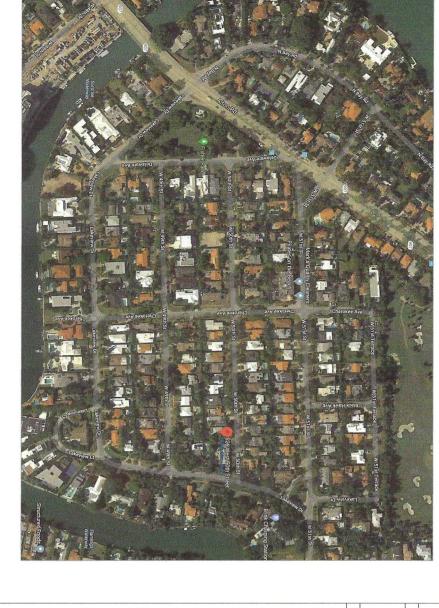

COVER PAGE

5 2 6 W 50th. Street MIAMI BEACH, Florida, 33140 5 2 50th.


B R U C K

CANDELA + PARTNERS, LLC

5940 SOUTHWEST JORD STREET SUITE 200 SOUTH MIAM: FLORIDA 33143 P 305 866 7788 WWW.GANDELAANDFANTNERS.COM HILARIO F. CANDELA. FAIA

CANDELA

DRAWING LIST

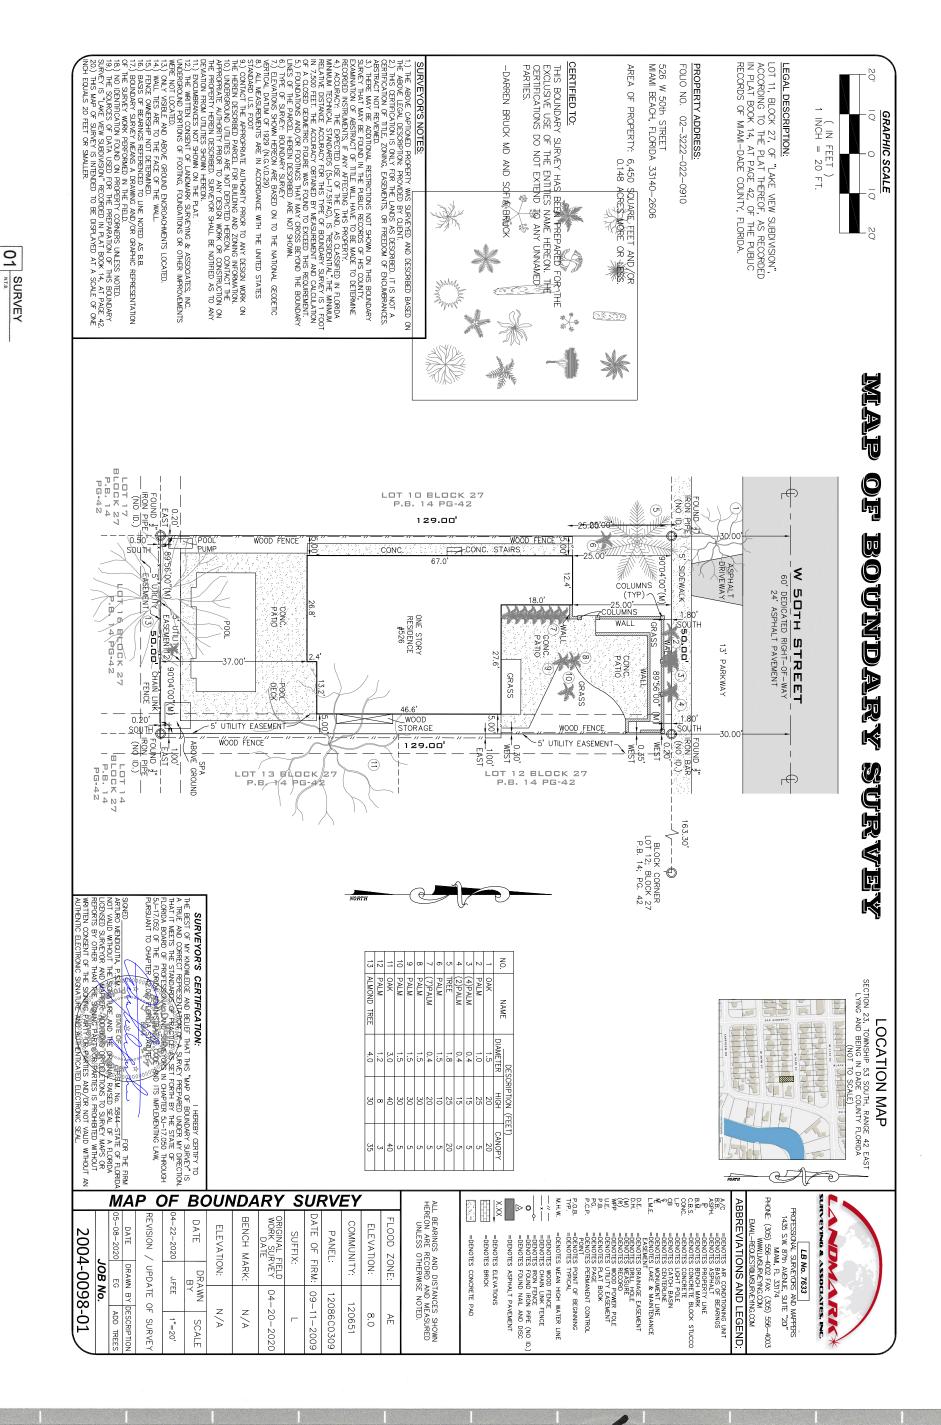

4/20/20


Revisions

SURVEY

50th. Florida, 33140 MIAMI BEACH, Street B R U C K


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CANDELA + PARTNERS, LLC

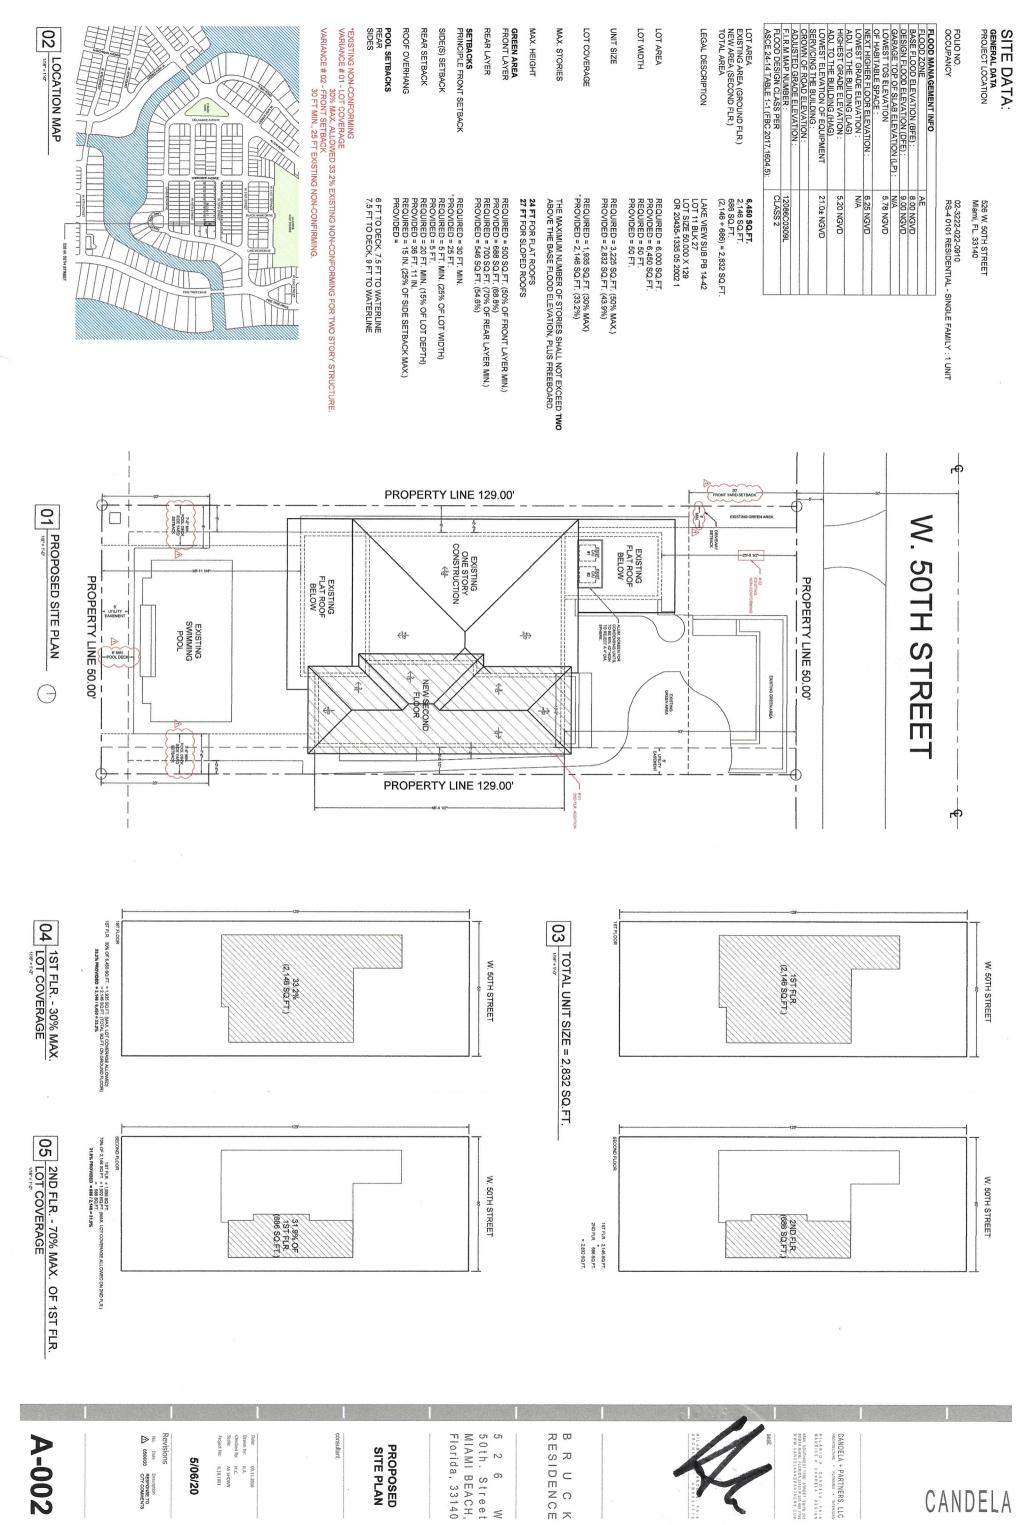

5/06/20

Description
RESPONSE TO
CITY COMMENTS

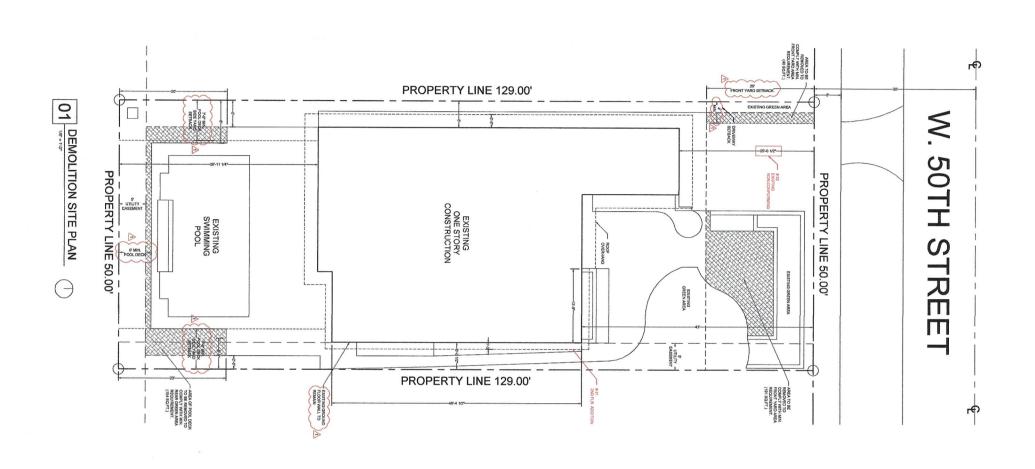

NOTE

EXISTING PAVEMENT OTHER THAN DRIVEWAY & WALKWAYS WITHIN FRONT YARD TO BE REMOVED.


A-003

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Date: 05.11.2018
Drawn br: R.A.
Checked by: M.C.
Scale: AS \$150WN
Poject No: R.18.1801

DEMOLITION SITE PLAN 5 2 6 W 50th. Street MIAMI BEACH, Florida, 33140 B R U C K

CANDELA + PARTNERS, LLC
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HILARIO F CANDELA - SALO
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NOTE

EXISTING PAVEMENT OTHER THAN DRIVEWAY & WALKWAYS WITHIN FRONT YARD TO BE REMOVED.

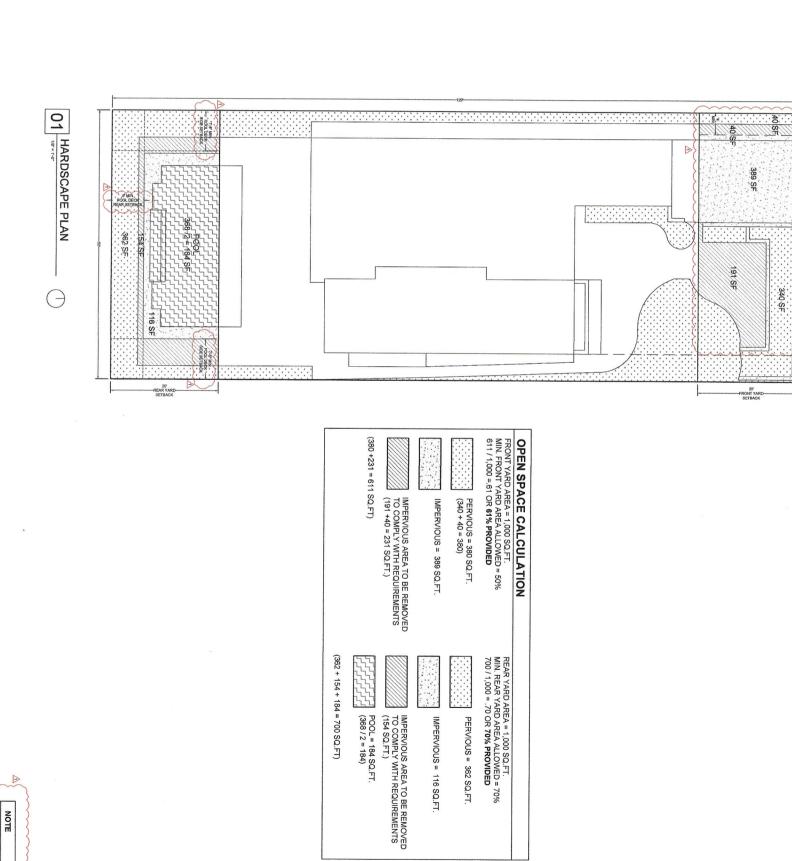A-004

Revisions

No. Date Description

A 0506/20 CITY COMMENTS 5/06/20

Date: 09.11.2018
Drawn by: R.A.
Checked By: M.C.
Scale: AS SHOWN
Project No: R.18.1001

HARDSCAPE PLAN

5 2 6 W 50th. Street MIAMI BEACH, Florida, 33140

B R U C K

CANDELA + PARTNERS, LLC
ACCUMECTURE + SLANANG - INTERIORS
HILLARIO F CANDELA FALA
MADRICE M CANDELA DESIGN

W. 50TH STREET

01 VARIANCE / WAIVER PLAN LOT_AREA=6,450 SQ.FT. EXISTING A/C AREA= 2,127SQ. FT. LOT AREA=6,450 SQ. FT. NEW 2ND FLR.= 686 SQ. FT.

A-005

VARIANCE # 01 - LOT COVERAGE
30% MAX. ALLOWED 33.2% EXISTING NON-CONFORMING FOR TWO STORY STRUCTURE.
VARIANCE # 02 - FRONT SETBACK
30 FT MIN., 25 FT EXISTING NON-CONFIRMING.


5/06/20

VARIANCE / WAIVER PLAN

5 2 6 W 50th. Street MIAMI BEACH, Florida, 33140

B R U C K

CANDELA + PARTNERS, LLC
AMENTECIBLE + PLANSING + DIEBOGES
HILARIO F CANDELA FAIA
HAURICE H CANDELA DESIGN

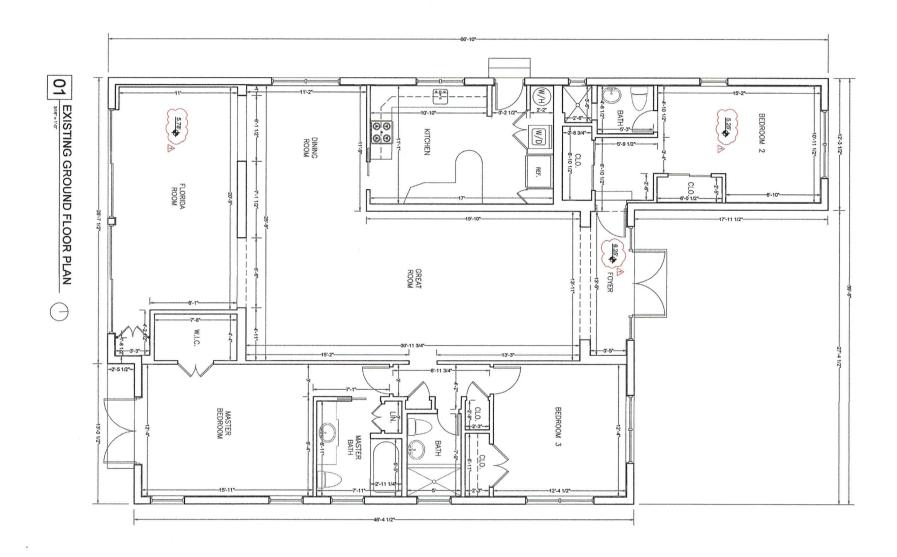

5/06/20

Revisions

No. Date Description


Social RESPONSE TO CITY COMMENTS

ate: 09.11.2018
rown by: R.A.
hecked by: M.C.
cate: AS \$10WN
roject No: R.19.1001

EXISTING GROUND FLOOR PLAN 5 2 6 W 50th. Street MIAMI BEACH, Florida, 33140

B R U C K



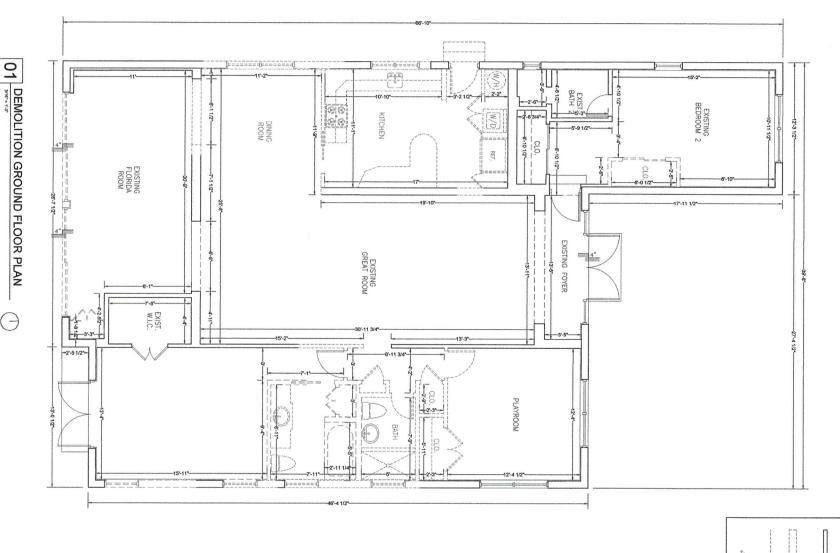

LEGEND : EXISTING 8" C.B.S. WALL TO REMAIN

PREPARE SURFACE TO RECEIVE NEW WORK

DEMOLITION KEY NOTES

PREPARE SURFACE TO RECEIVE NEW WORK.

TO BE DEMOLISHED EXISTING TO BE REMOVED

REMOVE EXISTING EXTERIOR DOOR AND FRAME PREPARE SURFACE TO RECEIVE NEW WORK.

A REMOVE EXISTING PARTITION TO NEAREST ADJACENT STUD. PREPARE SURFACE TO RECEIVE NEW WORK.

GENERAL DEMOLITION NOTES:

CUT BACK EXISTING ROOF OVERHANG.
PREPARE SURFACE TO RECEIVE NEW WORK REMOVE EXISTING ROOF STRUCTURE.

PREPARE SURFACES TO RECEIVE NEW WORK CAP OR REROUTE PIPING AS REQUIRED.

- DASHED LINES INDICATE WALLS AND ITEMS TO BE REMOVED, LIGHT SOLID LINES INDICATE EXISTING WALLS AND ITEMS TO REMAIN
- CONTRACTOR SHALL FIELD VERIFY ALL EXISTING CONSTRUCTION RELATED CONDITIONS PRIOR TO STARTING DEMOLITION. ANY AND ALL DISCREPANCES SHALL BE ROUGHT TO THE IMMEDIATE ATTENTION OF THE OWNER'S REPRESENTATIVE.
- 3. THE OWNER SHALL RETAIN ALL SALVAGE RIGHTS OFER BUILDING MATERIALS THAT ARE OF WALLE AS DESIGNATED BY THE OWNER'S REPRESENTAING. THE OWNER'S BEPRESENTAING SHALL DRECTOR THE INMIDUAL CONTRACTORS TO THE LOCATIONS OF STORAGE AREAS FOR WROOLD SALVAGE TELLS. THE CONTRACTOR SHALL BE RESPONSIBLE FOR REMOVING FROM THE BUILDING AND THE CONSTRUCTION SHE ALL CONSTRUCTION DEBRIS AND ITEMS OF RETAINED BY THE OWNER'S REPRESENTAINE.
- PATCH AND REPAIR ALL EXISTING SURFACES THAT ARE TO RECEIVE NEW FINISHES. ALL OPENINGS AND VOIDS LEFT BY THE REMOVAL OF EXISTING CONSTRUCTION EQUIPMENT, PIPMS, DUCTS, ETC. SHALL BE PROPERLY PATCHED OR CLOSED OFF TO MANTAN FIRE RATING OF SURROUNDING WALL AND WEATHER TIGHT CONDITIONS.
- EXISTING ITEMS, EQUIPMENT, PLUMBING FIXTURES, ETC, TO REMAIN IN PLACE SHALL BE PROTECTED FROM DIRT AND DAMAGE DURING DEMOLITION AND CONSTRUCTION. ALL PNISHED AREAS WHICH ARE DAMAGED DURING DEMOLITION BY THE CONTRACTOR SHALL BE PATCHED TO MATCH EXISTING PRINSHES, ETC. THE CONTRACTOR IS RESPONSIBLE FOR PROVIDING NEW PINISHES, CEILING, FLOORING, ETC. TO DAMAGED AREAS.
- WHERE REMOVAL OF PORTIONS OF FLOOR COVERINGS ARE REQUIRED, REMOVE ONLY THOSE MATERIALS TO THE EXTENT SHOWN WITHIN THE ROOMS.

 INCLUDING THE REMOVAL OF ADHESIVES, GROUTING BEDS, ANCHORING DEVICES AND PREPARE SURFACES FOR NEW CONSTRUCTION. WHERE REMOVAL OF PORTIONS OF FINISHED CEILINGS ARE REQUIRED, REMOVE ONLY THOSE LIGHT FIXTURES AND OTHER CEILING EQUIPMENT WITHIN THAT PORTION OF CEILING. COORDINATE WITH DRAWINGS.
- 10. CONTRACTOR SHALL TAKE ALL NECESSARY PRECAUTIONS TO PREPARI DIMANGE TO OWNERS'S OCCUPED AREAS ADJACENT TO NEW CONSTRUCTION OR OCCUPED. AREAS WHERE VARIOUS SYSTEM CONNECTIONS OR EXTENSION ARE
- RECUIED THOUGHT ON THE TOTAL ACTUMES SHALL SUBJECT IN BUILDING CHARLES AND BE CONSTITUTED WITH THE OWNER TREPESTATION OF THE BUILDING STATE OF THE BUILDING STATE OWNER TO THE CONTRACTOR SHALL BE RESPONSIBLE FOR STORAGE AND PROTECTION OF

12.

 $\bar{\omega}$

EXISTING EXIT PASSAGEWAYS SHALL BE MAINTAINED AND ACCESSIBLE AT ALL TIMES DURING CONSTRUCTION. ALL SALVAGE TIEUS WHO! WILL BE RELISED IN THIS PROJECT.
ALL NON-ATTACHED TIEUS SIGH, BE FUNNISHINGS, MOBILE
COURDERT, CHARS, ETC., SHALL BE REJOYED BY OWNER PRIOR TO
COMMUNECULENT OF DEMOLITION WORK, COORDINATE WITH OWNERS
REPRESENTATIVE FOR REJOYAL OR RELOCATION OF ANY REJAINING

4

15. STOP ALL WORK IF ANY UNFORESEEN CONDITIONS ARE ENCOUNTERED DURING DEMOLITION AND CONSTRUCTION. NOTIFY ARCHITECT IMMEDIALTELY. coordinate with building management all work to be performed.

09.11.2018 R.A. M.C. AS SHOWN R.18.1001

Revisions

4/20/20

GROUND

FLOOR PLAN

DEMOLITION

50th. Street MIAMI BEACH, Florida, 33140


RESIDENCE

MAUNICE H. CANDELA DESIGN ARCHITECTURE - PLANNING - INTERIORS

REMOVE EXISTING KITCHEN COUNTER AND CABINETS. PREPARE SURFACES TO RECEIVE NEW WORK. REMOVE EXISTING INTERIOR DOOR AND FRAME.

PREPARE SURFACES TO RECEIVE NEW WORK. S REMOVE EXISTING PLUMBING FIXTURE.

CAP OR REROUTE PIPING AS REQUIRED.

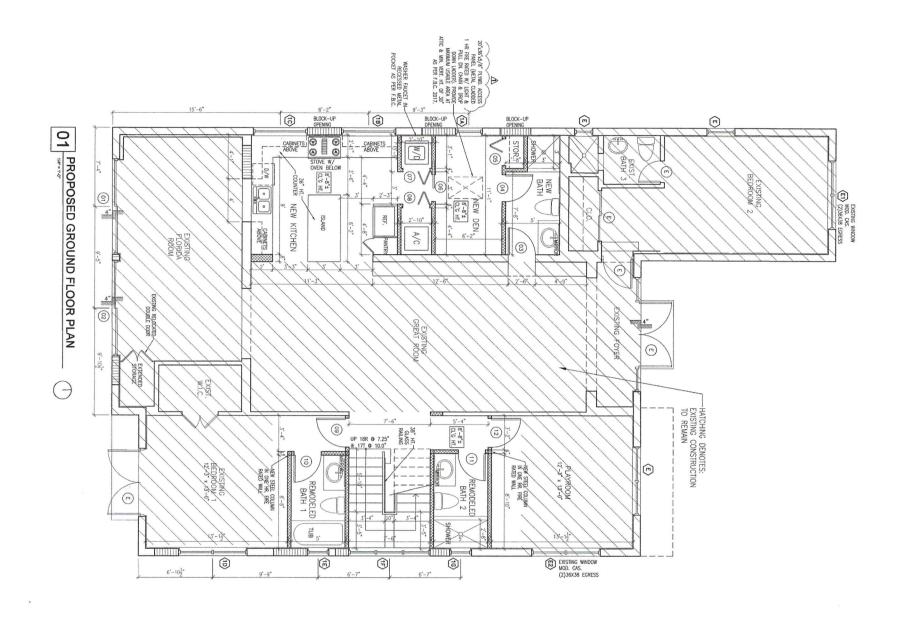

1 TYPE 9 SCREIGH INDY (1944M) LONG SHALL BE USED FOR ATTACHING THE RIPST LAYER OF WALLEDARD TO THE STEEL STUDS AND THE THIRD LAYER TO THE SHEET METAL ANGLES AT 24 MODES (60MM) ON CENTER THE 5 SCREIGH 194 MODES (44MM) CON CENTER THE 5 SCREIGH 194 MODES (44MM) CON CENTER THAT SHEET METAL SHEET METAL SHEET METAL SHEET OF WALLEDARD TO THE STEEL STUDS AND THE FOURTH LAYER TO THE SHEET NETAL ANGLES AT 12 MODES (2054M) ON CENTER THES SHEET METAL ANGLES AT 12 MODES (2054M) ON CENTER THESE SHEET SHEET METAL ANGLES AT 12 MODES (2054M) ON THE STEEL STUDS AT 12 MODES (51MM) LONG SHALL BE USED FOR ATTACHING THE HIRD LAYER OF WALLEDARD TO THE STEEL STUDS AT 12 MODES (3054M) ON CENTER

4 GALYANIZED ØØ149 inch (Ø318mm) TRINITUM THICKNESS STEEL CORNER BEADS WITH I 12-Inch (38.imm) LEGS ATTACHED TO THE WALLEDARD WITH I Inch (25.4mm) LOVS, TYPE S SCREWS SPACED 13 Inches (305mm) ON CENTER

A 6

Date Description
03/25 /19 COMMENTS

4/20/20

26 TYPE X CATPENN WALLEDARD IN ACCORDANCE WITH ASM 256. FOR SMALE LATER APPLICATIONS THE WALLEDARD WALLEDARD THE APPLICATIONS THE WALLEDARD WALLES APPLICATIONS THE WALLEDARD WALLES APPLICATIONS HORIZONTAL JOINTS ARE PROTITED AT A TIME WANTED ACING SO FOR 17 (325m) FOR A TIME WANTED ACING SO FOR 17 (325m) FOR A TIME WANTED ACING SO FOR 17 (325m) FOR A TIME WANTED ACING SO FOR 17 (325m) FOR A TIME WANTED ACING SO FOR 17 (325m) FOR A TIME WALLES (325m) ALLE BASIS ACING WALLES (325m) ALLE DATESMED HAVE BASIS ACING WALLES (325m) ALLE DATESMED AND THE WEIGHT-TO-HEATED-PERINETER RATIO (WID) OF THE COLUMN. (1.578LCTIASA). STEEL COLLYN, ETHER WIDE FLANGE OR TUBLIAR SHAPES. 2.1 B/B. INCH. (1.3 mr.) DEEP STUDS FADRICATED FROM ØØTIS Inch (9.4 mm.) MINOVIT THICOMESS GALVANIZED STEEL WITH 15 Mr. (9.4 mm.) MINOVIT THICOMESS GALVANIZED STEEL ENGINE OF THE OFFICE STUD SHAPEN DEEP (2.1 mch. (12.1 mm.) LESS THAN THE HEIGHT OFFICE STUD SHAPEN. 46 PER FBC, 2011, THE GYPSUM WALLBOARD SHALL BE SUPPORTED AS ILLUSTRATED IN FIGURE 1095IC FOR FIRE RESISTANCE RATINGS OF THREE (3) HOURS OR LESS. I LAYER = 5/8' OR 1/2"

MOTE:
AS PER F.B.C. 2017, COMBUSTIBLE INSULATION SHALL
BE SEPARATED A MINMUM OF 3 INCHES (76mm) FROM
RECESSED LIGHTIME FIXTURES, FAN MOTORS AND OTHER
HEAT-PRODUCING DEVICES.

TERMITE NOTES:

AS PER F. S.C. 2017, A WENTER-RESSIANT JOB-SITE POSTING BOARD SHALL BE PROVIDED TO RECEIVE DUPLICATE TREAMBUT CRITICATES AS SACH REQUIRED PROTECTIVE TREAMBUT IS TO SERVICE TO AN AMOTHER DOPE TO BE THE BUILDON FROM THE SERVICE THE AMOTHER DOPE TO BE THE BUILDON FROM THE SERVICE THE AMOTHER DEPOYED BY THE BUILDON FROM THE SERVICE TO SERVICE THE AMO DATE OF THE PRODUCT USED. DENTITY OF THE APPLICATION, THE AMO DATE OF THE PREMIENT ON THE APPLICATION, THE MODEL TO THE STANGEST AND VERTIFIES RECORD OF PROTECTIVE TREATMENT, IF THE SOIL VERTIFIES RECORD OF PROTECTIVE TREATMENT, IF THE SOIL AS PER F.B.C. 2017, A PERMANENT SIGN WHICH IDENTIFIES THE ITEMITE TREATMENT PROVIDER AND NEED FOR REINSPECTION AND TREATMENT CONTRACT RELIVEM, SHALL BE PROVIDED. THE SIGN SHALL BE POSTED NEAR THE WATER HEATER OR ELECTRIC PANEL.

TIAS JURBING 15° OC., DIE LINER 5/8" THE K OFFERM LÄH, 55
CERENT-OUELD OR MING SHANED MILS 6" OC. PRETR THE ELEVEL CONFERD WITH
COMETENTIONS COMPANIO ORES, JAMES ERPORTO MIL HELDS CONFERD WITH
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MINIMALM MERCHALES. FIRE RATINGS DESCRIPTION :

09.11.2018 R.A. M.C. AS SHOWN R.18.1001

FLOOR PLAN PROPOSED GROUND Florida, 33140

5 2 50th. MIAMI BEACH Street


B R U C K

MAURICE H CANDELA DESIGN

CANDELA + PARTNERS, LLC

01 PROPOSED SECOND FLOOR PLAN

9

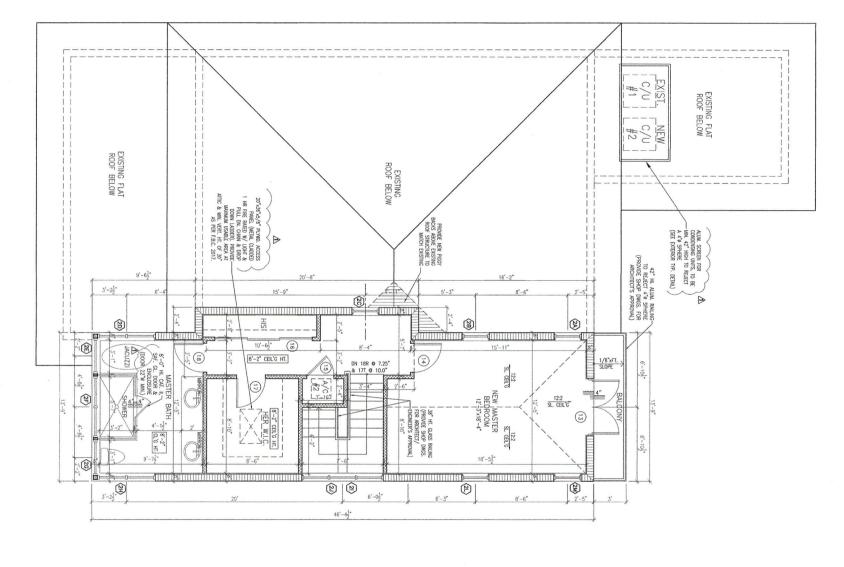

ATTACHING 16 ECREUB I NON (19 AMM) LONG SHALL BE USED FOR ATTACHING THE RIGST LAYER OF WALLEDARD TO THE STEEL STUDS AND THE RIGST LAYER OF WALLEDARD TO THE STEEL STUDS AND THE MIND LAYER TO THE SHEET INTIAL ANGLES (19 A MONE) (4 Amm) ON CENTER TO THE SHEET INTIAL ANGLES (19 A MONE) (4 Amm) LONG SHALL BE USED FOR ATTACHING THE SECOND LAYER OF WALLEDARD TO THE STEEL STUDS AND THE FOURTH LAYER TO THE SHEET NETAL ANGLES AT 18 INCHES (205mm) ON CENTER, TYPE 6 SCREUB 2 1/4 Inches (5 17 m) LONG SHALL BE USED FOR ATTACHING THE THIRD LAYER OF WALLEDARD TO THE STEEL STUDS AT 12 INChes (205mm) ON CENTER. 5, No. 18 SWG STEEL TIE WIRES SPACED 24 inches (610 mm) CN CENTER. . SHEET METAL ANGLES WITH 2-INCH LEGS FABRICATED FROM @2@3 Inch (@531mm) MINIMUM THICKNESS GALVANIZED STEEL

2) TYPE X GYPSUM WALLBOARD IN ACCORDANCE WITH ASIM COS. FOR SINGLE LATER APPLICATIONS THE WALLBOARD IN ACCORDANCE WITH SOLUTIONS THE WALLBOARD OF THE PAPELED VERY CALL WITH NO HORSICOMAL JOINTS ARE PROVIDED THAT THE JOINTS IN SUCCESSIVE LATERS ARE PROVIDED THAT THE JOINTS IN SUCCESSIVE LATERS ARE PROVIDED THAT CALLS (1800-18). THE TOAL HORSICOMAL WITH SOLUTION THE WALLBOARD SHALL BE DETERMINED RECORDED THAT WE SECOND THE WALLS OF THE SECOND THAT SUCCESSIVE RATING AND THE WEIGHT-TO-HEATED-FERRITETER RATIO (WD) OF THE COLUMN.

4 GALYANIZED ØØ148 inch (Ø315mm) TRINTUM THICKNESS STEEL CORNER BEADS WITH I 172-Inch (38.1mm) LEGS ATTACHED TO THE WALLEDARD WITH I Inch (25.4mm) LONG, TYPE S SCREWS SPACED IZ Inches (365mm) ON CENTER.

Date Description
03/25 /19 COMMENTS

4/20/20

(1 STRUCTURAL STEEL COLUNN, EITHER WIDE FLANGE OR TUBULAR SHAPES 2.1 5/8 INDN (4)3mm) DEEP STUDS FABRICATED FROM ØØITS INCH GASEN (MINITAL THE CONSESS CALL VANUED) STEEL WITH 1 5/16 -(500-500) DEEP STUDIES OF SEEDIN) LEGS. THE LENGTH OF THE STEEL IS TUD ON CASE OR SEEDIN LEGS. THAN THE HEIGHT OF THE ASSET PLY.

AS PER F.B.C. 2011, THE GYPSUM WALLBOARD SHALL BE SUPPORTED AS ILLUSTRATED IN FIGURE 1035.IC FOR FIRE RESISTANCE RATINGS OF THREE (3) HOURS OR LESS. 1 LAYER = 5/8' OR 1/2"

NOTE:
AS PER F.B.C. 2017, COMBUSTIBLE INSULATION SHALL
BE SEPARATED A MINIMUM OF 3 INCHES (76mm) FROM
RECESSED LIGHTING FIXTURES, FAN MOTORS AND OTHER
HEAT-PRODUCING DEWICES.

TERMITE NOTES:

AS PER F.B.C. 2017, A WEATHER-RESISTANT JOB-STIE POSTING BOARD SHALL BE PROVIDED TO RECEIVE DUPLICATE TREATMENT CERTIFICATES & EACH REQUIRED PROTECTIVE TREATMENT CERTIFICATES & EACH REQUIRED PROTECTIVE TREATMENT IS CHARLEST PROVIDER A COPP FOR THE PERSON THE PERSON IS DETECTIVE TO A WEATHER THE STIED TO ANY AND A COPP FOR THE BUILDING PERSON THESE. THE PROVIDED THE PRODUCT USED, DIFFERENCE FOR THE PROVIDED PROTECTIVE TO ANY A PROVIDED THE PROVIDED PROTECTIVE TO STREUGH A VERHALE RECORD OF PROTECTIVE TREATMENT, IT THE SUB-FINAL ENTERIOR METHOD FOR TERMINE PROVIDENCE IS USED. FINAL ENTERIOR TREATMENT THE PROVIDENCE TO FINAL ENTERIOR AS PER F.B.C. 2017, A PERMANENT SIGN WHICH IDENTIFIES THE TERMITE TREATMENT PROVIDER AND NEED FOR REINSPECTION AND TREATMENT CONTRACT RENEMBLA SHALL BE PROVIDED. HE SIGN SHALL BE POSTED NEAR THE WATER HEATER OR ELECTRIC PANEL

TAS FURRING 16" O.C., ONE LAYER 5/8" THEE X CHESUM LATH, 551 CENSIF-CONTECT ON RINK S-MANCED MILS 6" O.C. PREET THEE EDISECTION OF THE MATERIAL EDISECTION OF THE MATERIAL EDISECTION OF THE MATERIAL COMPOUND WITH FACES CONFECTION WITH COMPOUND WITH FACES CONFECTION OF THE MATERIAL COMPOUND WITH FACES CONFECTION OF THE MATERIAL COMPOUND OF THE THE MATERIAL OF THE MATERIAL COMPOUND OF THE MATERIA FIRE RATINGS DESCRIPTION :

FLOOR PLAN PROPOSED SECOND


50th. Street MIAMI BEACH, Florida, 33140

RESIDENCE

MAURICE H CANDELA DESIGN

CANDELA + PARTNERS, LLC

01 PROPOSED SECOND FLOOR PLAN

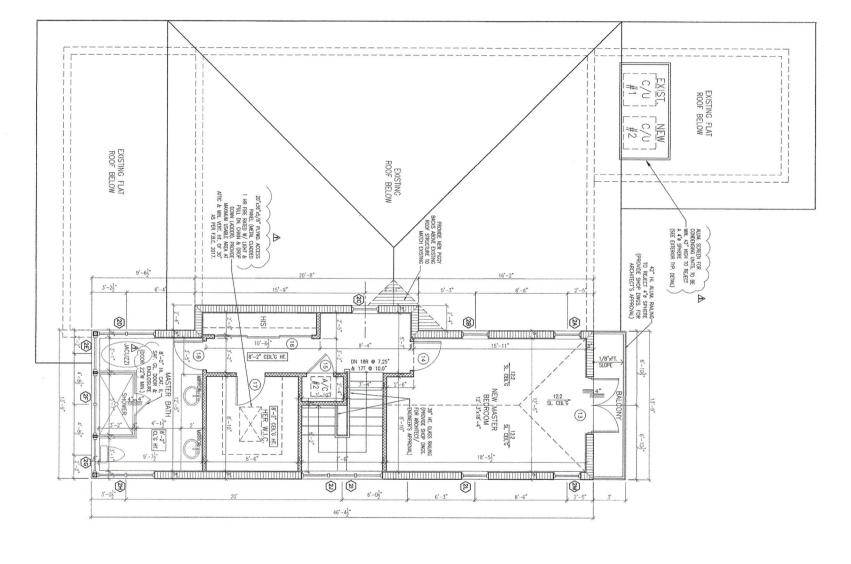

6. SHEET METAL ANGLES WITH 2 INCN LEGS FADRICATED FROM 2020'9 INCN (2031m) PINNY DAY THICKNESS GAAL VANIZED STEEL 1 THES 6 SCREUS IN INC. (2035m) PINNY DAY THICKNESS GAAL DE USED FOR ATTACHING THE IRROT LAYER OF WALLEDARD TO THE STEEL STUDS AND THE THIRD LAYER OF WALLEDARD TO THE STEEL STUDS AND THE THIRD LAYER OF WALLEDARD TO THE STEEL STUDS AND THE THIRD LAYER OF WALLEDARD TO THE STEEL STUDS AND THE STORY OF WALLEDARD TO THE STEEL STUDS AND THE STORY LAYER TO THE SHEET INFAL ANGLES AND THE STORY LAYER TO THE SHEET INFAL ANGLES AT IZ INCRESS (2025m) ON CENTER THESE SOCIETIES 21 I/A INCRESS (5125m) LONG SHALL BE USED FOR ATTACHING THE THIRD LAYER OF WALLEDARD TO THE STEEL STUDS AT IZ INCRESS (3025m) ON CENTER THE STUDS AT IZ INCRESS (3025m) ON CENTER CONTRACTIONS AND THE STEEL STUDS AT IZ INCRESS (3025m) ON CENTER 5. No. 18 SWG STEEL TIE WIRES SPACED 24 Inches (610 mm) ON CENTER. 3 TYPE X CYPSUM WALLBOARD IN ACCORDANCE WITH ASTY
C36 FOR SHALE LATER APPLICATIONS THE WALLBOARD

SHALL BE APPLIED MERICALLY WITH NO HORIZONTAL JOINTS
SHALL BE APPLIED MERICALLY WITH NO HORIZONTAL JOINTS
FOR THE LATER APPLICATIONS HORIZONTAL JOINTS ARE
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FOR THE DATA A MINIMATE SHALING SO FT. (3458m.)
FOR THE DATA THE JOINTS IN SUCCESSIVE LATERS ARE
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AND THE BASIS OF THE SPECIFIED FIRE RESISTANCE RATING
AND THE WEIGHT-TO-HEATED-PERITETER RATIO (WDD) OF THE
COLUMN. (1. STRUCTURAL STEEL COLUNN, EITHER WIDE FLANGE OR TUBLLAR 64 APERS. 2. 1 5/8 Inch (413mm) DEEP STUDS FABRICATED FROM ØØTTS Inch (646mm) MINTIM THICONESS GALVAN/IZED STEEL WITH 15/8 (-GAS 17/8 - Inch (336 OR 365mm) LEGS THE LENGTH OF THE ORE 17/8 - Inch (336 OR 365mm) LEGS THE LENGTH OF THE GTEEL STUDS SHALL BE (17 Inch (17.71mm) LESS THAN THE HEIGHT OF THE ASSETBLY. AS PER F.B.C. 2011, THE GYPSUM WALLBOARD SHALL
MPPORTED AS ILLUSTRATED IN FIGURE 109.5/C
FOR FIRE RESISTANCE RATINGS OF THREE (3) HOURS
OR LESS. 1 LAYER = 5/8' OR 1/2"

NOTE:
AS PER F.B.C. 2017, COMBUSTIBLE INSULATION SHALL
BE SEPARATED A MINMUM OF 3 INCHES (76mm) FROM
RECKSSED LIGHTING FIXTURES, FAN MOTORS AND OTHER
HEAT-PRODUCING DEVICES.


TERMITE NOTES:

AS PER F.B.C. 2017, A WEATHER-RESISTANT JOB-SITE POSTING BOARD SHALL BE PROVIDED TO RECEIVE DUPLICATE TREATMENT OF THE PROVIDED TO RECEIVE DUPLICATE TREATMENT IS CENTRICATED. APPROVIDED PROTECTIVE PREATMENT IS CENTRICATED. APPROVIDED AND CONTROL OF THE PERSON THE FEBRUARY DESIGNATION OF THE PROPERTY OF THE PROPERTY OF THE PROPERTY OF THE APPLICATION. THE AND DATE OF THE PROPERTY OF THE APPLICATION AND NUMBER OF CALLONIS USED, TO ESTABLISH A CHEMICAL BARBER METHOD TOR TERMITE PROPERTION IS USED, THAT WE ARREST METHOD TOR TERMITE PROPERTION IS USED, THAT WE ARREST METHOD TOR TERMITE PROPERTION IS USED, THAT WE ARREST METHOD TOR TERMITE PROPERTION IS USED, THAT WE ARREST METHOD TOR TERMITE PROPERTION IS USED, THAT WE ARREST METHOD TOR TERMITE PROPERTION IS USED, THAT WE ARREST METHOD TOR TERMITE PROPERTION IS USED, THAT WE ARREST METHOD TOR THE PROPERTION IS USED. THAT WE ARREST METHOD TOR THE PROPERTY OF THE PROPER AS PER F.B.C. 2017, A PERMANENT SIGN WHICH IDENTIFIES THE TERMITE TREATMENT PROVIDER AND NEED FOR REINSPECTION AND TREATMENT CONTRACT RENEWAL SHALL BE PROVIDED. THE SIGN SHALL BE POSTED NEAR THE WATER HEATER OR ELECTRIC PANEL

I LAS JURRINO 16° O.C., ONE LAYER 5/8" THE X OFFICIAL MUTH, 5d.
CENEMI-COLLEGE ON RANG SHANCO MULS 6° O.C. PARET THE EMPEDDO IN
CENETIONITIONS COMPANIO OREA JUNES, EDVENDO ME, THOSE COMPEND WITH
COMPANIA PARENE CAMES, DEVENDO ME, FESTE CONFEDE WITH COMPOUND AND
PROMPHAY PARENE CAMES, MERCHAL FOR SHANCO SHOW, MANUAL MICHAEL ORE
COMM. M. TERENDO MERCHAL MORO, OR CELLULOSIO NEGLATION MANNO A
MANUAL MISULATION MULTE OF RE-11. FIRE RATINGS DESCRIPTION

5040 SOUTHWEST FARD STREET SUITE 200 SOUTH MAMI, FLORIDA 73142 P 305 666 7789 WWW.CANDELAANDPARTNERS COM HILARIO F. CANDELA. FAIA MAURICE H. CANDELA. DESIGN CANDELA + PARTNERS, LLC
ARCHITECTURE + PLANNING + INTERPORE

GALVANIZED ØØ149 Inch (Ø318mm) MINIMUM THICKNESS STEEL
CRAIRE BELDS WITH I 1/2-Inch (38.1mm) LEGS ATTACHED TO THE
ALLEDARD WITH I INch (28.4mm) LOKG TYPE 9 SCREUS
PACED 12 Inches (3.05mm) ON CENTER

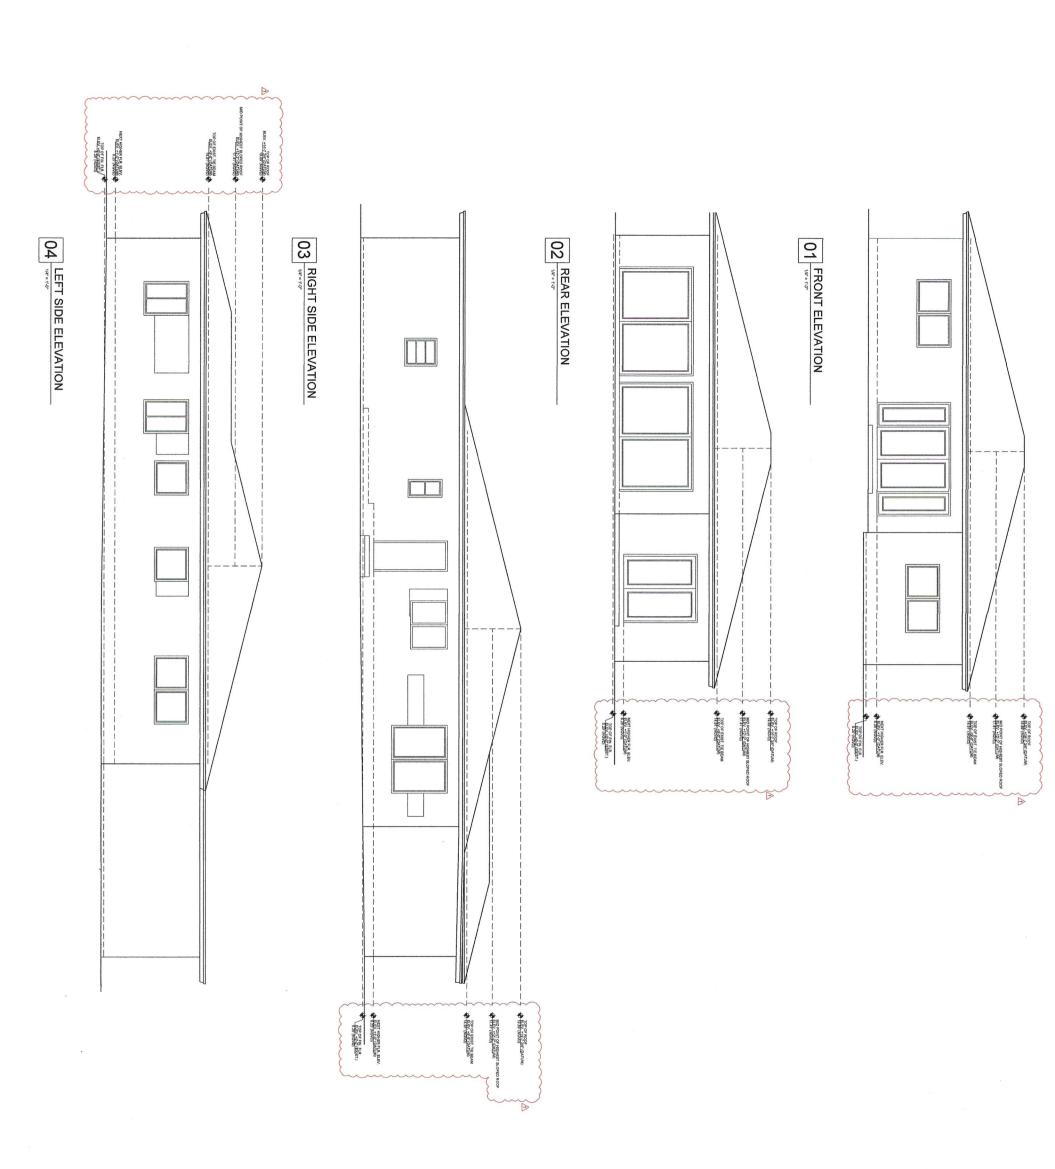

Conducted by: M.C.
Soulier Associative
Project Vizz R.18.1001

5/06/20


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consultant:

EXISTING ELEVATIONS 5 2 6 W 50th. Street MIAMI BEACH, Florida, 33140


B R U C K



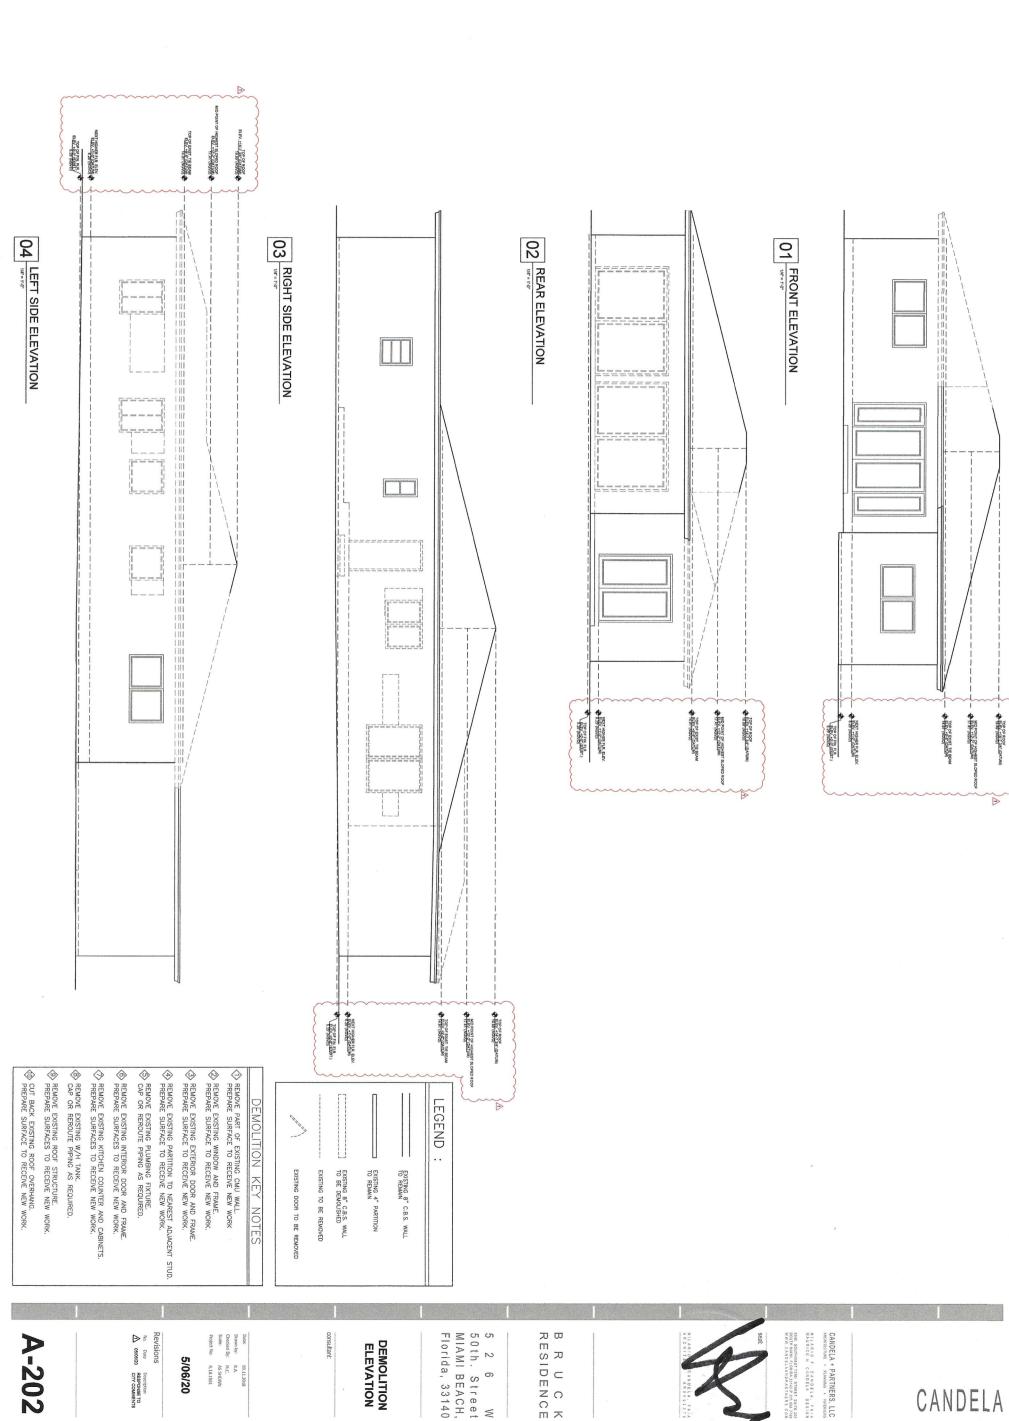

5 2 6 W 50th. Street MIAMI BEACH, Florida, 33140

RESIDENCE

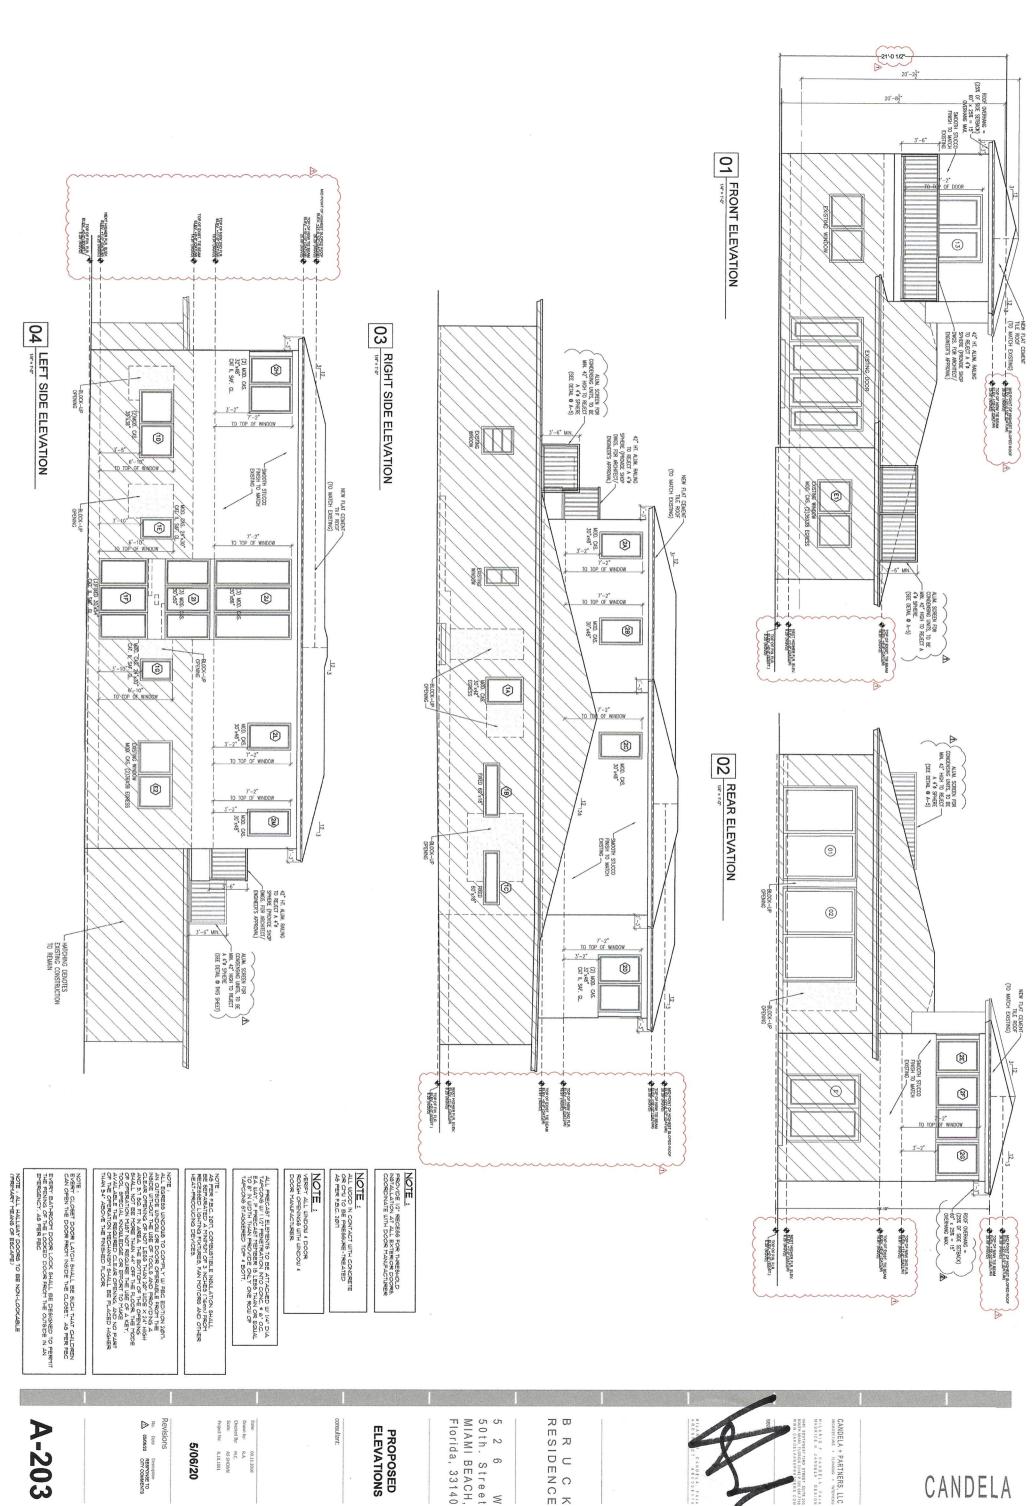

5/06/20

Date: 09.11.2018
Drawn by: R.A.
Checked By: M.C.
Scole: AS SHOWN
Project No: R.18.1001

50th. Street MIAMI BEACH, Florida, 33140

RESIDENCE

MAURICE H CANDELA DESIGN CANDELA + PARTNERS, LLC

02 PROPOSED SECTION ROOF OVERHANG =

(25% OF SIDE SETBACK)

60" x 25% = 15"

OVERHANG MAX. MID POINT OF HIGHEST & OP BEY, 471-6107 DATUM) TOP OF NEW TE BEAM BEY, 415-107 DATUM) NEXT HIGHER FUR. ELEV.

ELEV. *100 (DATUM)

TOP OF FIN. FUR.

ENG. 400 (DASSET)

ENG. 400 (DASSET) TOP OF EXIST, THE BEAM

FLEY 18:35 (DATUM) TOP OF NEW 2ND FLR.
FLEY-111-3" (DATUM)
18.91" (NUVD) MAX, HEIGHT ABOVE LOWEST ELEY, 127-0" (DATUM) 37.75" (NOVD)

NOTE : ALL HALLWAY DOORS TO BE NON-LOCKABLE (PRIMARY MEANS OF ESCAPE)

NOTE:
EVERY CLOSET DOOR LATCH SHALL BE SUCH THAT CHILDREN
CAN OPEN THE DOOR FROM INSIDE THE CLOSET. AS PER FBC

EVERY BATHROOM DOOR LOCK SHALL BE DESIGNED TO FERMIT THE FENN'S OF THE LOCKED DOOR FROM THE OUTSIDE IN AN EMERGENCY, AS PER FBC

Mo. Date Description
A 05/06/20 RESPONSE TO CITY COMMENTS

ANDRE WINDOWS TO COMPLY WIFEC EDITION 2011.
ALL EGGESS WINDOWS TO COMPLY WIFEC EDITION 2011.
AN OUTSIDE WINDOW OR DOOR OFFENALE READY THE
NOTE WINDOWS THE USE OF TOOLS AND PROVIDING A 24Y HIGH
ANDREW OFFENAL OFFENAL AND WINDOWS AND HIGH
ANDREWS TO THE DOOR THAN AND WINDOWS AND TOOLS
SHOULD KNOW FROM THE THE WINDOWS THAN TO MAKE
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OF THE OFFENAL NOW FROM THE OFFENAL AND NO PART
OF THE OFFENAL ON THE THINGHED FLOOR
THAN SAY ABOVE THE THINGHED FLOOR

Date: 09.11.2018
Drawn by: R.A.
Checked By: M.C.
Scale: AS SHOWN
Project No: R.18.1001 5/06/20

NOTE:
AS PER F.B.C. 2011, COMBUSTIBLE INSULATION SHALL
AS PER F.B.C. 2011, COMBUSTIBLE INSULATION SHALL
BE SEPARATED A MUNIMIM OF 3 NOHES ("Semi) FROM
RECESSED LIGHTING FIXTURES, FAN MOTORS AND OTHER
HEAT-PRODUCING DEVICES.

ALL, PRECAST ELETENTS TO BE ATTACHED WI (4" DIA, TAPCANS WI (1") PENETRATION NO CONC. 6" OC. BE AUXY, IF PRECAST PRINTERS IS LESS THAN OR BOAIAL, TO 8" IN JUD IT THAN PROVIDE DIALY ONE ROUL OF TAGGERED TOP 4 BOTT.

PROPOSED SECTION

NOTE:

PROVIDE 1/2' RECESS FOR THRESHOLD
NSTALLATION AT ALL EXTERIOR DOORS.
COORDINATE WITH DOOR MANUFACTURER


5 2 6 W 50th. Street MIAMI BEACH, Florida, 33140


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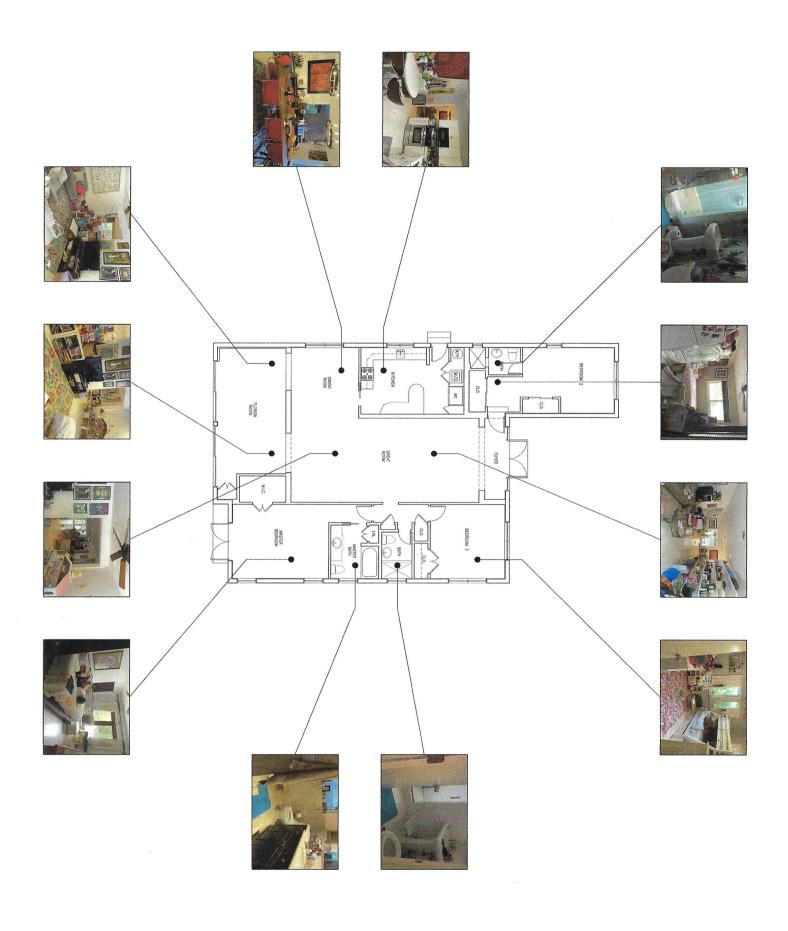


CANDELA + PARTNERS, LLC

HILARIO F CANDELA, FALA MAURICE H CANDELA DESIGN



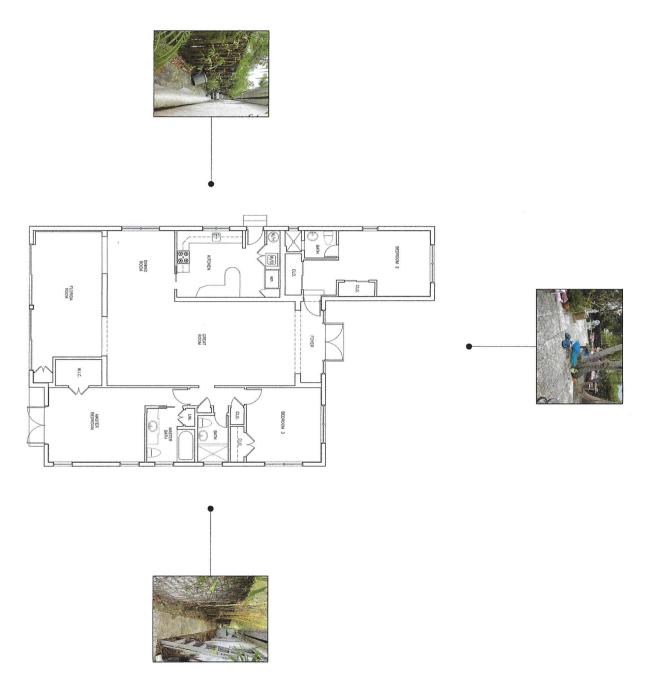

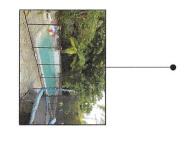


4/20/20

PHOTOGRAPHS INTERIOR

5 2 6 W 50th. Street MIAMI BEACH, Florida, 33140

B R U C K



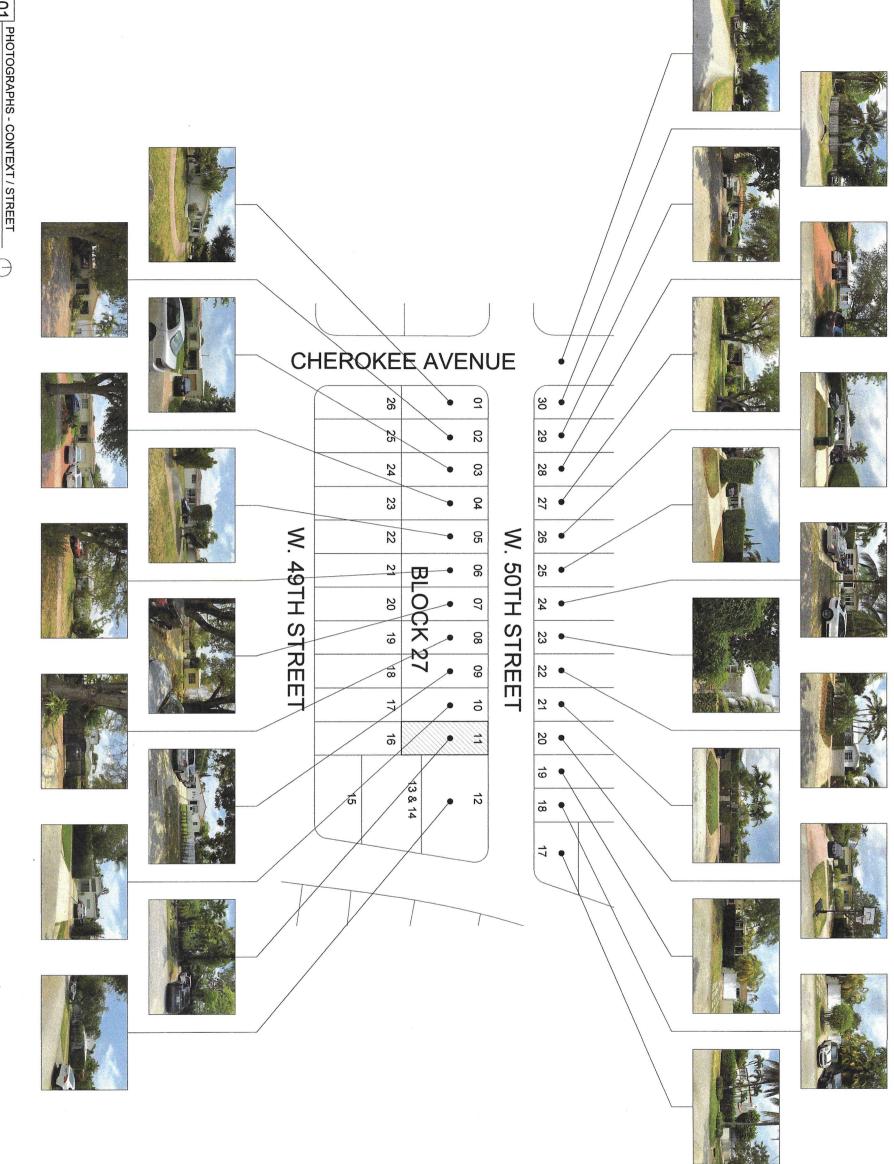

4/20/20

PHOTOGRAPHS CONTEXT/ STREET

5 2 6 W 50th. Street MIAMI BEACH, Florida, 33140

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