
1910 ALTON ROAD

1910 ALTON ROAD MIAMI BEACH, FL 33139

PLANNING BOARD FINAL SUBMITTAL - APRIL 27TH, 2020

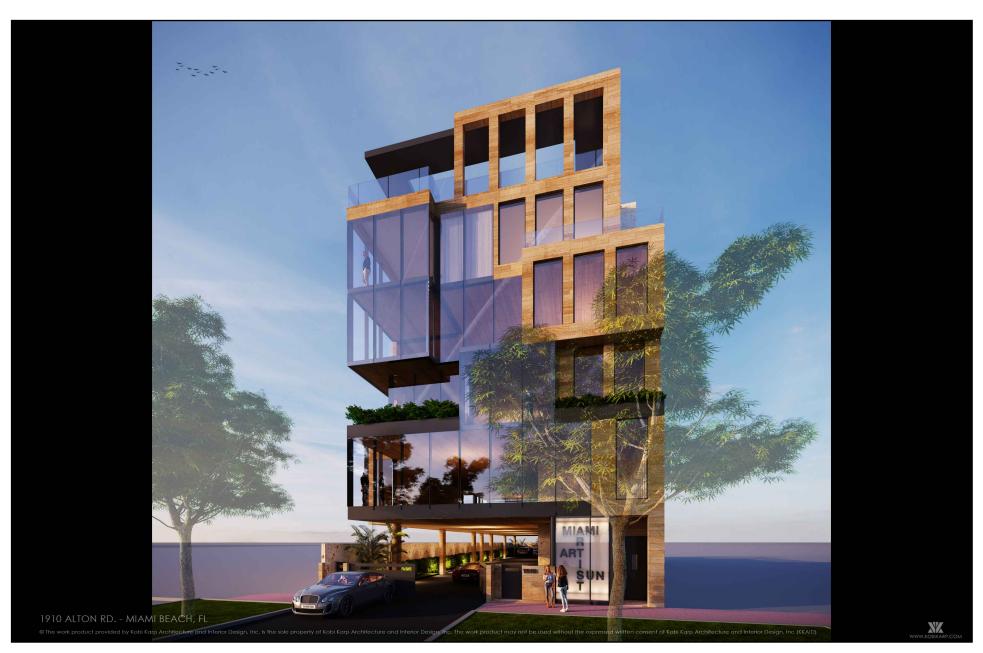

ARCHITECT KOBI KARP ARCHITECTURE AND INTERIOR DESIGN, INC.

> 2915 BISCAYNE BLVD. SUITE 200 MIAMI, FLORIDA 33137 T: 305.573.1818

-	Rev.	Date	Rev.	Date
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PLANNING BOARD

PB20-0357 FINAL SUBMITTAL

MIXED USE - COMMERCIAL -OFFICE - RESIDENCE 1910 ALTON ROAD MIAMI BEACH, FLORIDA 33139

Owner:

Consultant: LANDSCAPE ARCHITECT

Name CHRISTOPHER CAWLEY

Address 780 NF 69th STREFT

ress Suite #1106 Tel: (786) 536-2961

Consultar Name Address Address

Consultant:

lame Address Address el:

Architect of Record

Kobi Karp Architecture and Int 2915 Biscayne Boulevard, Sui Miami, Florida 33137 USA Tel: +1(305) 573 1818







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Date	04-27-2020	Sheet No.
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	CD-2 COMMERCIAL MEDIUM INTENSITY DISTRICT - ZONING DATA SHEET					
ITEM #	ZONING INFORMATION					
1	ADDRESS: 1910 ALTON RD., MIAMI BEACH, FL 33139					
2	FOLIO NUMBER(S):	02-3233-022-0020				
3	BOARD AND FILE NUMBERS:	N/A				
4	YEAR BUILT:	1935	ZONING DISTRICT:		CD-2 (COMMERCIAL MEDIUM INTENSITY)	
5	BASE FLOOD ELEVATION:	8'-0" NGVD	FUTURE GRADE VALUE IN NGVD :		N/A	
6	GRADE:	3.99' NGVD	ADJUSTED GRADE:		N/A	
7	LOT AREA:	8,000 SF	HEIGHT OF FIRST FLOOR:		+5.00' N.G.V.D.	
8	LOT WIDTH:	50'-0"	LOT DEPTH:		160'-0"	
9	PROPOSED GROUND FLOOR F.A.R.:	689 SF (4.31%)				
10	PROPOSED SECOND FLOOR ART GALLERY RETAIL 1 F.A.R.:	3,479 SF (21.74%)				
11	PROPOSED SECOND FLOOR ART GALLERY RETAIL 2 F.A.R.:	431 SF (2.69%)				
12	PROPOSED THIRD FLOOR OFFICE F.A.R.:	3,526 SF (22.04%)				
13	PROPOSED FOURTH FLOOR OFFICE F.A.R.:	3,670 SF (22.93%)				
14	PROPOSED FIFTH FLOOR RESIDENTIAL F.A.R.:	3,682 SF (23.01%)				
15	PROPOSED ROOFTOP RESIDENTIAL F.A.R.:	520 SF (3.25%)				
16	TOTAL BUILDING F.A.R.:	15,997 SF				
		ALLOWED	EXISTING	PROPOSED	DEFICIENCIES VARIANCE #1 : TO REDUCE THE REQUIRED	
17	HEIGHT:	50'-0"	N/A	53'-0"	CLEARANCE FOR PARKING AT GROUND FLOOR LEVEL BELOW THE FIRST HABITABLE LEVEL 12 FEET REQUIRED (FROM BFE+1). 8 FEET PROVIDED VARIANCE #2: TO EXCEED BY 3'-0" THE MAXIMUM ALLOWABLE HEIGHT. 50 FEET REQUIRED. 53 FEET PROVIDED	
18	SETBACKS:					
	FRONT AT GRADE PARKING:	5'-0" AT-GRADE PARKING	N/A	73'-0"	NONE	
	FRONT PEDESTAL AND TOWER:	0'-0"	N/A	0'-0"	NONE	
19	SIDE 1: NORTH	0'-0" (5'-0" AT-GRADE PARKING)	N/A	5'-0" AT GRADE PARKING	NONE	
20	SIDE 2: SOUTH	0'-0" (5'-0" AT-GRADE PARKING)	N/A	5'-0" AT GRADE PARKING	NONE	
21	REAR:	5'-0"	N/A	5'-0"	NONE	
22	ACCESSORY STRUCTURE REAR:	N/A	N/A	N/A	NONE	
23	SUM OF SIDE YARD:	N/A	N/A	5'-0"	NONE	
24	LOCATED WITHIN A LOCAL HISTORIC DISTRICT):		NO			
25	DESIGNATED AS AN INDIVIDUAL HISTORIC SINGLE FAMILY RESIDENCE SITE?		NO			
26	DETERMINED TO BE ARCHITECTURALLY SIGNIFICANT?		NO			
27	PROPOSED ENCROACHMENT IN REAR YARD			0'-0"	NONE	
				0'-0"	NONE	
28	PROPOSED ENCROACHMENT IN WEST SIDE YARD			0'-0"	NONE	
29	PROPOSED ENCROACHMENT IN EAST SIDE YARD	0.4421.000			VARIANCE #3: TO REDUCE THE REQUIRED	
30	LOADING SPACE REQUIREMENT	2 (10'x20')	N/A	2 (10'x20')	TWO-WAY DRIVEWAY UP TO 11 FEET.	
PROJE	TIS LOCATED IN PARKING DISTRICT no. 5 - SUNSET HARBOUR NEIGHBORHOOD					

- PARKING REQUIREMENT WITHOUT PARKING INCENTIVES:

 REQUIRED PARKING: 2 SPACES FOR RESIDENTIAL

 RETAIL SF = 3,500 + 36 + 339 + = 0 SPACE + 375/300 = 2 SPACES
- OFFICE SF = 3,461 + 3,607 = 7,068 / 400 = 18 SPACES
 22 SPACES TOTAL REQUIRED

PARKING REQUIREMENT WITH PARKING INCENTIVES:

- REQUIRED PARKING: 2 SPACES FOR RESIDENTIAL
 RETAIL SF = 3,500 + 36 + 339 + = 0 SPACE + 375/300 = 2 SPACES
 OFFICE SF = 3,461 + 3,607 = 7,068 / 400 = 18 SPACES 50% WITH ALTERNATIVE PARKING REDUCTION SYSTEM = 9 SPACES
- 13 SPACES TOTAL REQUIRED

- PARKING PROVIDED
 PROVIDED PARKING: 2 SPACES FOR RESIDENTIAL
- RETAIL SF = 3,500 + 36 + 339 = 2 SPACES
- OFFICE SF = 3,461 + 3,607 = 7,068 / 400 = 18 SPACES 50% WITH ALTERNATIVE PARKING REDUCTION SYSTEM = 9 SPACES
 15 SPACES TOTAL PARKING PROVIDED WITH LIFTS

NOTES: IF NOT APPLICABLE WRITE N/A
3 SHOWERS = 6 PARKING SPACES REDUCTION PER SECS. 130-40. (a) - ALTERNATIVE PARKING INCENTIVES.

15 LONGTERM BICYCLE SPACES = 3 PARKING SPACES REDUCTION PER SECS. 130-40. (f) - ALTERNATIVE PARKING INCENTIVES.

PROJECT WILL NEED CUP APPROVAL FOR INCORPORATION OF MECHANICAL LIFTS.

LEGAL DESCRIPTION:
LOT 2, BLOCK 12-A, OF ISLAND VIEW ADDITION, ACCORDING TO THE PLAT THEREOF AS RECORDED IN PLAT BOOK 2 AT PAGE 144, OF THE PUBLIC RECORDS OF MIAMI-DADE COUNTY, FLORIDA.

NOTHING SHALL BE ERECTED, PLACED, PARKED, PLANTED, OR ALLOWED TO GROW IN SUCH A MANNER WITHIN A 15'-0" TRIANGLE OF VISIBILITY SO AS TO MATERIALLY IMPEDE VISION BETWEEN A HEIGHT OF 2'-0" AND 6'-0" ABOVE GRADE (3.99" N.G.V.D.)

THE SIDE OF THE PROPERTY SHALL BE GRADED IN A MANNER TO RETAIN ALL
RAINWATER ON THE PROPERTY WITH THE USE OF INTERCEPTOR SWALES AROUND THE PERIMETER OF THE SITE WITH NO ENCROACHMENT OVER ADJACENT PROPERTIES AND THE AREA ADJACENT TO THE CANAL WILL BE GRADED TO PREVENT DIRECT OVERLAND DISCHARGE OF STORMWATER INTO THE CANAL

SHEET IUMBER	SHEET NAME
A0.00	ARCHITECTURAL DRAWINGS COVER
A0.01	PROJECT DATA / DRAWING INDEX & GENERAL NOTES
A0.02	SURVEY
A0.02	LOCATION MAP
A0.03	EXISTING BUILDING IMAGES
A0.04	SITE CONTEXT IMAGES
A0.05	ZONING DIAGRAMS - F.A.R.
A0.06	ZONING DIAGRAMS - F.A.R.
A0.07	ZONING DIAGRAMS - F.A.R.
A0.08	AXONOMETRIC RENDERING
A0.09	AXONOMETRIC RENDERING
A0.10	AXONOMETRIC RENDERING
A0.11	AXONOMETRIC RENDERING
A0.12	ZONING LOADING VARIANCE DIAGRAM
A2.00	SITE PLAN
A3.01	GROUND FLOOR PLAN WITH LIFTS
A3.01b	ALTERNATE GROUND FLOOR PLAN WITHOUT LIFTS
A3.02	SECOND FLOOR PLAN
A3.03	THIRD FLOOR PLAN
A3.04	
A3.05	FOURTH FLOOR PLAN
A3.06	FIFTH FLOOR PLAN
A4.00	ROOF PLAN
A4.00	FRONT ELEVATION (EAST)
A4.02	REAR ELEVATION (WEST)
A4.03	SIDE ELEVATION (SOUTH) SIDE ELEVATION (NORTH)
A4.04	
	CONTEXTUAL ELEVATIONS
A4.05	FRONT RENDERED ELEVATION (EAST)
A4.06 A4.07	REAR RENDERED ELEVATION (WEST)
	SIDE RENDERED ELEVATION (SOUTH)
A4.08	SIDE RENDERED ELEVATION (NORTH)
A5.00	SECTION
A5.01	SECTION
A5.02	SECTION
A5.03	ENLARGED SECTIONS
A5.04	ENLARGED SECTIONS
A5.05	ENLARGED SECTIONS
A5.06	ENLARGED SECTIONS / DETAILS
A5.07	ALTERNATE SECTION WITH (AS OF RIGHT) (FOR REFERENCE
A6.00	RENDERING
A6.01	RENDERING
A6.02	RENDERING
A6.03	RENDERING

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PLANNING BOARD

PB20-0357 FINAL SUBMITTAL

MIXED USE - COMMERCIAL -OFFICE - RESIDENCE 1910 ALTON ROAD MIAMI BEACH, FLORIDA 33139

Consultant: LANDSCAPE ARCHITECT CHRISTOPHER CAWLEY 780 NE 69th STREET Suite #1106 Tel: (786) 536-2961

Consultant Name Address Address Tel: Email


Architect of Record:
Kobi Karp Architecture and Interior Design, Inc.
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Tel: +1(305) 573 3766





DATA SHEET

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GRAPHIC SCALE

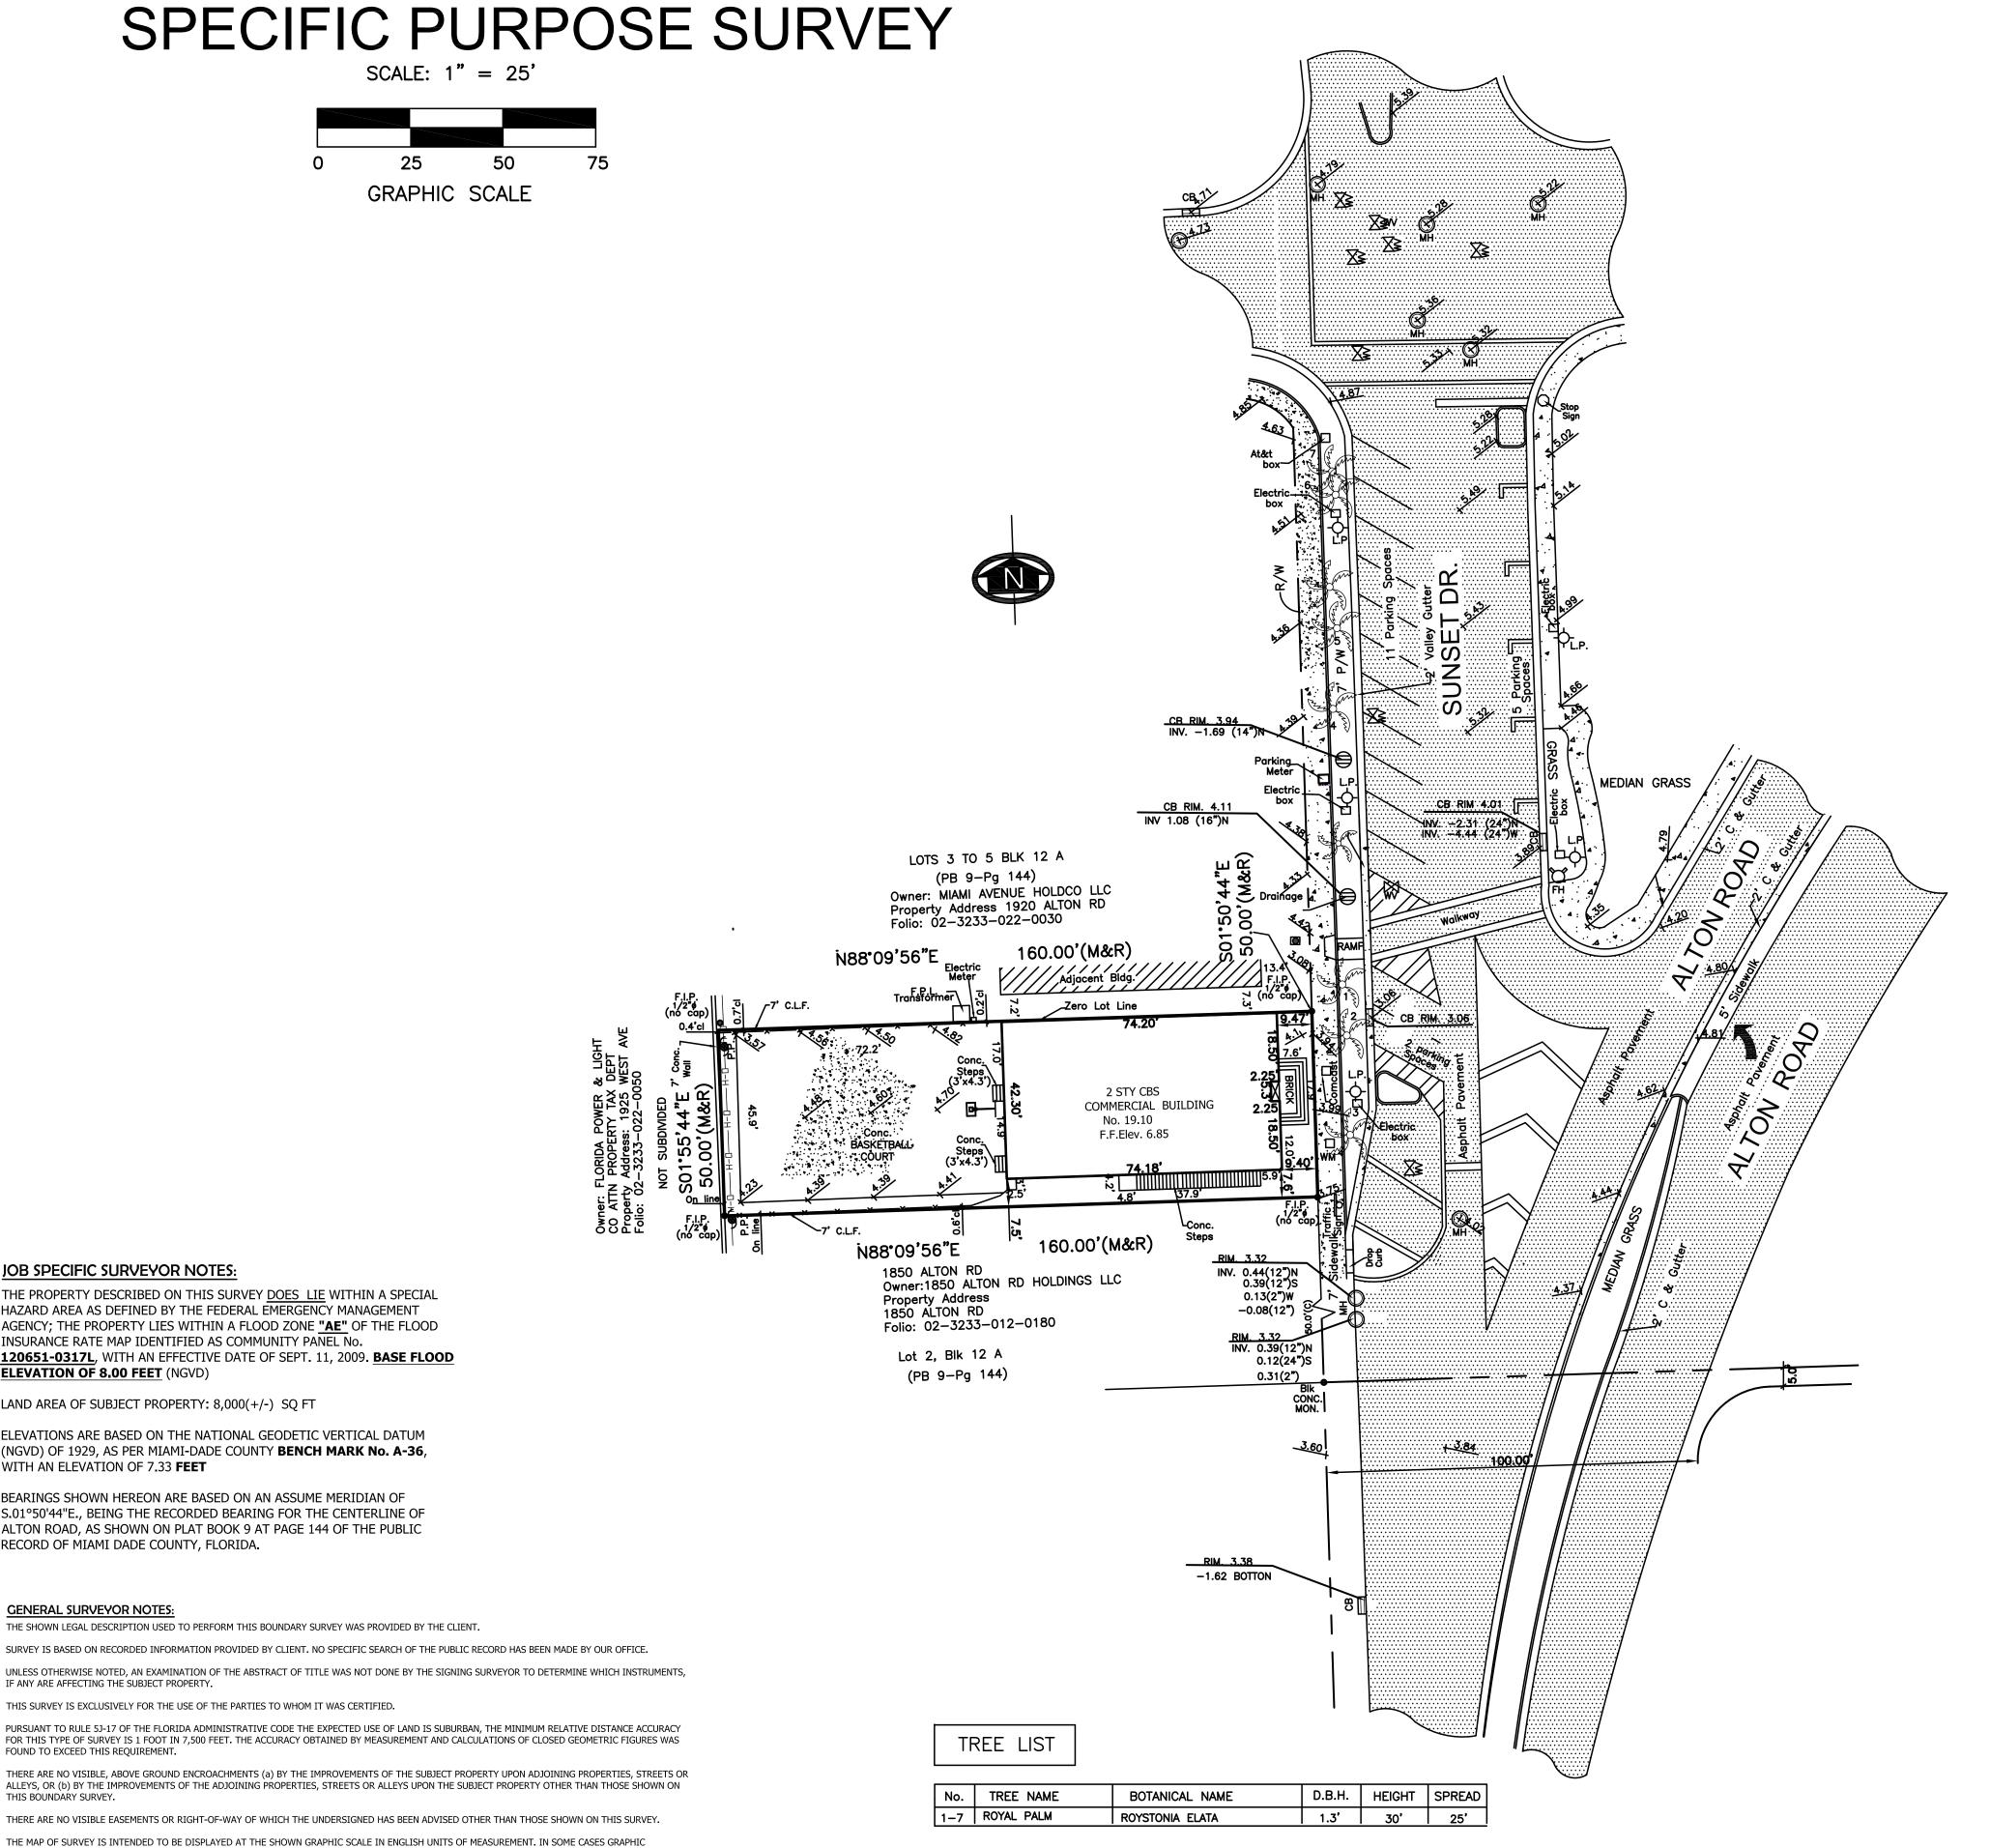JOB SPECIFIC SURVEYOR NOTES:

ELEVATION OF 8.00 FEET (NGVD)

WITH AN ELEVATION OF 7.33 **FEET**

RECORD OF MIAMI DADE COUNTY, FLORIDA.

IF ANY ARE AFFECTING THE SUBJECT PROPERTY.

1 THE PROPERTY DESCRIBED ON THIS SURVEY DOES LIE WITHIN A SPECIAL

INSURANCE RATE MAP IDENTIFIED AS COMMUNITY PANEL No.

② LAND AREA OF SUBJECT PROPERTY: 8,000(+/-) SQ FT

HAZARD AREA AS DEFINED BY THE FEDERAL EMERGENCY MANAGEMENT

ELEVATIONS ARE BASED ON THE NATIONAL GEODETIC VERTICAL DATUM (3) (NGVD) OF 1929, AS PER MIAMI-DADE COUNTY BENCH MARK No. A-36,

BEARINGS SHOWN HEREON ARE BASED ON AN ASSUME MERIDIAN OF

(4) S.01°50'44"E., BEING THE RECORDED BEARING FOR THE CENTERLINE OF

THIS SURVEY IS EXCLUSIVELY FOR THE USE OF THE PARTIES TO WHOM IT WAS CERTIFIED.

ALTON ROAD, AS SHOWN ON PLAT BOOK 9 AT PAGE 144 OF THE PUBLIC

THE SHOWN LEGAL DESCRIPTION USED TO PERFORM THIS BOUNDARY SURVEY WAS PROVIDED BY THE CLIENT.

REPRESENTATION HAVE BEEN EXAGERATED TO MORE CLEARLY ILLUSTRATE A PARTICULAR AREA WHERE DIMENSIONS SHALL HAVE PREFERENCE OVER GRAPHIC

THE ELEVATIONS (IF ANY) OF WELL-IDENTIFIED FEATURES AS DEPICTED ON THIS SURVEY AND MAP WERE MEASURED TO AN ESTIMATED VERTICAL POSITIONAL ACCURACY OF $\cancel{1}_{10}$ FOOT FOR NATURAL GROUND SURFACES AND $\cancel{1}_{100}$ FOOT FOR HARDSCAPE SURFACES, INCLUDING PAVEMENT, CURBS, SIDEWALKS AND OTHER

THE SURVEYOR MAKES NO REPRESENTATION AS TO OWNERSHIP, POSSESSION OR OCCUPATION OF THE SUBJECT PROPERTY BY ANY ENTITY OR INDIVIDUAL.

ANY FEMA FLOOD ZONE INFORMATION PROVIDED ON THIS SURVEY IS FOR INFORMATIONAL PURPOSE ONLY AND IT WAS OBTAINED AT WWW.FEMA.COM.

IF YOU ARE READING THIS BOUNDARY SURVEY IN AN ELECTRONIC FORMAT, THE INFORMATION CONTAINED ON THIS DOCUMENT IS ONLY VALID IF THIS DOCUMENT IS ELECTRONICALLY SIGNED AS SPECIFIED IN CHAPTER 5J-17.062 (3) OF THE FLORIDA ADMINISTRATIVE CODE. IF THIS DOCUMENT IS IN PAPER FORMAT, IT IS NOT VALID WITHOUT THE SIGNATURE AND ORIGINAL RAISED SEAL OF THE PROFESSIONAL LAND SURVEYOR AND MAPPER OF RECORD.

AGENCY; THE PROPERTY LIES WITHIN A FLOOD ZONE **"AE"** OF THE FLOOD


120651-0317L, WITH AN EFFECTIVE DATE OF SEPT. 11, 2009. **BASE FLOOD**

LOT 2, BLOCK 12-A, OF ISLAND VIEW ADDITION, ACCORDING TO THE PLAT THEREOF AS RECORDED IN PLAT BOOK 9 AT PAGE 144, OF THE PUBLIC RECORDS OF MIAMI-DADE COUNTY, FLORIDA.


MONUMENT
P.T. = POINT OF TANGENCY
RAD. = RADIAL
REC. (R) = RECORDED
RES. = RESIDENCE
R/W = RIGHT OF WAY
SEC. = SECTION
S.D/H = SET DRILL HOLE
S.N/D = SET NAIL AND DISC
S.I.P. = SET IRON PIPE
S.R.B. = SET REBAR
STY = STORY
SWK. = SIDEWALK
T.O.P. = TOP OF BANK
U.E. = UTIL. EASEMENT
W.P. = WOODEN POLE

€ = SECTION LINE

LOCATION MAP

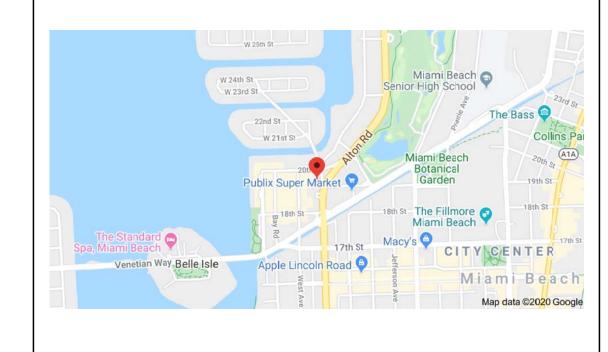

SITE PHOTO

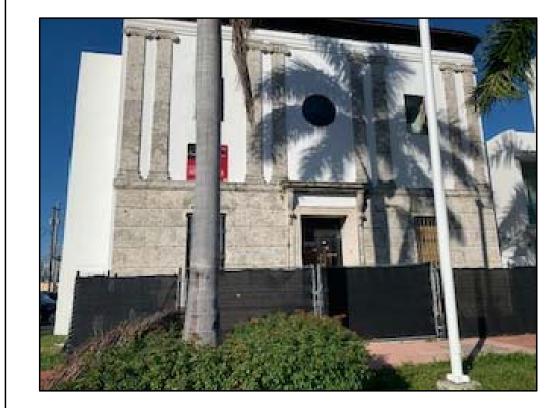


SURVEY CERTIFICATION: TODD GLASER

SITE ADDRESS: 1910 ALTON ROAD MIAMI BEACH, FL 33139 JOB NUMBER: 20-108 DATE OF SURVEY: JANUARY 7, 2020 FOLIO NUMBER: 02-3233-022-0020

THIS DRAWING IS THE PROPERTY OF AMERICAN SERVICES OF MIAMI, CORP. AND SHALL NOT BE USED OR REPRODUCED, IN WHOLE, OR IN PART, WITHOUT PERMISSION OF AMERICAN SERVICES OF MIAMI, CORP.

NOTHING HEREON SHALL BE CONSTRUED TO GIVE ANY RIGHTS OR BENEFITS TO ANYONE OTHER THAN THOSE CERTIFIED.

WE HEREBY CERTIFY THAT THIS "SPECIFIC PURPOSE" RESULTING THEREFROM WAS PERFORMED UNDER MY SUPERVISION AND/OR DIRECTION AND IS TRUE AND CORRECT TO THE BEST OF MY KNOWLEDGE AND BELIEF AND FURTHER, THAT SAID "ALTA SURVEY" MEETS THE INTENT OF THE APPLICABLE PROVISIONS OF THE "STANDARDS OF PRACTICE FOR LAND SURVEYING IN THE STATE OF FLORIDA", PURSUANT TO RULE 5J-17 OF THE FLORIDA ADMINISTRATIVE CODE AND ITS IMPLEMENTING LAW, CHAPTER 472.027 FOR THE FLORIDA STATUTES.

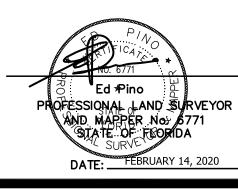



PB20-0357 FINAL SUBMITTAL

MIAMI BEACH, FLORIDA 33139

MIXED USE - COMMERCIAL - OFFICE - RESIDENCE 1910 ALTON ROAD

Consultant: LANDSCAPE ARCHITECT
Name CHRISTOPHER CAWLEY
Address 780 NE 69th STREET
Address Suite #1106
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Architect of Record:
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Fax: +1(305) 573 3766





LOCATION MAP PROPOSED DESIGN

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SITE IMAGE 1

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PB20-0357 FINAL SUBMITTAL

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MIXED USE - COMMERCIAL - OFFICE - RESIDENCE 1910 ALTON ROAD MIAMI BEACH, FLORIDA 33139





Consultant: LANDSCAPE ARCHITECT
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CONTEXT IMAGES PROPOSED DESIGN

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MIXED USE - COMMERCIAL -OFFICE - RESIDENCE 1910 ALTON ROAD MIAMI BEACH, FLORIDA 33139





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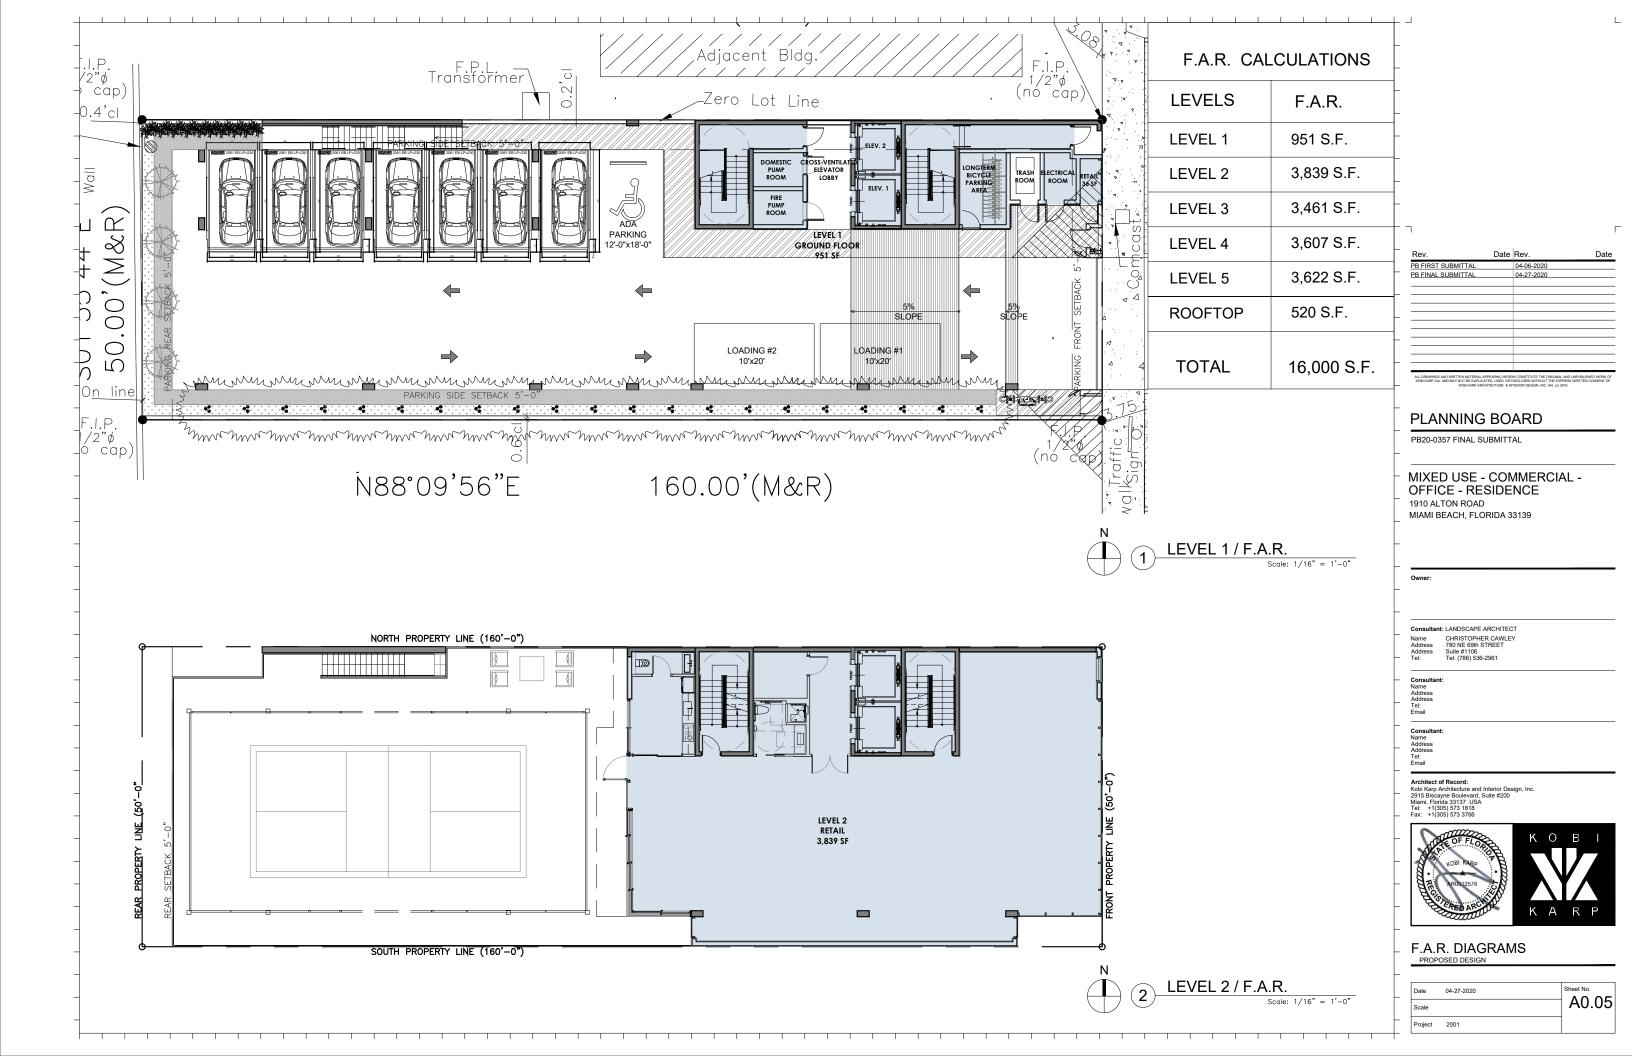
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CONTEXT IMAGES PROPOSED DESIGN

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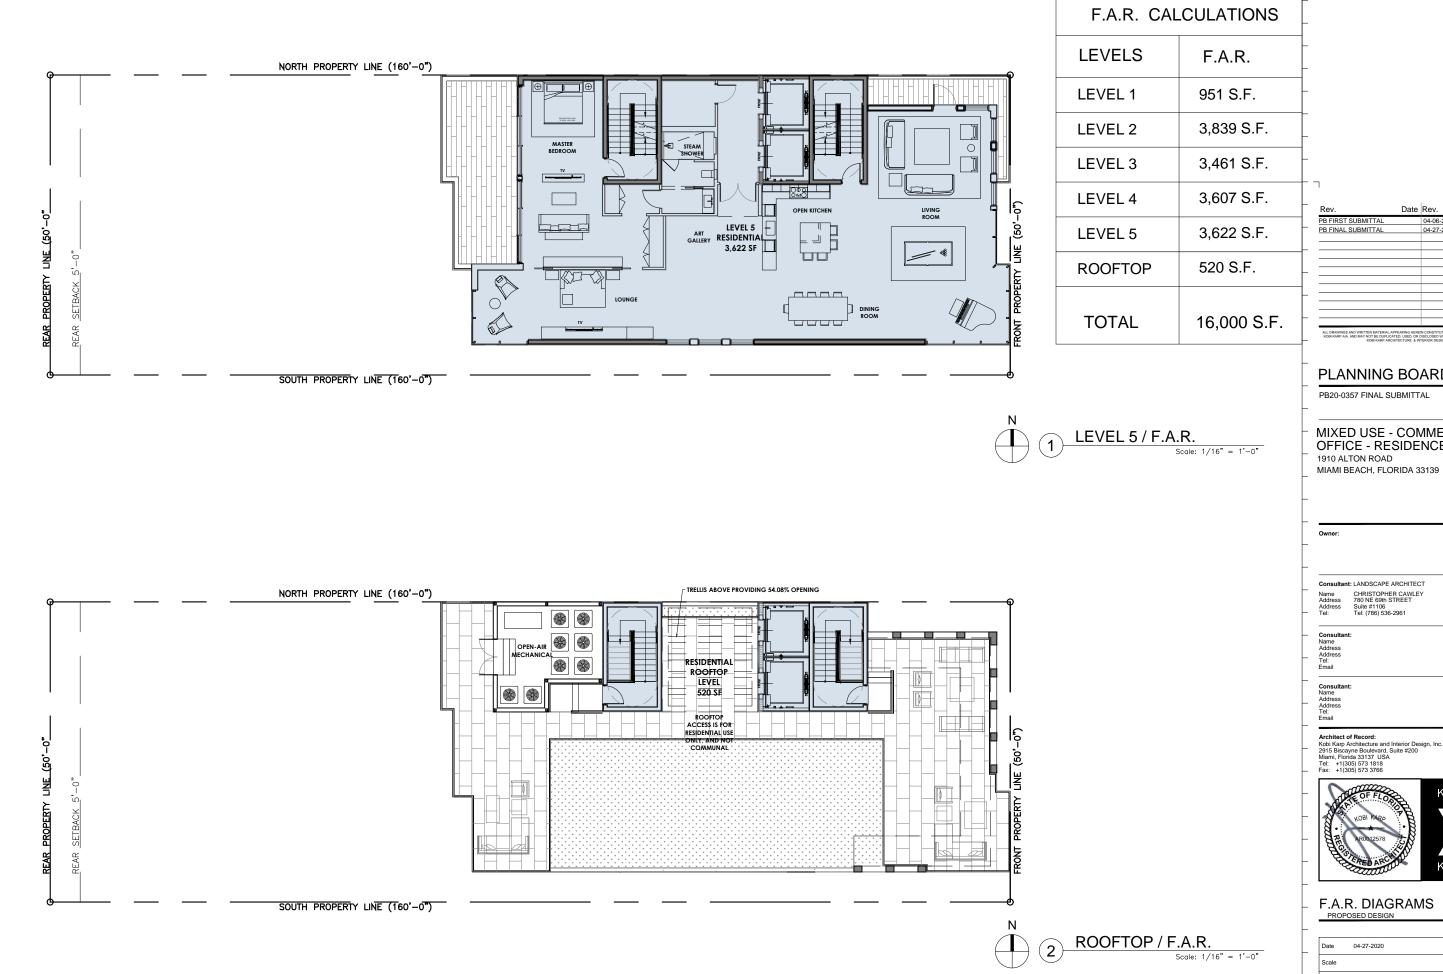
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F.A.R. DIAGRAMS

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PLANNING BOARD

PB20-0357 FINAL SUBMITTAL

MIXED USE - COMMERCIAL -OFFICE - RESIDENCE 1910 ALTON ROAD

Consultant: LANDSCAPE ARCHITECT

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F.A.R. DIAGRAMS

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PB20-0357 FINAL SUBMITTAL

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Consultant: LANDSCAPE ARCHITECT
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Address Suite #1106
Tel: (786) 536-2961

S.E. AXONOMETRIC

Scale: N.T.S.





Date Scale	04-27-2020	Sheet No. A0.08
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N.E. AXONOMETRIC







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N.W. AXONOMETRIC





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S.W. AXONOMETRIC

Scale: N.T.S.





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