

Work Order Signature Document

	NJPA EZIQC Contrac	t No.: FL-SEA-GC	01-041019-HBC	
	X New Work Order	Modify an Ex	kisting Work Order	
Work Order Numbe	er.: 077746.00	Work Order Date:	04/03/2020	
Work Order Title:	Screen Wall at Sunset Harbour P	ump Station No. 3		
Owner Name:	City of Miami Beach	Contractor Name:	Harbour Construction, Inc.	
Contact:	Colette Satchell	Contact:	Guy Lesseur	
Phone:	305-673-7071 x26401	Phone:	305.603.9944	
	Work to h	e Performed		
-	ped as per the Final Detailed Scope of No. FL-SEA-GC01-041019-HBC.		per the terms and conditions of NJPA	
Brief Work Order D	escription:			
	at the Pump Station #3 located in Sunsasphalt area adjacent to the pump.	set Harbor, removal ar	nd replacement of the traffic barrier and	
Time of Performa	Estimated Start Date: Estimated Completion Dat	e:		
Liquidated Dama		Will not apply:	X	
Work Order Firm	Fixed Price: \$749,251.00		_	
Owner Purcha	se Order Number:			
Approvals				
Jimmy Morales, Cit	y Manager [Date Contracto	r	Date
David Martinez, P.E	E., CIP Director D	Date Date		

Work Order Signature Document Page 1 of 1



Detailed Scope of Work

То:	Guy Lesseur Harbour Constru	action, Inc.	rom:	Colette Satchell City of Miami Beach						
	7340 SW 48th S Miami, FL 33155 305.603.9944			1700 Convention Center Drive Miami Beach, FL 33139 305-673-7071 x26401						
Date	Printed:	April 03, 2020								
Work	Order Number:	077746.00								
Work	Order Title:	Screen Wall at Sunset Harbour Pump Station N	No. 3							
Brief	Scope:	Screen installation at the Pump Station #3 local replacement of the traffic barrier and mill and repump.								
	Prelimina	ry Revised		X Final						
	•	all the scope of work as discussed at the site. All a considered part of this scope of work.	require	ements necessary to accomplish the items						
	·	ed in the attached 100% drawings prepared by E Sheets Cover page, A-000 - A-003, S-001 - S-00								
Subje	ect to the terms and	d conditions of JOC Contract FL-SEA-GC01-0410)19-HE	3C.						
Contr	actor	Da	ate	_						
Jimm	y Morales, City Ma	nager Da	ate	_						
David Martinez, P.E., CIP Director			ıte	_						

Scope of Work Page 1 of 1

Contractor's Price Proposal - Summary

Date: April 03, 2020

Re: IQC Master Contract #: FL-SEA-GC01-041019-HBC

Work Order #:

077746.00

Owner PO #:

Title: Screen Wall at Sunset Harbour Pump Station No. 3

Contractor: Harbour Construction, Inc.

Proposal Value: \$749,251.00

Asphalt	\$46,986.95
Bomar Industries	\$398,465.50
Concrete	\$53,085.24
Concrete Demo	\$7,374.23
Electrical	\$15,376.17
General Conditions	\$225,784.46
Planter	\$2,178.44
Proposal Total	\$749,251.00

ThisI total represents the correct total for the proposal. Any discrepancy between line totals, sub-totals and the proposal total is due to rounding.

The Percentage of NPP on this Proposal: 53.18%

Contractor's Price Proposal - Detail

Date: April 03, 2020

Re: IQC Master Contract #: FL-SEA-GC01-041019-HBC

Work Order #:

077746.00

Owner PO #:

Title: Screen Wall at Sunset Harbour Pump Station No. 3

Contractor: Harbour Construction, Inc.

Proposal Value: \$749,251.00

	Sect.	Item	Mod.	UOM	Description							Line Total
Labor	Equip.	Material	(Excludes)									
Asph	alt											
1	01 22 20	00 0065		HR	Flagperson	For Traffic	Control					\$10,043.42
				Installati	ion	Quantity 250.00	x	Unit Price 37.16	x	Factor 1.0811 =	Total 10,043.42	
2	01 71 13	3 00 0003		EA	Trailer With equipment, transporting hydraulic ex constructior constructior telescoping	Up To 53' E off loading away. For ccavators, g loaders, tr forklifts, te	BedInclud on site, ri equipme radalls, r actors, pa lescoping		own of equity of the second of	or scrapers, oes, heavy duty ers, straight mast ruction forklifts,	Total 12,439.29	\$12,439.29
				(3 times	s)millinng mac	hine, aspha	It placem	ent machine, bob	cat, swee	eper, roller		
3	01 71 13	3 00 0003		EA	Trailer With equipment, transporting hydraulic exconstruction construction	Up To 53' E off loading away. For ccavators, g loaders, tr forklifts, te	BedInclud on site, ri equipme radalls, r actors, pa lescoping		own of equity of the second of	or scrapers, oes, heavy duty ers, straight mast ruction forklifts,		\$1,382.14
				Installati	ion	Quantity		Unit Price		Factor	Total	
				Installati		2.00	Х	639.23	Х	1.0811 =	1,382.14	
					Mobilization							
4	02 41 13	3 13 0020		SY	>3" To 6" By	y Machine,	Break-up	And Remove Bite	uminous I	Paving		\$1,341.92
				Installati	ion	Quantity 125.00	х	Unit Price 9.93	x	Factor 1.0811 =	Total 1,341.92	
5	02 41 19	13 0070		EA Installati 3 times	less than th be used in o	e minimum	charge, ı	-	usively. T	cutting charge is his task should not Factor 1.0811	Total 1,756.38	\$1,756.38
6	32 01 16	3 71 0008		SY	Up To 3" De	epth, Limited	d Cold Mi	lling Of Asphalt				\$21,000.37
				Installati	·	Quantity 1,250.00	x	Unit Price 15.54	x	Factor 1.0811 =	Total 21,000.37	. ,522.01
7	32 01 16	71 0008	0021	MOD	For >1,000,	Deduct						-\$15,757.03
				Installati	ion	Quantity 1,250.00	x	Unit Price -11.66	x	Factor 1.0811 =	Total -15,757.03	
8	32 11 29	13 0002		SY	6" Thick FD	OT Limero	ck					\$5,388.74
				Installat	ion	Quantity 150.00	x	Unit Price 33.23	х	Factor 1.0811 =	Total 5,388.74	

Contractor's Price Proposal - Detail Page 1 of 7
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Work Order Number: 077746.00

Work Order Title: Screen Wall at Sunset Harbour Pump Station No. 3

9	32 11 29 13 0002	2 0010	MOD For Up	To 500, Add							\$1,162.72
			Installation	Quantity 150.00	x	Unit Price 7.17	х	Factor 1.0811	=	Total 1,162.72	
10	32 12 13 13 0004	4	SY Tack Co	oat, 0.08 Gallon/	SY						\$729.74
			Installation	Quantity 1,250.00	x	Unit Price 0.54	х	Factor 1.0811	=	Total 729.74	
11	32 12 16 13 0049	9	TON Traffic (C, S-I And S-III							\$6,590.06
			Installation	Quantity 45.00	x	Unit Price 135.46	x	Factor 1.0811	=	Total 6,590.06	
12	32 17 23 13 0035	5	LF Single 6	6" Wide Solid Lir	ne, Pai	nted Reflective Pav	ement S	triping			\$71.35
			Installation	Quantity 300.00	х	Unit Price 0.22	x	Factor 1.0811	=	Total 71.35	
13	32 17 23 13 0035	5 0062	MOD For Up	To 5,000 LF, Ad	d						\$12.97
			Installation	Quantity 300.00	x	Unit Price 0.04	x	Factor 1.0811	=	Total 12.97	
14	32 17 23 13 0036	6	LF Single 8		ne, Pai	nted Reflective Pav	ement S				\$121.08
			Installation	Quantity 400.00	х	Unit Price 0.28	x	Factor 1.0811	=	Total 121.08	
15	32 17 23 13 0036	6 0062	MOD For Up	To 5,000 LF, Ad	d						\$25.95
			Installation	Quantity 400.00	x	Unit Price 0.06	x	Factor 1.0811	=	Total 25.95	
16	32 17 23 33 0004	4	LF Single 6	6" Wide Solid Lir	ne, The	ermoplastic Reflectiv	ve Paver	ment Striping			\$424.87
			Installation	Quantity 300.00	x	Unit Price 1.31	x	Factor 1.0811	=	Total 424.87	
17	32 17 23 33 0004	4 0047	MOD For Up	To 5,000 LF, Ad	d						\$84.33
			Installation	Quantity 300.00	х	Unit Price 0.26	х	Factor 1.0811	=	Total 84.33	
18	32 17 23 33 0005	5	LF Single 8		ne, The	ermoplastic Reflectiv	ve Paver	. •			\$140.27
			Installation	Quantity 75.00	х	Unit Price 1.73	х	Factor 1.0811	=	Total 140.27	
19	32 17 23 33 0005	5 0047	MOD For Up	To 5,000 LF, Ad	d						\$28.38
			Installation	Quantity 75.00	х	Unit Price 0.35	х	Factor 1.0811	=	Total 28.38	
Subto	otal for Asphalt										\$46,986.95
	ar Industries										
20	10 00 00 0 0 000010	01	Screen	, ,	r Insdu	ustries- Grecian Pat	tern				\$398,465.50
		NPP	Installation	Quantity 1.00	х	Unit Price 351,040.00	х	Factor 1.1351	=	Total 398,465.50	
Subto	otal for Bomar Inc	dustries									\$398,465.50
Conc	01 22 20 00 0006	<u> </u>	HR Carpen	terFor tacke not	includ	ed in the Constructi	on Taek	Catalon® and a	<u> </u>		\$22,027.41
		-		by owner only.	ioiuu	ca in the constituti	on idak	odialogo aliu a	J		ΨΔΔ, ΟΔΙ. ΤΙ
			Installation	Quantity 500.00	x	Unit Price 40.75	x	Factor 1.0811	=	Total 22,027.41	
			all form work-For	m and strip all fo	rmwor	k					

Contractor's Price Proposal - Detail Page 2 of 7
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077746.00 Work Order Number:

Screen Wall at Sunset Harbour Pump Station No. 3 Work Order Title:

Conc	rete										
22	03 21 11 00 008	9	LF #4, 0	Grade 60, Footings	, Steel R	einforcement Bar					\$1,427.05
			la stallation	Quantity		Unit Price		Factor	_	Total	
			Installation	2,000.00	Х	0.66	Х	1.0811	=	1,427.05	
23	03 21 11 00 009)	LF #5, 0	Grade 60, Footings	, Steel R	einforcement Bar					\$4,864.95
			Installation	Quantity	x	Unit Price	x	Factor	=	Total 4,864.95	
24	02 24 42 00 004	0		4,500.00		1.00		1.0811			00.005.40
24	03 31 13 00 001	0	C1 Dire	ct Chute, Place 3,0	00 PSI C		us Footing			Total	\$8,605.12
			Installation	Quantity 55.00	х	Unit Price 144.72	x	Factor 1.0811	=	Total 8,605.12	
25	03 31 13 00 001	8 0033	MOD For	6,000 PSI Concrete	e, Add						\$1,975.28
				Quantity		Unit Price		Factor		Total	¥ 1,01 0.00
			Installation	55.00	X	33.22	Х	1.0811	=	1,975.28	
26	03 31 13 00 006	7	CY 8" T	hick, By Direct Chu	te, Place	3,000 PSI Concr	ete Walls				\$5,414.04
			Installation	Quantity		Unit Price		Factor	_	Total	
			Installation	30.00	Х	166.93	Х	1.0811		5,414.04	
27	03 31 13 00 006	7 0033	MOD For	6,000 PSI Concrete	e, Add						\$1,077.42
			Installation	Quantity	x	Unit Price	x	Factor 1.0811	=	Total 1,077.42	
28	03 37 16 00 001	n	HR 35 C	30.00 CY/HR, 66 HP Traile		33.22					#7 CO2 O7
20	03 37 16 00 001	J	пк 35 C	*	er iviourite	'	omciudes			Total	\$7,693.97
			Installation	Quantity		Unit Price		Factor	=	Total 7,693.97	
			IIIStaliation	80.00	Х	88.96	Х	1.0811		1,093.91	
			Separate Pour	80.00 rs	х	88.96	Х	1.0811		1,093.91	
Subto	otal for Concrete				X	88.96	X	1.0811		7,093.97	\$53,085.2
	otal for Concrete				X	88.96	X	1.0811		7,095.97	\$53,085.2
		6	Separate Pour					1.0811		7,095.97	\$53,085.2 \$2,197.23
Conc	rete Demo	6	Separate Pour	o-Off Reinforced Co	oncrete A	at Recycling Cente	r	Factor	=	Total	\$53,085.2 \$2,197.23
2 9	on 74 19 00 002		Separate Pour CY Drop Installation	o-Off Reinforced Co Quantity 40.00	oncrete A	at Recycling Cente Unit Price 50.81			=	,	\$2,197.23
Conc	rete Demo		Separate Pour CY Drop Installation	o-Off Reinforced Co Quantity 40.00 Iforced Concrete Fo	oncrete A	at Recycling Cente Unit Price 50.81 In Demolition	r	Factor 1.0811	=	Total 2,197.23	·
2 9	on 74 19 00 002		Separate Pour CY Drop Installation	o-Off Reinforced Co Quantity 40.00 Inforced Concrete Fo Quantity	oncrete A	at Recycling Cente Unit Price 50.81 In Demolition Unit Price	r	Factor 1.0811 Factor	=	Total	\$2,197.23
29 30	01 74 19 00 002 02 41 16 13 003	0	CY Drop Installation CF Rein Installation	o-Off Reinforced Co Quantity 40.00 Iforced Concrete Fo Quantity 300.00	x x pundation x	ut Recycling Cente Unit Price 50.81 In Demolition Unit Price 8.19	r x	Factor 1.0811	=	Total 2,197.23 Total	\$2,197.23 \$2,656.26
29	on 74 19 00 002	0	CY Drop Installation CF Rein Installation	o-Off Reinforced Co Quantity 40.00 Iforced Concrete Fo Quantity 300.00 hick Reinforced Co	x x pundation x	ut Recycling Center Unit Price 50.81 In Demolition Unit Price 8.19 Oundation Wall De	r x	Factor 1.0811 Factor 1.0811	=	Total 2,197.23 Total 2,656.26	\$2,197.23
29 30	01 74 19 00 002 02 41 16 13 003	0	CY Drop Installation CF Rein Installation	o-Off Reinforced Co Quantity 40.00 Iforced Concrete Fo Quantity 300.00	x x pundation x	ut Recycling Cente Unit Price 50.81 In Demolition Unit Price 8.19	r x	Factor 1.0811 Factor	=	Total 2,197.23 Total	\$2,197.23 \$2,656.26
29 30	01 74 19 00 002 02 41 16 13 003	3	CY Drop Installation CF Rein Installation SF 8" Ti	O-Off Reinforced Co Quantity 40.00 Iforced Concrete For Quantity 300.00 hick Reinforced Co Quantity	oncrete A x oundation x ncrete Fo	unit Price 50.81 n Demolition Unit Price 8.19 oundation Wall De Unit Price 5.85	x x x molition	Factor 1.0811 Factor 1.0811 Factor 1.0811		Total 2,197.23 Total 2,656.26	\$2,197.23 \$2,656.26
29 30	01 74 19 00 002 02 41 16 13 003 02 41 16 13 003	3	CY Drop Installation CF Rein Installation SF 8" Ti Installation EA Saw less	O-Off Reinforced Co Quantity 40.00 Inforced Concrete For Quantity 300.00 hick Reinforced Co Quantity 306.00 Cut Minimum Cha than the minimum	oncrete A x oundation x oncrete For x rgeFor picharge, t	unit Price 50.81 n Demolition Unit Price 8.19 oundation Wall De Unit Price 5.85 rojects where the use this task exclusives	r x x x molition x total saw sively. The	Factor 1.0811 Factor 1.0811 Factor 1.0811 cutting charge	is	Total 2,197.23 Total 2,656.26	\$2,197.23 \$2,656.26 \$1,935.28
29 30	01 74 19 00 002 02 41 16 13 003 02 41 16 13 003	3	CY Drop Installation CF Rein Installation SF 8" Ti Installation EA Saw less	O-Off Reinforced Co Quantity 40.00 Inforced Concrete For Quantity 300.00 hick Reinforced Co Quantity 306.00 Cut Minimum Cha than the minimum sed in conjunction	oncrete A x oundation x oncrete For x rgeFor picharge, t	unit Price 50.81 n Demolition Unit Price 8.19 oundation Wall De Unit Price 5.85 rojects where the use this task excluother tasks in this	r x x x molition x total saw sively. The	Factor 1.0811 Factor 1.0811 Factor 1.0811 cutting charge is task should	is	Total 2,197.23 Total 2,656.26 Total 1,935.28	\$2,197.23 \$2,656.26 \$1,935.28
29 30	01 74 19 00 002 02 41 16 13 003 02 41 16 13 003	3	CY Drop Installation CF Rein Installation SF 8" Ti Installation EA Saw less	O-Off Reinforced Co Quantity 40.00 Inforced Concrete For Quantity 300.00 hick Reinforced Co Quantity 306.00 Cut Minimum Cha than the minimum	oncrete A x oundation x oncrete For x rgeFor picharge, t	unit Price 50.81 n Demolition Unit Price 8.19 oundation Wall De Unit Price 5.85 rojects where the use this task exclusives	r x x x molition x total saw sively. The	Factor 1.0811 Factor 1.0811 Factor 1.0811 cutting charge	is not	Total 2,197.23 Total 2,656.26	\$2,197.23 \$2,656.26 \$1,935.28
29 30 31 32	01 74 19 00 002 02 41 16 13 003 02 41 16 13 003	3	CY Drop Installation CF Rein Installation SF 8" Ti Installation EA Saw less be u	O-Off Reinforced Co Quantity 40.00 Inforced Concrete For Quantity 300.00 hick Reinforced Co Quantity 306.00 Cut Minimum Cha than the minimum sed in conjunction Quantity	oncrete A x oundation x ncrete For x rgeFor procharge, to with any	unit Price 50.81 n Demolition Unit Price 8.19 oundation Wall De Unit Price 5.85 rojects where the use this task excluother tasks in this Unit Price	x x molition x total saw sively. Th section.	Factor 1.0811 Factor 1.0811 Factor 1.0811 cutting charge is task should	is not	Total 2,197.23 Total 2,656.26 Total 1,935.28	\$2,197.23 \$2,656.26 \$1,935.28
29 30 31 32	01 74 19 00 002 02 41 16 13 003 02 41 16 13 003 02 41 19 13 007 02 41 19 00 002	3	CY Drop Installation CF Rein Installation SF 8" Ti Installation EA Saw less be u	O-Off Reinforced Co Quantity 40.00 Inforced Concrete For Quantity 300.00 hick Reinforced Co Quantity 306.00 Cut Minimum Cha than the minimum sed in conjunction Quantity	oncrete A x oundation x ncrete For x rgeFor procharge, to with any	unit Price 50.81 n Demolition Unit Price 8.19 oundation Wall De Unit Price 5.85 rojects where the use this task excluother tasks in this Unit Price	x x molition x total saw sively. Th section.	Factor 1.0811 Factor 1.0811 Factor 1.0811 cutting charge is task should	is not	Total 2,197.23 Total 2,656.26 Total 1,935.28	\$2,197.23 \$2,656.26 \$1,935.28
29 30 31 32	01 74 19 00 002 02 41 16 13 003 02 41 16 13 003 02 41 19 13 007 02 41 19 00 002	0 3 0 Demo	CY Drop Installation CF Rein Installation SF 8" Ti Installation EA Saw less be u Installation	O-Off Reinforced Co Quantity 40.00 Inforced Concrete For Quantity 300.00 hick Reinforced Co Quantity 306.00 Cut Minimum Cha than the minimum sed in conjunction Quantity	oncrete A x oundation x oncrete For x rgeFor picharge, twith any x	unit Price 50.81 In Demolition Unit Price 8.19 Oundation Wall De Unit Price 5.85 In Demolition Unit Price 5.85 In Demolition Wall Def Unit Price 5.85 In Demolition Wall Def Unit Price Unit Price 541.54	x x molition x total saw sively. Th section.	Factor 1.0811 Factor 1.0811 Factor 1.0811 cutting charge is task should	is not	Total 2,197.23 Total 2,656.26 Total 1,935.28	\$2,197.23 \$2,656.26 \$1,935.28 \$585.46
29 30 31 32 Subto	01 74 19 00 002 02 41 16 13 003 02 41 16 13 003 02 41 19 13 007 01 01 01 01 01 01 01 01 01 01 01 01 01 0	0 3 0 Demo	CY Drop Installation CF Rein Installation SF 8" Ti Installation EA Saw less be u Installation	o-Off Reinforced Co Quantity 40.00 Iforced Concrete Fo Quantity 300.00 hick Reinforced Co Quantity 306.00 Cut Minimum Cha than the minimum sed in conjunction Quantity 1.00	oncrete A x oundation x oncrete For x rgeFor picharge, twith any x	unit Price 50.81 In Demolition Unit Price 8.19 Oundation Wall De Unit Price 5.85 In Demolition Unit Price 5.85 In Demolition Wall Def Unit Price 5.85 In Demolition Wall Def Unit Price Unit Price 541.54	x x molition x total saw sively. Th section.	Factor 1.0811 Factor 1.0811 Factor 1.0811 cutting charge is task should	is not	Total 2,197.23 Total 2,656.26 Total 1,935.28	\$2,197.23 \$2,656.26 \$1,935.28 \$585.46

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Work Order Number: 077746.00

Work Order Title: Screen Wall at Sunset Harbour Pump Station No. 3

		ameter x 3-1/4 L	_enath. 3	16 Stainless Stee	el. Wedae	Anchor Expansion		\$402.82
	Bolt		-og, o		o, rrougo	инопот Дирапотот		Ψ.02.01
	Installation	Quantity	¥	Unit Price	Y	Factor	Total 402.82	
05 05 22 00 0010	ΕΛ 1/4" Di							#040.0
03 03 23 00 0010	LA 1/4 DI	`	juii, 30 4 /		cei, i iex i i		Total	\$249.0
	Installation	80.00	х	2.88	х	1.0811 =	249.09	
05 05 23 00 1452	EA 1/4" In	side Diameter, 3	16 Stainle	ess Steel Flat Wa	sher			\$17.30
	Installation	Quantity 80.00	х	Unit Price 0.20	x	Factor 1.0811 =	Total 17.30	
26 05 19 16 0124					ingle Stra	nded Copper,		\$91.3
		Quantity		Unit Price		Factor	Total	
	Installation	0.20	Х	422.38	х	1.0811 =	91.33	
26 05 29 00 0010	•	•	" Wide x	1-5/8" High, 14 G	Sauge, 304	1 Stainless Steel		\$567.36
	Installation	Quantity		Unit Price		Factor =	Total	
00.05.00.0007							307.30	
26 05 29 00 0097	. 5.4.	it Channel	ess Stee	,	And Rigid	·		\$150.4
	Installation	•	¥		¥	_		
26 05 29 00 0151	FΔ 1/4-20							¢279.0
20 03 23 00 0131	LA 1/4-20		leer Lock	•	ing r or or		Total	\$278.0
	Installation	40.00	x	6.43	х		278.06	
26 05 33 13 0175	EA 1" Rigi	d Galvanized Ste	el (RGS) Plastic Insulating	g Bushing			\$91.0
		Quantity		Unit Price		Factor	Total	
	Installation	10.00	Х	8.42	Х	1.0811 =	91.03	
26 24 16 00 0444			lt, 15-30	Amp, Branch Cir	cuit Break	er, 22,000 Amp		\$161.3
	Installation	Quantity	v	Unit Price	v	Factor	Total 161.34	
26 27 16 00 0210	ΕΛ 4" ν 4"							Ф000.0
20 27 10 00 0310	EA 4 X 4	•	31, 304 5		IVIA 4A EII		Total	\$683.3
	Installation	4.00	x	158.02	х	1.0811	683.34	
26 56 23 00 0112				/all Mount, Full C	utoff, LED	Wall Pack (CREE®		\$4,131.70
		Quantity	LDO)	Unit Price		Factor	Total	
		2.00	Х	1,910.88	X	1.0811	4,131.70	
	<u> </u>							
40 05 23 43 0111	LF 1" Stai		ig, Type	,				\$1,588.5
	Installation	=	x		Х		Total 1,588.57	
40 05 23 43 0128	EA 1" 90 [1.0011		\$2,219.9
	In ata U - C - ·	Quantity		Unit Price		Factor	Total	
	installation	10.00	X	205.34	Х	1.0811 =	2,219.93	
40 05 23 43 0152	EA 1" x 1"	Male Connector	Stainles	s Steel Type 316				\$2,164.4
	Installation	Quantity 15.00	x	Unit Price 133.47	x	Factor 1.0811 =	Total 2,164.42	
	26 05 19 16 0124 26 05 29 00 0010 26 05 29 00 0097 26 05 29 00 0151 26 05 33 13 0175 26 24 16 00 0444 26 27 16 00 0310 26 56 23 00 0112 40 05 23 43 0111 40 05 23 43 0128	D5 05 23 00 0818	Section	Solid	Section	Section Color Co	Section Sect	Section Part Part

Contractor's Price Proposal - Detail Page 4 of 7
4/3/2020

077746.00 Work Order Number:

Electrical

Screen Wall at Sunset Harbour Pump Station No. 3 Work Order Title:

48	40 05	23	43 0215	EA (Cut And Prepare 1" Sta	inless S	teel Pipe				\$249.73
				Installation	Quantity 20.00	x	Unit Price 11.55	x	Factor 1.0811 =	Total 249.73	
49	40 05	23	43 0385	EA	1", 150#, Type 316 Stai	nless St	teel Threaded Cou	pling			\$405.20
				Installation	Quantity 10.00	x	Unit Price 37.48	x	Factor 1.0811 =	Total 405.20	
50	40 05	23	43 0727	EA ·	1", Type 316, Schedule	10 Stair	nless Steel 45 Dec	gree Elbov	w		\$526.84
				Installation	Quantity 6.00	x	Unit Price 81.22	x	Factor 1.0811 =	Total 526.84	
51	46 82	83	00 2342	[(Remote NEMA 4X (IP69 EN4 ())Mounted up to 2 on probe. Includes remo female NPT connection Quantity	200' awa	ay from the probe vertronics enclosure round Unit Price	with juncti	ion box mounted bracket and 1/2" Factor	Total 810.90	\$810.90
Subto	otal for	Elec	ctrical		1.00		750.07	^	1.0811		\$15,376.17
	ral Con										
52			00 0002	(Reimbursable FeesReir costs. Insert the appropression of the appropressi	oriate quere are omment ure, road s, etc.).	uantity to adjust the multiple Reimburs in the "note" block d cut, various perm	e base co able Fees to identif nits, exten	st to the actual s, list each one fy the Reimbursable ided warranty,		\$15,757.77
				Installation Bond Fee	Quantity 15,757.77	x	Unit Price 1.00	x	Factor 1.0000 =	Total 15,757.77	
53	01 22	20	00 0047		Senior Surveyor (Party	Chief)					\$2,811.29
				Installation	Quantity 60.00	х	Unit Price 43.34	x	Factor 1.0811 =	Total 2,811.29	
54	01 22	20	00 0048	HR S	Surveyor (Instrument pe	erson)					\$2,714.64
				Installation	Quantity 60.00	x	Unit Price 41.85	x	Factor 1.0811 =	Total 2,714.64	
55	01 22	20	00 0049	HR S	Surveyor (Rod person)						\$2,617.99
				Installation	Quantity 60.00	х	Unit Price 40.36	х	Factor 1.0811 =	Total 2,617.99	
56	01 22	20	00 0062	HR I	Project Manager						\$44,615.65
				Installation	Quantity 355.00	x	Unit Price 116.25	x	Factor 1.0811 =	Total 44,615.65	
					equest - PM & Super Blo						
57	01 22	23	00 0274	MO	1,500 LB Capacity, 60"	Wide, S		With Full-	•		\$32,853.10
				Installation	Quantity 3.00	x	Unit Price 10,129.53	x	Factor 1.0811 =	Total 32,853.10	
58	01 22	23	00 0428		1-3/4 CY, 30" Bucket, 1 Operator	8'-0" De	ep, 112 HP, Loade	er-Backho	oe With Full-Time		\$15,818.21
					Quantity		Unit Price		Factor	Total	

Contractor's Price Proposal - Detail Page 5 of 7

Work Order Number: 077746.00

Work Order Title: Screen Wall at Sunset Harbour Pump Station No. 3

					1 x 2 Flat Bed Tru	OK VVILITI	all Tillic Track		\$19,416.11
		Driver							
		Installation	Quantity	v	Unit Price	v	Factor	Total 19,416.11	
			1.50	Х	11,973.06	Х	1.0811 =	10,410.11	
60	01 22 23 00 1376	MO 18 CY F	Rear Dump Truc	k With Fu	ıll-Time Truck Dri	ver			\$49,536.0
		Installation	Quantity		Unit Price		Factor	Total 49,536.09	
		mstallation	3.00	Х	15,273.36	Х	1.0811	49,556.09	
61	01 55 26 00 0030	MO 28" Cor	ne With Reflectiv	ve Collar					\$4,446.5
		Installation	Quantity		Unit Price		Factor =	Total 4,446.56	
			900.00	Х	4.57	Х	1.0811 =	7,770.30	
		300 for 3 mos							
62	01 55 26 00 0036	MO Channe	lizer Drum						\$1,945.9
		Installation	Quantity	.,	Unit Price	.,	Factor	Total 1,945.98	
			120.00	Х	15.00	Х	1.0011	1,040.00	
63	01 55 26 00 0048	MO Type III	Barricade, Up 1	To 5' Wide	e With Three Refl	ective Rai	ls		\$3,218.6
		Installation	Quantity		Unit Price		Factor _	Total	
			120.00	X	24.81	Х	1.0811	3,218.65	
		40 for 3 mos							
64	01 55 26 00 0057	MO Type A	Or C Flasher						\$1,644.3
		Installation	Quantity		Unit Price		Factor	Total	
			300.00	X	5.07	Х	1.0811	1,644.35	
		100 for 3 mos							
65	01 55 26 00 0076	MO 6' x 32"	Tall Plastic Wat	er Barriei	r				\$8,811.2
		locate Hether	Quantity		Unit Price		Factor	Total	
		Installation	81.00	X	100.62	X	1.0811	8,811.20	
		27 for 3 mos							
66	01 55 26 00 0096	MO Trailer N	Mounted Flashir	ng Arrow I	Board				\$6,996.1
		la stallation	Quantity		Unit Price		Factor	Total	
		Installation	12.00	X	539.28	X	1.0811	6,996.19	
		4 for 3 mos							
67	01 55 26 00 0105	EA Place A	nd Remove >25	50 Cones	Using Truck				\$1,770.8
		locate Hether	Quantity		Unit Price		Factor	Total	
		Installation	900.00	x	1.82	Х	1.0811	1,770.84	
		set 300 3 individu	al times.						
68	01 55 26 00 0116	EA Place A	nd Remove Pla	stic Wate	r BarrierIncludes	water. If I	ifting equipment is		\$7,287.5
						0-0000 for	Equipment Usage,		
		01 71 1	3 00-0000 for m	obilizatio			Fastan	Tatal	
		Installation	Quantity 243.00	х	Unit Price 27.74	X	Factor 1.0811 =	Total 7,287.50	
		81 set 3 indiviuda			21.14		1.0011		
69	01 74 19 00 0014			.) "0	usatian Dahnialla	المامم مامان			#2 F22 2
U J	01 74 13 00 00 14			•			very of dumpster, zardous material.		\$3,522.3
		remai d	Quantity	., maaiing	Unit Price		Factor	Total	
		Installation	5.00	X	651.62	X	1.0811 =	3,522.33	
	otal for General Condition								\$225,784

Contractor's Price Proposal - Detail Page 6 of 7
4/3/2020

Work Order Number: 077746.00

Work Order Title: Screen Wall at Sunset Harbour Pump Station No. 3

Plant 70		16	00.0000		CY	#57.04	- A	:II /#4 Ta	411)				^ 5.10.11
70	31 05	10	8000 00		CY	#5/ Ston	e Aggregate F	III (#4 IO	1")				\$542.44
					Installati		Quantity		Unit Price		Factor	Total	
					instaliati	on	9.00	X	55.75	X	1.0811 =	542.44	
71	31 05	16	8000 00	0053	MOD	For Up To	o 10, Add						\$157.82
							Quantity		Unit Price		Factor	Total	
					Installati	on	9.00	Х	16.22	X	1.0811 =	157.82	
72	31 32	19	16 0013		SY	4 To 6%	Open Area, 37	0 x 250 l	B Grab Tensile V	Voven Mo	nofilament		\$65.41
						Geotextile	e Fabric (Cartl	nage Mills	s Carthage 6%)				
							Quantity		Unit Price		Factor	Total	
					Installati	on	22.00	Х	2.75	X	1.0811 =	65.41	
73	31 32	19	16 0013	0084	MOD	For Up To	50, Add						\$13.56
							Quantity		Unit Price		Factor	Total	
					Installati	on	22.00	X	0.57	X	1.0811 =	13.56	
74	32 91	13	26 0015		CY	Backfill P	lanting Pit By	Machine,	With Topsoil Fro	m Stockpi	е		\$93.52
							Quantity		Unit Price		Factor	Total	
					Installati	on	25.00	X	3.46	X	1.0811 =	93.52	
75	32 91	19	13 0016		CY	Furnish A	and Place Impo	orted Scr	eened Topsoil, O	ver 12" De	ер		\$1,025.96
							Quantity		Unit Price		Factor	Total	
					Installati	on	25.00	X	37.96	x	1.0811 =	1,025.96	
76	32 93	33	00 0104		EA	3 Gallon	Ficus benjami	na - Wee	ping Fig				\$279.73
							Quantity		Unit Price		Factor	Total	
					Installati	on	25.00	Х	10.35	X	1.0811 =	279.73	
	otal for	Die	mto v										\$2,178.
inti	Jiai IUI I	r id	iii e i										Ψ2,170

Proposal Total \$749,251.00

This total represents the correct total for the proposal. Any discrepancy between line totals, sub-totals and the proposal total is due to rounding.

The Percentage of NPP on this Proposal: 53.18%



Subcontractor Listing

Date: April 03, 2020

Re: IQC Master Contract #: FL-SEA-GC01-041019-HBC

Work Order #: 077746.00

Owner PO #:

Title: Screen Wall at Sunset Harbour Pump Station No. 3

Contractor: Harbour Construction, Inc.

Proposal Value: \$749,251.00

Name of Contractor	Duties	Amount	%
No Subcontractors have been		\$0.00	0.00
selected for this Work Order			

Subcontractor Listing Page 1 of 1

MIAMIBEACH

CITY OF MIAMI BEACH

SCREEN WALL AT SUNSET HARBOUR PUMP STATION (PS NO 3)

WEST AVENUE AND 20TH STREET
OCTOBER 7, 2019
100% DESIGN SUBMITTAL (FINAL SUBMITTAL)



CITY OF MIAMI BEACH

KNOW WHAT'S BELOW ALWAYS CALL 811 BEFORE YOU DIG

MAYOR: DAN GELBER

COMMISSIONERS: JOHN ELIZABETH ALEMÁN

RICKY ARRIOLA MICHAEL GONGORA JOY MALAKOFF MARK SAMUELIAN

MICKY STEINBERG

CITY MANAGER: JIMMY L. MORALES CITY ATTORNEY: RAUL J. AGUILA

CITY CLERK: RAFAEL E. GRANADO ASSISTANT CITY MANAGER: ERIC T. CARPENTER, P.E.

CIP DIRECTOR: DAVID MARTINEZ P.E.

PW DIRECTOR: ROY COLEY





INDEX OF DRAWINGS

G-001 COVER SHEET & INDEX OF DRAWINGS
A-000 SITE PLAN AND PUMP STATION PERIMETER PLAN
A-001 SOW, SCREEN PANEL INSTALLATION & REMOVAL
AND PLANTER DETAIL
A-002 ARCHITECTURAL ELEVATIONS
A-003 ARCHITECTURAL DETAILS
S-001 SCREEN WALL PLAN AND ELEVATIONS

S-002 SCREEN WALL DETAILS S-003 CONSTRUCTION SEQUENCE (1 OF 2)

S-004 CONSTRUCTION SEQUENCE (2 OF 2)
S-005 REPLACEMENT TRAFFIC RAILING AND

S-006 REPLACEMENT TRAFFIC RAILING AND JUNCTION SLAB DETAILS (2 OF 2)

S-007 PROJECT PHOTOS

E-001 ELECTRICAL PLAN
E-002 ELECTRICAL DETAILS

E-003 SIGN LIGHTING CUT SHEET

X-001 TRAFFIC RAILING AS-BUILT DRAWING (NOT INCLUDED IN PERMIT PLANS)


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West Palm Beach, Florido 33409
Florido Engineering Cert. No. 1978


LOCATION MAP

THIS SEAL APPLIES TO THE FOLLOWING DRAWINGS ONLY: G-001

A Series Drawings
S Series Drawings



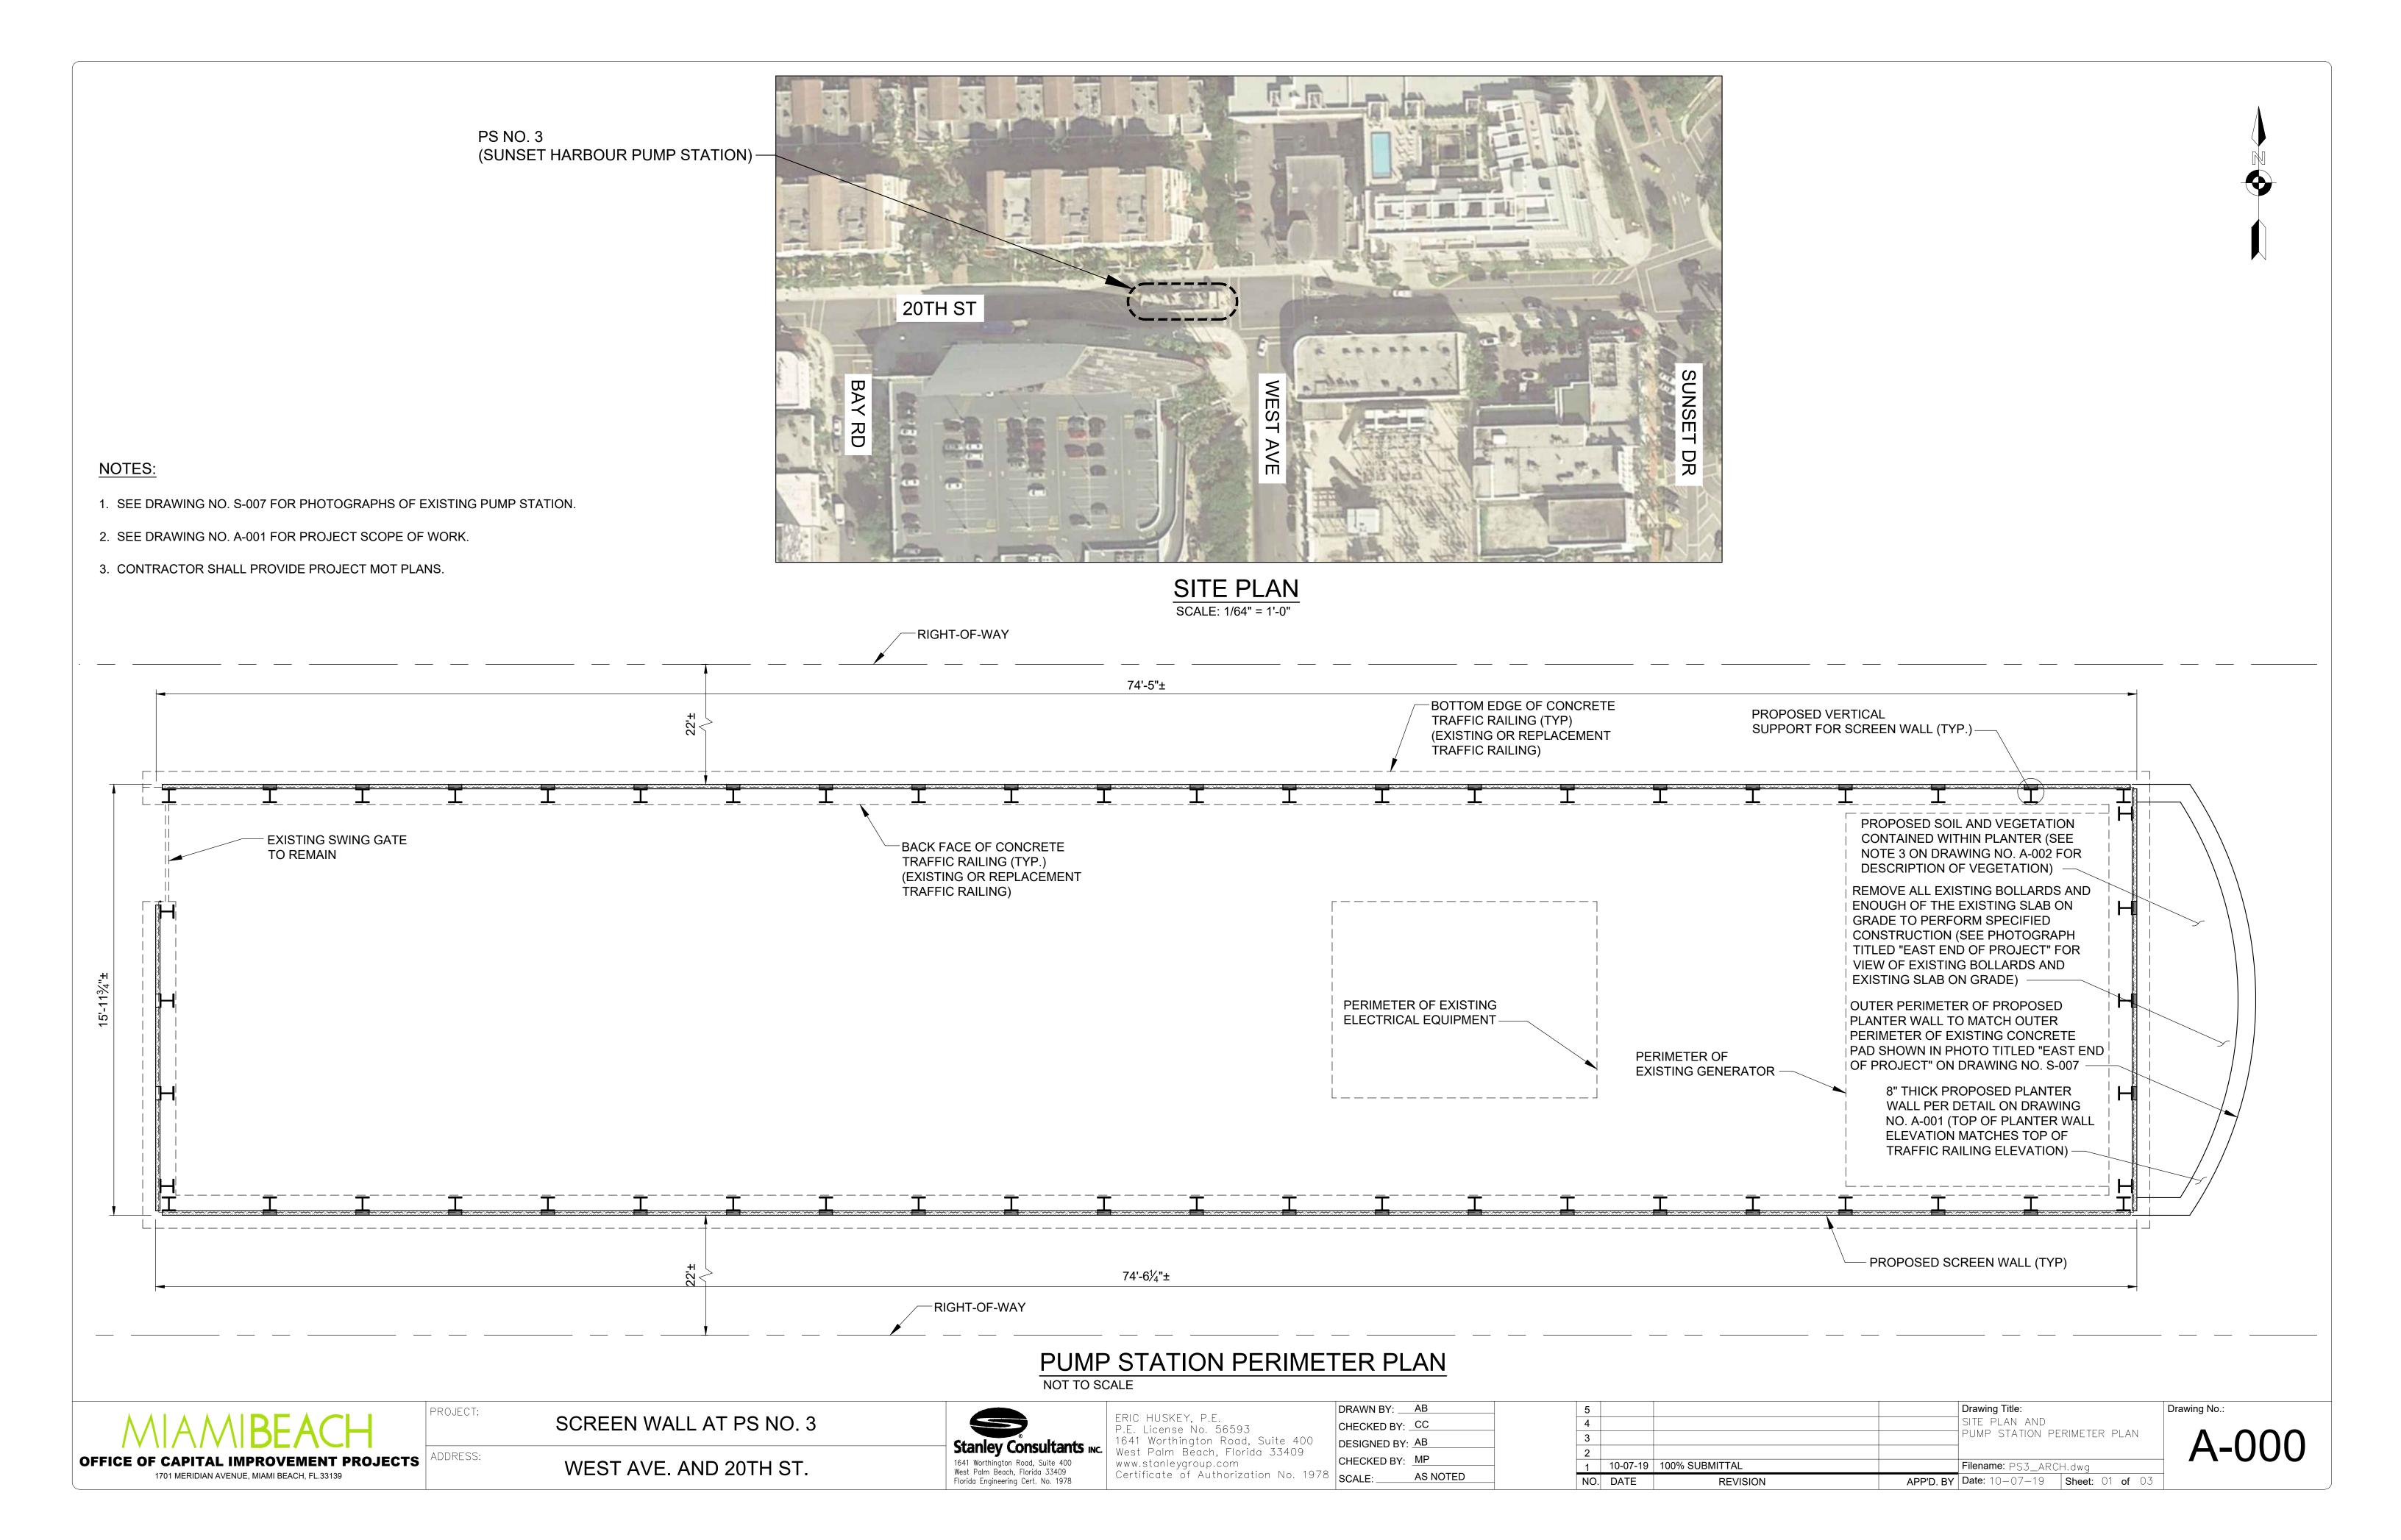

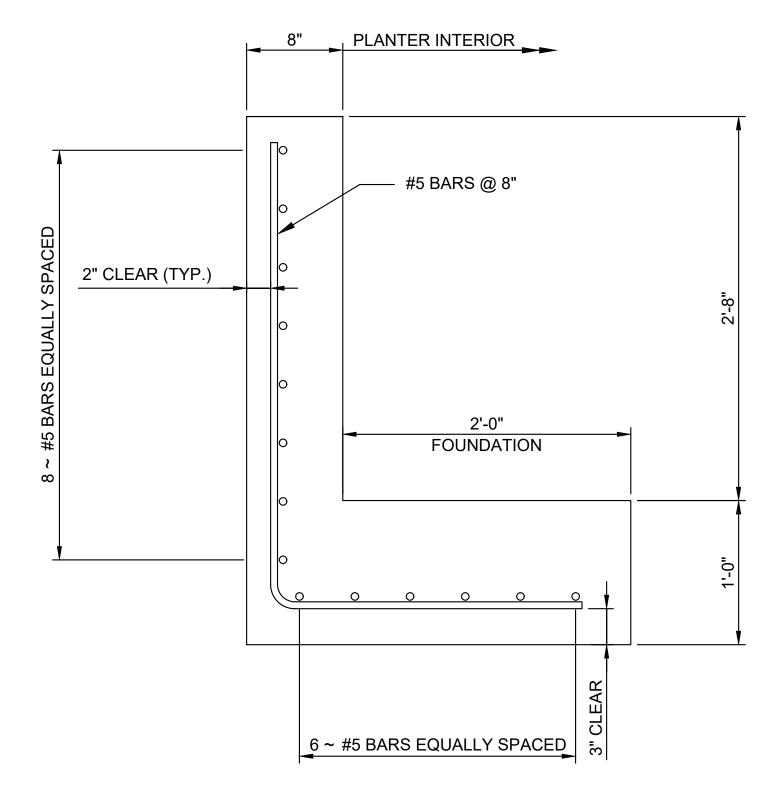

NOTE:

1. IN THOSE LOCATIONS WHERE THE PLANTER IS DIRECTLY OVER THE PROPOSED TRAFFIC RAILING JUNCTION SLAB (TRAFFIC RAILING FOOTING) THERE WILL BE NO PLANTER WALL FOUNDATION. INSTEAD THE VERTICAL #5 BARS (HOOKED AT ENDS AS SHOWN) WILL BE EMBEDDED IN THE TRAFFIC RAILING JUNCTION SLAB.

PLANTER WALL AND FOUNDATION SECTION

NOT TO SCALE

PROJECT SCOPE OF WORK (SOW)

- 1. CONTRACTOR SHALL VERIFY PROJECT DIMENSIONS AS STATED IN NOTE C ON DRAWING NUMBER S-001.
- 2. WHILE MAINTAINING TRAFFIC ON ONE SIDE OF THE PUMP STATION (NORTH SIDE OR SOUTH SIDE), THE CONTRACTOR SHALL REMOVE THE PORTION OF THE EXISTING TRAFFIC RAILING AND JUNCTION SLAB ON THE OTHER SIDE OF THE PUMP STATION (SOUTH SIDE OR NORTH SIDE) AS SHOWN ON DRAWING NO'S S-003 AND S-004.
- 3. THE CONTRACTOR SHALL DETERMINE IF THE REMAINING EXISTING SUB-GRADE IS SUFFICIENT TO PLACE NEW CONSTRUCTION UPON. IF IMPROVEMENTS NEED TO BE MADE TO EXISTING SUB-GRADE, THE CONTRACTOR SHALL REFER TO SUB-GRADE CALLOUT IN SECTION D ON DRAWING NUMBER S-004.
- 4. THE CONTRACTOR SHALL CONSTRUCT THE REPLACEMENT JUNCTION SLAB PER DRAWING NO'S S-003 THROUGH S-006.
- 5. THE CONTRACTOR SHALL CONSTRUCT THE REPLACEMENT TRAFFIC RAILING PER DRAWING NO'S S-003 THROUGH S-006.
- 6. THE CONTRACTOR SHALL PLACE ASPHALT ON TOP OF THE REPLACEMENT JUNCTION SLAB TO MATCH ROADWAY SLOPE OF REMAINING ROADWAY AREAS ADJACENT TO CONSTRUCTION PER DRAWING NO'S S-003 THROUGH S-006.
- 7. THE CONTRACTOR SHALL INSTALL ANCHOR RODS IN THE PORTION OF THE EXISTING TRAFFIC RAILING THAT IS TO REMAIN PER SECTION C ON DRAWING NO \$-004
- 8. THE CONTRACTOR SHALL INSTALL THE VERTICAL SUPPORTS ON TOP OF THE TRAFFIC RAILING AS PER DRAWING NO'S S-001 AND S-002.
- 9. THE CONTRACTOR SHALL INSTALL THE SCREEN PANELS AS PER DRAWING NO'S S-001, S-002 AND THE A SERIES DRAWINGS.
- 10. THE CONTRACTOR SHALL SHIFT TRAFFIC TO THE OTHER SIDE OF THE PUMP STATION.
- 11. THE CONTRACTOR SHALL PERFORM SOW STEPS 2 THROUGH 9 FOR THE ALTERNATE SIDE OF THE PUMP STATION.
- 12. THE CONTRACTOR SHALL PERFORM WORK ON THE EAST AND WEST SIDES OF THE PUMP STATION AS SPECIFIED IN THE MOT PLAN DETERMINED BY THE CONTRACTOR. THE CONTRACTOR SHALL PERFORM SOW STEPS 2 THROUGH 9 FOR THE WORK ON THE WEST SIDE OF THE PUMP STATION. THE CONTRACTOR SHALL PERFORM SOW STEPS 2 THROUGH 6, 8 AND 9 FOR THE WORK ON THE EAST SIDE OF THE PUMP STATION. NOTE THAT FOR THE WORK ON THE EAST SIDE OF THE PUMP STATION, THE CONTRACTOR SHALL REMOVE ALL EXISTING BOLLARDS AND ENOUGH OF THE EXISTING SLAB ON GRADE TO PERFORM SPECIFIED CONSTRUCTION (SEE PHOTOGRAPH TITLED "EAST END OF PROJECT" FOR VIEW OF EXISTING BOLLARDS AND EXISTING SLAB ON GRADE). ADDITIONALLY, FOR WORK ON THE EAST SIDE OF THE PUMP STATION, THE CONTRACTOR SHALL INSTALL PLANTER WALL VERTICAL REINFORCING IN THE PROPOSED JUNCTION SLAB AS REQUIRED AND SHALL CONSTRUCT THE PLANTER AS PER THE A SERIES DRAWINGS. AND INSTALL LIGHTING AS SPECIFIED IN THE ELECTRICAL DRAWINGS.

SCREEN PANEL INSTALLATION AND REMOVAL

NOTE THE FOLLOWING:

- MAXIMUM SCREEN PANEL WEIGHT IS ABOUT 300 POUNDS.
- USE THE LIFTING HOLES IN THE SCREEN PANEL TOP ENDS SHOWN ON DRAWING NO S-002 TO LIFT THE SCREEN PANELS.
- USE SHACKLES ATTACHED TO THE SCREEN PANEL LIFTING HOLES, WIRE ROPES ATTACHED TO THE SHACKLES AND A MECHANICAL LIFTING DEVICE ATTACHED TO THE WIRE ROPES TO LIFT THE SCREEN PANELS.
- SHACKLE PINS THAT CAN FIT THROUGH A 5/8" DIAMETER HOLE SHALL BE USED.

SCREEN PANEL INSTALLATION

- 1. ATTACH SHACKLE PINS TO THE SCREEN PANEL LIFTING HOLES.
- 2. USE A MECHANICAL LIFTING DEVICE TO LIFT THE SCREEN PANEL AND PLACE IN POSITION.
- 3. INSTALL BOLTS TO ATTACH THE SCREEN PANEL TO THE VERTICAL SUPPORTS.
- 4. RELEASE THE SHACKLES FROM THE SCREEN PANEL.

SCREEN PANEL REMOVAL

- 1. ATTACH SHACKLE PINS TO THE SCREEN PANEL LIFTING HOLES.
- 2. USE A MECHANICAL LIFTING DEVICE TO HOLD THE SCREEN PANEL IN PLACE.
- REMOVE THE BOLTS ATTACHING THE SCREEN PANEL TO THE VERTICAL SUPPORTS.
- 4. LIFT AND REMOVE THE SCREEN PANEL



SCREEN WALL AT PS NO. 3


WEST AVE. AND 20TH ST.




ERIC HUSKEY, P.E.
P.E. License No. 56593
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West Palm Beach, Florida 33409
www.stanleygroup.com
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CHEC
SCAL

DRAWN BY:	AB
CHECKED BY: _	CC
DESIGNED BY:	
CHECKED BY:	MP
SCALE:	AS NOTED
00,	

5				Drawing Title:
4				SOW, SCREEN PANEL
3				INSTALLATION & REMOVAL AND PLANTER DETAIL
2				AND PLANTER DETAIL
1	10-07-19	100% SUBMITTAL		Filename: PS3_ARCH.dwg
NO.	DATE	REVISION	APP'D. BY	Date: 10-07-19 Sheet: 01 of 0.

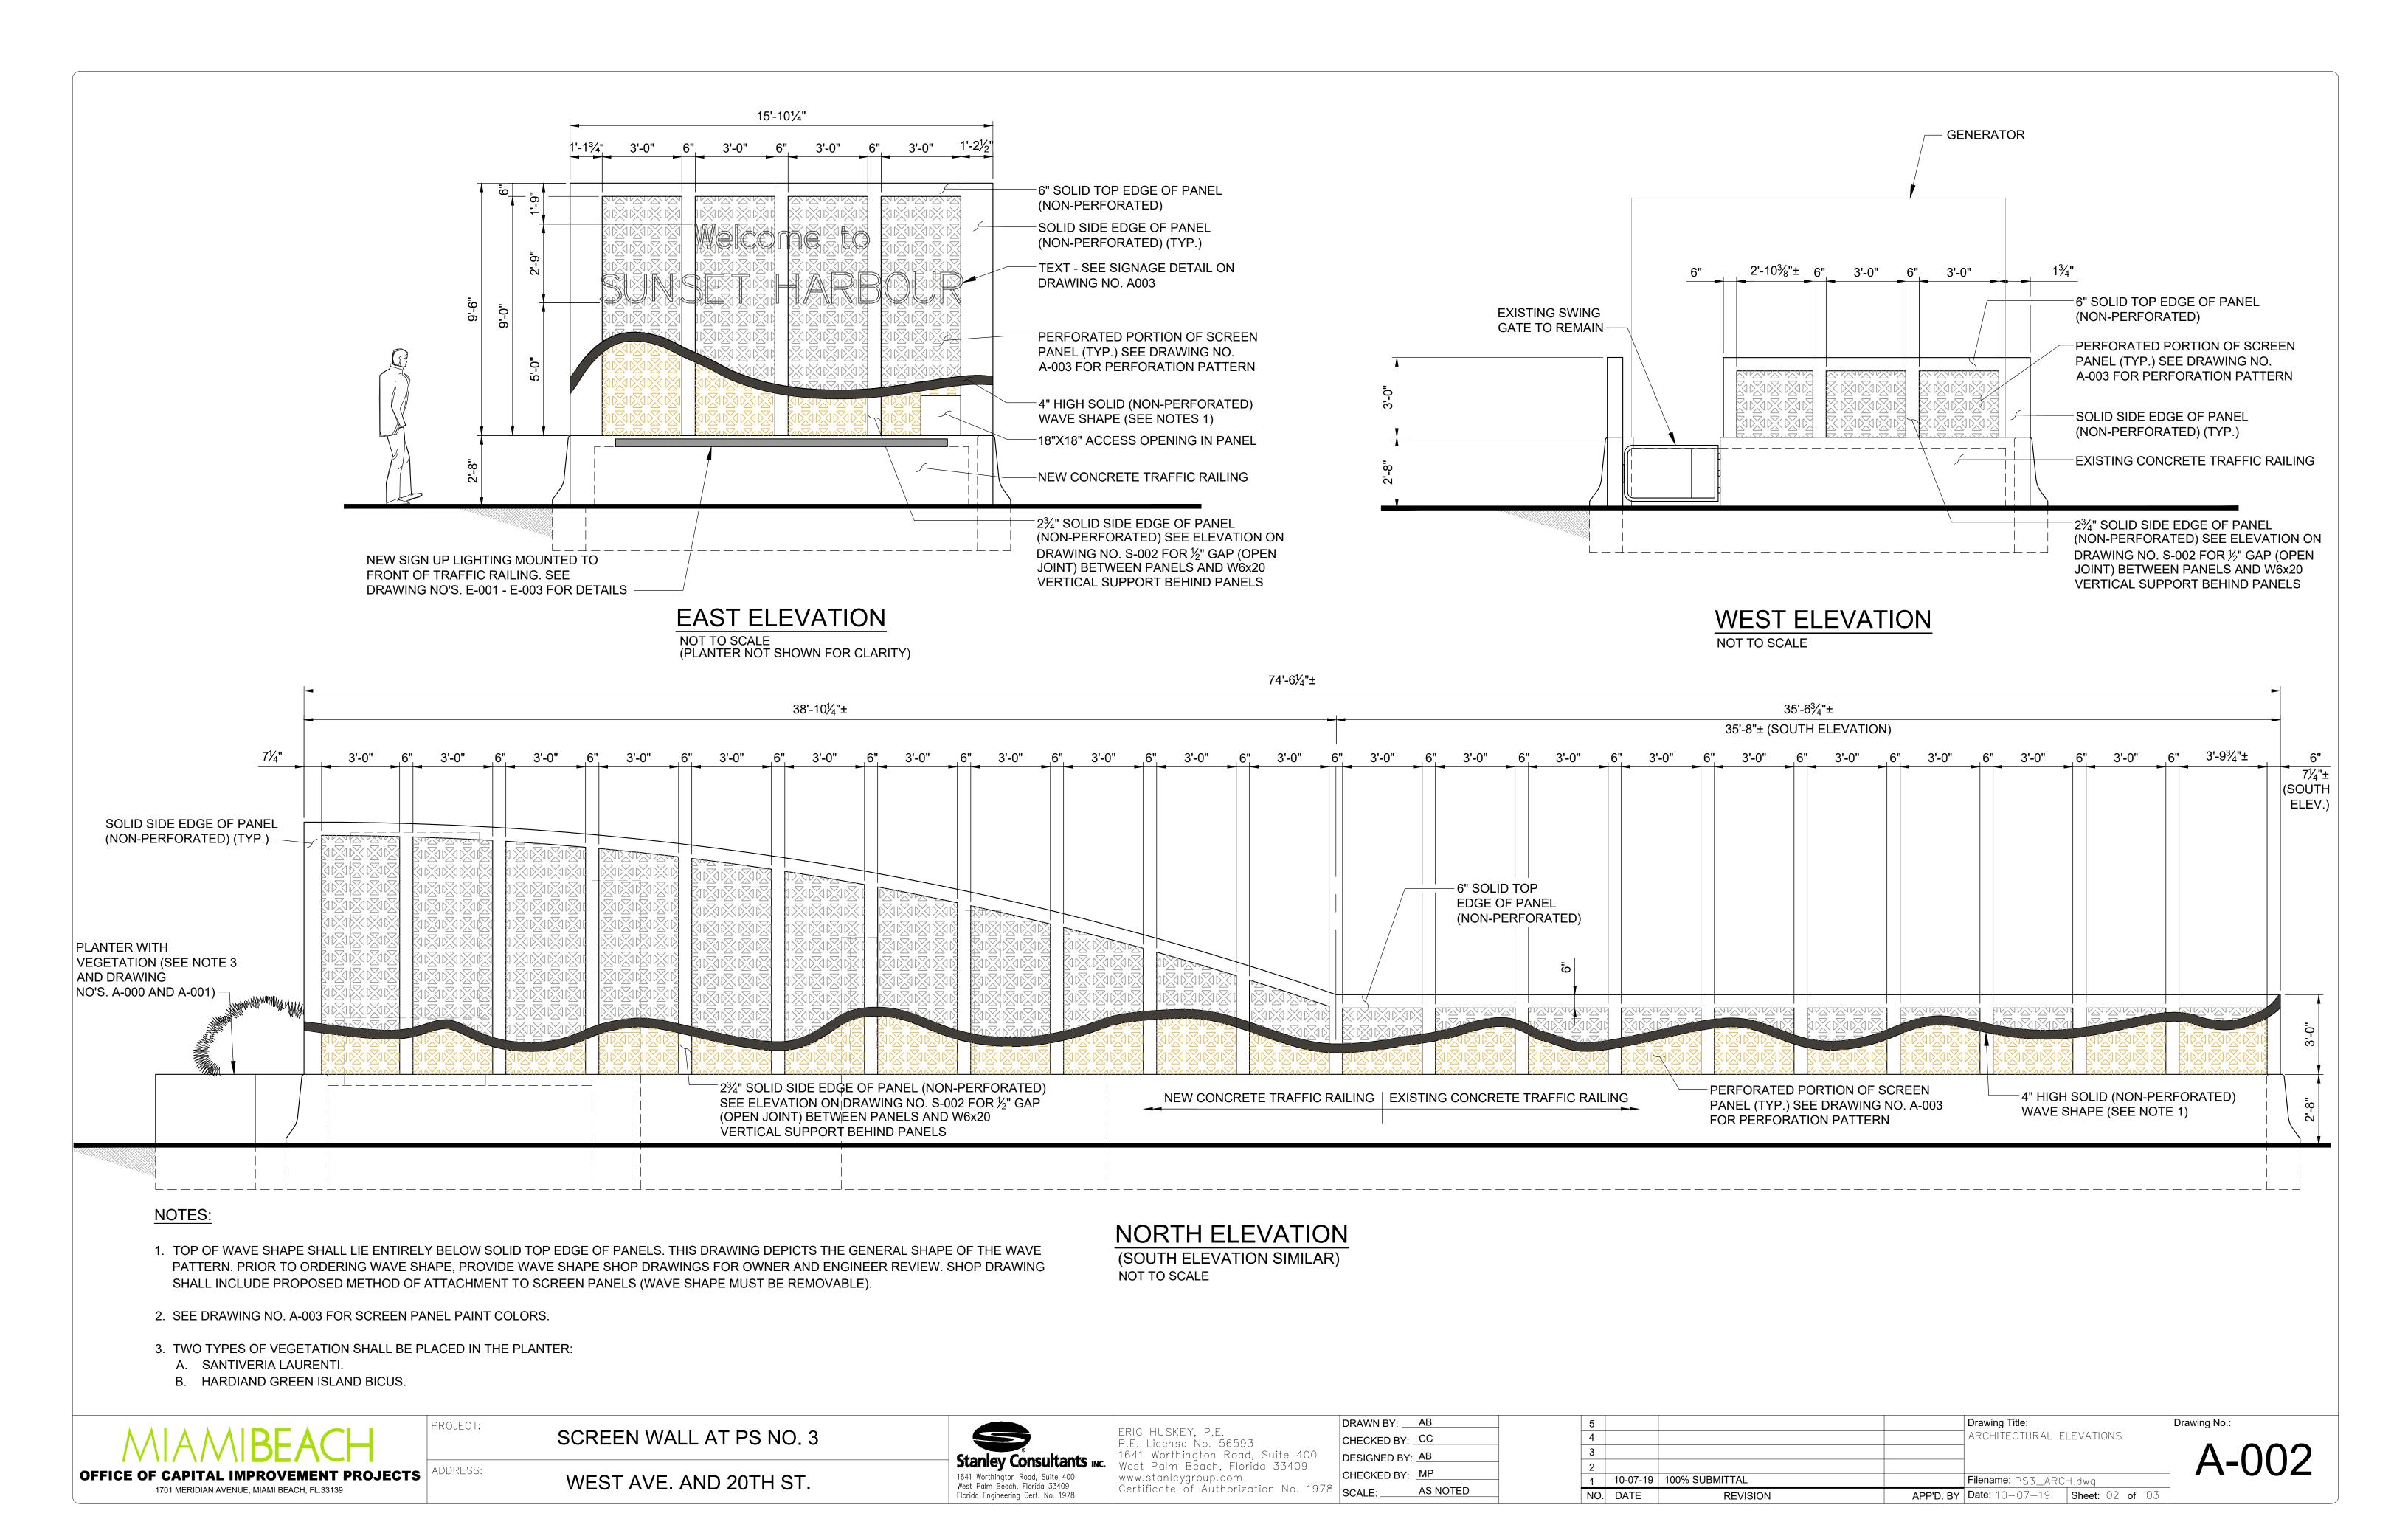

PERFORATION PATTERN:

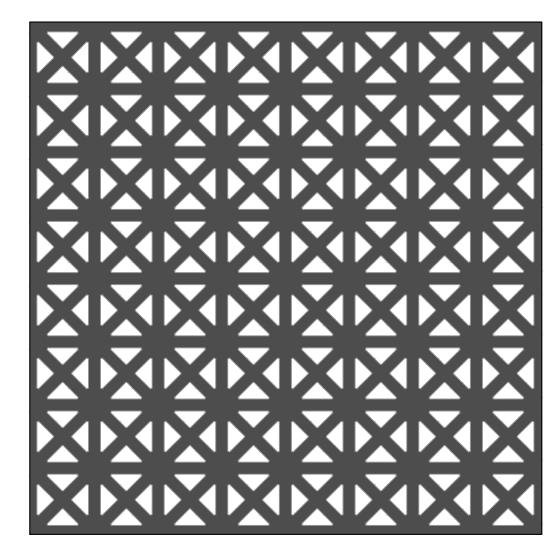


MANUFACTURER: McNICHOLS OR SIMILAR

NOTES:

- 1. SEE NOTE E AND "SCREEN WALL MATERIAL PROPERTIES" ON DRAWING NO. S-001.
- 2. AVAILABLE GRECIAN PATTERN SAMPLES WILL BE PROVIDED TO THE OWNER FOR REVIEW AND APPROVAL PRIOR TO ORDERING SCREEN PANELS.

SIGNAGE DETAIL:


FONT STYLE: FUTURA STD BOOK

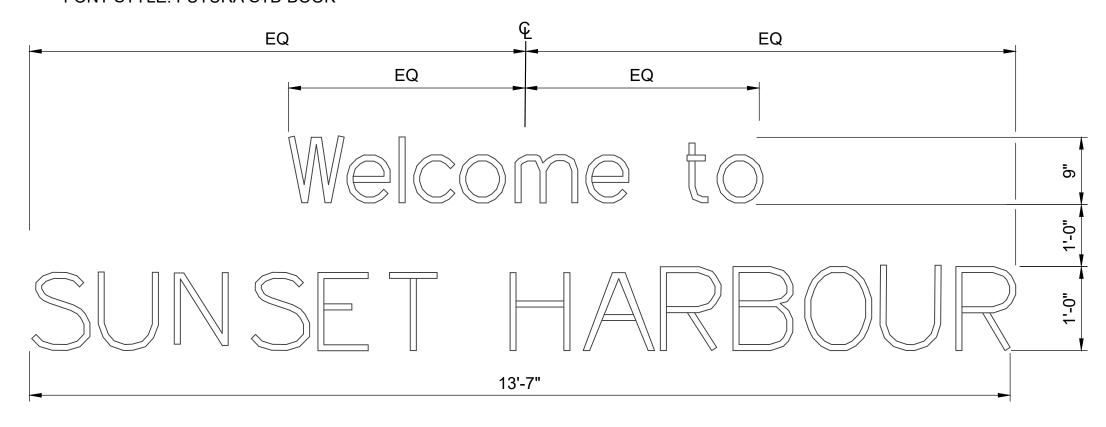


NOTE:

1. PRIOR TO ORDERING SIGN PROVIDE SIGN SHOP DRAWINGS FOR OWNER AND ENGINEER REVIEW. SHOP DRAWINGS SHALL INCLUDE PROPOSED METHOD OF ATTACHMENT TO SCREEN PANELS (SIGN MUST BE REMOVABLE).

COLOR CHART:

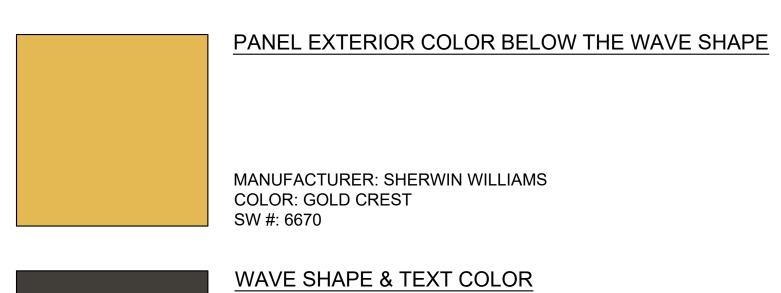



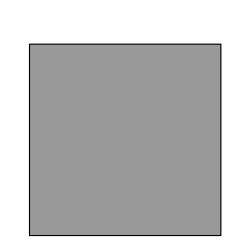

PANEL INTERIOR COLOR

MANUFACTURER: SHERWIN WILLIAMS COLOR: EIDER WHITE SW #: 7014

MIAMIBEACH	PROJECT:
OFFICE OF CAPITAL IMPROVEMENT PROJECTS 1701 MERIDIAN AVENUE, MIAMI BEACH, FL.33139	ADDRESS:

PROJECT: SCREEN WALL AT PS NO. 3

WEST AVE. AND 20TH ST.




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Certificate of Authorization No. 1978 | CHECKED BY: No. 1978 | SCALE: AS NOT

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CHECKED BY:	CC	İ
DESIGNED BY:	AB	İ
CHECKED BY:	MP	İ
SCALE:	AS NOTED	

5				Drawing Title:	
4				ARCHITECTURAL DETAILS	
3					
2					
1	10-07-19	100% SUBMITTAL		Filename: PS3_ARCH.dwg	
NO.	DATE	REVISION	APP'D. BY	Date: 10-07-19 Sheet: 03 of 0	13

Drawing No.:

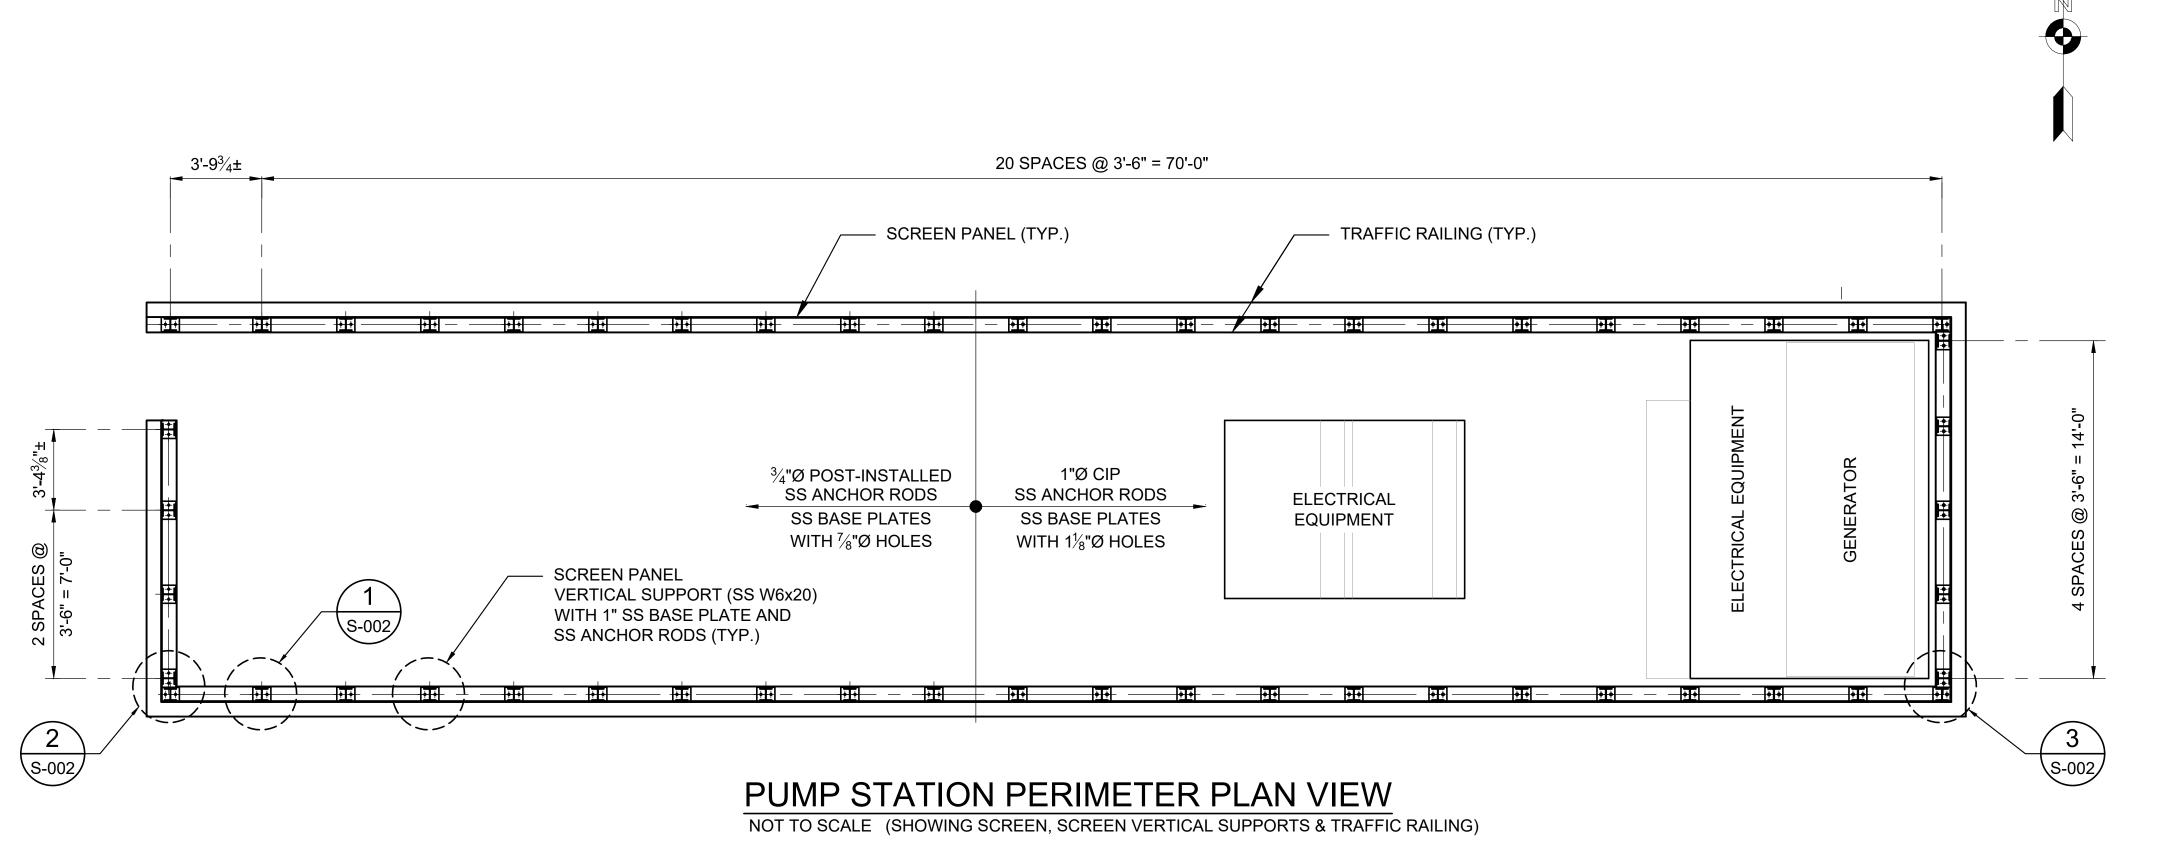

NOTES:

- A. CONSTRUCTION SPECIFICATIONS:
- 1. FLORIDA DEPARTMENT OF TRANSPORTATION (FDOT) JANUARY 2019 STANDARD SPECIFICATIONS FOR ROAD AND BRIDGE CONSTRUCTION, AS AMENDED BY CONTRACT DOCUMENTS.
- 2. "PART II MINIMUM SPECIFICATIONS" IN CITY OF MIAMI BEACH PUBLIC WORKS MANUAL.
- 3. AMERICAN WELDING SOCIETY (AWS) D1.6 STRUCTURAL WELDING CODE -STAINLESS STEEL.
- B. DESIGN WIND SPEED = 170 MPH.
- C. DIMENSION VERIFICATION:

UNLESS OTHERWISE NOTED, THE DIMENSIONS SHOWN ARE BASED ON THE INFORMATION DETAILED IN THE ORIGINAL CONSTRUCTION PLANS AND AVAILABLE AS-BUILT PLANS OF THE EXISTING PUMP STATION AND MAY NOT REPRESENT ALL AS-BUILT CONDITIONS. IT IS THE CONTRACTOR'S RESPONSIBILITY TO VERIFY THE DATA BEFORE BEGINNING CONSTRUCTION AND NOTIFY THE ENGINEER OF ANY DISCREPANCIES.

- D. SCREEN WALL (SCREEN) CONSIST OF SCREEN PANELS BETWEEN VERTICAL SUPPORTS.
- E. SCREEN PANELS ARE 1/4" THICK PERFORATED STAINLESS STEEL SHEETS. SEE ARCHITECTURAL DRAWING NUMBER A-003 FOR PERFORATION PATTERN ON SCREEN PANELS.
- F. SCREEN PANEL SHOP DRAWINGS SHALL BE SUBMITTED TO THE ENGINEER FOR REVIEW AND APPROVAL PRIOR TO BEGINNING FABRICATION.

SCREEN WALL MATERIAL PROPERTIES

- STAINLESS STEEL SCREEN PANELS ASTM A240, GRADE 316.
- STAINLESS STEEL SHAPES (W6x20) ASTM A276, GRADE 316L.
- STAINLESS STEEL BASE PLATES ASTM A240, GRADE 316L.
- STAINLESS STEEL THREADED ANCHOR RODS ASTM F593, GRADE 316L, FY=70 KSI.
- STAINLESS STEEL HEAVY HEX BOLTS F593, FY=30 KSI.
- STAINLESS STEEL HEAVY HEX NUTS AND WASHERS ASTM F594.


LEGEND

AWS = AMERICAN WELDING SOCIETY

CIP = CAST-IN-PLACE

FDOT = FLORIDA DEPARTMENT OF TRANSPORTATION

SS = STAINLESS STEEL

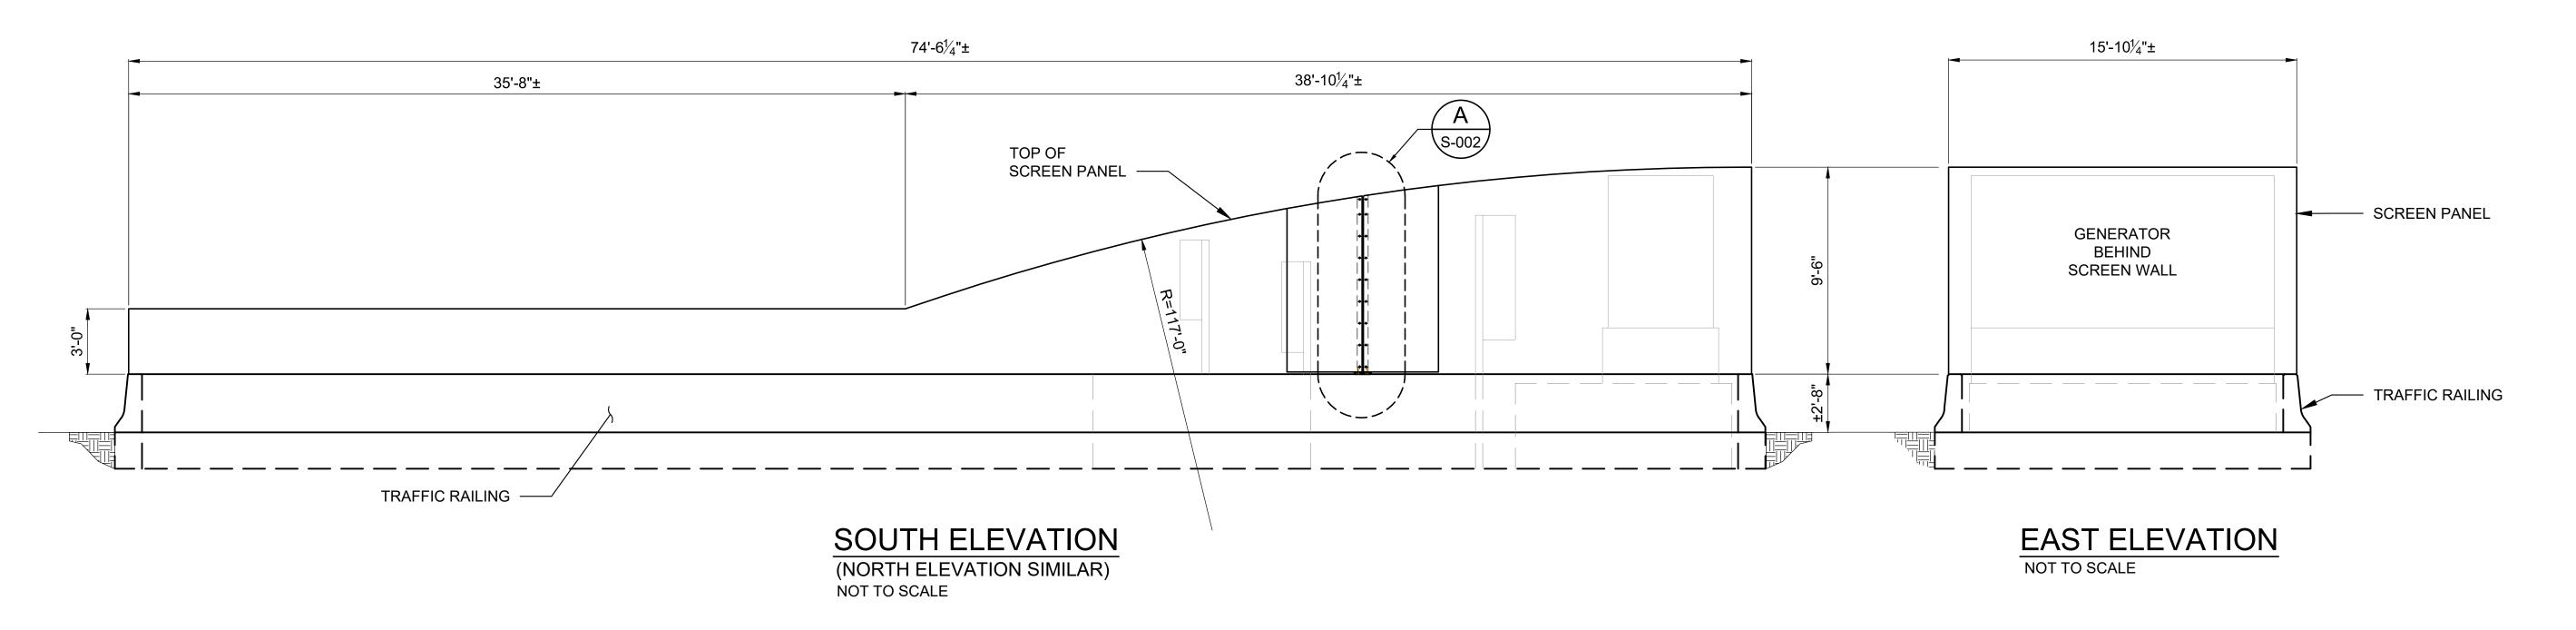

OFFICE OF CAPITAL IMPROVEMENT PROJECTS 1701 MERIDIAN AVENUE, MIAMI BEACH, FL.33139

PROJECT: SCREEN WALL AT PS NO. 3 ADDRESS: WEST AVE. AND 20TH ST.


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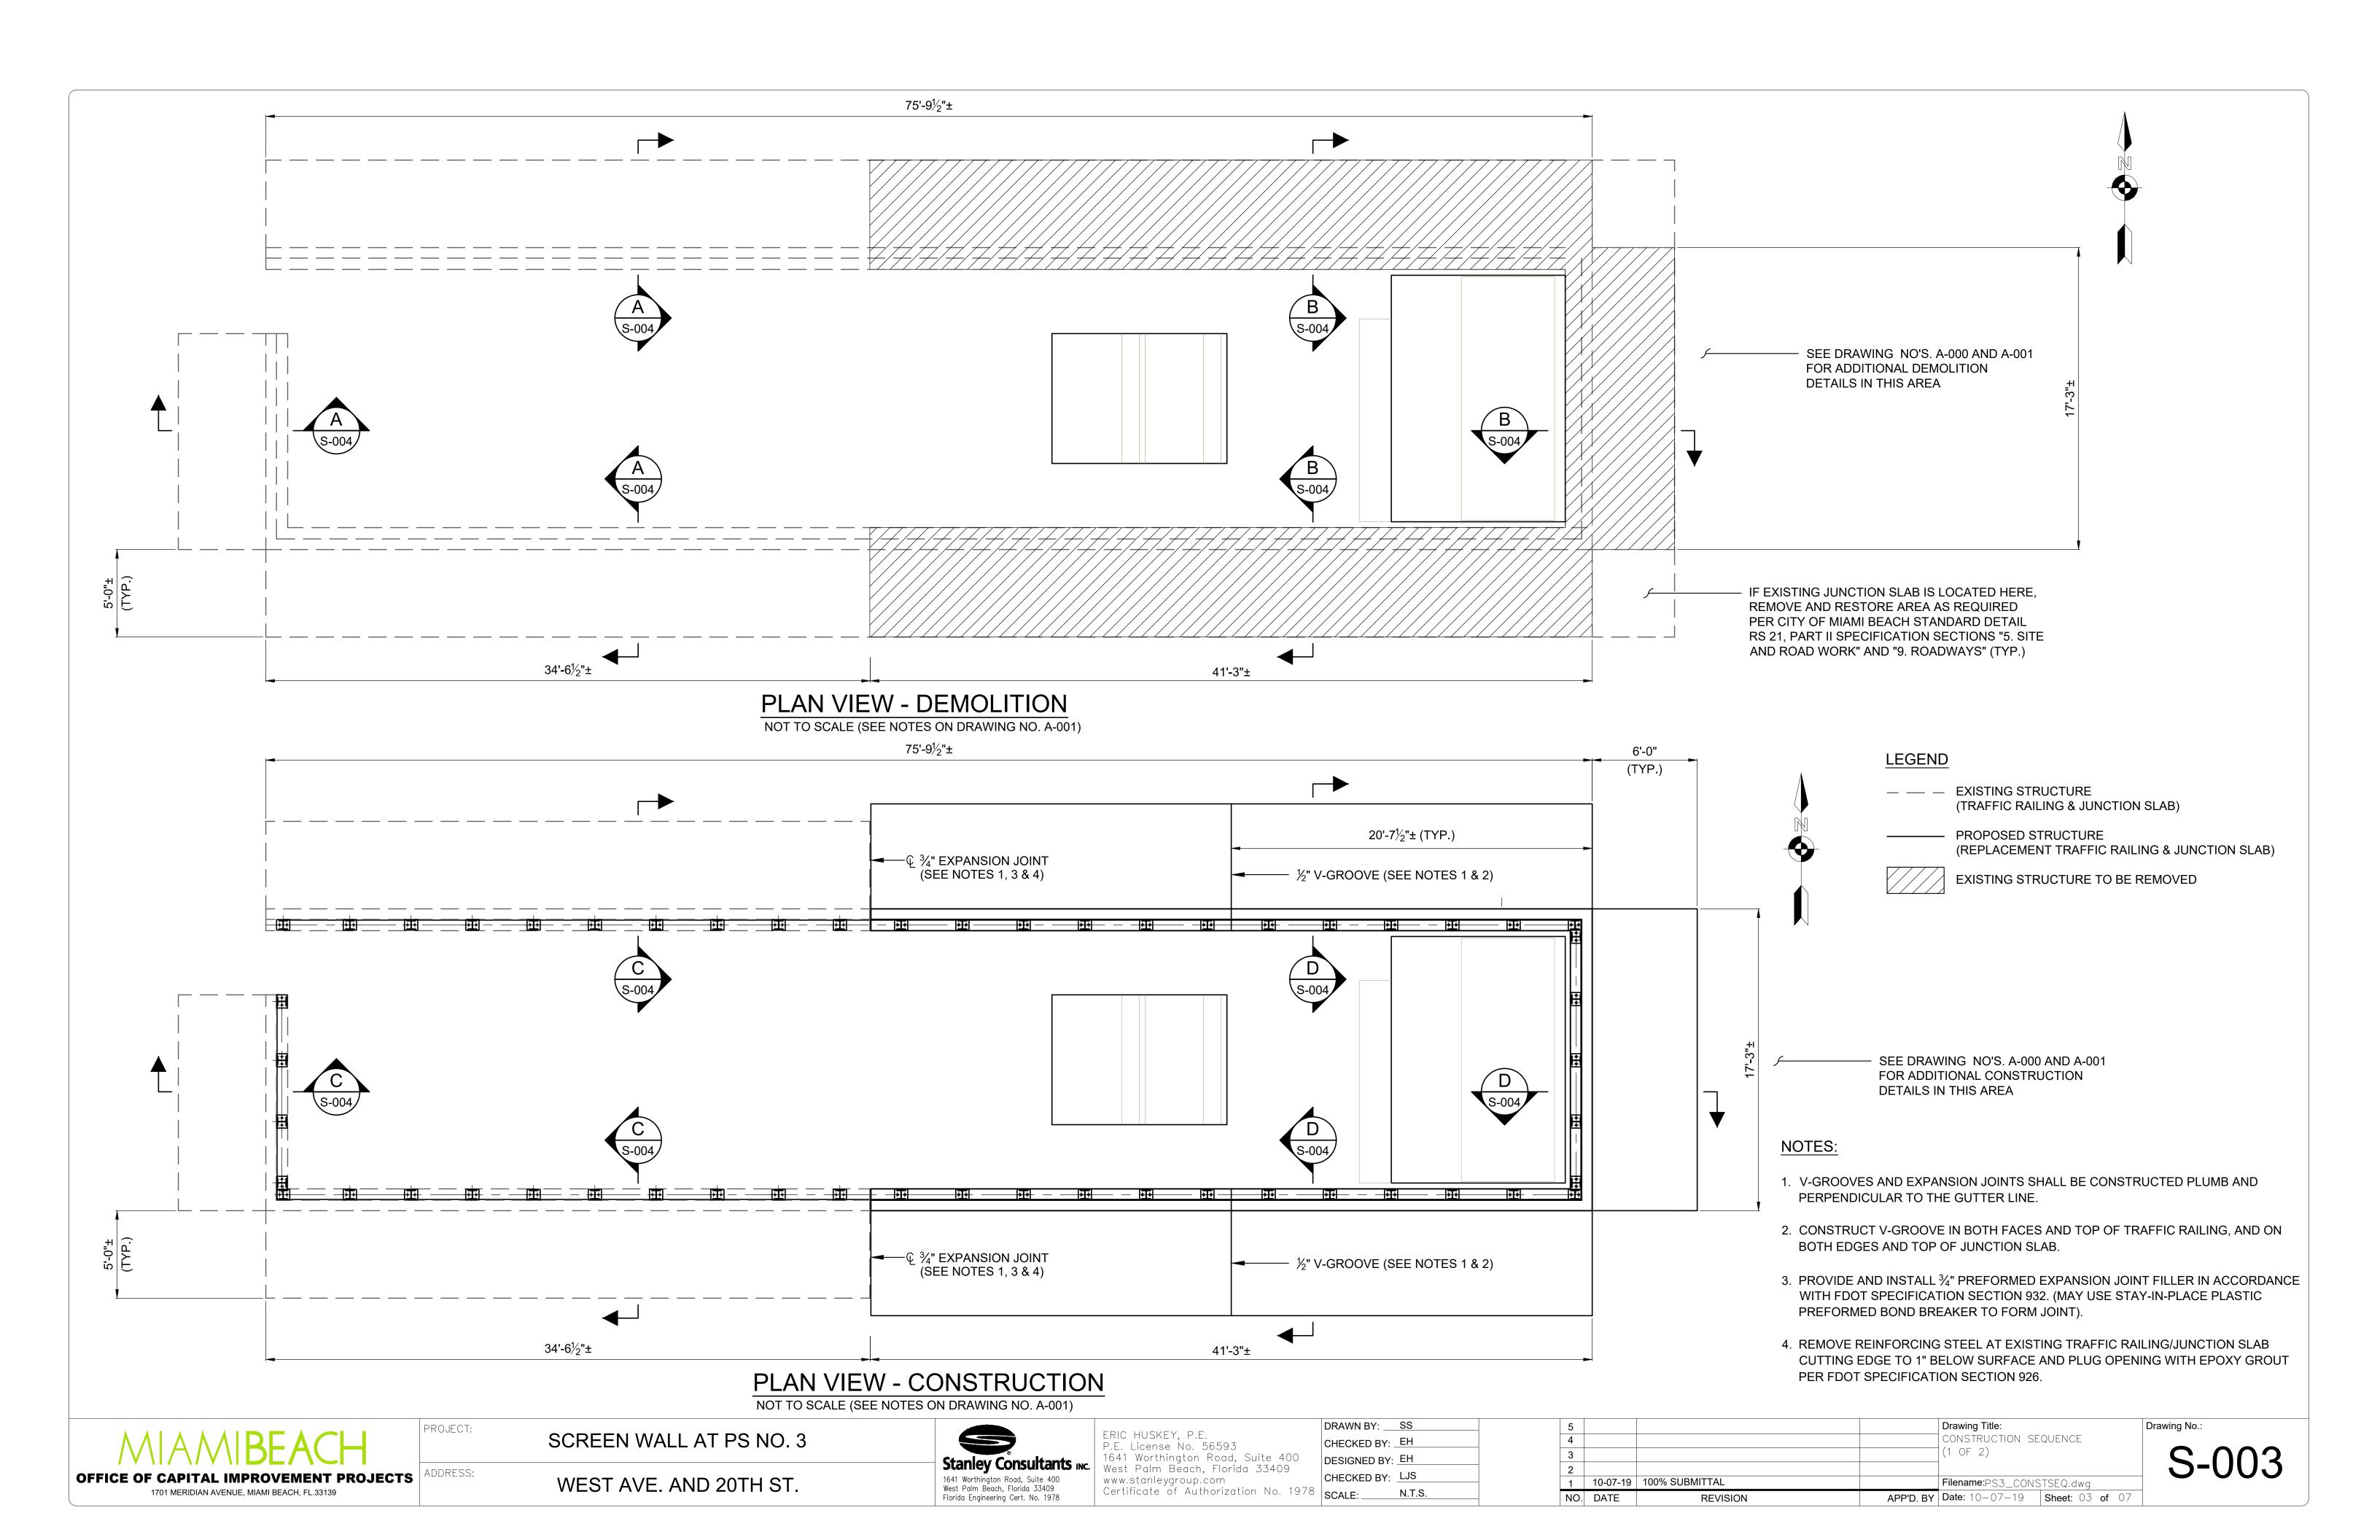
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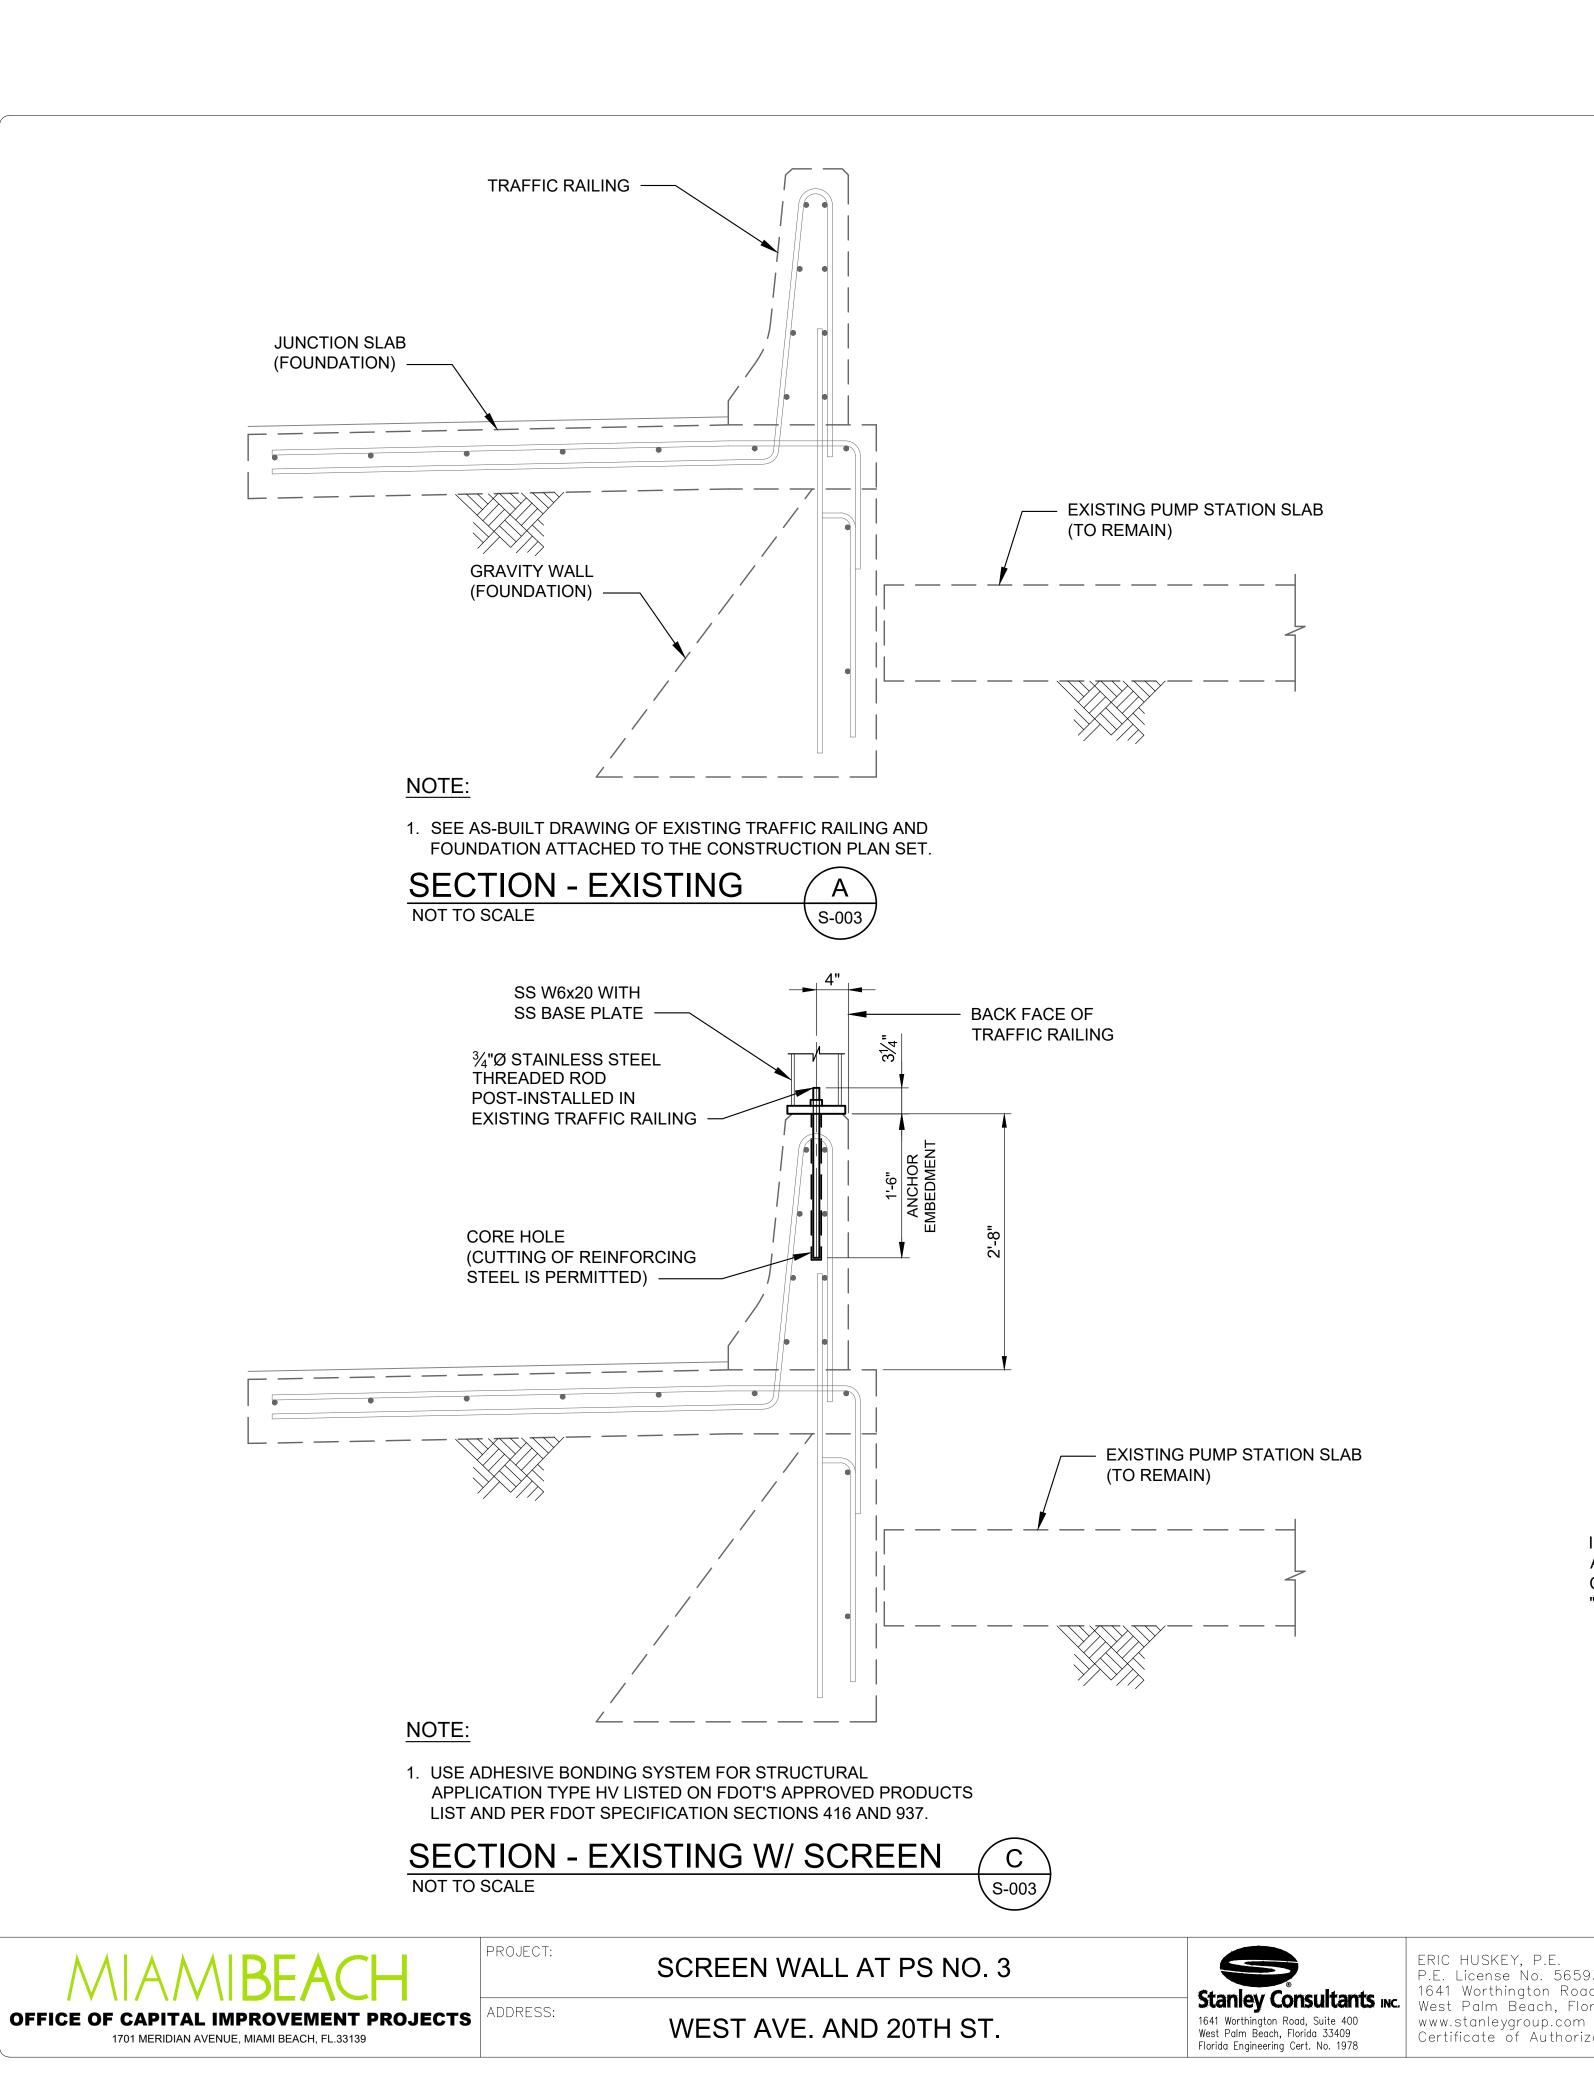
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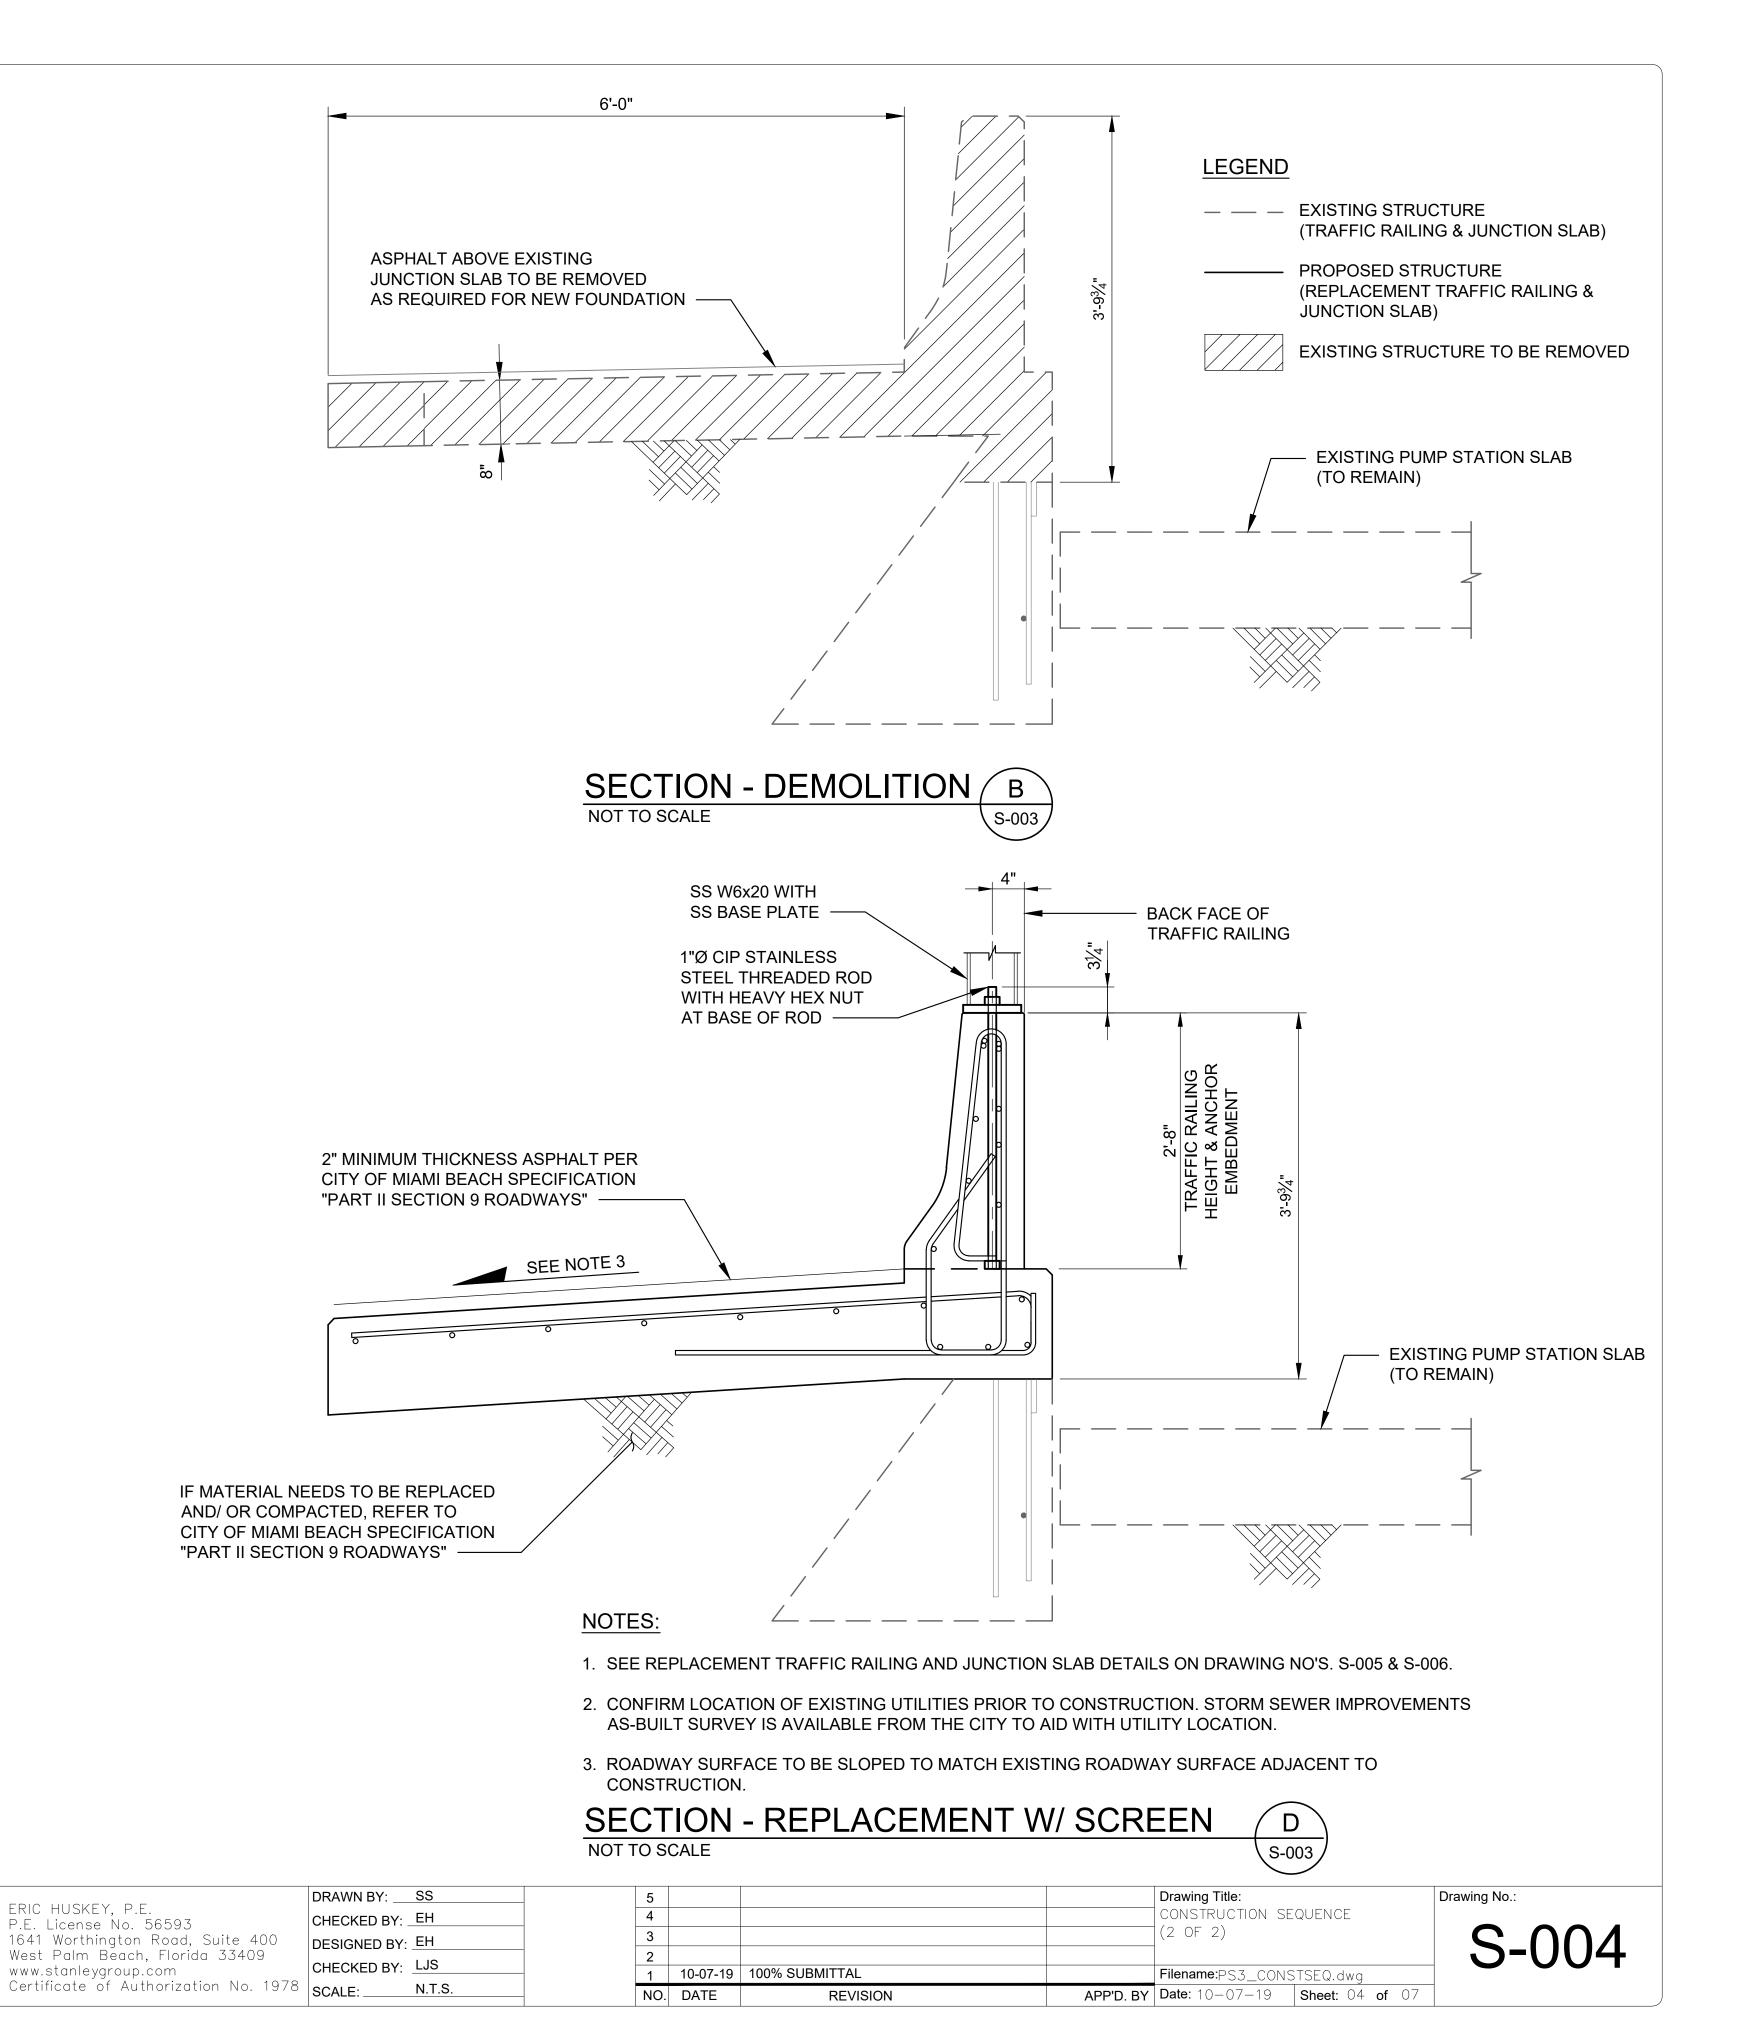
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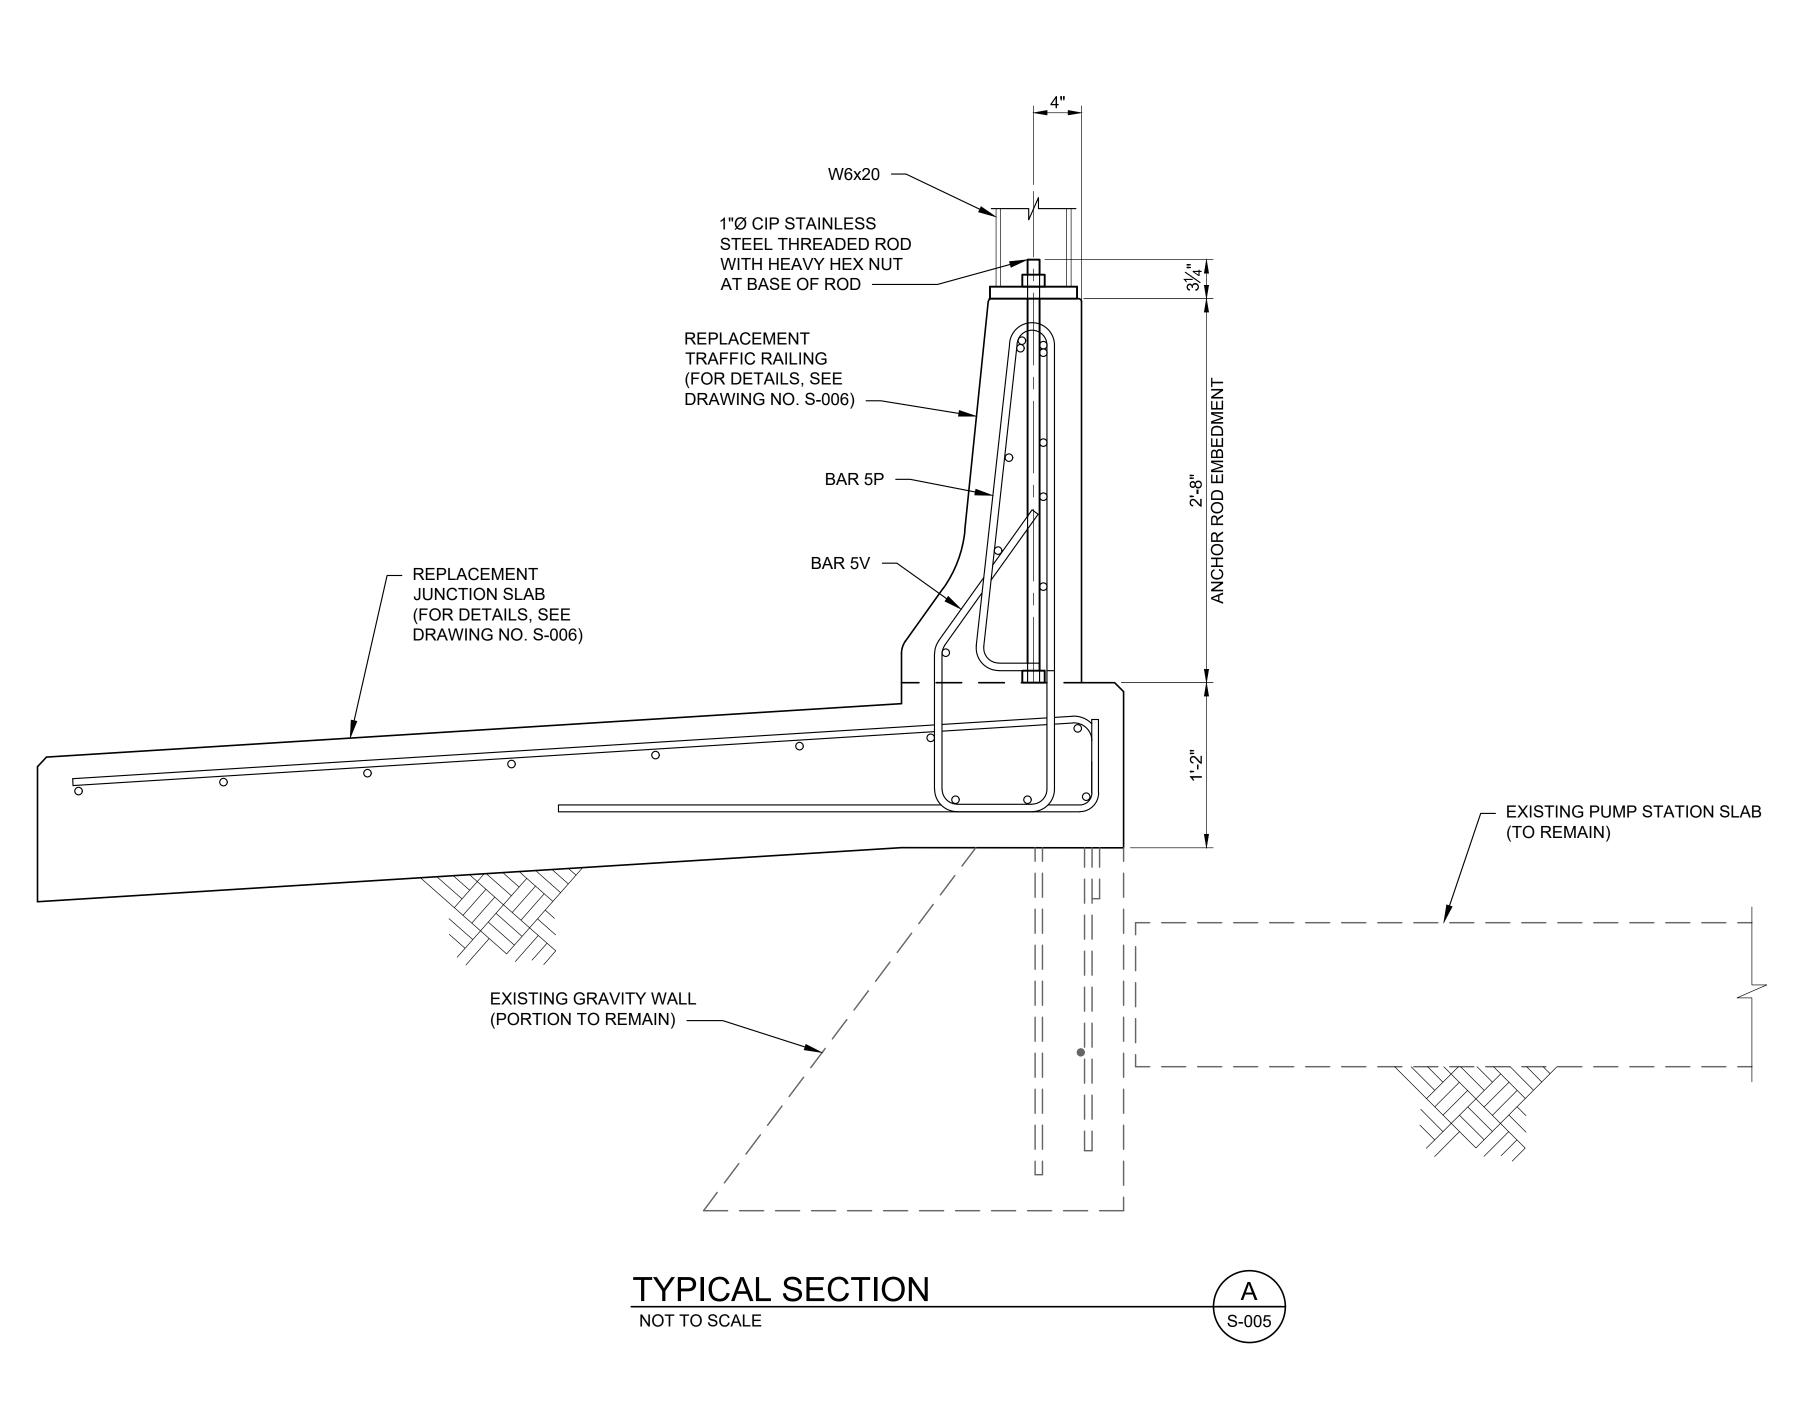
S-001










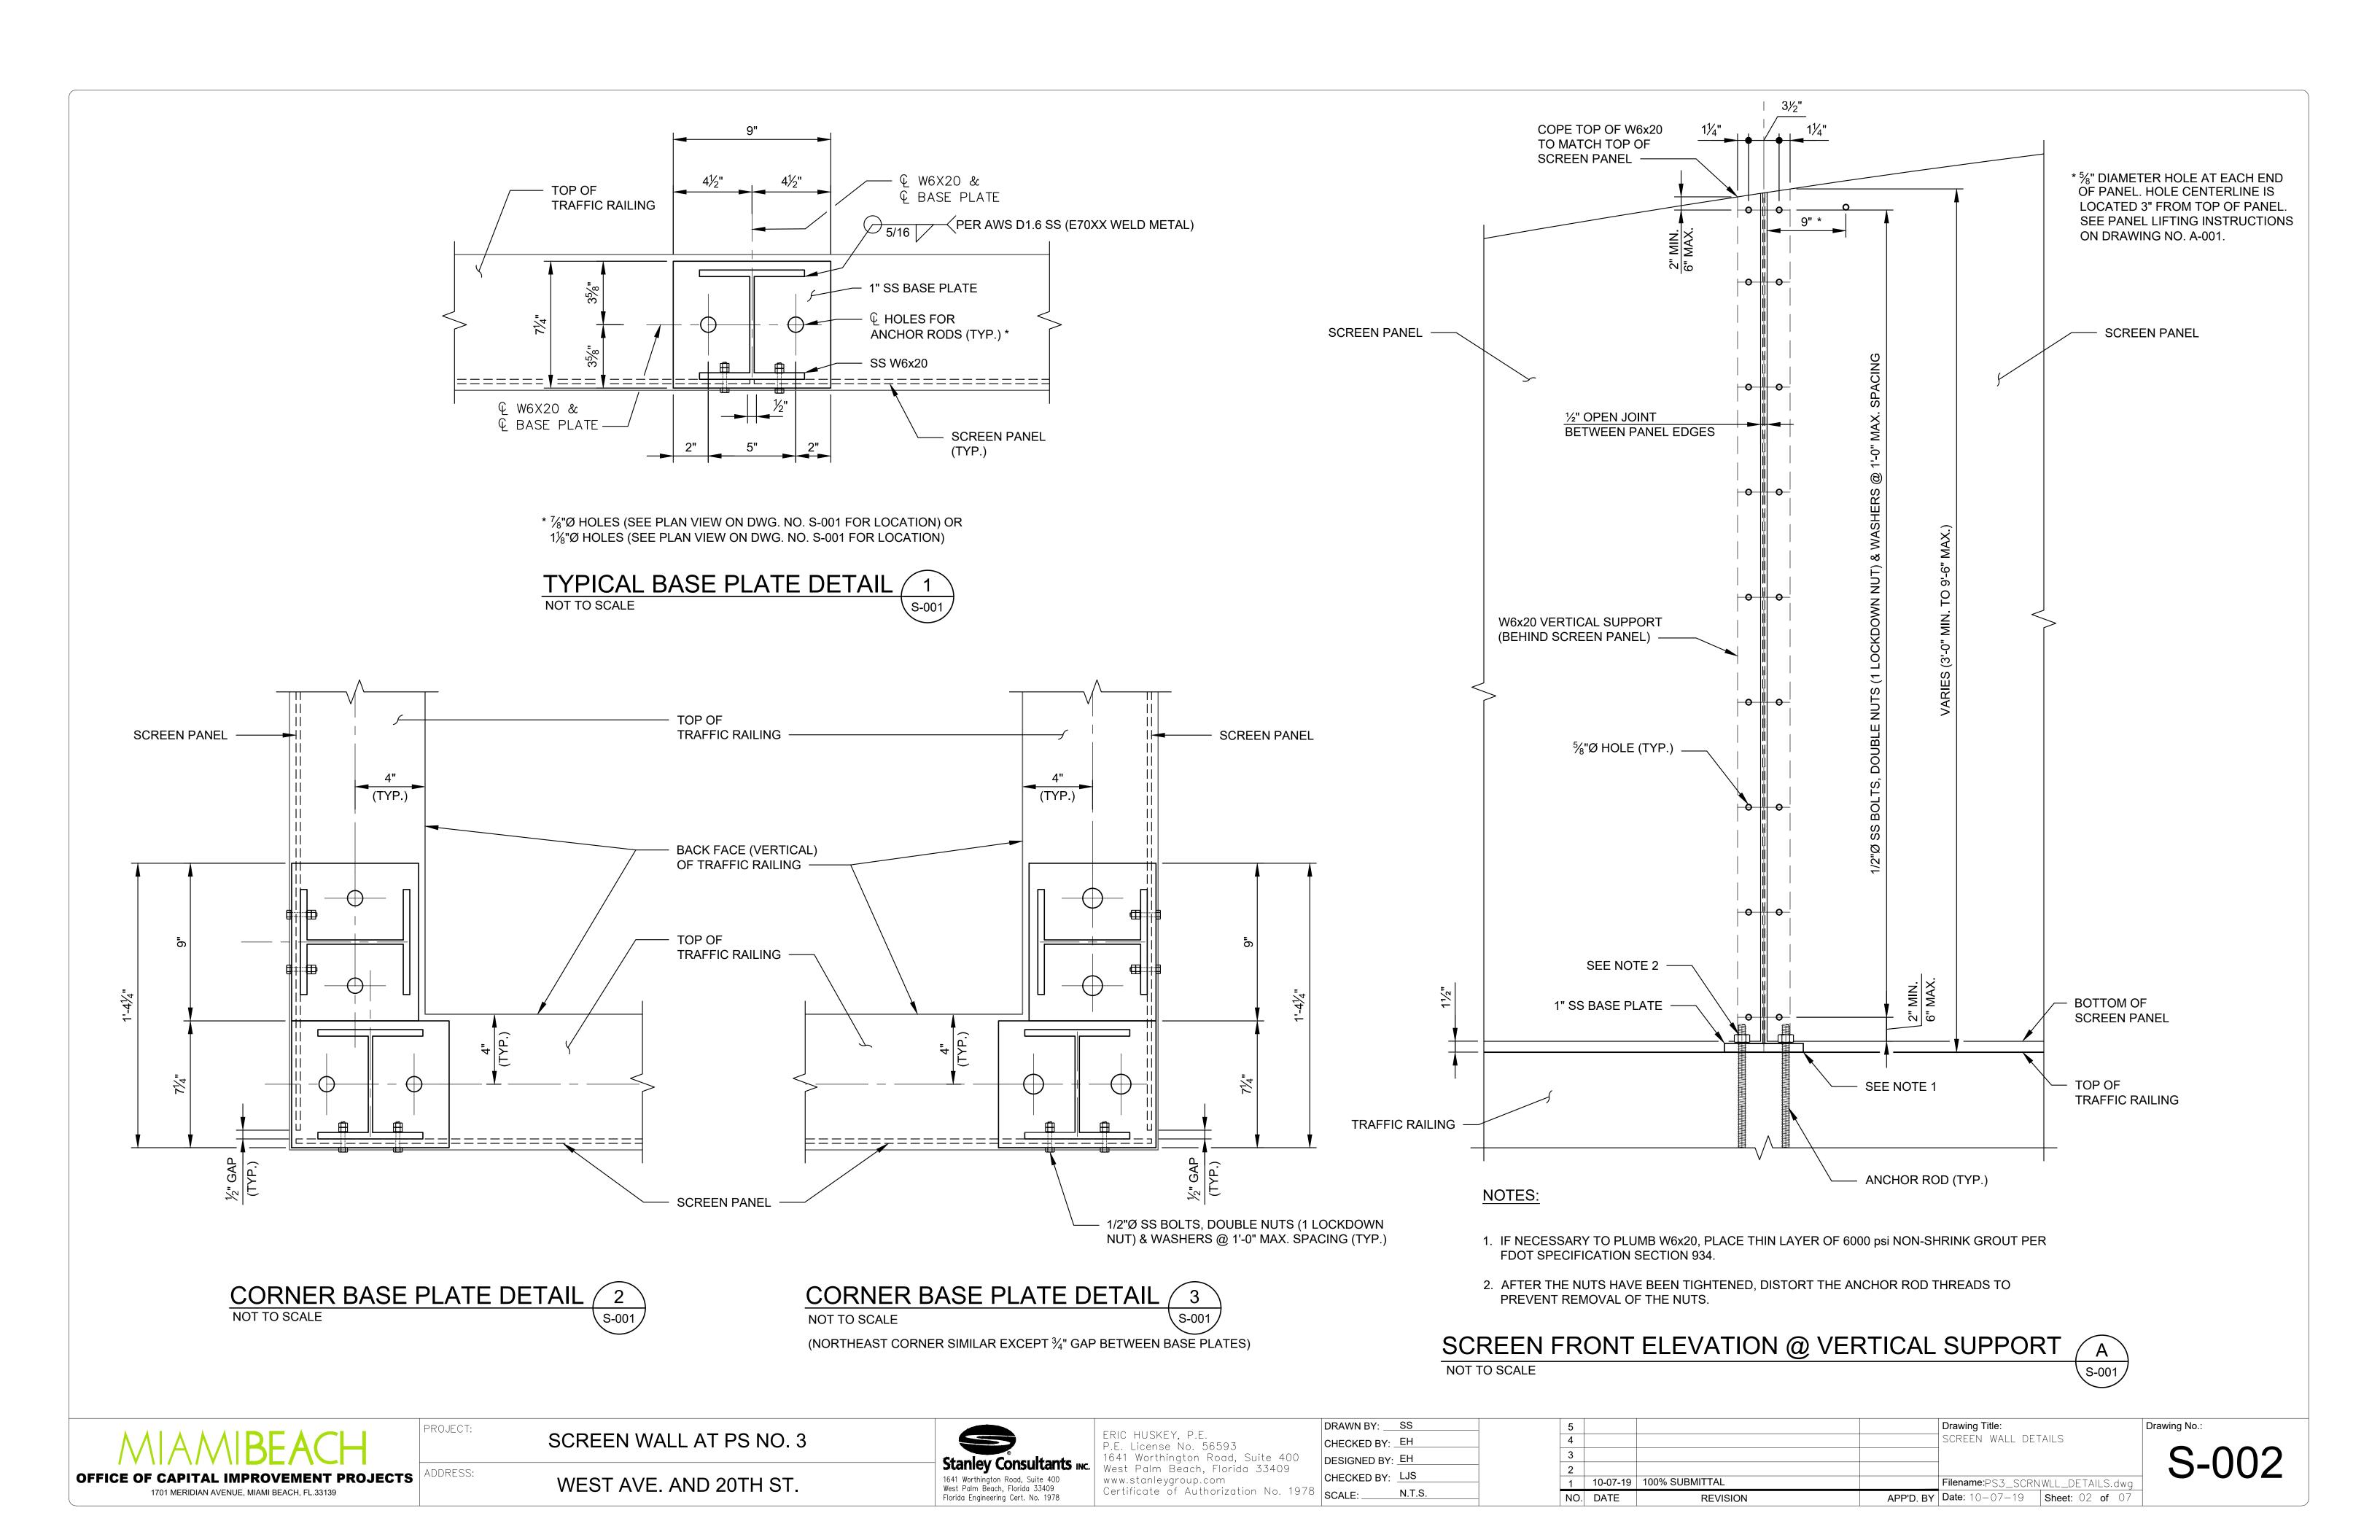

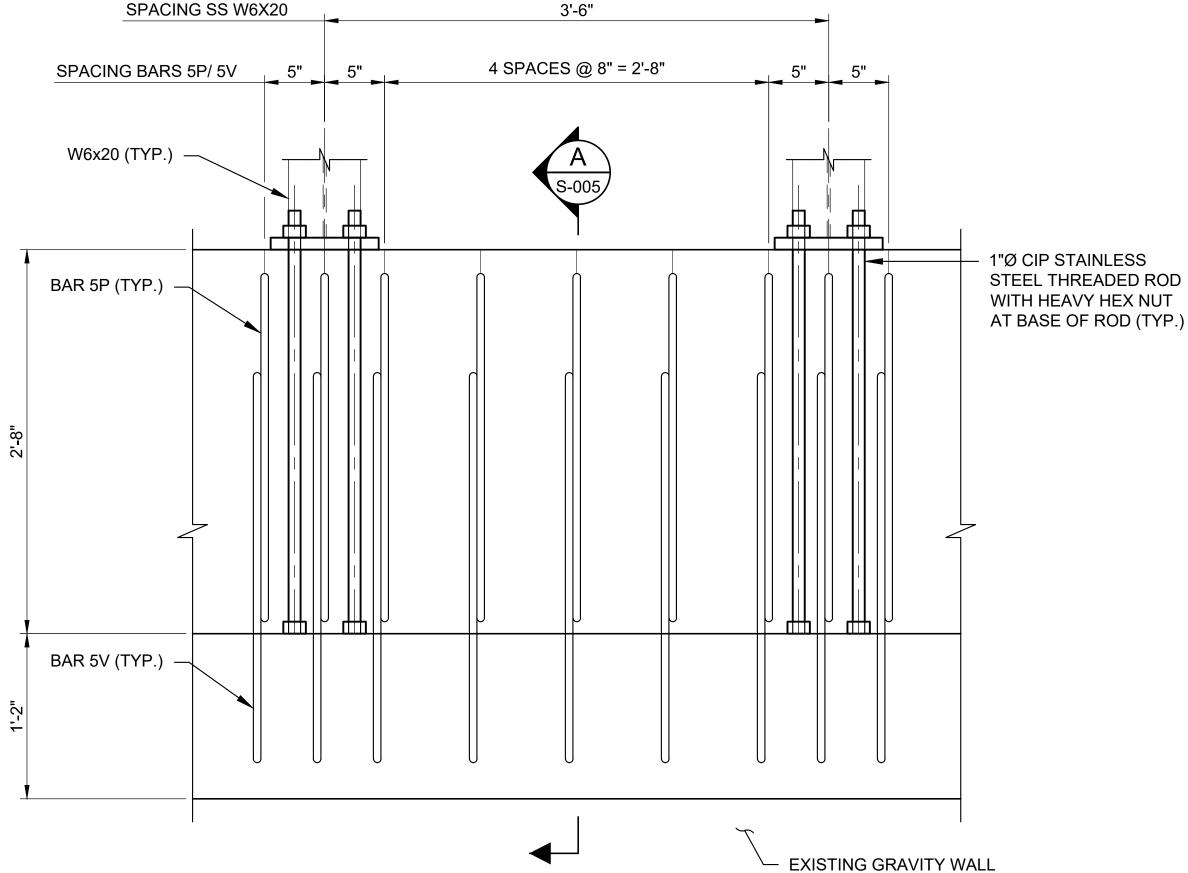


TYPICAL ELEVATION

NOT TO SCALE (ONLY BARS 5P AND 5V SHOWN FOR CLARITY)

TRAFFIC RAILING AND JUNCTION SLAB MATERIALS

- 1. REINFORCING STEEL
- I) ALL REINFORCING STEEL SHALL BE CARBON STEEL PER FDOT SPECIFICATION SECTION 931.
- II) ALL DIMENSIONS PERTAINING TO LOCATION OF REINFORCING STEEL ARE TO CENTERLINE OF BARS EXCEPT WHERE THE CLEAR DIMENSION IS SHOWN FROM FACE OF BAR TO FACE OF CONCRETE OR OTHER ELEMENT.
- III) TYPICAL REINFORCING BARS ARE MARKED AS FOLLOWS:

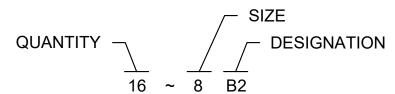

2. CONCRETE

CONCRETE SHALL CONFORM TO FDOT SPECIFICATION SECTION 346.

CONCRETE CLASS	MINIMUM 28 DAY COMPRESSIVE STRENGTH (PSI)	LOCATION OF CONCRETE IN STRUCTURE
IV	5,500	TRAFFIC RAILING JUNCTION SLAB PLANTER

LEGEND

— — EXISTING STRUCTURE (GRAVITY WALL & PUMP STATION SLAB)

> — PROPOSED STRUCTURE (REPLACEMENT TRAFFIC RAILING & JUNCTION SLAB)

OFFICE OF CAPITAL IMPROVEMENT PROJECTS 1701 MERIDIAN AVENUE, MIAMI BEACH, FL.33139

PROJECT: SCREEN WALL AT PS NO. 3 ADDRESS: WEST AVE. AND 20TH ST.


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DRAWN BY: SS CHECKED BY: EH DESIGNED BY: EH CHECKED BY: LJS

Drawing Title: 5 REPLACEMENT TRAFFIC RAILING AND JUNCTION SLAB DETAILS (1 OF 2) Filename:PS3_FOUND_DETAILS.dwg 1 10-07-19 100% SUBMITTAL APP'D. BY Date: 10-07-19 Sheet: 05 of 07 NO. DATE REVISION

S-005




NOTES:

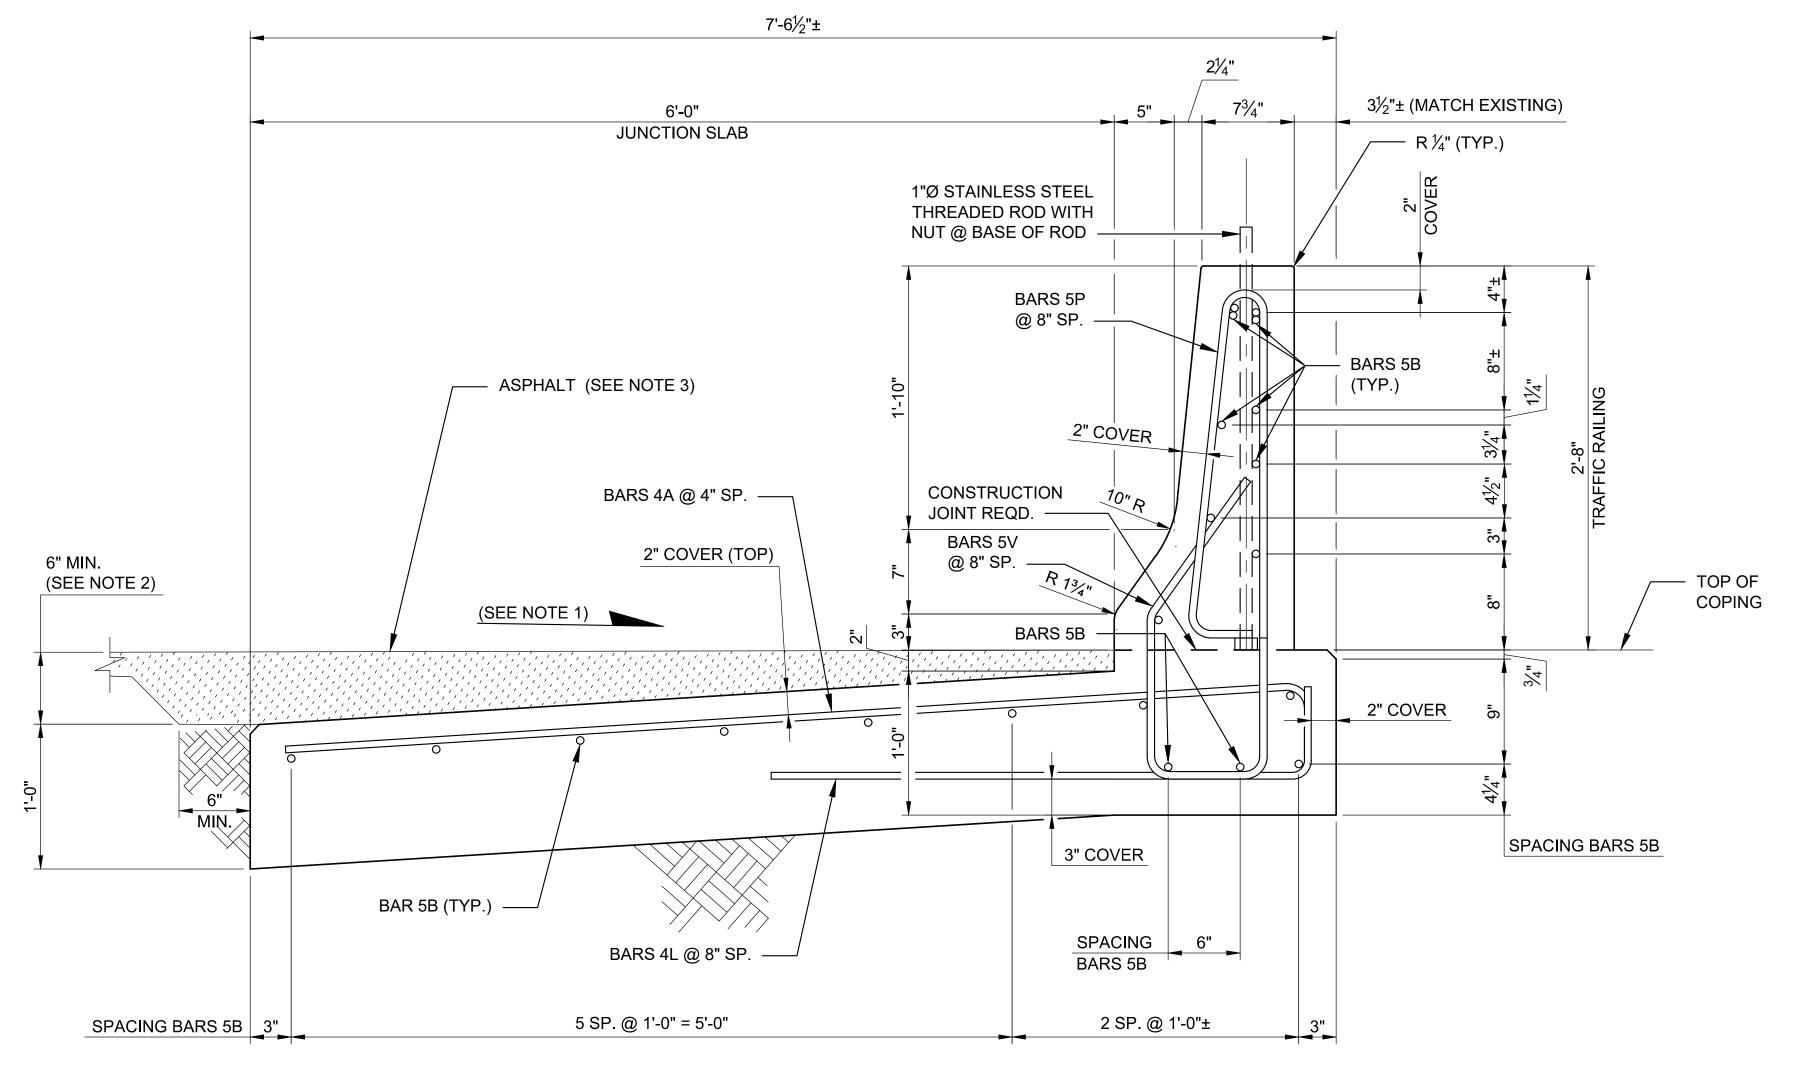- 1. ROADWAY SURFACE TO BE SLOPED TO MATCH EXISTING ROADWAY SURFACE ADJACENT TO CONSTRUCTION.
- 2. VARY THE JUNCTION SLAB SLOPE BASED ON THE ROADWAY CROSS SLOPE TO MAINTAIN A MINIMUM 6" ASPHALT DEPTH AT THE EDGE OF THE SLAB.
- 3. ASPHALT IS REQUIRED ON TOP OF THE JUNCTION SLAB FOR IT'S ENTIRE LENGTH ON THE TRAFFIC SIDE OF THE TRAFFIC RAILING. SEE CITY OF MIAMI BEACH SPECIFICATION "PART II SECTION 9 ROADWAYS".
- 4. UNLESS NOTED OTHERWISE, CONCRETE COVER SHALL BE 2".

TYPICAL SECTION - REPLACEMENT TRAFFIC RAILING & JUNCTION SLAB

NOT TO SCALE (EXISTING GRAVITY WALL NOT SHOWN FOR CLARITY)

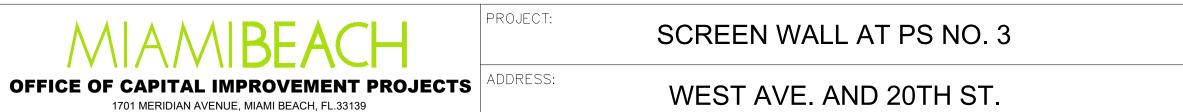





ERIC HUSKEY, P.E.
P.E. License No. 56593
1641 Worthington Road, Suite 400
West Palm Beach, Florida 33409
www.stanleygroup.com
Certificate of Authorization No. 1978

DRAWN BY: SS
CHECKED BY: EH
CHECKED BY: LJS
SCALE: N.T.S.


BILL (BILL OF REINFORCING STEEL						
MARK	SIZE	LENGTH					
А	4	7'-10"					
В	5	AS REQD.					
L	4	4'-5"					
Р	5	5'-7"					
V	5	5'-10½"					

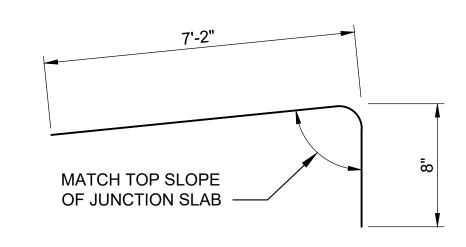


BAR 4A

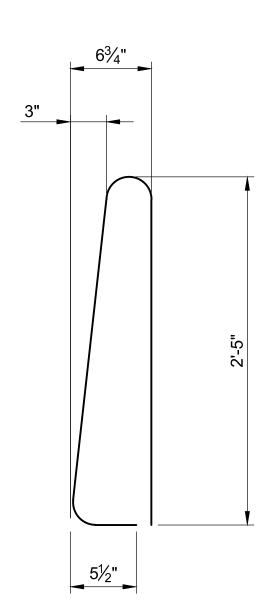

STIRRUPS BAR 5P

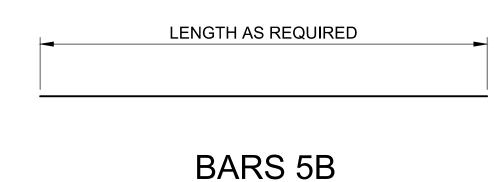

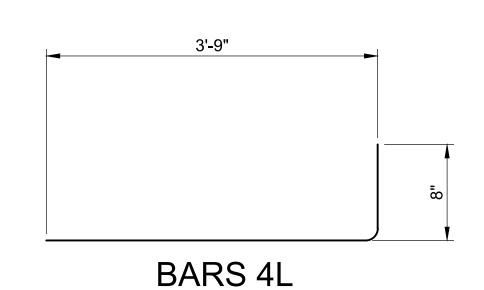

CONTRACTOR'S OPTION

10"


STIRRUPS BAR 5V

NOTES:


- 1. ALL BAR DIMENSIONS IN THE BENDING DIAGRAMS ARE OUT TO OUT.
- 2. ALL REINFORCING STEEL AT EXPANSION AND OPEN JOINTS WILL HAVE A 2" MINIMUM COVER.
- 3. LAP SPLICES FOR BARS 5B WILL BE A MINIMUM OF 2'-2".
- 4. CONTRACTOR MAY USE A SINGLE #5 STIRRUP IN LIEU OF TWO BARS FOR 5P AND 5V2.

REINFORCING STEEL BENDING DIAGRAMS

5 4 3 2				Drawing Title: REPLACEMENT TRA AND JUNCTION SL (2 OF 2)		S-006
1	10-07-19	100% SUBMITTAL		Filename:PS3_FOUN	D_DETAILS.dwg	
NO.	DATE	REVISION	APP'D. BY	Date : 10-07-19	Sheet: 06 of 07	

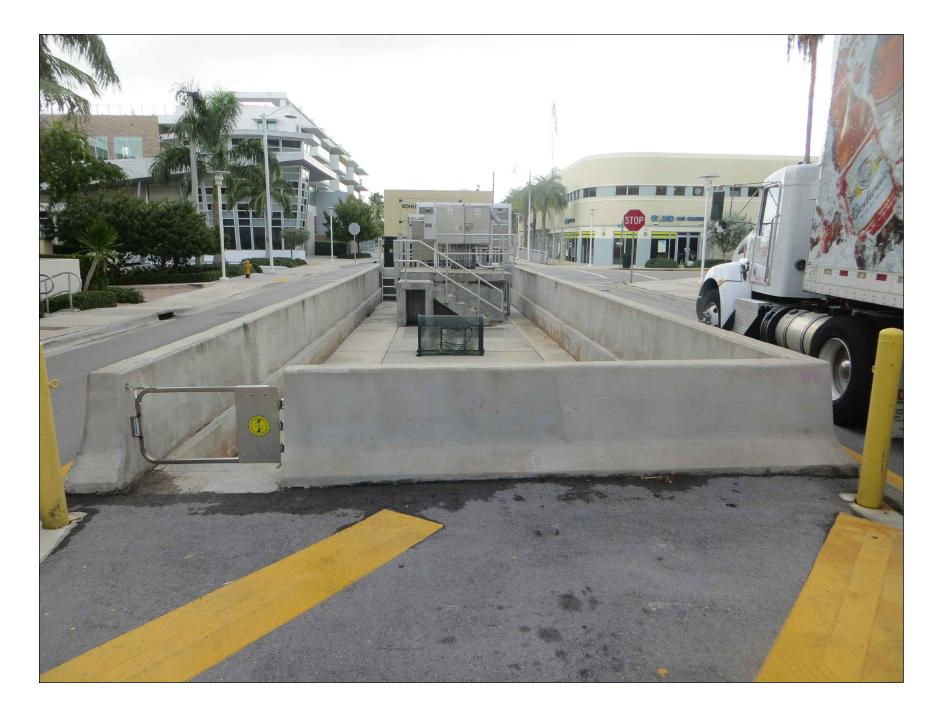

WEST END OF PROJECT

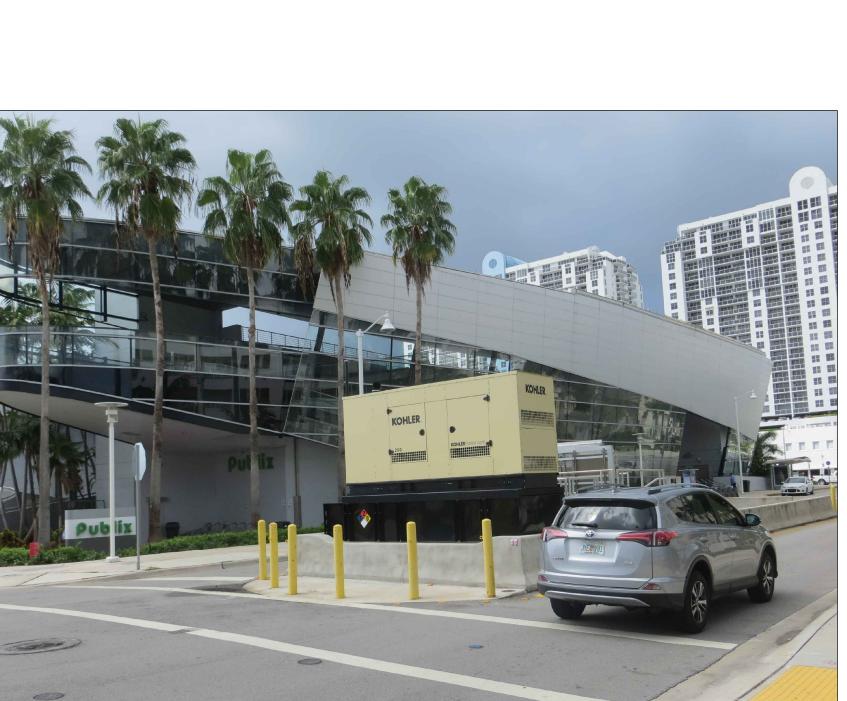


PUBLIX BEYOND PROJECT




ERIC HUSKEY, P.E. P.E. License No. 56593 1641 Worthington Road, Suite 400 West Palm Beach, Florida 33409 www.stanleygroup.com Certificate of Authorization No. 1978

SOUTHWEST CORNER OF PROJECT


DRAWN BY: SS CHECKED BY: EH DESIGNED BY: EH CHECKED BY: LJS

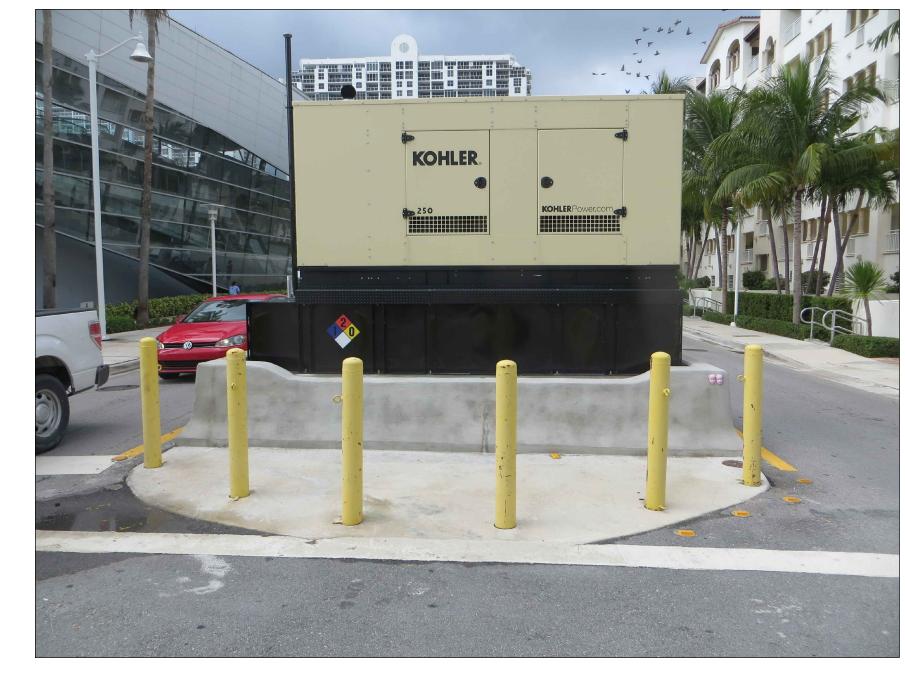

EAST END OF PROJECT

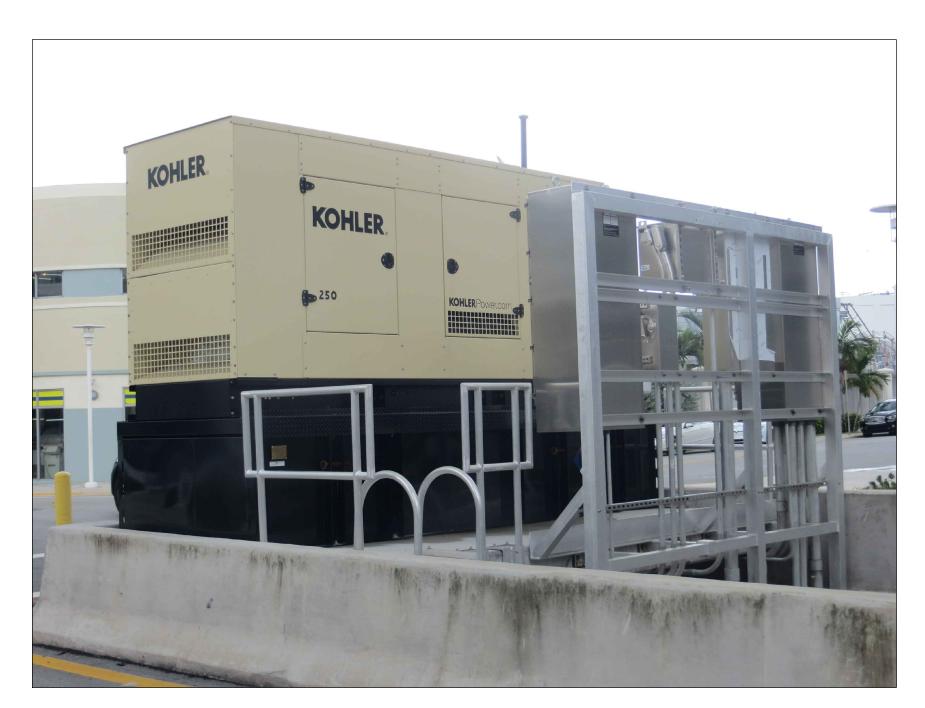



GENERATOR AND ELECTRICAL EQUIPMENT

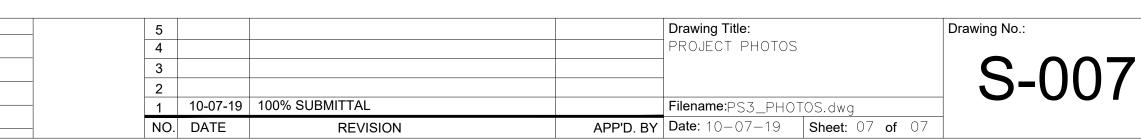

SCREEN WALL AT PS NO. 3 ADDRESS:

WEST AVE. AND 20TH ST.

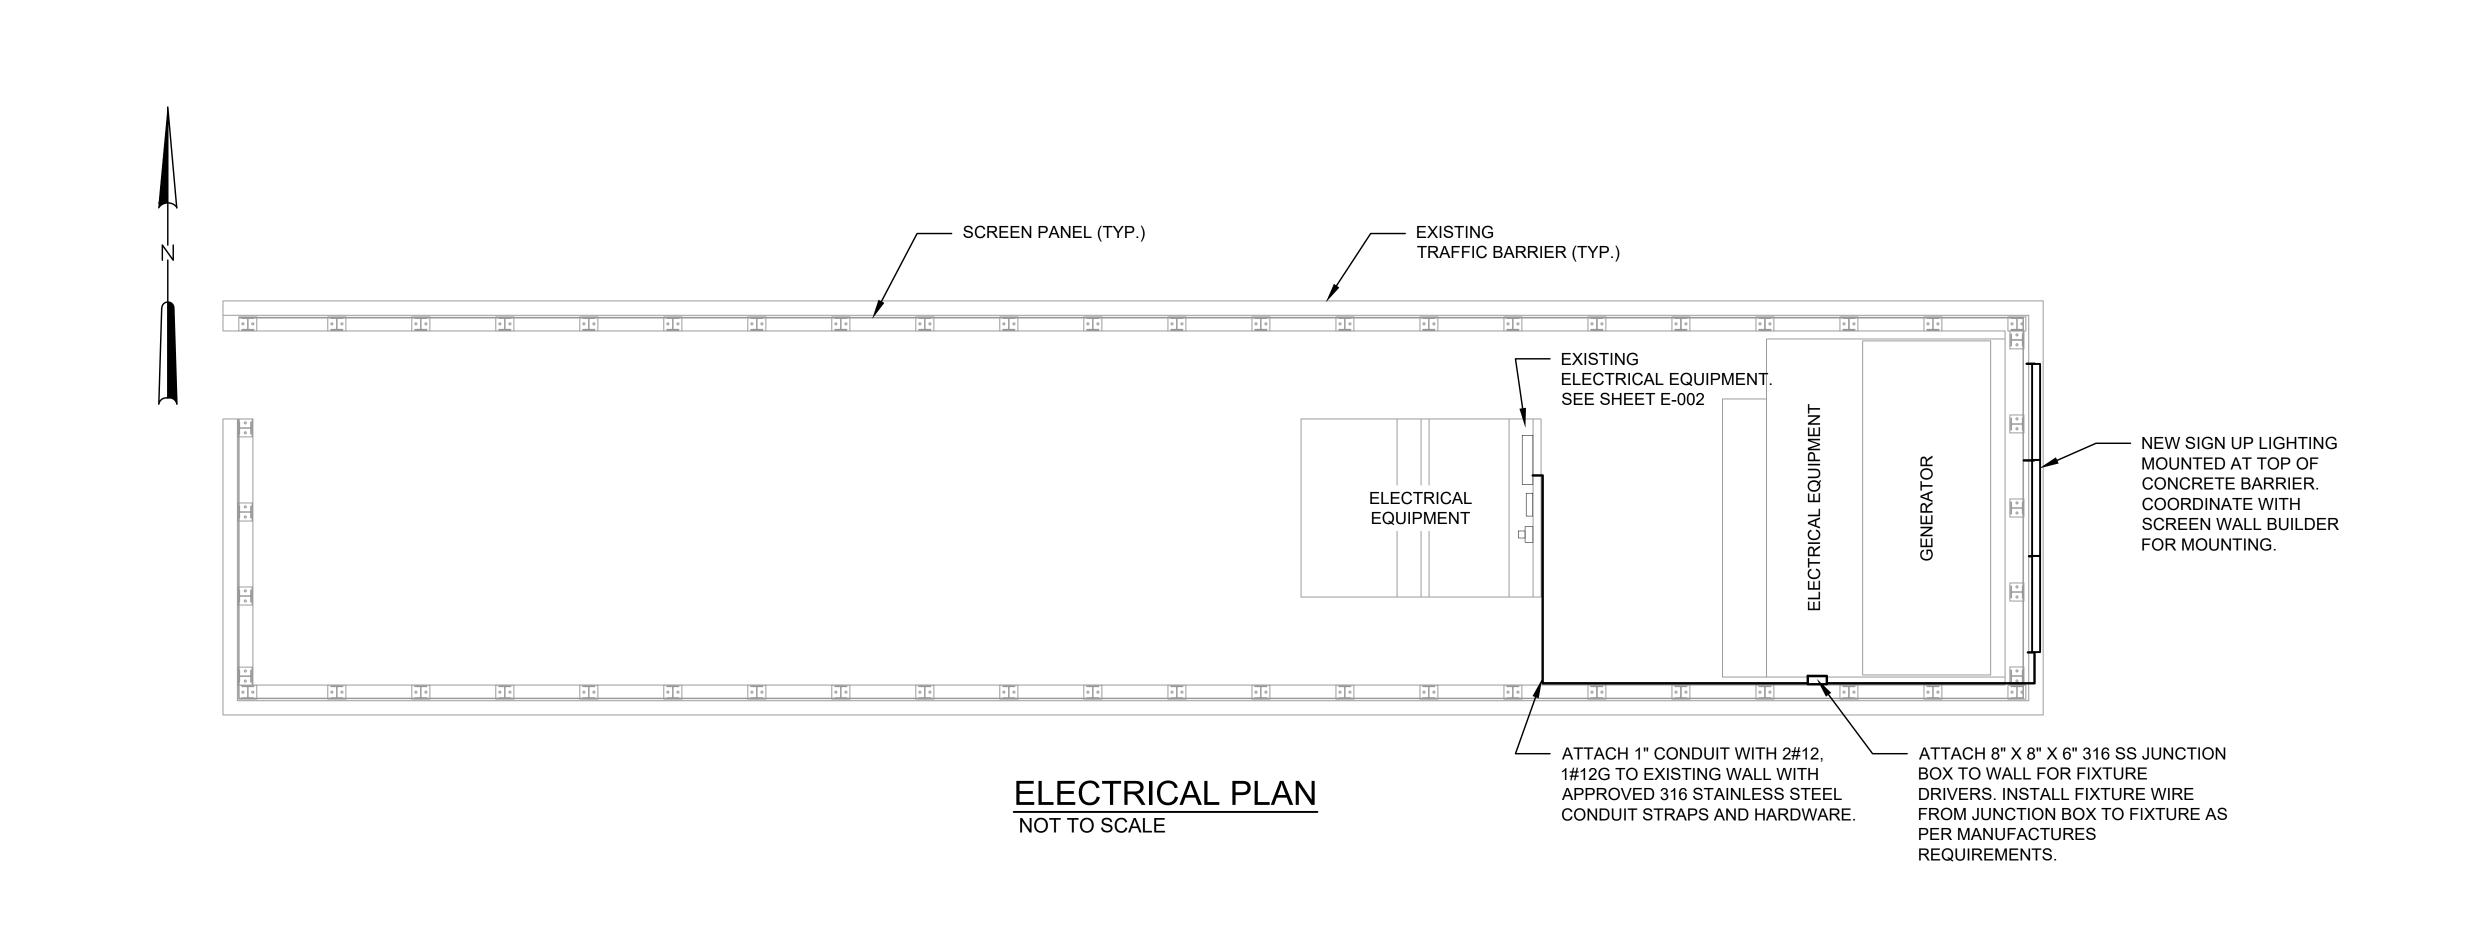

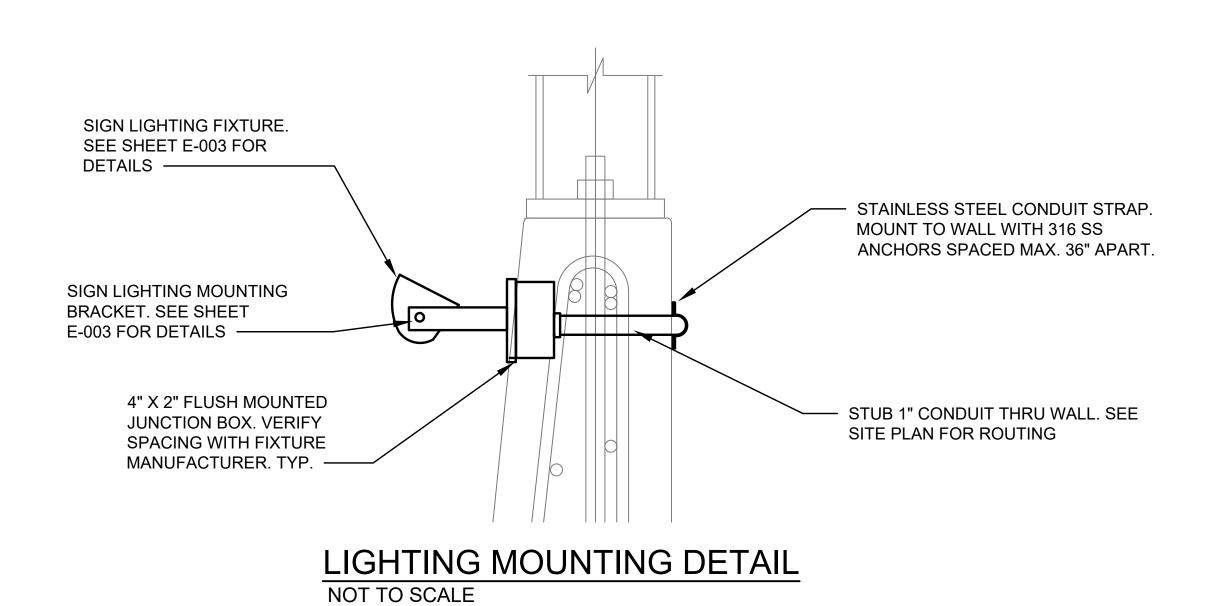



100% SUBMITTAL

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MIAMIBEACH	rĸ
OFFICE OF CAPITAL IMPROVEMENT PROJECTS 1701 MERIDIAN AVENUE, MIAMI BEACH, FL.33139	AD

ROJECT:	SCREEN WALL AT PS NO. 3	Stanley Consultant
ODRESS:	WEST AVE. AND 20TH ST.	1641 Worthington Road, Suite 400 West Palm Beach, Florida 33409 Florida Engineering Cert. No. 1978

	LARRY M. SMITH, P.E.	DI
	P.E. License No. 45997	C
	2161 Palm Beach Lakes Blvd., Suite 312	DI
VC.	West Palm Beach, Florida 33409	C
	www.smithengineeringconsultants.com Certificate of Authorization No. 8228	S


DRAWN BY:	SPH	
CHECKED BY:	LMS	
DESIGNED BY:	SPH	
CHECKED BY:	XX	
SCALE:	N.T.S.	

5				Drawing Title:	Г
4				ELECTRICAL PLAN	
3					
2					
1				Filename: S19042_E-1 PS3_PLA	N.DWG
NO.	DATE	REVISION	APP'D. BY	Date: 8/20/19 Sheet: 01 of	03

E-001

GENERAL ELECTRICAL NOTES AND SPECIFICATIONS:

- 1. THE SCOPE OF WORK SHALL CONSIST PRIMARILY OF THE FOLLOWING:
- A. PROVIDE AND INSTALL NEW SIGN LIGHTING COMPLETE.
- B. PROVIDE AND INSTALL CONDUIT AND WIRE COMPLETE.
- 2. THE CONTRACTOR SHALL PROVIDE ALL MATERIALS AND LABOR TO INSTALL THE ELECTRICAL SYSTEMS AS INDICATED ON THE DRAWINGS. ITEMS NOT SHOWN BUT OBVIOUSLY NECESSARY FOR COMPLETION OF THE WORK SHALL BE INCLUDED.
- 3. THE INSTALLATION SHALL BE IN ACCORDANCE WITH THE 2014 NATIONAL ELECTRICAL CODE, LATEST ADOPTED NATIONAL ELECTRICAL SAFETY CODE, LOCAL CODES, CITY CODES AND THE 2017 (6TH EDITION) FLORIDA BUILDING CODE.
- 4. THE CONTRACTOR SHALL OBTAIN ALL NECESSARY PERMITS, INSPECTIONS AND APPROVALS AND TO INCLUDE ALL FEES AS PART OF HIS BID IF NOT OTHERWISE NOTED.
- 5. THE CONTRACTOR SHALL COORDINATE HIS WORK WITH THE OWNER & ENGINEER.
- 6. THE CONTRACTOR SHALL, BEFORE SUBMITTING HIS BID, VISIT THE SITE OF THE PROJECT AND BECOME FAMILIAR WITH THE EXISTING CONDITIONS. NO ALLOWANCE WILL BE MADE FOR EXISTING CONDITIONS OR FAILURE OF THE CONTRACTOR TO OBSERVE THEM.
- 7. ALL EQUIPMENT AND MATERIAL SHALL BE UNUSED AND U.L. LISTED. ALL REFERENCES TO A PARTICULAR MANUFACTURER ARE GIVEN ON AN "APPROVED EQUAL" BASIS UNLESS OTHERWISE NOTED.
- 8. THE CONTRACTOR IS RESPONSIBLE TO TEST ALL SYSTEMS INSTALLED OR MODIFIED UNDER THIS PROJECT AND REPAIR OR REPLACE ALL DEFECTIVE WORK TO THE SATISFACTION OF THE ENGINEER AND OWNER.
- 9. ALL EQUIPMENT FURNISHED AND INSTALLED BY THE CONTRACTOR SHALL BE GUARANTEED AGAINST DEFECTS IN MATERIAL AND WORKMANSHIP FOR A PERIOD OF ONE YEAR FROM DATE OF ACCEPTANCE.
- 10. ALL CONDUCTORS SHALL BE COPPER. NO ALUMINUM ALLOWED UNLESS SPECIFICALLY INDICATED ON DRAWINGS.
- 11. THE DRAWINGS ARE NOT INTENDED TO SHOW THE EXACT LOCATION OF CONDUIT RUNS. THESE ARE TO BE COORDINATED WITH THE OTHER TRADES SO THAT CONFLICTS ARE AVOIDED PRIOR TO INSTALLATIONS.
- 12. ALL MOUNTING HARDWARE SHALL BE STAINLESS STEEL.
- 13. GROUNDING SHALL BE INSTALLED IN ACCORDANCE WITH NEC, ARTICLE 250. THE GROUNDING SYSTEM TEST SHALL NOT EXCEED A 48 HOUR SPAN DRY RESISTANCE OF 5 OHMS. ADDITIONAL GROUNDING TO MEET THIS REQUIREMENT SHALL BE INSTALLED AT NO EXTRA COST. GROUNDING AND BONDING CONNECTIONS SHALL NOT BE PAINTED. ALL GROUNDING CONNECTIONS SHALL BE EXOTHERMIC WELDED UNLESS SPECIFICALLY INDICATED OTHERWISE.
- 14. AN EQUIPMENT GROUND WIRE SIZED PER NEC SHALL BE PULLED IN ALL ELECTRICAL CONDUITS, POWER AND CONTROL, WHETHER OR NOT INDICATED ON THE PLANS.
- 15. PROVIDE CONDUIT DUCT SEAL AT ALL CONDUIT ENDS.
- 16. CONTRACTOR SHALL, WITHIN 30 DAYS AFTER THE DATE OF THE SYSTEM ACCEPTANCE, PROVIDE TO THE BUILDING OWNER RECORD DRAWINGS OF THE ACTUAL INSTALLATION INCLUDING A SINGLE LINE DIAGRAM OF THE ELECTRICAL DISTRIBUTION SYSTEM AND RELATED FLOOR PLANS INDICATING THE LOCATION AND AREA SERVED FOR THE DISTRIBUTION.
- 17. CONTRACTOR SHALL PROVIDE TO THE OWNER AN OPERATING AND MAINTENANCE MANUAL IN ACCORDANCE WITH THE REQUIREMENTS OF SECTION C405.6.4.2 OF THE 2017 FLORIDA BUILDING CODE - ENERGY CONSERVATION, INCLUDING ANY AMENDMENTS THERETO.
- 18. CONDUIT SHALL BE ALUMINUM CONDUIT.
- 19. POWER WIRING SHALL BE 600V THHN/THWN, COPPER.

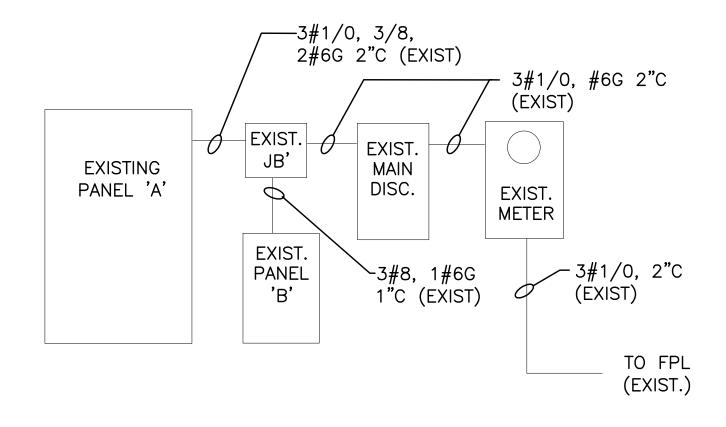


EXISTING ONE LINE DIAGRAM

120/240V, 1ø, 3 WIRE



EXISTING PANEL 'A' AND SERVICE POINT

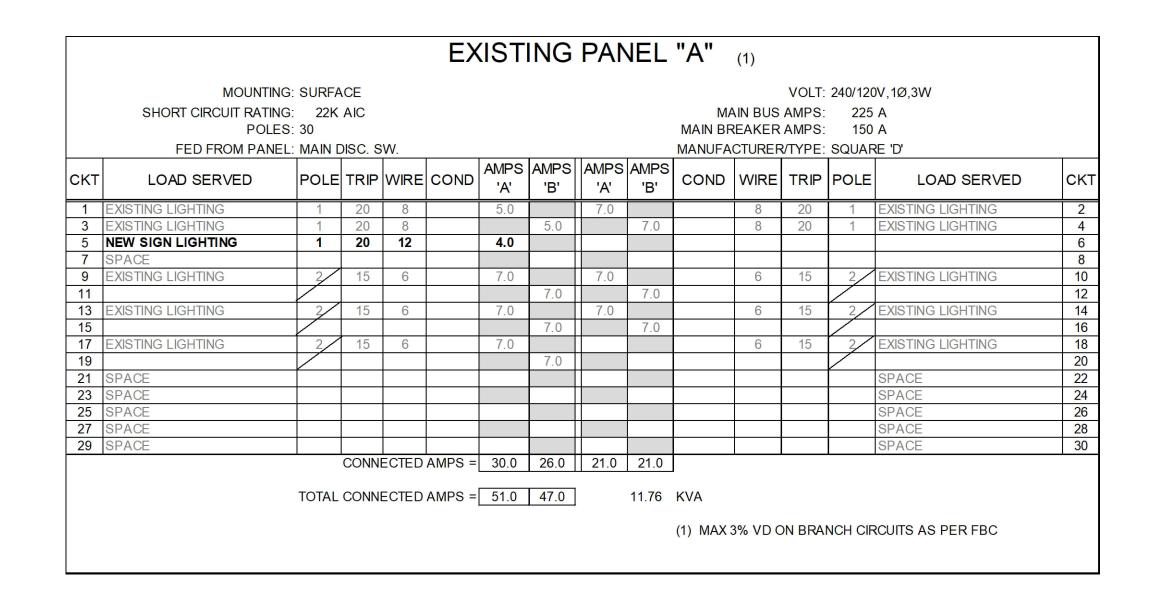

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PROJECT: SCREEN WALL AT PS NO. 3


Stanley Consultants INC 1641 Worthington Road, Suite 400 West Palm Beach, Florida 33409 Florida Engineering Cert. No. 1978


LARRY M. SMITH, P.E. P.E. License No. 45997 2161 Palm Beach Lakes Blvd., Suite 312 West Palm Beach, Florida 33409 www.smithengineeringconsultants.com


DRAWN BY: SPH CHECKED BY: LMS DESIGNED BY: SPH CHECKED BY: XX Certificate of Authorization No. 8228 | SCALE: _

Drawing Title: **ELECTRICAL DETAILS** 4 Filename: S19042_E-1 PS3_PLAN.DWG APP'D. BY Date: **8/20/19** Sheet: **02** of **03** NO. DATE REVISION

Drawing No.: E-002

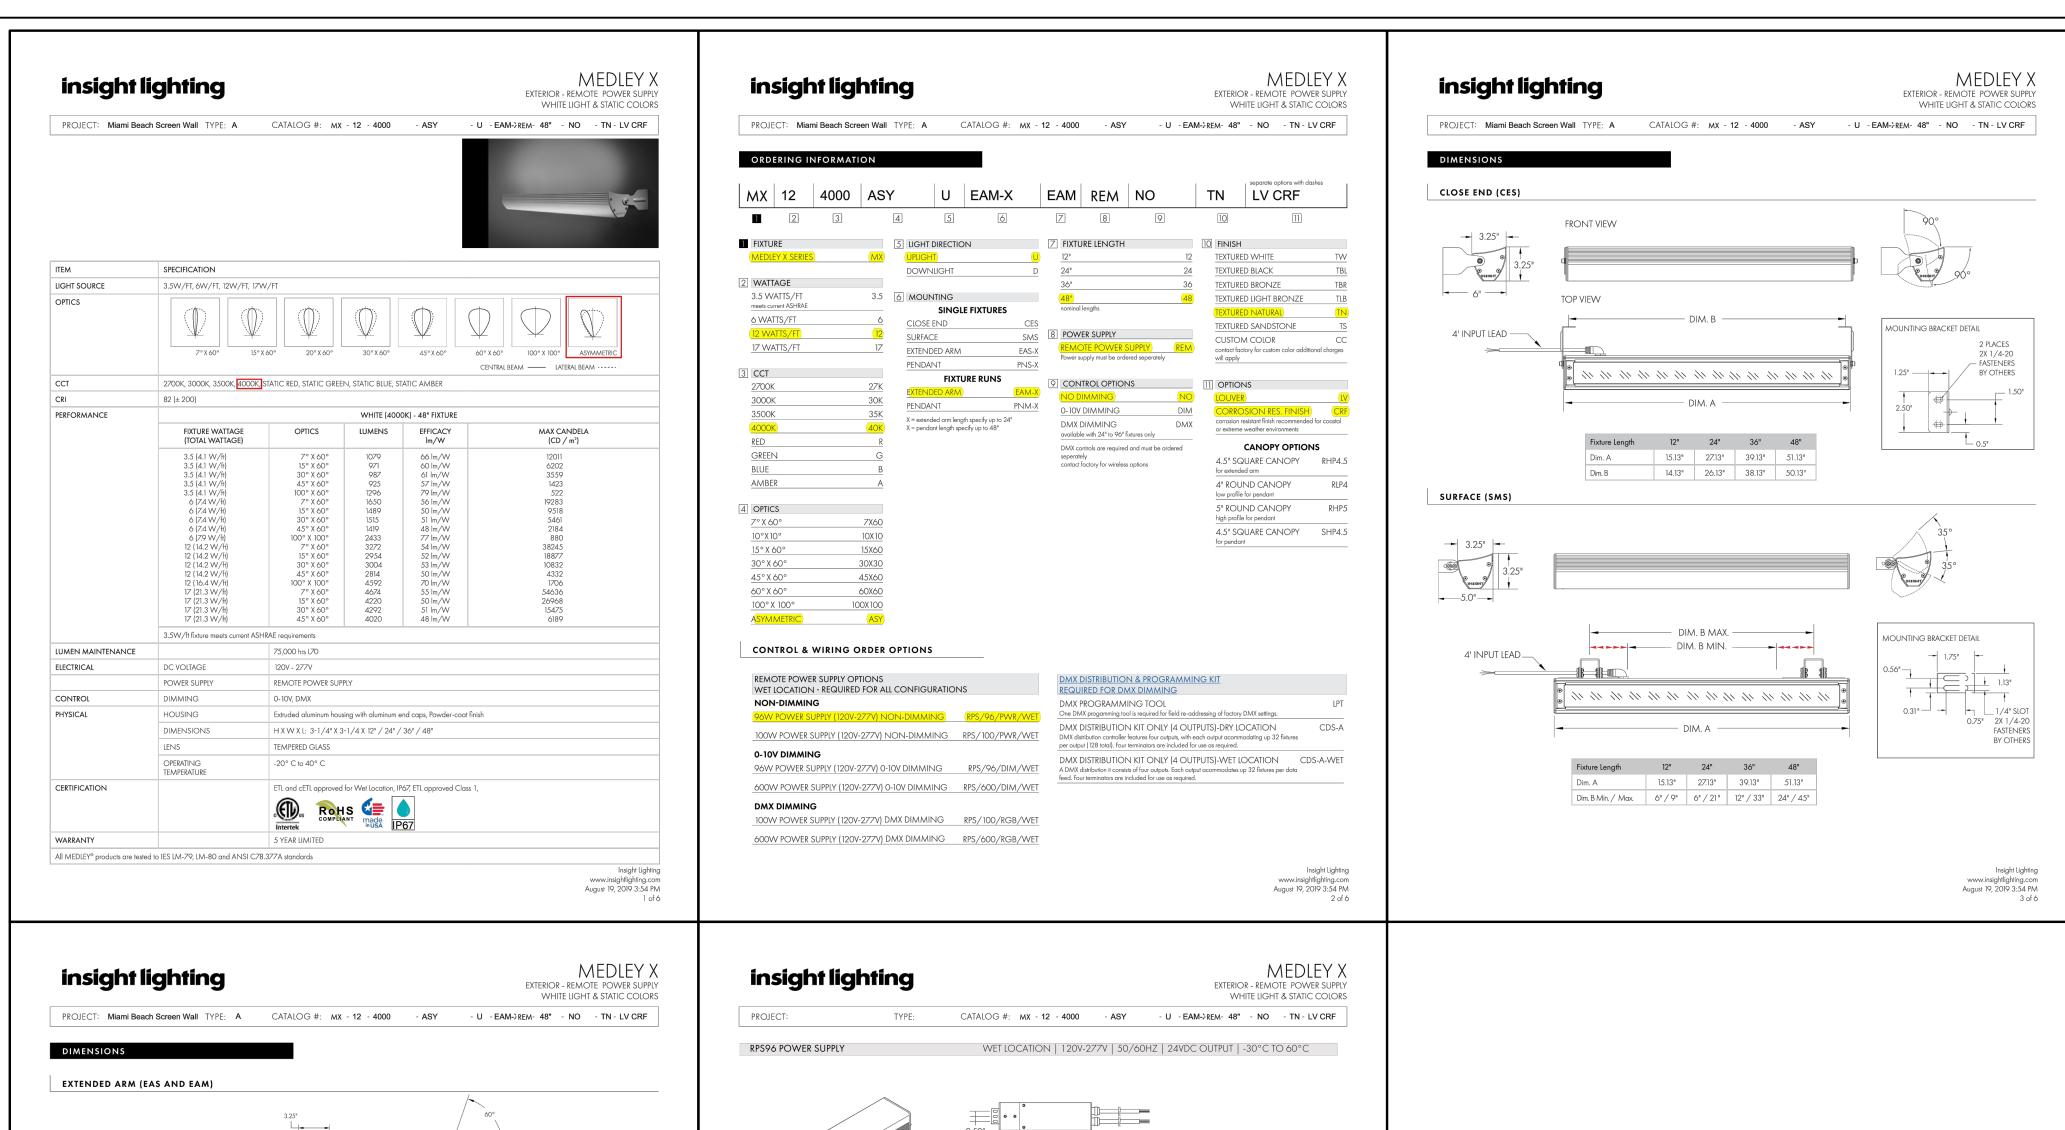

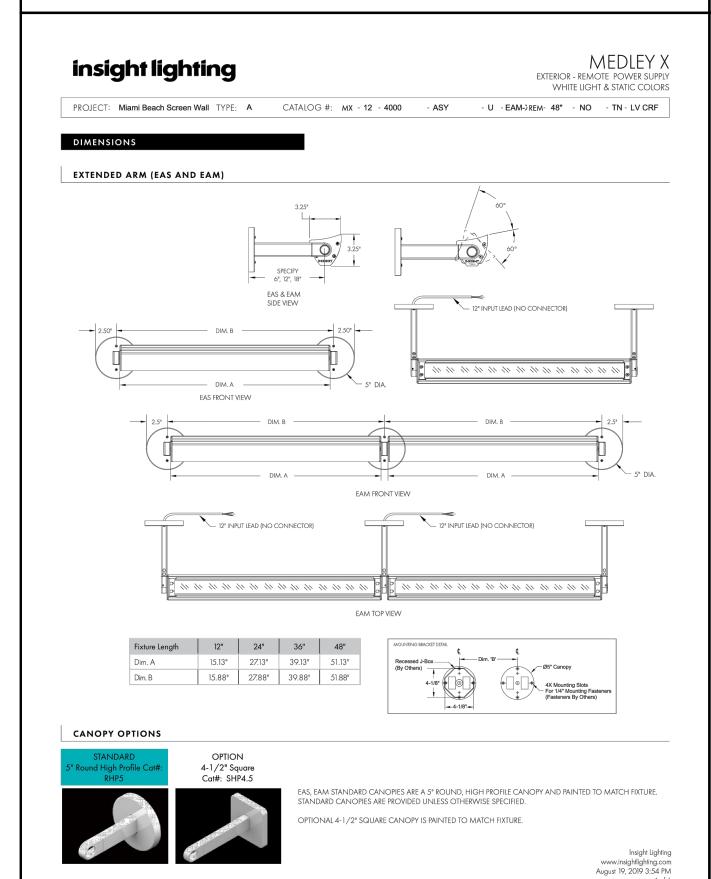

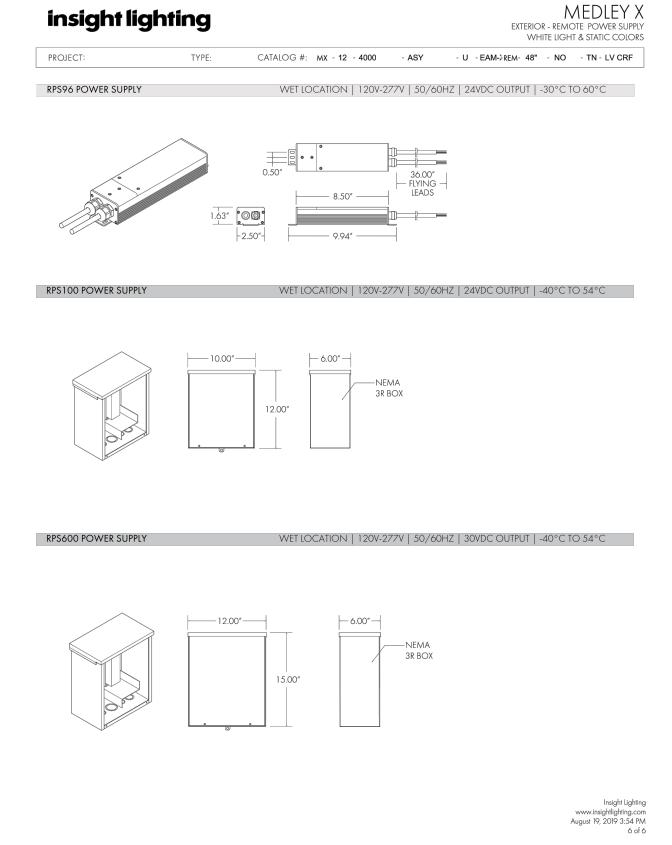

SIGN UP LIGHTING CUT SHEET

CATALOG NUMBER: MX-12-4000-ASY-U-EAM-X-REM-48"-NO-TN-LV CRF



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APP'D. BY Date: **8/20/19** Sheet: **03** of **03**

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PROJECT: SCREEN WALL AT PS NO. 3

WEST AVE. AND 20TH ST.

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	DRAWN BY:	SPH	
	CHECKED BY:	LMS	
	DESIGNED BY:	SPH	
	CHECKED BY:		
3	SCALE:	N.T.S.	

NO. DATE

SIGN LIGHTING CUT SHEET Filename: S19042_E-1 PS3_PLAN.DWG

REVISION

E-003

Contractor's Non-Prepriced Worksheet



te:	3/26/2020									
:	Job Order	077746	6.00							
	Title	Screen	Wall at	Sunset Harbour	Pump Station	n No. 3				
SE	ECTION	ITEM	UOM	DESCRIPTION	N					
10	00 00 00	00 001		Screen Pane	el(s) Bo-Mar I	nsdustrie	s- Greci	an Pa	ttern	
Ins	stall Price:	351,040.00	X	Install Quan	tity:	1.00		=	Install Total:	\$351,040.00
								X	Factor:	1.135
								=	Line Item Total:	\$398,465.50
For	r Work Perf	ormed wit	h the C	ontractor's (Own Force	s:				
	A				ect Labor Co ırrent Prevail		•		evel shed Fringe Benefits)	
	В. —			Dire	ect Material (Costs	(Suppo	orted b	y 3 Quotes)*	
	C. –			Dire	ect Equipmer	nt Costs	(For E	quipme	ent NOT in the CTC)	
	_			Tota (A+	al Cost for Self B+C) x Non-P	-perform N repriced W	NPP Wor Vork Task	k Task k Adjus	= tment Factor	
	aterial Cost	-	ubcontracto	ors. A Justification L	etter must be att	ached if 3 o	quotes are	not furi	nished.)	
	1.						\$			
	2.						\$			
	3.						\$			
Fo	or Work Pei	formed By	y Subc	ontractors:						
	G				bcontractor (s Should	he the	Price Entered into PRO	GEN)
	Н	1.	1351		ntractor's No					0214)
	I.						_		ned by Subcontractors	s = G x H
**S	- ubcontract	or Cost Qı	uotes				J		•	
(Attac	ch quotes from lis	sted suppliers/su	bcontracto	ors. A Justification Le	etter must be att	ached if 3 c	quotes are	not furr	nished.)	
	1. Bo	-Mar Industrie	es, Inc.			<u>\$</u>	351,04	10.00		
	2. All	Dade Fences	s, Inc.			<u> </u>	374,00	00.00		
	3. Kre	ativ Concept	S			\$	No bio	d/No re	esponse	

Non-Prepriced Worksheet Page 1 of 45

bo-mar Industries, Inc.

3838 S Arlington Ave Indianapolis, IN 46203

317-899-1240 Phone: Fax: 317-899-1241 Fed ID: 35-1843148

Quote No: 23204 Wednesday, March 18, 2020

Page:

Attention: **Guy Lesseur**

Harbour Construction, Inc

7340 SW 48th Street. Suite #102 Miami, FL 33155

Phone: 305.603.9944

Guy

Line: 1

Screen Wall At PS No. 3 Miami Beach Fl.

Part ID: STAINLESS STEEL SCREEN WALL

Unit Price

Quantity U/M

Discount

Rev:

Addl Charge

Lead Time

Total Price

Stainless Steel Generator Enclosure.

Custom 1/4" perforated 316 stainless steel panels (custom pattern based on Grecian pattern provided by customer) with galvanized and powder coated steel I-Beam Structure. All stainless steel button head hardware with stainless hex nuts on back side. Custom Paint with wave pattern wrapping outside. Designed to fit existing concrete wall structure. Locating templates will be provided for new cat in place anchors. Front side to be mill finish stainless steel upper with powder coated wave on top of lower colored section. Wave material to be 14 ga material with powder coat finish. Wave to be second layer on top of perforated panels. Wave also includes signage letters in same gauge bolt on design. Back side of panel to be mill finish. (Paint/ powder coat would not be cost effective)

Panels would be 1/4" 316 Stainless Steel with custom finish. I-Beams would be steel W6 x 20 I-beams, galvanized with powder coat finish.

Bomar would want to cut one panel to test stability/ flatness of material after cutting.

Quote based on 1.5 hours per full size sheet waterjet cut time. Final perforated pattern density may affect cut time and price. Full panel yield 1 to 3 panels in overall layout.

I-beams will mount to traffic barrier. Locating templates will be provided to concrete contractor to locate and set cast in place anchors for mounting I-beams. Bomar will drill existing anchors 1'- 4" and use 3/4" stainless steel expoxy set anchors in existing traffic barrier.

Quote has a separate line for PE to approve and sign off on drawings. Discounted

			Unit Price	
	1.00 EA	287,890.00	\$	287,890.00
Line:	-	Part ID: SHIPPING ESTIMATE Two Direct Soft Sided Trucks Estimate only.	Rev:	

Quantity U/M Unit Price Discount Discounted Addl Charge Lead Time Total Price Unit Price

1.00 EA 15,000.00 \$15,000.00

bo-mar Industries, Inc.

3838 S Arlington Ave Indianapolis, IN 46203

Phone: 317-899-1240 Fax: 317-899-1241 Fed ID: 35-1843148

Quote No: 23204 Wednesday, March 18, 2020

Page: 2

Line:	4	Part ID: SAMF	PLE PANEL.			Rev:			
		Cut Sample for Material Stability							
		•		n cut perf pattern. Panel will be					
		a usable panel	l if pattern ar						
		Sample panel	cost can be c	redited back to pr	oject if panel is usable ir	n final insta	Illation.		
	Quantity U/M	Unit Price	Discount	Discounted Unit Price			Addl Charge	Lead Time	Total Price
	1.00 EA	6,175.00							\$6,175.00
Line:	5	Part ID: FLOR	IDA SALES T	AX ESTIMATE		Rev:			
		7% if applicab	le to project						
	Quantity U/M	Unit Price	Discount	Discounted Unit Price			Addl Charge	Lead Time	Total Price
	1.00 EA	8,500.00							\$8,500.00
Line:	6	Part ID: PE SE	RVICES			Rev:			
		Registered Pro	ofessional Eng	gineer					
	Quantity U/M	Unit Price	Discount	Discounted Unit Price			Addl Charge	Lead Time	Total Price
	1.00 EA	3,500.00							\$3,500.00
Line:	7	Part ID: INST.	ALLATION			Rev:			
		Bomar Crew							
		Anchor Suppor	rt Beams & A	ttach Panels on to	p of traffic barrier wall.				
	Quantity U/M	Unit Price	Discount	Discounted Unit Price			Addl Charge	Lead Time	Total Price
	1.00 EA	29,975.00							\$29,975.00

Salesperson:

Prices are Valid Until Sunday, April 19, 2020

Quote based on all discussions with Stanley Consultants, City of Miami Beech Florida and Bomar Industries. Prints, material, and budget changes have been accounted for in quoted line items. Any additional changes will have additional cost incurred by customer.

Exclusions:

Permits, any bond cost, traffic control, barricades, premium/ overtime hours.

Any cost involved with change in design per code due to wind load, corrosion, or other.

Approximate lead time would be 12-14 weeks.

bo-mar Industries, Inc.

3838 S Arlington Ave Indianapolis, IN 46203

Phone: 317-899-1240 Fax: 317-899-1241 Fed ID: 35-1843148

Quote No: 23204

Wednesday, March 18, 2020

Page: 3

Quote offered by: Ronson Lepper

Please refer to this quote number when ordering.

SPECIAL NOTE

Due to instability in metals markets, all prices quoted are based on today's cost of material. Bo-mar Industries reserves the right to adjust our selling price to price in effect at the time order is placed. All quotes are subject to material availability at the time order is placed.

Payment terms are to be COD until Bomar account is established and approved.

Above pricing does not include shipping or applicable sales taxes unless stated otherwise.

All Dade Fences, Inc. 2720 West 78th Street Hialeah, FL 33016

Phone # 305-826-2535 Fax # 305-512-4360

iortega@alldadefences.com Lic: 98BS00285

Date	Estimate NO.
3/16/2020	11273

Name / Address				
Harbour Construction 7340 SW 48 Street, Unit 102 Miami, FL 33155	REP:	Re	Revised	
	Ю			
Description Project: Screen Wall At Pump Station No3	Qty	Cost	Total	
Furnished and install hot deep galvanized steel I-Beams W6 x 20 with welded plates All rod anchor and bolts stainless steel 316. Removable 1/4" Stainless steel screen Grecian pattern customer perforated grille, stainless steel type 316 brush finish. Bottom section of screen with custom paint (gcrest) Removable 1/8" Stainless steel wave shape and signage letters, black paint. Shop Drawing will be provide for approval. Lead time after receipt approval shop drawing 10 week to receive screen materials. Note: Permit are not included.		374,000.00	374,000.00	
Thank you for your business.		¢ > =	4 000 00	
"OUR PRIORITY IS YOUR SECURITY"		\$3/	4,000.00	

Wendy Jaramillo

From: Guy Lesseur <gl@harbourconstruction.com>

Sent: Monday, March 30, 2020 6:31 AM

To: Wendy Jaramillo

Subject: FW: Guy L.-Harbour - PS 3 screens - Construction

Attachments: 2020-02-14 - PS No 3 Screen - 100% Architectural Drawings - Rev 1 - SS.pdf; 2020-02-18 - PS No 3

Screen - 100% Structural Drawings - Rev 1 - SS.pdf; 2020-02-18-PS No 3 Screen - 100% Electrical

Drawings -SS.pdf

3rd NPP request. Non responsive

From: Guy Lesseur

Sent: Monday, March 2, 2020 3:31 PM

To: Jonathan Martell <jmartell3008@gmail.com>

Subject: FW: Guy L.-Harbour - PS 3 screens - Construction

Please provide pricing for the Screen Material and installation for the attached