
PRIVATE RESIDENCE


CITY OF MIAMI BEACH - FINAL SUBMITTAL LANDSCAPE ARCHITECTURE DRAWINGS JANUARY 06, 2020



DRAWING INDEX			
SHEET #	SHEET NAME		
GI-100	COVER PAGE & DRAWING INDEX		
LP-100	CANOPY PLANTING PLAN		
LP-200	UNDERSTORY PLANTING PLAN		
LP-300	ELEVATIONS		
LP-301	ELEVATIONS		
LP-400	PLANTING SCHEDULE, DETAILS & GENERAL NOTES		
LR-100	TREE DISPOSITION PLAN, SCHEDULE & DETAIL		
SURVEY	SITE SURVEY (BY OTHERS)		



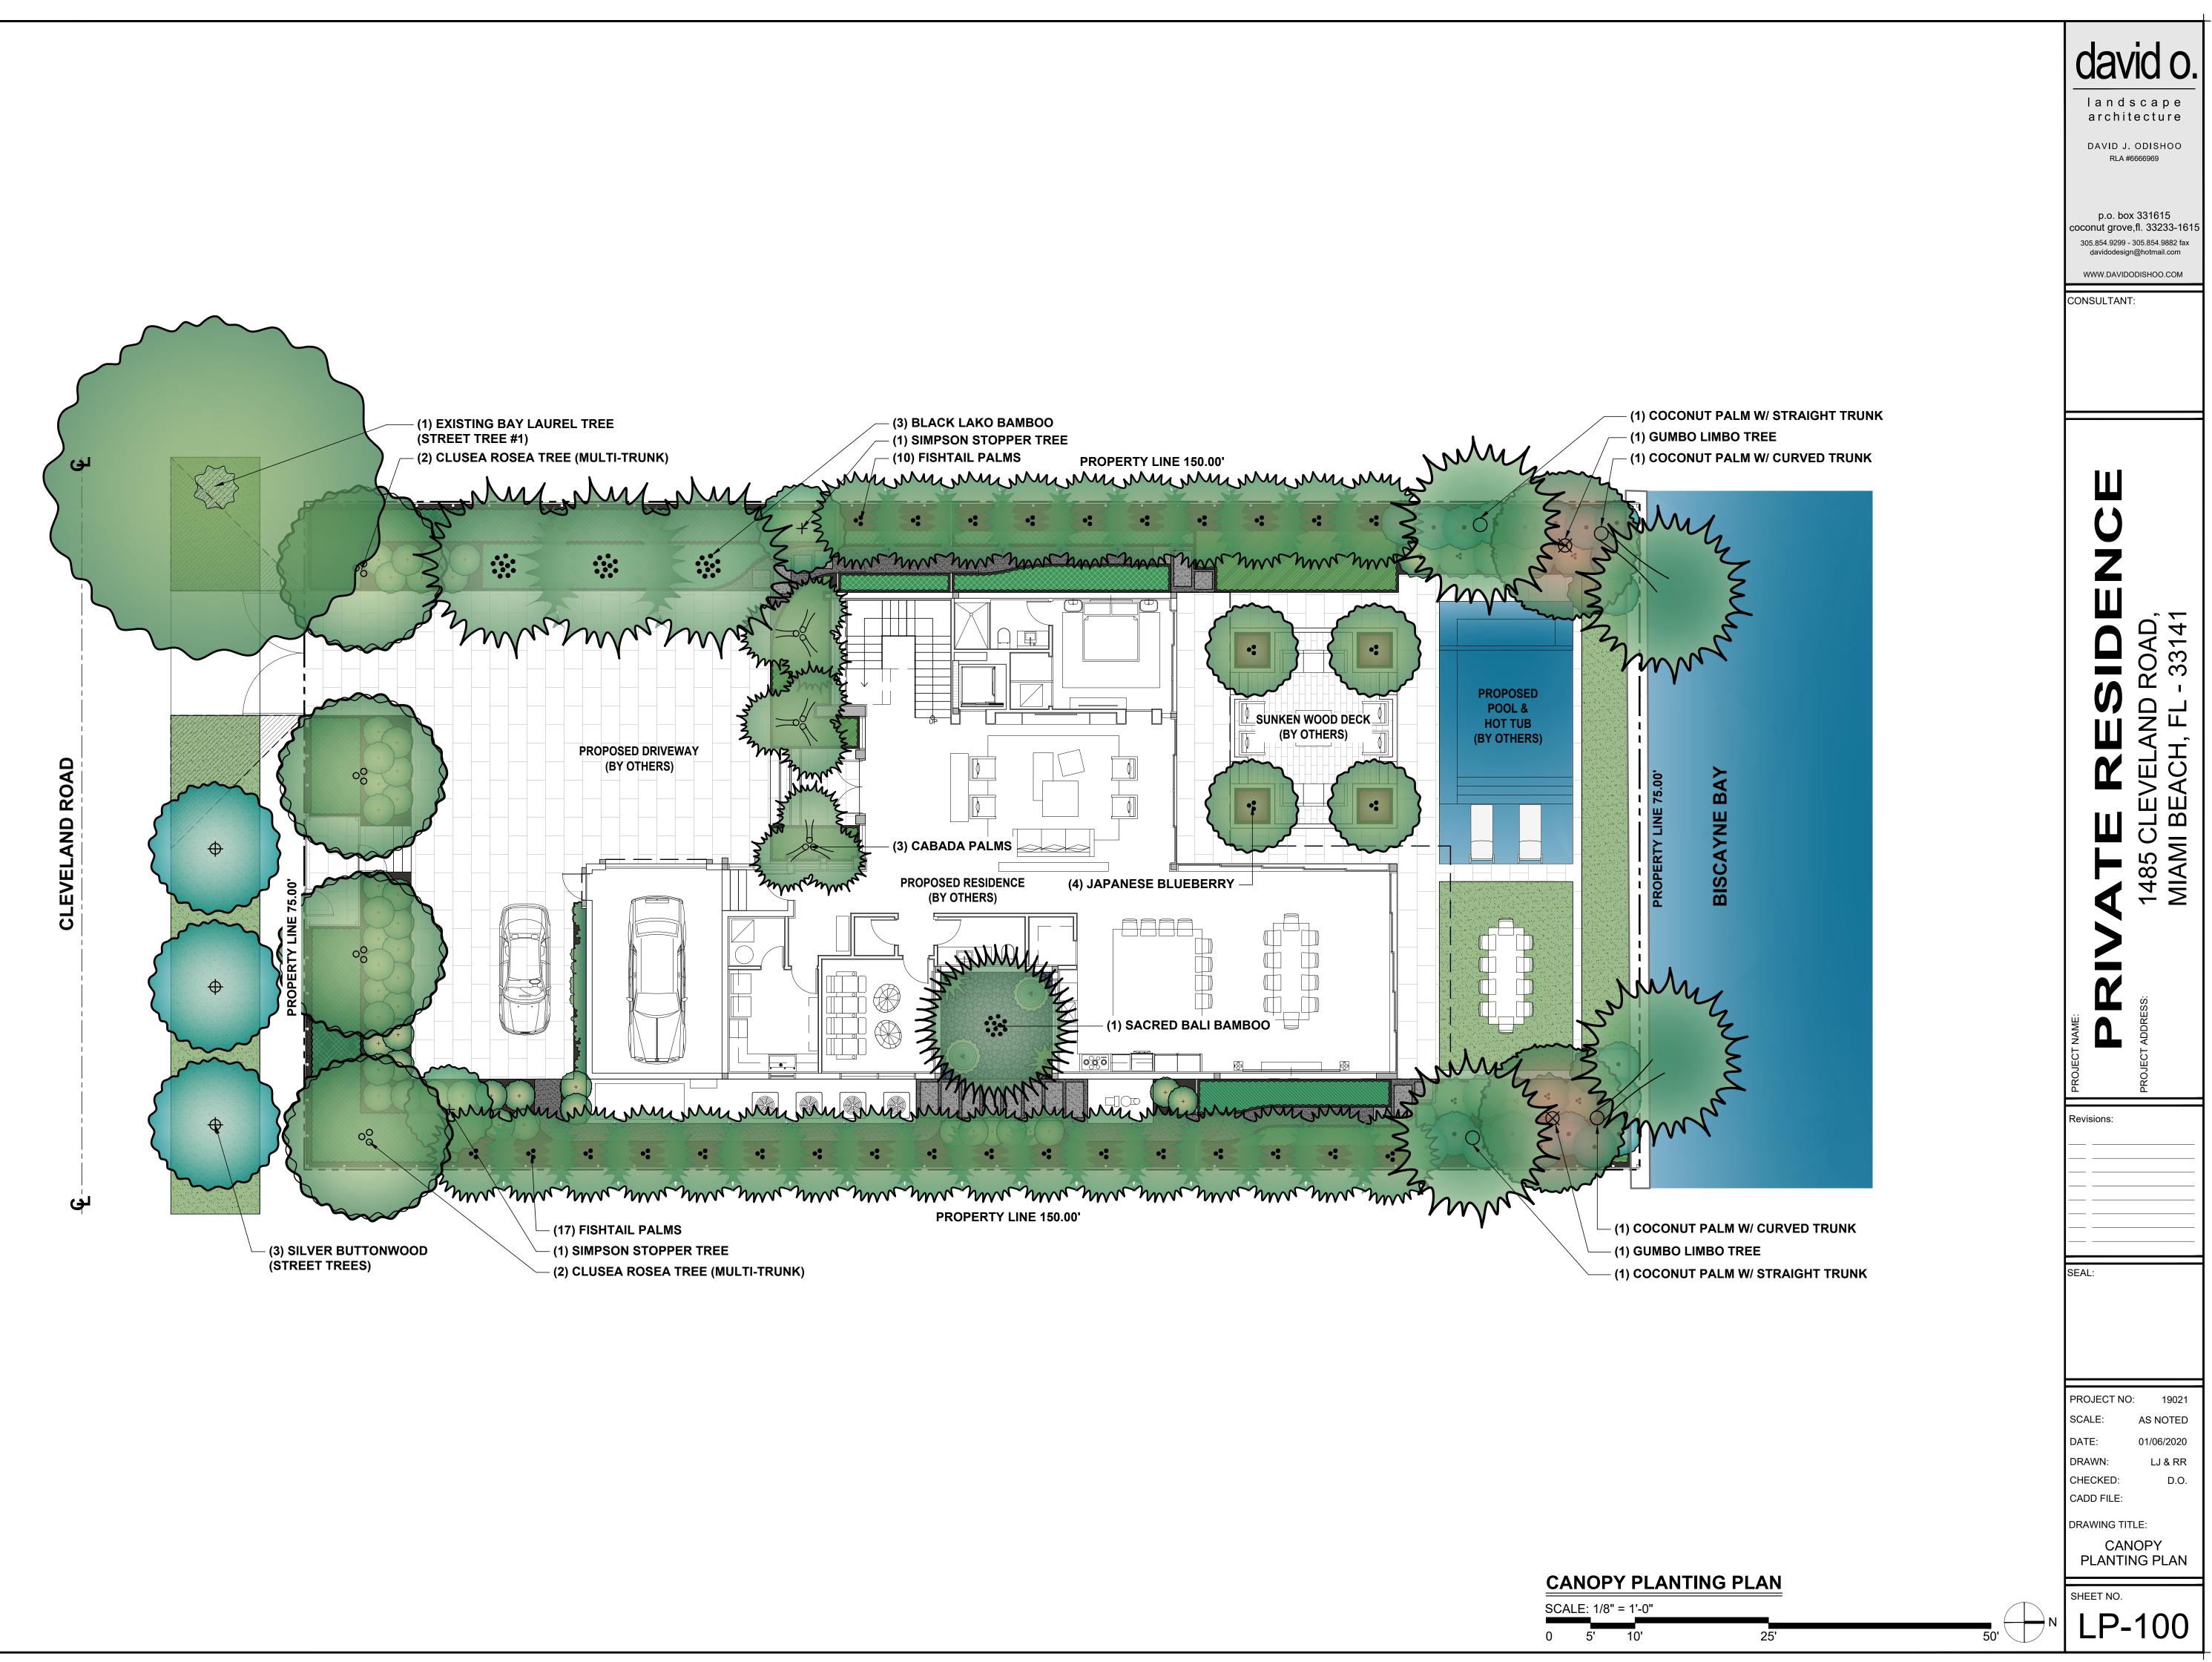

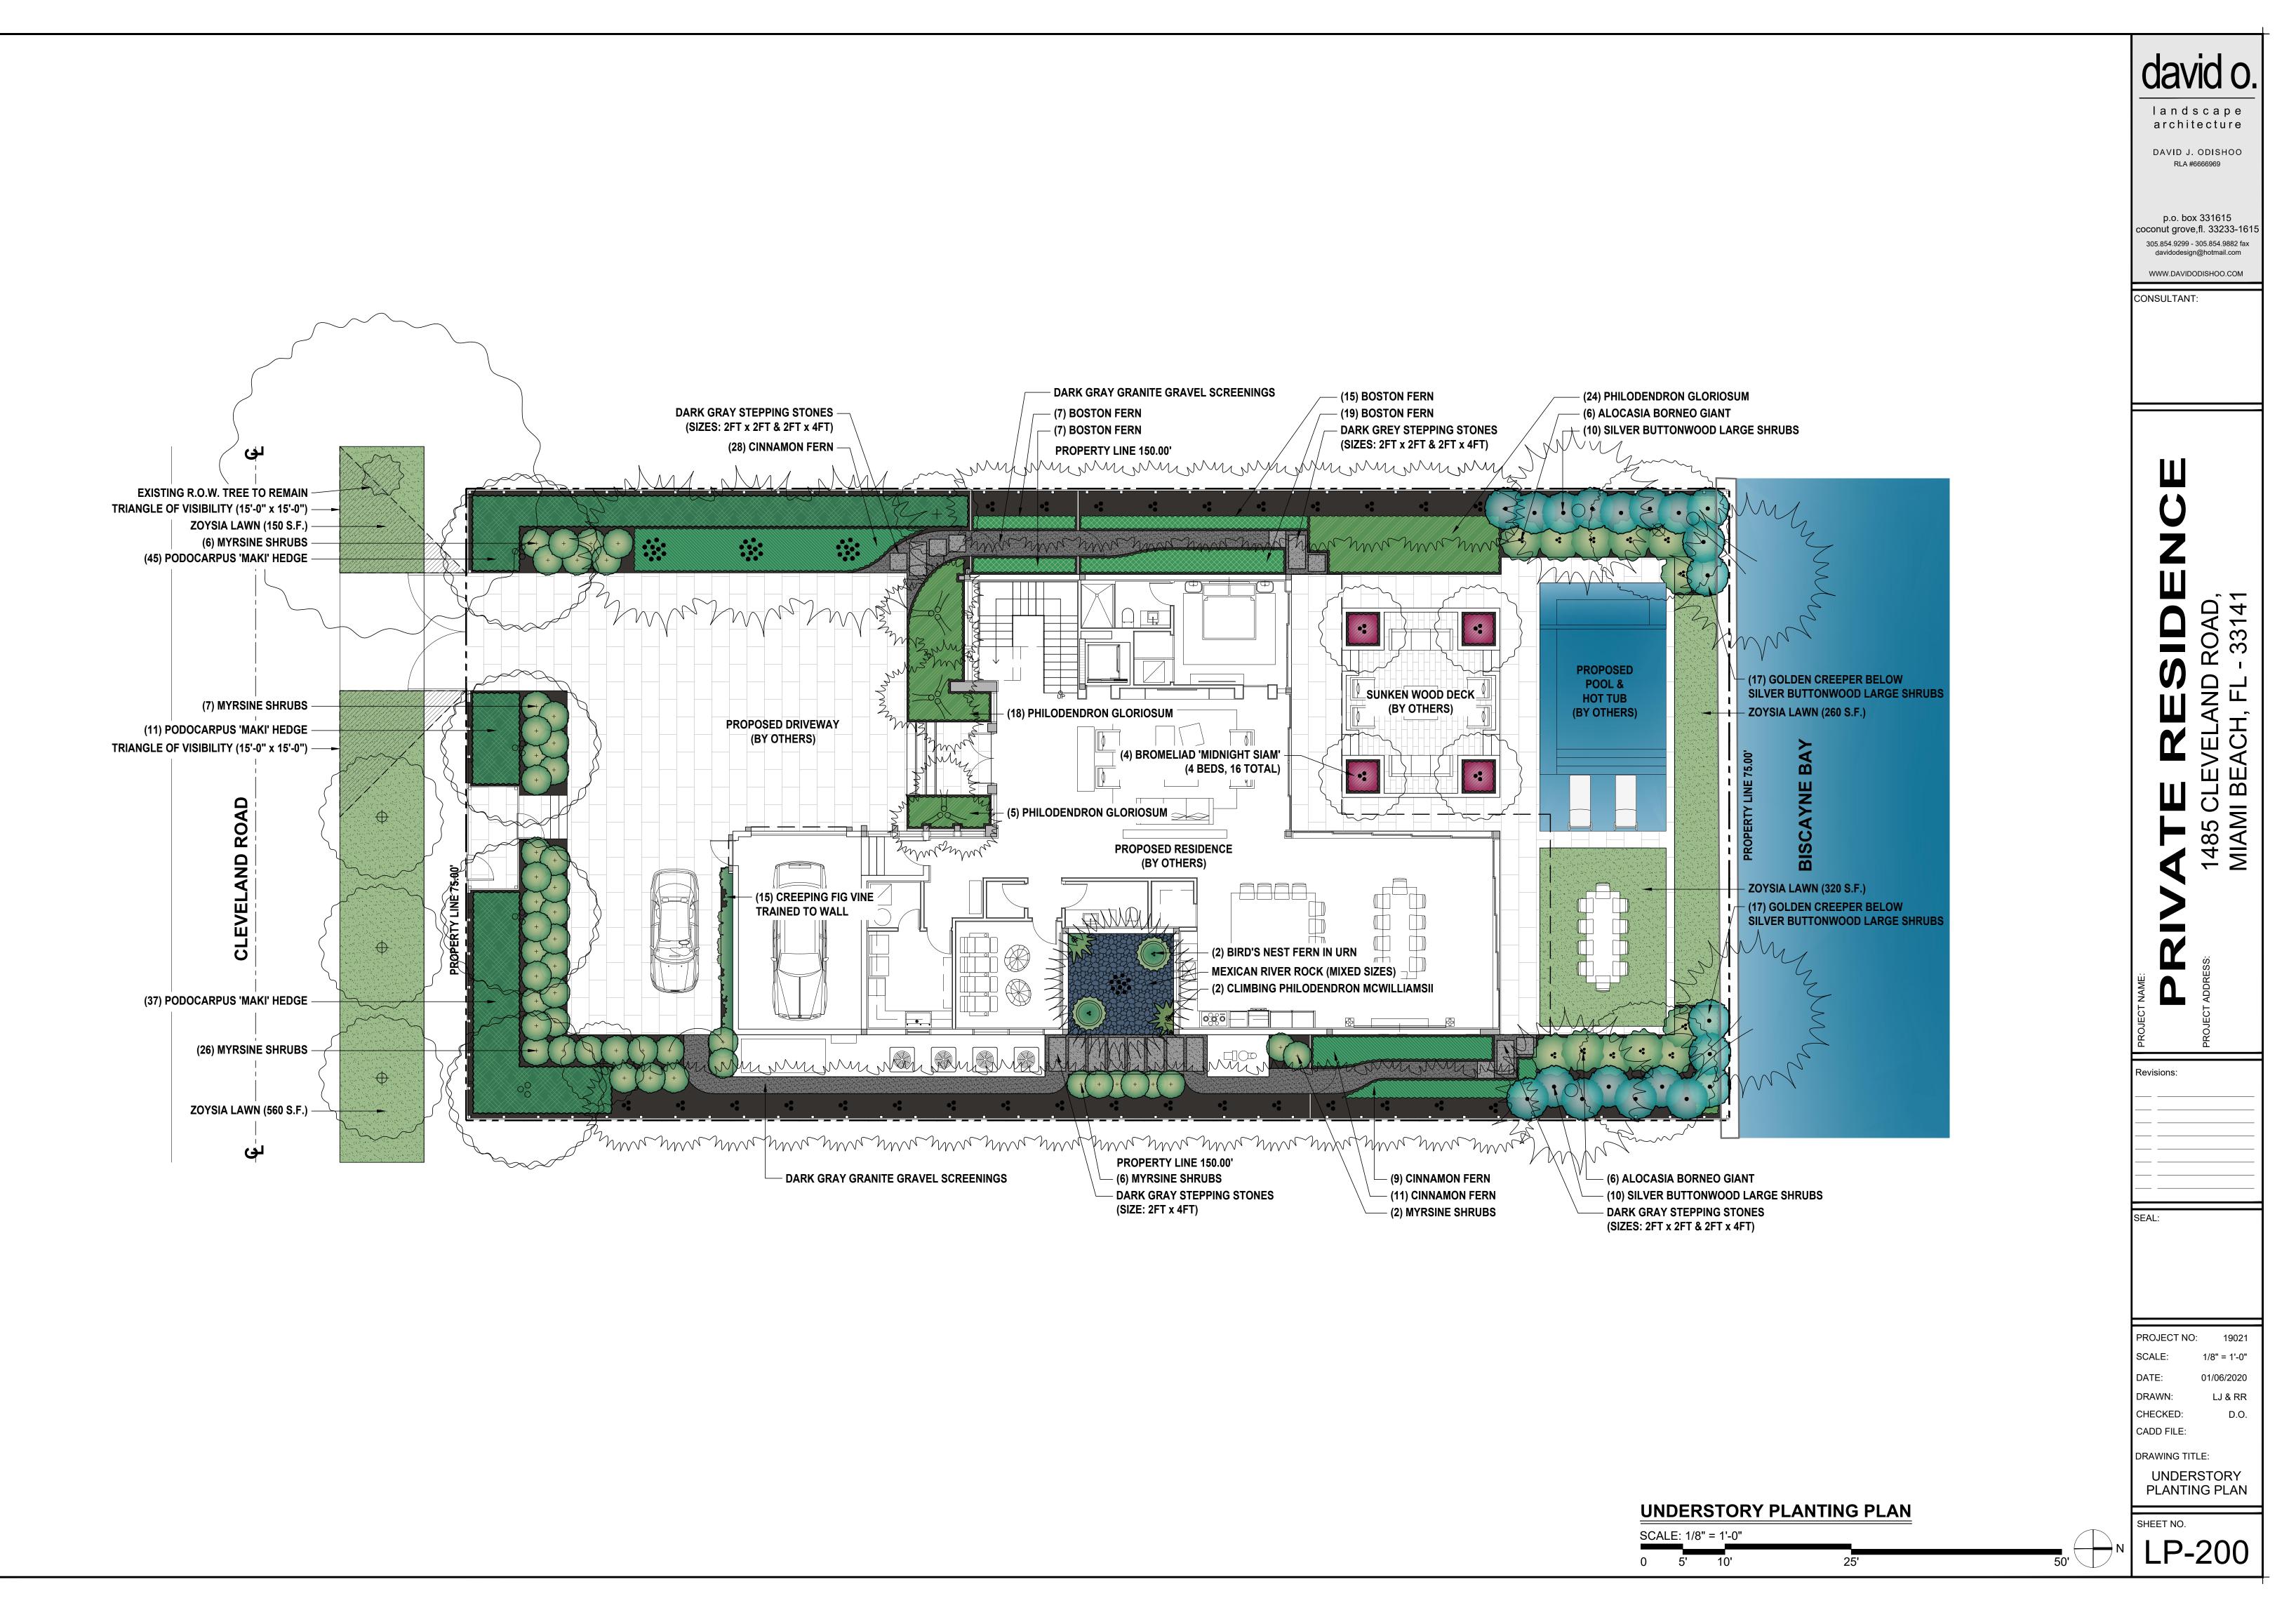



Scale: 3/16" = 1'-0"





— COCONUT PALMS — SILVER BUTTONWOOD (LARGE SHRUBS) JAPANESE BLUEBERRY (SCULPTURAL TREES)



—PODOCARPUS MAKI —EXISTING BAY LAUREL TREE (TREE #1) —PODOCARPUS MAKI —CABADA PALMS —PHILODENDRON GLORIOSUM


SOUTH ELEVATION Scale: 3/16" = 1'-0"

2

COCONUT PALMS SILVER BUTTONWOOD (LARGE SHRUBS)


SILVER BUTTONWOOD—— (STREET TREES)

	 ;; ;; ;; ;; ;; ;; ;; ;; ;; ;; ;; ;; ;;	and archi DAVID RLA p.o. b nut grov 5.854.9299 davidodes	9 - 305.854. ign@hotma DODISHOC	p e J r e HOO 15 33-1615 9882 fax il.com
		PRIVATE RESIDENCE	PROJECT ADDRESS: 1485 CLEVELAND ROAD,	MIAMI BEACH, FL - 33141
- - - -	Revi:	sions:		
S	EAL	.:		
	SCA DAT DRA CHE CAD	E: WN: CKED: D FILE: WING T	AS N 01/06 LJ	19021 OTED 5/2020 & RR D.O.
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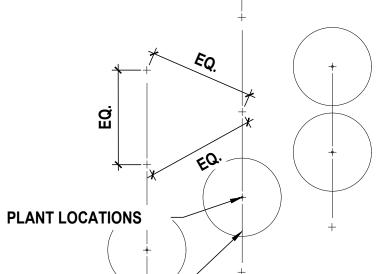


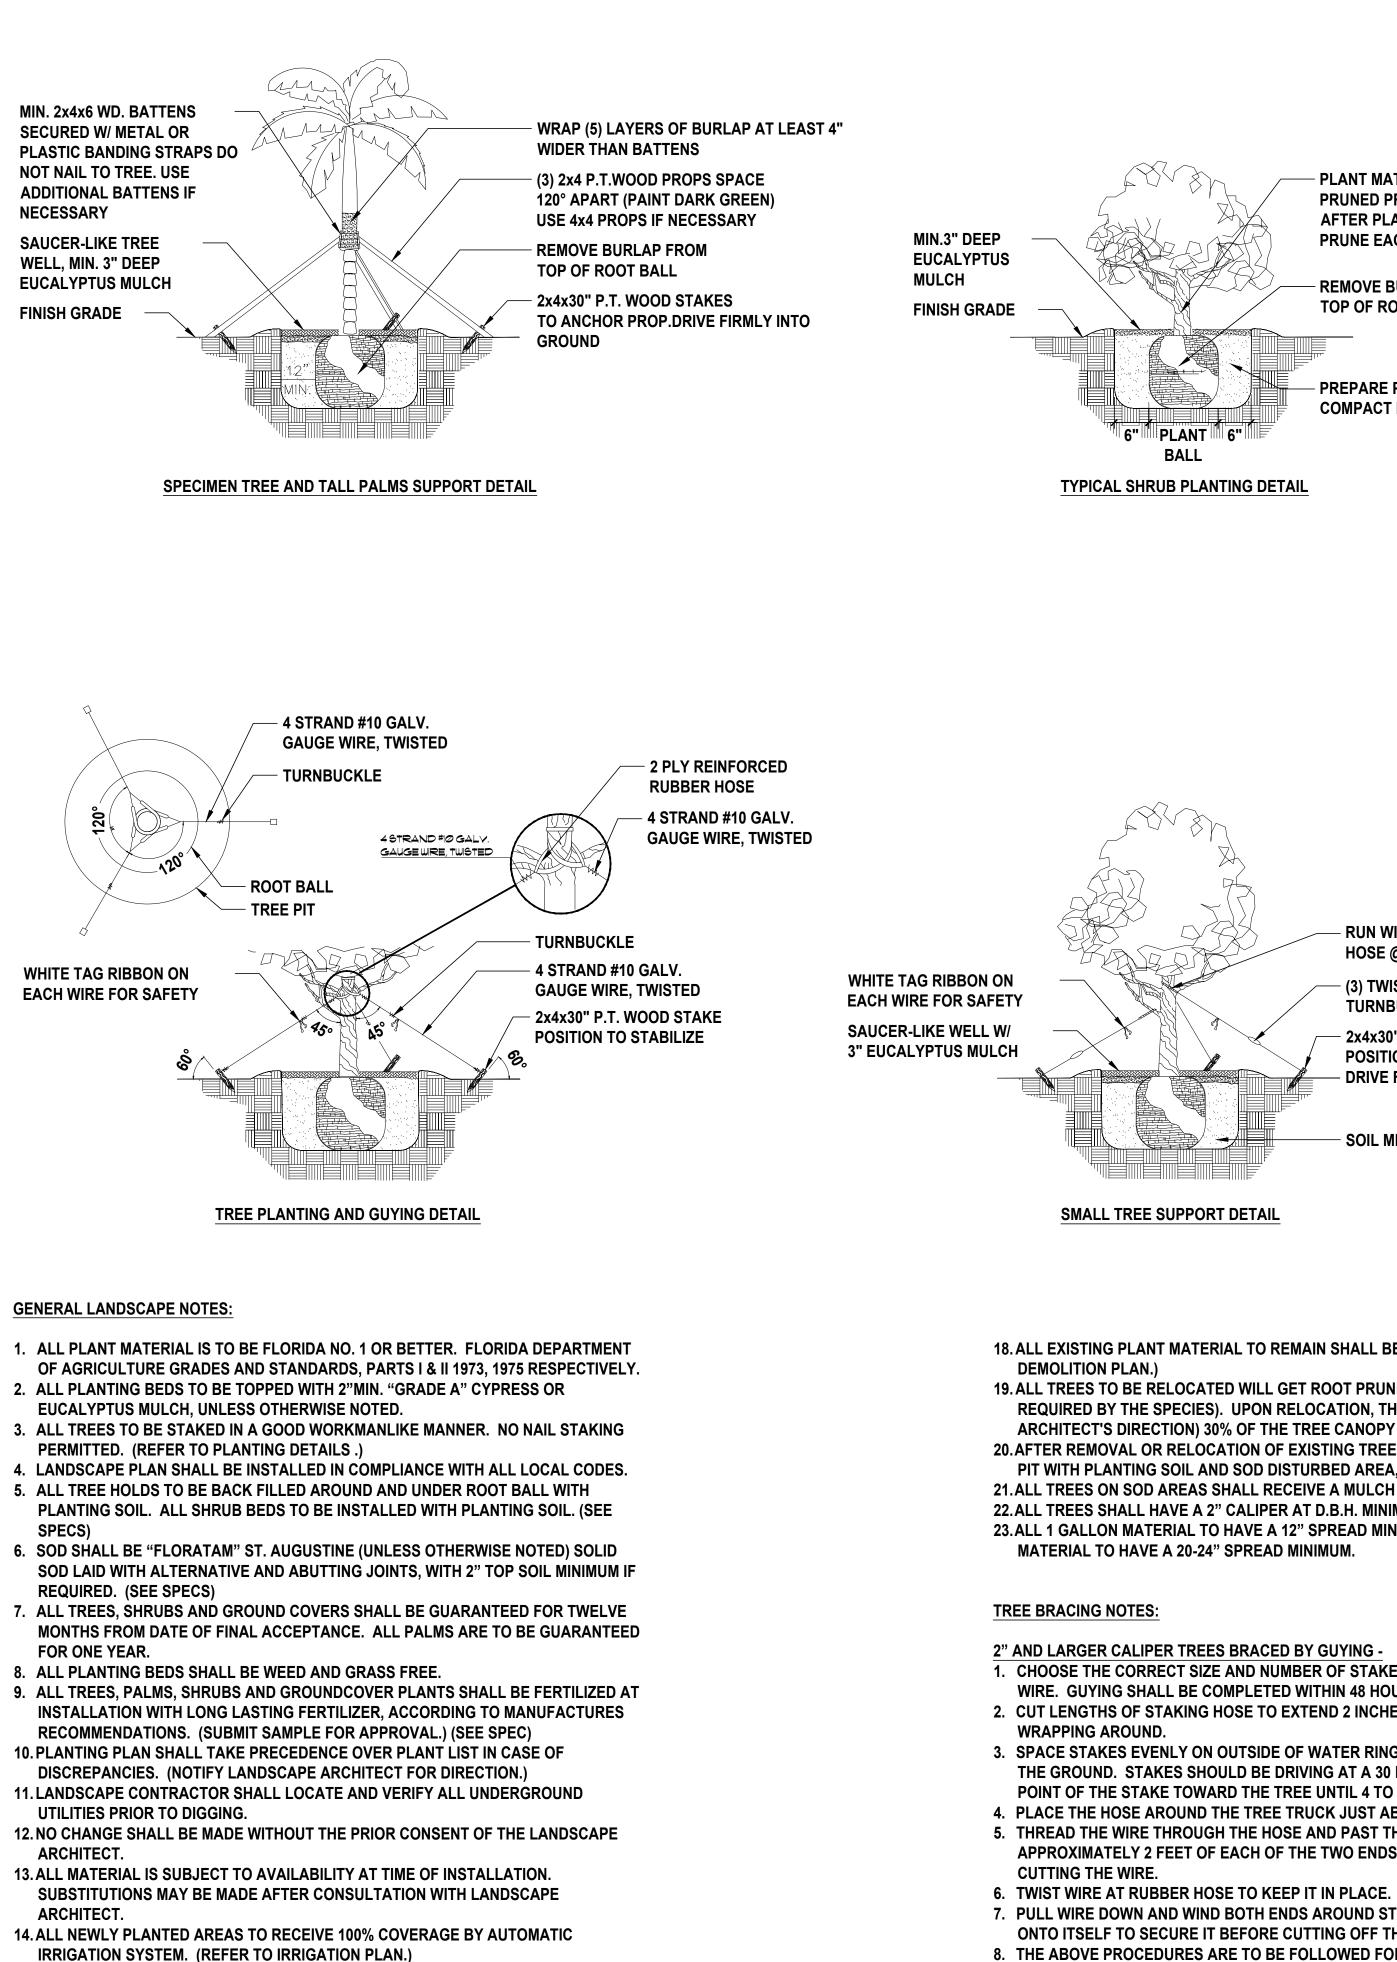- 15. ALL PLANTING BEDS TO RECEIVE NEW PLANTING SOIL (1/3 EVERGLADES PEAT, 1/3 SAND, 1/3 CYPRESS SAWDUST & CHOPS) MINIMUM 6" DEEP. (REFER TO PLANTING DETAILS.)
- 16. CONTRACTOR WILL VISIT SITE TO FAMILIARIZED HIMSELF WITH THE SCOPE OF WORK PRIOR TO SUBMITTING A BID.
- 17. LANDSCAPE CONTRACTOR TO COORDINATE HIS WORK WITH THE GENERAL CONTRACTOR, THE IRRIGATION CONTRACTOR, AND THE ELECTRICAL CONTRACTOR.

NOTE IN MOST CASES TRIANGULAR SPACING IS PREFERRED, USE SQUARE SPACING ONLY IN SMALL **RECTILINEAR AREAS.**

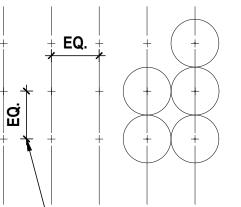

- TYPICAL PLANT SPACING SQUARE SPACING



TYPICAL PLANT SPACING

TRIANGULAR SPACING


ON-CENTER PLANT SPACING VARIES PER SPECIES. REFER TO PLANTING LIST

1" BELOW PAVEMENT

ADJACENT PAVEMENT



PLANTING DETAIL

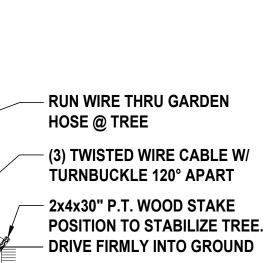

PLANT MATERIAL SHALL NOT BE

PRUNE EACH UNIFORMLY.

PREPARE PLANTING SOIL,

- REMOVE BURLAP FROM

TOP OF ROOT BALL

COMPACT FULLY

PRUNED PRIOR TO INSTALLATION;

AFTER PLANTS HAVE BEEN INSTALLED,

- SOIL MIX AS PER SPECIFICATIONS

SMALL TREE SUPPORT DETAIL

III PLANT II BALL

18. ALL EXISTING PLANT MATERIAL TO REMAIN SHALL BE PROTECTED. (REFER TO

19. ALL TREES TO BE RELOCATED WILL GET ROOT PRUNED 30 DAYS MIN. (OR MORE IF REQUIRED BY THE SPECIES). UPON RELOCATION, THIN OUT (UNDER LANDSCAPE ARCHITECT'S DIRECTION) 30% OF THE TREE CANOPY TO BE RELOCATED.

20. AFTER REMOVAL OR RELOCATION OF EXISTING TREES AND PALMS, BACKFILL TREE PIT WITH PLANTING SOIL AND SOD DISTURBED AREA, AS REQUIRED. 21. ALL TREES ON SOD AREAS SHALL RECEIVE A MULCH RING 2' IN DIAMETER TYPICAL.

22. ALL TREES SHALL HAVE A 2" CALIPER AT D.B.H. MINIMUM FOR A 10' HEIGHT TREE. 23. ALL 1 GALLON MATERIAL TO HAVE A 12" SPREAD MINIMUM, ALL 3 GALLON MATERIAL TO HAVE A 20-24" SPREAD MINIMUM.

SAFETY.

2" AND LARGER CALIPER TREES BRACED BY GUYING -


1. CHOOSE THE CORRECT SIZE AND NUMBER OF STAKES AND SIZE OF HOSE AND WIRE. GUYING SHALL BE COMPLETED WITHIN 48 HOURS OF PLANTING THE TREE. 2. CUT LENGTHS OF STAKING HOSE TO EXTEND 2 INCHES PAST TREE TRUNK WHEN

3. SPACE STAKES EVENLY ON OUTSIDE OF WATER RING AND DRIVE EACH FIRMLY INTO THE GROUND. STAKES SHOULD BE DRIVING AT A 30 DEGREE ANGLE WITH THE POINT OF THE STAKE TOWARD THE TREE UNTIL 4 TO 5 INCHES ARE LEFT SHOWING. 4. PLACE THE HOSE AROUND THE TREE TRUCK JUST ABOVE THE LOWEST BRANCH. 5. THREAD THE WIRE THROUGH THE HOSE AND PAST THE STAKE, ALLOWING APPROXIMATELY 2 FEET OF EACH OF THE TWO ENDS BEYOND THE STAKE BEFORE

7. PULL WIRE DOWN AND WIND BOTH ENDS AROUND STAKE TWICE. TWIST WIRE BACK ONTO ITSELF TO SECURE IT BEFORE CUTTING OFF THE EXCESS.

8. THE ABOVE PROCEDURES ARE TO BE FOLLOWED FOR EACH STAKE, KEEPING THE TREE STRAIGHT AT ALL TIMES. THERE SHOULD BE A 1 TO 3 INCH SWAY IN THE TREE (THE WIRES SHOULD NOT BE PULLED TIGHT) FOR BEST ESTABLISHMENT. 9. FLAG THE GUY WIRES WITH SURVEYOR'S FLAGGING OR APPROVED EQUAL FOR

10. GUYS ARE NOT TO BE REMOVED UNTIL APPROVED BY LANDSCAPE CONTRACTOR.

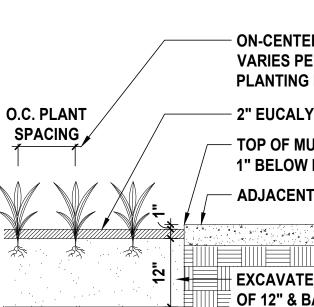

2" EUCALYPTUS MULCH TOP OF MULCH SHALL BE

WITH PREPARED

LAND INFORM Zoning

OPEN S A. Square

Lot Area B. Square

- Number C. Total squ
- LAWN A A. Square

B. Maximu

- **TREES** A. Number trees m
- N/A B. % Nativ C. % Low r
- Number D. Street T
- ____75 E. Street to (maxim

SHRUB:

A. Number B. % Nativ

LARGE A. Number

- x 10%=
- B. % Nativ small tr

PLANT I	LIST		
TREES &			
Native	Qty	Botanical/Common Name	Specifications
N	3	Bambusa 'Lako'	15'-0" to 20'-0" Ht., 45 Gal. (Matching Hts.)
IN	3	Lako/Timor Black Bamboo	(See General Note #1 Below)
Y	2	Bursera simaruba	16'-0" Ht. x 12'-0" Sp. (Specimens)
Ť	2	Gumbo Limbo Tree	12" Caliper Min. (See General Note #1 Below)
N	28	Caryota mitis	18'-0" Ht., Field Grown, Balled & Burlapped, Clumps,
IN	20	Fishtail Palm	Full to Base (See General Note #1 Below)
N	4	Cocos nucifera	18'-0" to 20'-0" Clear Wood Ht. x 15'-0" Sp. (2 Curved Trunks
IN	4	Coconut Palm	& 2 Straight Trunks) (See General Note #1 Below)
Y	3	Conocarpus erectus 'Sericeus'	14'-0" Ht. x 8'-0" Sp., 3" Min. Caliper, 4-0" Min Clear Trunk (C.T.),
T	3	Silver Buttonwood Trees	(See General Note #1 Below)
Y	4	Clusea rosea	20'-0" Ht. x 12'-0" Sp. (Specimen-Multi Trunk)
1	4	Autograph/Pitch Apple Tree	(See General Note #1 Below)
N	3	Dypsis cabadae	14'-0" Ht. (Multi-trunk) x 10'-0" Sp.
IN	5	Cabada Palm	(See General Note #1 Below)
N	4	Elaeocarpus decipiens	16'-0" Ht. x 8'-0" Sp. (Max Rootball 3'-6' x 3'-6"), 6-8 FT C.T. Min.,
IN	4	Japanese Blueberry Tree	Multi-Trunk (See General Note #1 Below)
Y	2	Myrcianthes fragrans	10'-0" Ht. x 6'-0" Sp. (Specimens);
1	۲	Simpson Stopper Tree	3-4" Caliper Min. (See General Note #1 Below)
N	1	Schizostachyum brachycladum	20'-0" Ht. Min., Field Grown, Balled & Burlapped
IN	I	Sacred Bali Bamboo	(See General Note #1 Below)
SHRUBS	& GRO	UNDCOVERS	
NI	12	Alocasia macrorrhiza 'Borneo Giant'	17" Pot.
N	12	Elephant Ear	


IN	12	Elephant Ear	
Ν	2	Asplenium nidus Bird's Nest Fern	15 Gal.
Y	20	Conocarpus erectus 'Sericeus' Silver Buttonwood Shrubs	65 Gal. Full to Base (8'-10' Ht x 4'-6' Crown Spread) Shrub/Bush Form - Multi Stem
Y	32	<i>Ernodea littoralis</i> Golden Creeper	3 Gal. @ 24" On-Center (O.C.) Planted at 18" Ht. Min.
N	15	Ficus pumila Creeping Fig Vine	Gal. Full - Trained to Architecture Façade
Y	48	<i>Myrsine guianensis</i> Colicwood	7 Gal Full to Base Shrub/Bush Form
N	16	<i>Neoregelia 'Midnight Siam'</i> Bromeliad 'Midnight Siam'	8" Pot.
Y	48	<i>Nephrolepis exaltata</i> Boston Fern	3 Gal. @ 24" On-Center (O.C.) Planted at 18" Ht. Min.
Y	48	Osmunda cinnamomea Cinnamon Fern	3 Gal. @ 30" On-Center (O.C.) Planted at 18" Ht. Min.
N	47	Philodendron Gloriosum10 Gal. @ 30" On-Center (O.C.)	
N	2	Philodendron 'McWilliamsii' Same	10 Gal Trained to Climb Architecture Façade
N	93	Podocarpus macrophyllus 'Maki' Podocarpus Hedge / Japanese Yew	25 Gal. (5'-0" Min. Planted Ht) @ 30" On-Center (O.C.) Shrub/Bush Form - Full to Base
ISCELI		8	
	580 S.F.	Empire Zoysia Sod	Alt: Cashmere
		Empire Zoysia Sod in Right-of-Way	Alt: Cashmere

Landscape Contractor shall provide photographic submittal with person for scale reference to Landscape Architect for review and approval prior to purchasing plants.

CITY OF MIAMI BEACH

ANDSCAPE LEGEND			
NFORMATION REQUIRED TO BE PERMANENTLY AFFIXED TO PLANS			
oning DistrictRS-3Lot Area <u>11,250 sq.ft</u> Acres	s 0.25 acres		
DPEN SPACE	REQUIRED/ ALLOWED	PROVIDED	
quare feet of required Open Space as indicated on site plan: ot Area = <u>11,250</u> s.f.x <u>50</u> % = <u>5,625</u> s.f.	5,625 s.f.	7,975 s.f.	
Square feet of parking lot open space required as indicated on site plan:			
lumber of parking spaces <u>N/A</u> x 10 s.f. parking space =	N/A	N/A	
otal square feet of landscaped open space required: A+B=	5,625 s.f.	<u>7,975 s.f.</u>	
AWN AREA CALCULATION			
quare feet of landscaped open space required	5,625 s.f.	7,975 s.f.	
/laximum lawn area (sod) permitted= <u>50</u> % x <u>5,526</u> s.f.	2,736 s.f.	508 s.f.	
REES Iumber of trees required per lot or net lot acre, less existing number of			
rees meeting minimum requirements= <u>N/A</u> trees x <u>N/A</u> net lot acres - number of existing trees=	12	12	
6 Natives required: Number of trees provided x 30% =	4	12	
6 Low maintenance / drought and salt tolerant required:			
lumber of trees provided x 50%=	6	12	
treet Trees (maximum average spacing of 20' o.c.) 75 linear feet along street divided by 20'=	4	4	
treet tree species allowed directly beneath power lines:	4	4	
maximum average spacing of 20' o.c.):		(1 exist	ing)
75 linear feet along street divided by 20'=	4	4 (3 prop	• •
HRUBS			
Iumber of shrubs required: Sum of lot and street trees required x 12=	192	332	
6 Native shrubs required: Number of shrubs provided x 50%=	166	176	
ARGE SHRUBS OR SMALL TREES			
Iumber of large shrubs or small trees required: Number of required shrubs 10%=	20	20	
6 Native large shrubs or small trees required: Number of large shrubs or mall trees provided x 50%=	10	20	


Lands archit DAVID J. RLA#6 p.o. box coconut grove 305.854.9299 - 3 davidodesign WWW.DAVIDC	C A e c t u ODISH 666969 333161 ,fl. 332 305.854.9 @hotmai	p e i r e 100 5 33-1615 0882 fax 1.com
PROJECT NAME: PRIVATE RESIDENCE	PROJECT ADDRESS: 1485 CLEVELAND ROAD,	MIAMI BEACH, FL - 33141
••••••••••••••••••••••••••••••••••••		
PROJECT NO SCALE: DATE: DRAWN: CHECKED: CADD FILE: DRAWING TIT PLAN SCHEDULE & GENER/ SHEET NO.	AS No 01/06 LJ LE: ITING E, DE AL NC	/2020 & RR D.O. TAILS DTES

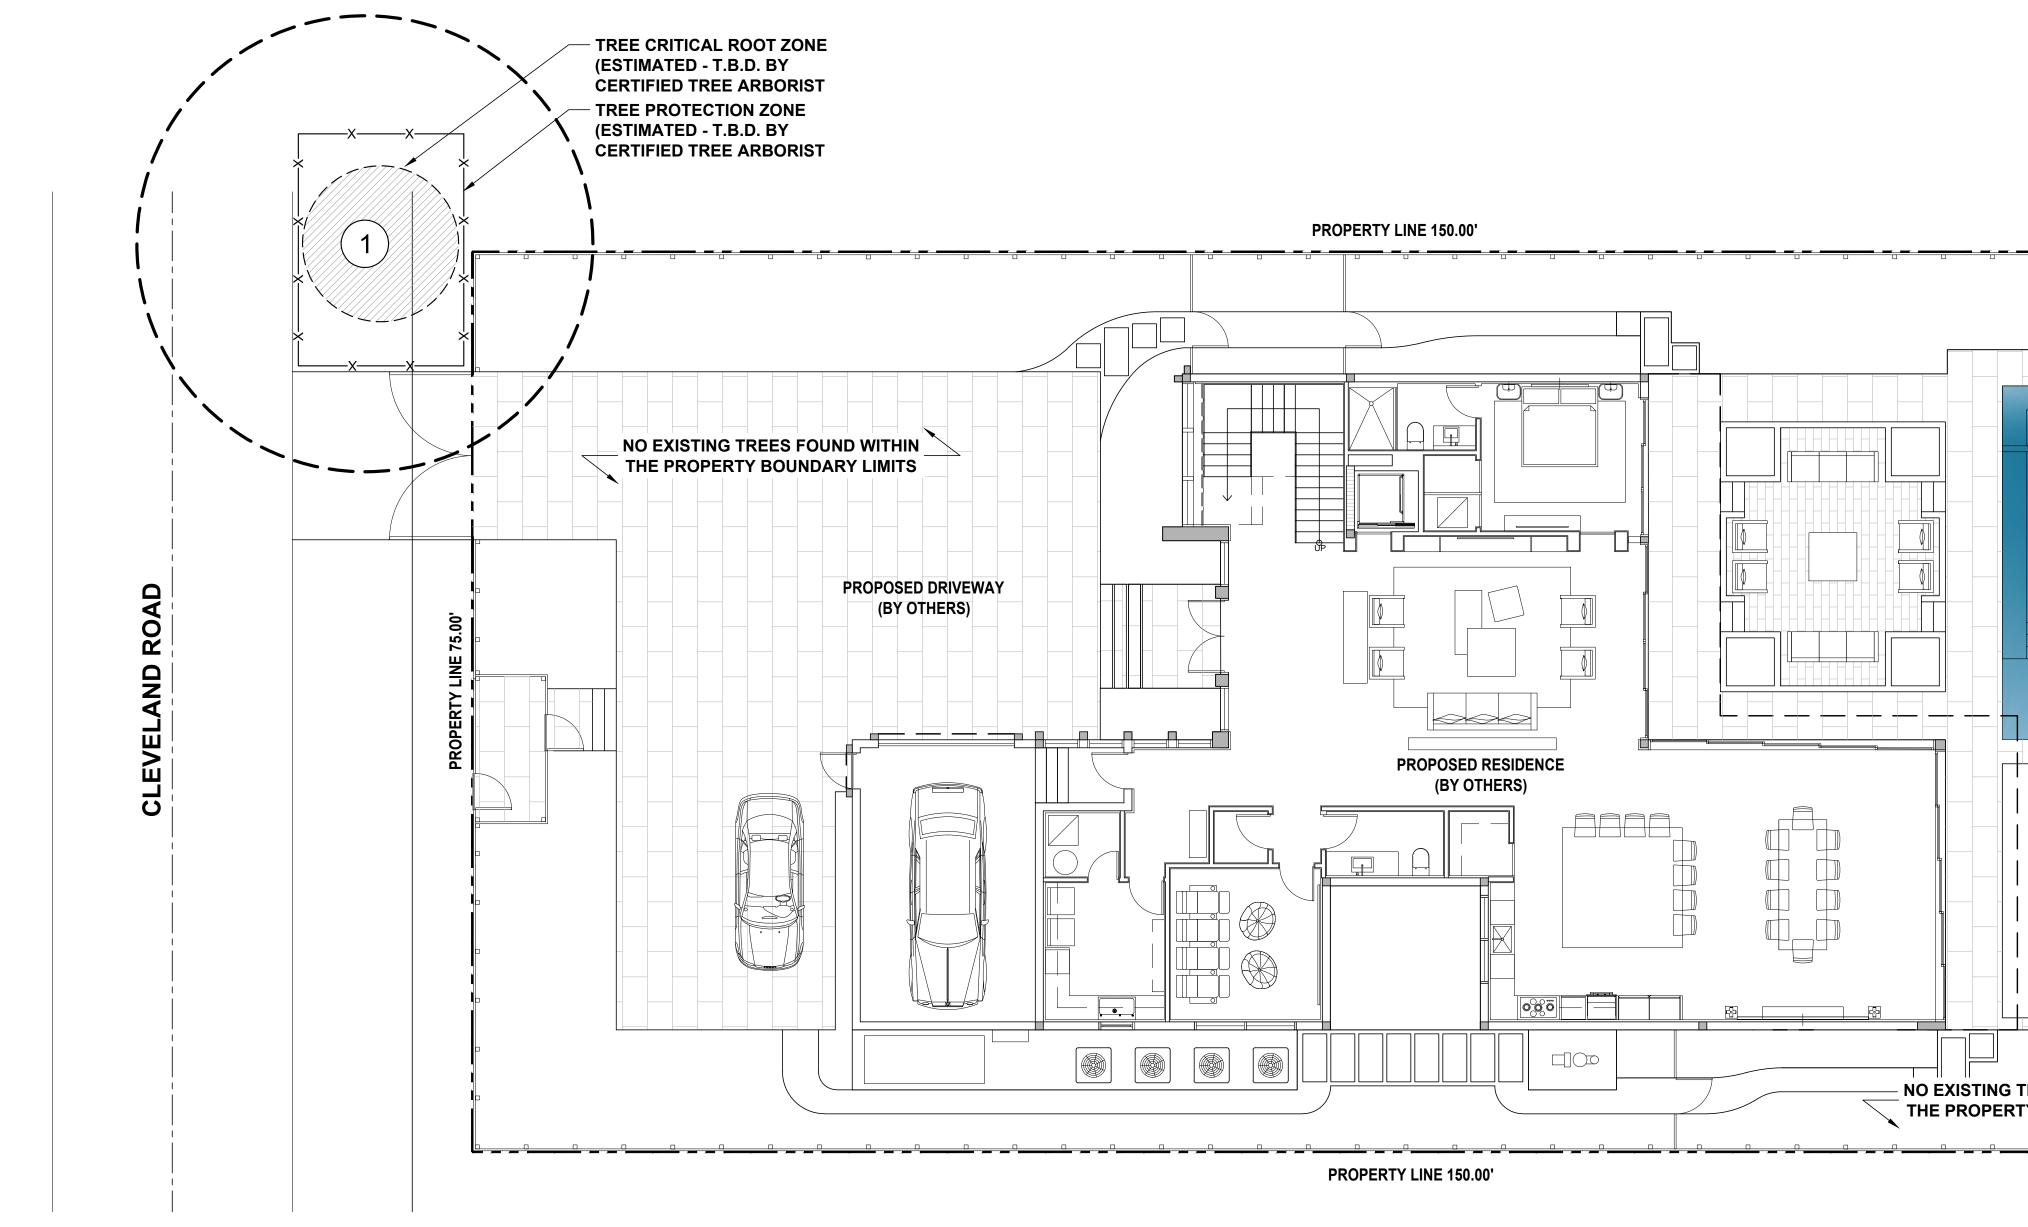


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#	= TREE OR PAL
	= TREE PROTE
	= CRITICAL RO

EXISTING	TREE LIST
SURVEY	СОММОМ
No	COMMON
1	Bay La
1	Bay La

PROVIDE A ADDITIONAL PER INCH OF DBH ON TR

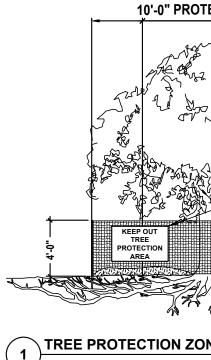

						lands archit DAVIDJ. RLA#6 p.o. box coconut grove 305.854.9299 - 3	
LM TO REMAIN ECTION ZONE (TPZ) DOT ZONE (CRZ) Image: A set of the	POOL & SPA (BY OTHERS)	PROPERTY LINE 75.00'				TE RESIDENC	
N NAME SCIENTIFIC NAME DIAMETER (INCHES) HEIGHT (FT) CANOPY (FT) aurel Laurus nobilis 20 40 38 L8'-12'' PROTECTION AREA RRES LARGER THAN 10' DBH 1-SEE SPECIFICATIONS FOR ADDITIONAL TREE PROTECTION REQUIREMENTS. 2-IF THERE IS NO EXISTING IRRIGATION, SEE SPECIFICATIONS FOR WATERING REQUIREMENTS. SEAL: 3-NO PRUNING SHALL BE PERFORMED EXCEPT BY APPROVED ARBORST. 4-NO EQUIPMENTS S-NO PRUNING SHALL BE PERFORMED EXCEPT BY APPROVED ARBORST. 4-NO EQUIPMENTS SEAL: 5-NO PRUNING SHALL BE PERFORMED EXCEPT BY APPROVED ARBORST. 4-NO EQUIPMENTS S-NO PRUNING SHALL BE PERFORMED EXCEPT BY APPROVED ARBORST. 4-NO EQUIPMENT SHALL OPERATION AND REMOVAL. SEAL: S-S'S 11'S IGON LAMINATE IN SIDAL THE PROTECTIVE FENCING INCLUDING DURING FENCE: HIGH DENSITY POLYETHYLENE FENCING WITH 5'S 1'S GO PENNINGS; COLOR-ORANGE STEEL POSTS INSTALLED AT 8'O.C. 2''S 'S '1'S GON APPROVED EQUAL SEAL: S'S 1'S 'DEPENNIOS; COLOR-ORANGE STEEL POSTS INSTALLED AT 8'O.C. 2''S 'S '1'S GR APPROVED EQUAL SCALE: AS NOTED DATE: OPENNIOS; COLOR-ORANGE STEEL POSTS INSTALLED AT 8'O.C. 2''S 'S '1'HICK MUCH LAYER PROJECTION PLAN, SCHEDULE & DETAIL NINTAN EXERTION PLAN, SCHEDULE & DETAIL D.O. CADD FILE: D.O. CADD FILE: DRAWING TITLE: TREE DISPOSITION PLAN, SCHEDULE & DETAIL SHEET NO. SCALE: 11'S'' = 1'-0'' INCLECT NO. INCLECT NO. </th <th>LM TO REMAIN ECTION ZONE (TPZ)</th> <th></th> <th></th> <th></th> <th></th> <th>PROJECT NAME:</th> <th>⊢</th>	LM TO REMAIN ECTION ZONE (TPZ)					PROJECT NAME:	⊢
aurel Laurus nobilis 20 40 38 Ls"-12" PROTECTION AREA REES LARGER THAN 10" DBH NOTES: 1 - SEE SPECIFICATIONS FOR ADDITIONAL TREE PROTECTION REQUIREMENTS. 2 - IF THERE IS NO EXISTING IRRIGATION, SEE SPECIFICATIONS FOR WATERING REQUIREMENTS. 3 - NO PRIVINOS SHALL BE PERFORMED EXCEPT BY APPROVED ARBORIST. 4 - NO EQUIPMENT SHALL OPERATE INSIDE THE PROTECTIVE FENCING INCLUDING DURING SHALL DOPERATE INSIDE THE PROTECTIVE FENCING INCLUDING NAREA. 8.5" X 11" SIGN LAMINATED IN PLASTIC SPACED EVERY 50' ALONG THE FENCE TREE PROTECTION FENCE: HIGH DENSITY POLYETHYLENE FENCING WITH 3.5" X 15" OPENINGS; COLOR- ORANGE. STELL POSTS INSTALLED AT 8" O.C. 2" X 6' 0" STEEL POSTS OR APPROVED EQUAL 5" THICK MUCH LAYER MAINTAIN EXISTING GRADE WITH THE TREE PROTECTION FENCE UNLESS OTHERWISE INDICATED ON PLANS PROJECT NO: 19021 SCALE: MS NOTED DATE: 01/06/2020 DRAWNI: LL & RR CHECKED: D.O. CADD FILE: DRAWNIS TILL & MAINTAIN EXISTING GRADE WITH THE TREE PROTECTION FENCE UNLESS OTHERWISE INDICATED ON PLANS PROJECT NO: 19021 SCALE: MS NOTED DATE: 01/06/2020 DATE: 01/0						Revisions:	
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3.5" X 1.5" OPENINGS; COLOR- ORANGE. STEEL POSTS INSTALLED AT 8' O.C. 2" X 6'-0" STEEL POSTS OR APPROVED EQUAL 5" THICK MUCH LAYER MAINTAIN EXISTING GRADE WITH THE TREE PROTECTION FENCE UNLESS OTHERWISE INDICATED ON PLANS ONE DETAIL TREE DISPOSITION PLAN, SCHEDULE & DETAIL SCALE: 1/8" = 1'-0" N LR_100	REES LARGER THAN 10" DBH	1- SEE SPEC 2- IF THERE REQUIREME 3- NO PRUN 4- NO EQUIP INCLUDING 5- SEE SITE PROTECTIO	IS NO EXISTING IRRIGATION, SE NTS. ING SHALL BE PERFORMED EXO MENT SHALL OPERATE INSIDE DURING FENCE INSTALLATION PREPARATION PLAN FOR ANY IN N AREA.	E SPECIFICATIONS CEPT BY APPROVE THE PROTECTIVE F AND REMOVAL. MODIFICATIONS WI	S FOR WATERING D ARBORIST. FENCING TH THE TREE	 SEAL:	
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			25'			LR-	100

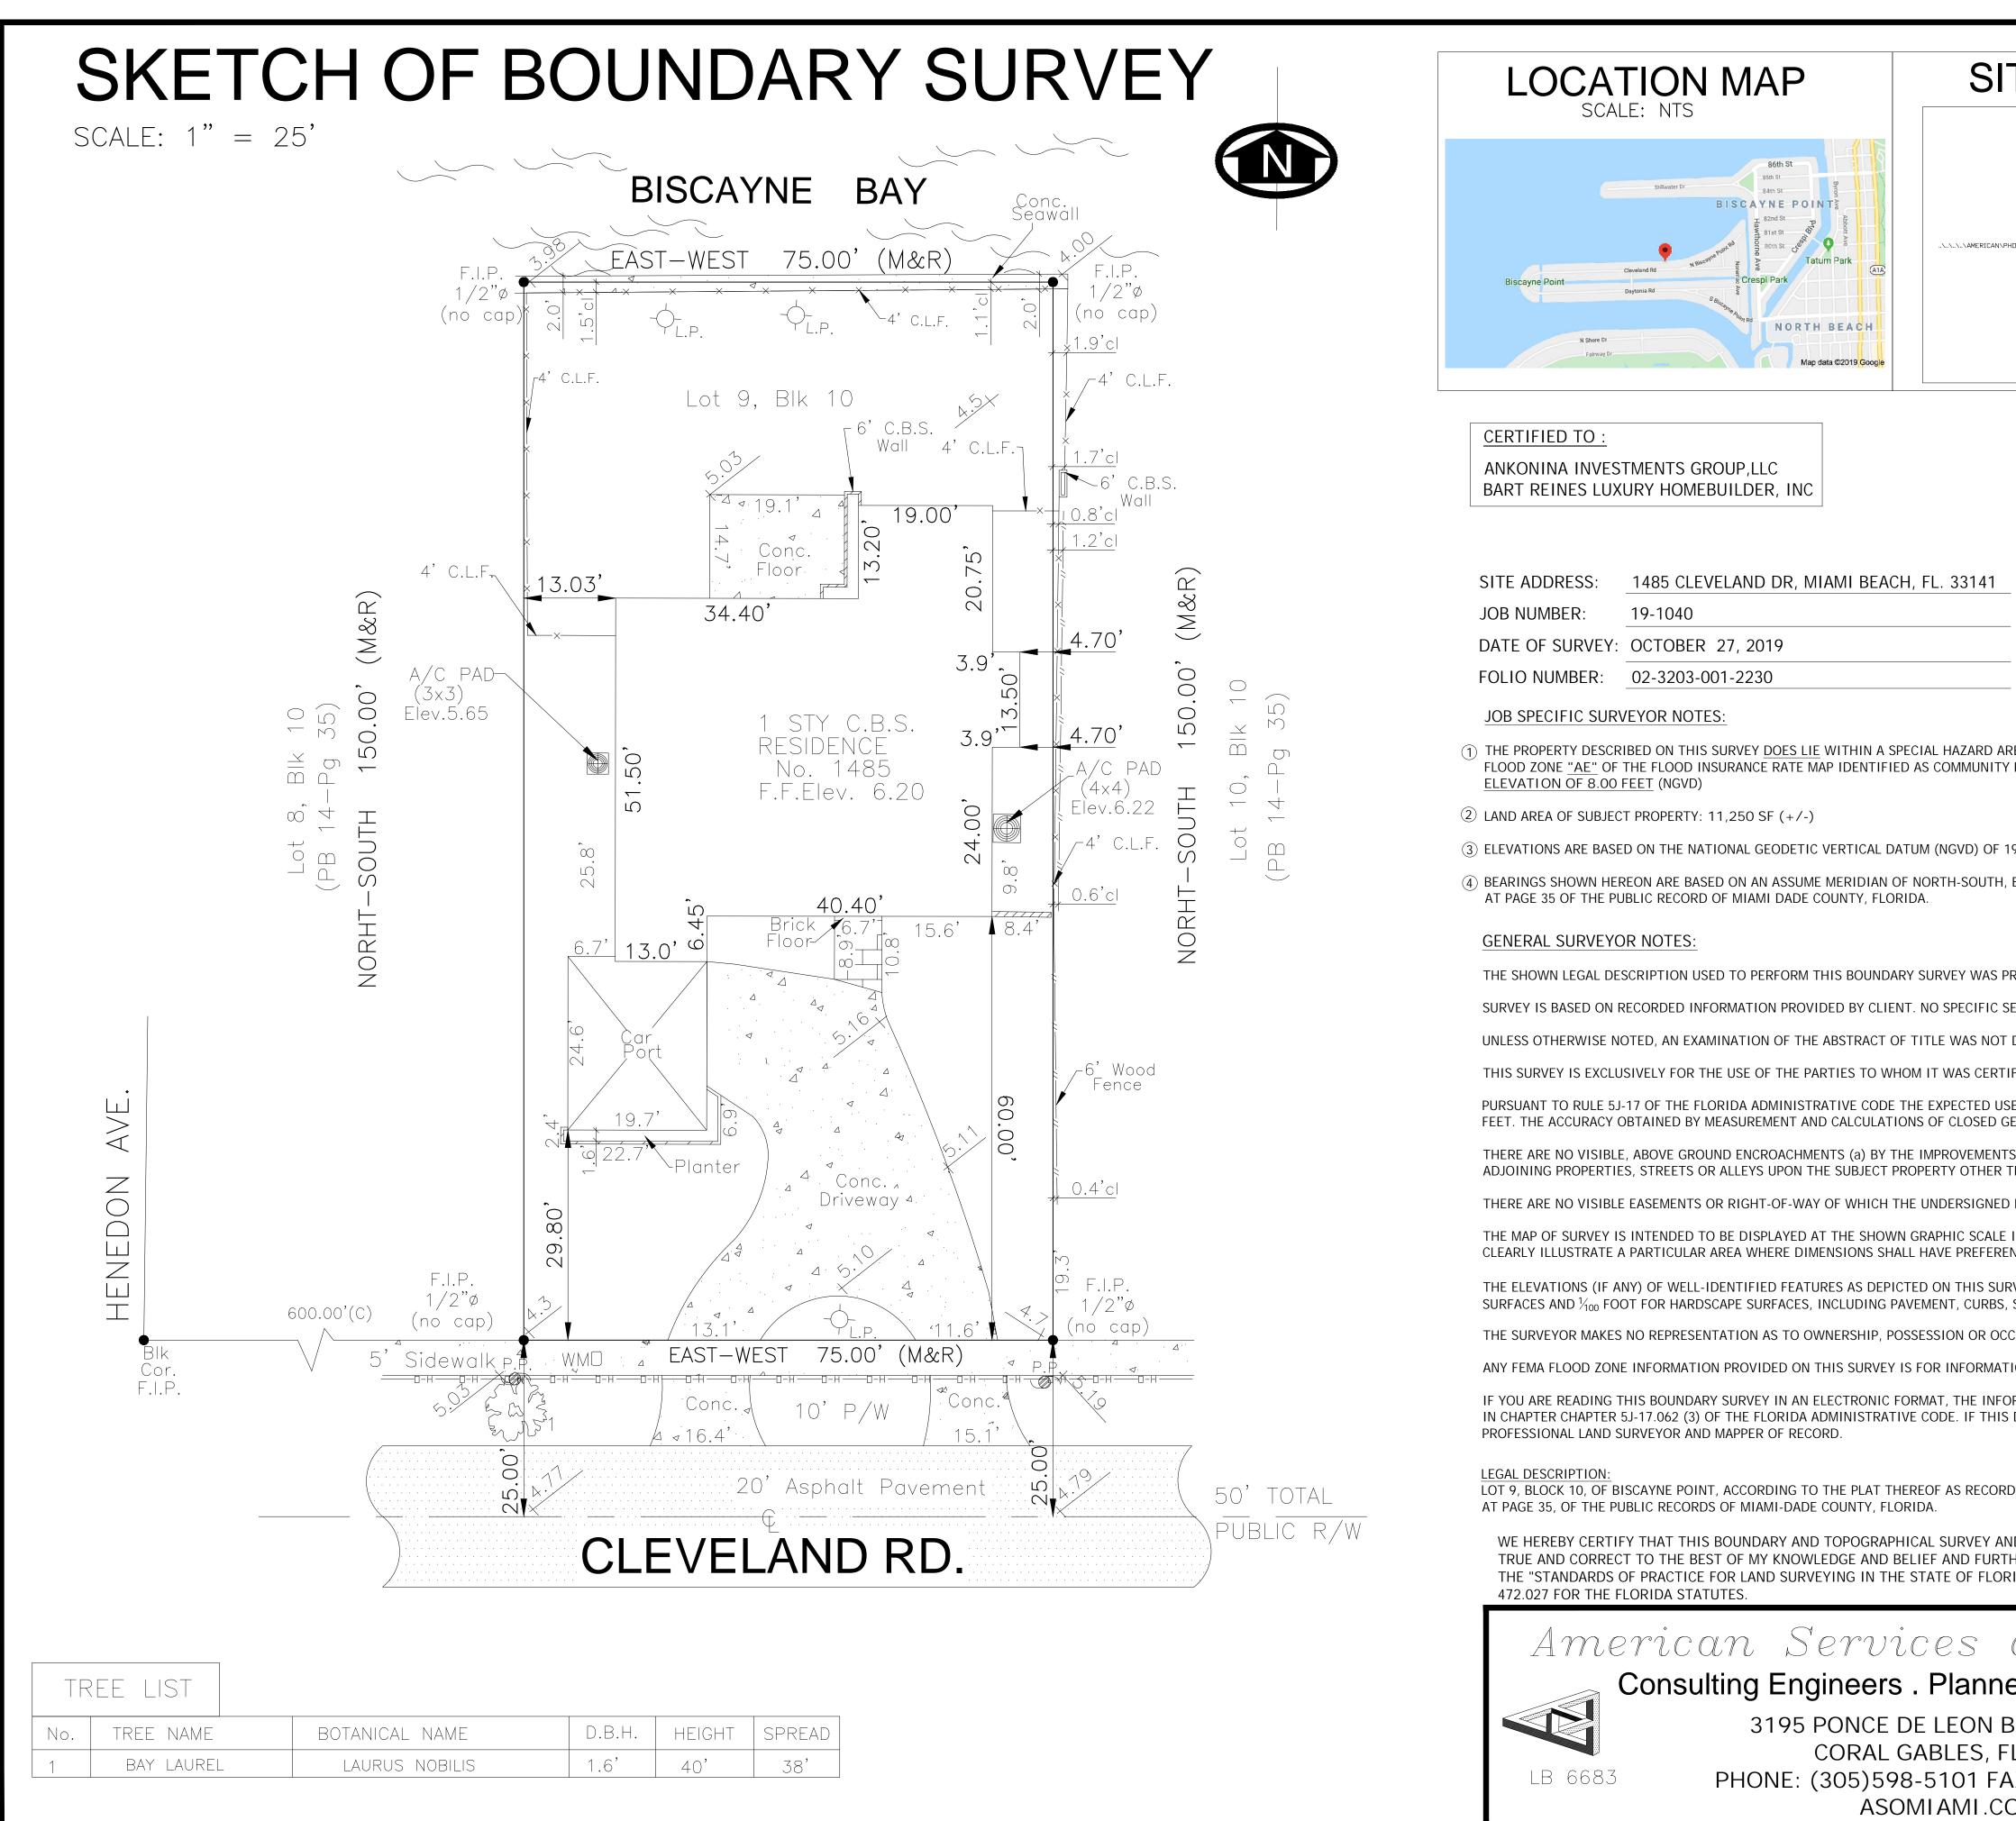

NOT VALI

	ABREVIATION (IF ANY APPLIED)
TE PICTURE	$A/C = AIR CONDITIONING UNITASPH. = ASPHALTP.O.B. = POINT OF BEGINNINGP.O.C. = POINT OF COMMENCEMENTB.M. = BENCH MARKP.O.C. = POINT OF COMMENCEMENTB.M. = BENCH MARKP.O.C. = POINT OF CURVATUREBIk/Corn.= BLOCK CORNERCALC.(C) = CALCULATEDP.I. = POINT OF INTERSECTIONCALC.(C) = CALCULATEDP.P. = POVER POLECB = CATCH BASINP.P. = POWER POLEC.B.S. = CONCRETE BLOCK STRUCTUREP.P. = POWER POLECL = CLEARP.T. = POINT OF TANGENCYCONC. = CONCRETEP.T. = POINT OF TANGENCYD.M.E. = DRAINAGE MAINT. EASEMENTP.T. = POINT OF TANGENCY\emptyset = DIAMETERRES. = RESIDENCEEASMT. = EASEMENTRES. = RESIDENCEELEV. = ELEVATIONR/W = RIGHT OF WAY$
HDTDS FOR ELEVATIONS\BART REINES\1485 CLEVELAND\19-1040 FRONT.jpg	ELECTELECTInterferenceENC. = ENCROACHMENTSEC. = SECTIONF.D/H = FOUND DRILL HOLES.D/H = SET DRILL HOLEF.H. = FIRE HYDRANTS.D/H = SET NAIL AND DISCF.N/D = FOUND NAIL AND DISCS.I.P. = SET IRON PIPEF.I.P. = FOUND IRON PIPES.R.B. = SET REBARF.S. = FOUND SPIKESTY = STORYL.P. = LIGHT POLESWK. = SIDEWALKMEAS.(M) = MEASUREDT.O.P. = TOP OF BANKMH = MANHOLEU.E. = UTIL. EASEMENTM = MONUMENTW.P. = WOODEN POLEM = MONUMENT LINE \mathfrak{L} = SECTION LINENTS = NOT TO SCALESTY = STORY
	SURVEYOR'S LEGEND (IF ANY APPLIED)
	BOUNDARY LINE CATCH BASIN STRUCTURE (BLDG.) MANHOLE CONCRETE BLOCK WALL O.E. WOODEN FENCE POWER POLE WOOD DECK/DOCK LIGHT POLE WOOD DECK/DOCK FIRE HYDRANT CONCRETE FIRE HYDRANT CONCRETE WATER VALVE BRICKS OR PAVERS WATER VALVE ROOFED AREAS W WATER (EDGE OF WATER) WM WM WATER METER WATER NETER WM
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929, AS PER MIAMI DADE COUNTY BENCH MARK No. <u>I</u> BEING THE RECORDED BEARING FOR THE CENTERLINE	
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EARCH OF THE PUBLIC RECORD HAS BEEN MADE BY OU DONE BY THE SIGNING SURVEYOR TO DETERMINE WHI FIED.	R OFFICE. CH INSTRUMENTS, IF ANY ARE AFFECTING THE SUBJECT PROPERTY.
	TANCE ACCURACY FOR THIS TYPE OF SURVEY IS 1 FOOT IN 7,500
	RTIES, STREETS OR ALLEYS, OR (b) BY THE IMPROVEMENTS OF THE
HAS BEEN ADVISED OTHER THAN THOSE SHOWN ON T	
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RVEY AND MAP WERE MEASURED TO AN ESTIMATED VER SIDEWALKS AND OTHER MANMADE STRUCTURES.	RTICAL POSITIONAL ACCURACY OF $\frac{1}{10}$ FOOT FOR NATURAL GROUND
CUPATION OF THE SUBJECT PROPERTY BY ANY ENTITY	
	LID IF THIS DOCUMENT IS ELECTRONICALLY SIGNED AS SPECIFIED
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DED IN PLAT BOOK 14 -THE SUBJECT PROPERT	E ENCROACHMENT OF THE SUBJECT PROPERTY Y IS WITHIN A FLOOD ZONE AE (SEE NOTE 1) IL. EASEMENT ON THE SUBJECT PROPERTY
HER, THAT SAID "BOUNDARY AND TOPOGRAPHICAL	PERFORMED UNDER MY SUPERVISION AND/OR DIRECTION AND IS SURVEY" MEETS THE INTENT OF THE APPLICABLE PROVISIONS OF DMINISTRATIVE CODE AND ITS IMPLEMENTING LAW, CHAPTER
of Miami, Cor	<i>p</i> .
ers.Surveyors	Ed Pino
BLVD, SUITE 200 L 33134	PROFESSIONAL LAND SURVEYOR AND MAPPER No. 6771 STATE OF FLORIDA
X: (305)598-8627 DM	DATE : OCTOBER 30, 2019
	SEAL OF A FLORIDA LICENSED SURVEYOR AND MAPPER