

TREE PROTECTION NOTES:

1. ALL TREE RELOCATION AND REPLACEMENT SHALL BE DONE IN ACCORDANCE WITH STANDARD FORESTRY PRACTICES AND PROCEDURES AND ALL SUCH PLANTINGS SHALL BE MAINTAINED AND ATTENDED TO PROMOTE SUCCESSFUL ESTABLISHMENT THEREOF.

2. DURING CONSTRUCTION, ALL REASONABLE STEPS SHALL BE TAKEN TO PREVENT THE DAMAGE OF VEGETATION DESIGNATED FOR PRESERVATION. VEGETATION DESTROYED OR DAMAGED MUST BE REPLACED BY VEGETATION OF EQUAL OR BETTER ENVIRONMENTAL VALUE, OR AS SPECIFIED BY THE CITY IN WHICH THE PROJECT IS LOCATED.

3. NO EXCESS SOIL, ADDITIONAL FILL, EQUIPMENT, LIQUIDS OR CONSTRUCTION DEBRIS SHALL BE PLACED WITHIN THE DRIP LINE OF ANY VEGETATION THAT IS BEING PRESERVED IN ITS PRESENT LOCATION, OR RELOCATED MATERIAL. ADDITIONALLY, NO SOIL SHALL BE REMOVED FROM THE DRIP LINE OF ANY OF SAID TREES.

4. PROTECTIVE BARRIERS SHALL BE ERECTED FOR ALL EXISTING TREES TO REMAIN IN PLACE, AS SHOWN IN THE DETAILS. THE PROTECTIVE BARRIERS SHALL BE INSTALLED AND MAINTAINED FOR THE PERIOD OF TIME BEGINNING WITH THE COMMENCEMENT OF ANY LAND CLEARING OR BUILDING OPERATIONS, AND ENDING WITH THE COMPLETION OF THE PERMITTED CLEARING OR BUILDING CONSTRUCTION WORK ON THE

5. AN ON SITE REPRESENTATIVE MUST BE PRESENT AND RESPONSIBLE FOR THE INSTALLATION AND MAINTENANCE OF ALL VEGETATION PROTECTIVE BARRIERS. THE REPRESENTATIVE SHALL BE RESPONSIBLE FOR SUPERVISING THE REMOVAL OF ALL EXISTING VEGETATION AND CLEARING OPERATIONS. 6. NO WORK SHALL COMMENCE WITHOUT RECEIVING ALL OF THE APPROPRIATE TREE PROTECTION. TREE REMOVAL AND TREE RELOCATION PERMITS.

7. FOR TREES TO BE REMOVED, ALL CUTTINGS, LEAVES, BRANCHES ETC, MUST BE PROMPTLY REMOVED FROM THE SITE. ALL STUMPS SHALL BE REMOVED BY UTILIZING A STUMP GRINDER OR REMOVING THE STUMP USING APPROPRIATE HYDRAULIC EQUIPMENT.

- 6. TREES TO BE RELOCATED SHALL UNDERGO THE FOLLOWING PRIOR TO RELOCATION: A. THE TREES SHALL BE STRUCTURALLY CROWN PRINNED IN ACCORDANCE WITH ACCEPTED ARBORIST STANDARDS IN PREPARATION FOR TREE RELOCATION. B. AFTER A PERIOD OF 60 DAYS AFTER CROWN PRINNED IN ACCORDANCE WITH ACCEPTED ARBORIST STANDARDS IN PREPARATION FOR TREE RELOCATION. B. AFTER A PERIOD OF 60 DAYS AFTER CROWN PRINNED IN ACCORDANCE WITH ACCEPTED ARBORIST STANDARDS. C. AFTER A SECOND PERIOD OF 60 DAYS. THE REMAINING 12 OF THE ROOT FRUNCE DAGE TO THE RUND FLAX. SHALL BE ROOT FRUNDED ARBORISTS STANDARDS. C. AFTER A SECOND PERIOD OF 60 DAYS. THE REMAINING 12 OF THE ROOT FRUNDE DAS DESIGNANTED MACCEPTED ARBORISTS STANDARDS. C. AFTER A SECOND PERIOD OF 60 DAYS. THE REMAINING 12 OF THE ROOT FRUNDE DAS DESIGNANTED ARBORIST DISTANCE ARBORIST OF THE ATTER AND ARDS. C. AFTER A SECOND PERIOD OF 60 DAYS. THE TREE SHALL THEN BE RELOCATED IN ACCORDANCE WITH ACCEPTED ARBORIST STANDARDS. D. AFTER A THIRD PERIOD OF 60 DAYS. THE TREES SHALL THEN BE RELOCATED IN ACCORDANCE WITH ACCEPTED ARBORIST FOR THE STEPS MALL DCATION. E. THE TREES WILL BE READY FOR RELOCATION AFTERA A TOTAL PERIOD OF 100 DAYS AND ORDERULY SATISFACTION OF THE STEPS MACH. F. IN THE EVENT THESE GUIDELINES DIFFER FROM LISTED ACCEPTED ARBORIST STANDARDS, THE ARBORISTS STANDARDS SHALL PREVAIL.

9. RELOCATED TREE SHALL BE PROPERLY IRRIGATED TO ASSURE THEIR SURVIVAL BOTH PRIOR TO RELOCATION (DURING ROOT PRUNING PROCESS) AND AFTER RELOCATION. ONCE THE TREE HAS BEEN RELOCATED, PROPER IRRIGATION SHALL INCLUDE BOTH BUBBLERS OVER THE ROOT ZONE, AND MIST HEADS IN THE CROWN THAT ADEQUATELY RINSE THE ENTIRE CROWN OF THE TREE (SEE DETAILS).

Appendix – A – Measurements and condition rating

	Scientific name	Common name	DBH	H/Ct	Canopy	Condition	TPZ
1	Podocarpus macrophyllus	Podocarpus	21"	25'	25'	Good	5'
2	Same as 1						
3	Kigelia pinnata	Sausage tree	22"	35'	55'	Good	18'
3a	Roystonea regia	Royal palm	19"	30'	28'	Good	5'
4	Roystonea regia	Royal palm	18"	16'	28'	Good	5'
5	Adonidia merrillii	Christmas palm	6"	16'	10'	Moderate	3'
6	Adonidia merrillii	Christmas palm	18"	20'	20'	Moderate	3'
7	Same as 6						
8	Same as 6						
9	Roystonea regia	Royal palm	21"	55'	26'	Moderate	6'
10	Adonidia merrillii	Christmas palm	6"	9'	12'	Good	3'
11	Adonidia merrillii	Christmas palm	13"	17'	15'	Moderate	4'
12	Same as 11						
13	Roystonea regia	Royal palm	45"	35'	32'	Good	6'
14	Adonidia merrillii	Christmas palm	7"	12'	16'	Good	3'
15	Adonidia merrillii	Christmas palm	7"	12'	16'	Good	3'
16	Veitchia montgomeryana	Montgomery palm	6"	20'	14'	Moderate	4'
17	Veitchia montgomeryana	Montgomery palm	7"	25'	18'	Moderate	4'
18	Adonidia merrillii	Christmas palm	13"	22'	18'	Moderate	4'
19	Same as 18						
20	Roystonea regia	Royal palm	17"	24'	25'	Good	5'
21	Roystonea regia	Royal palm	20"	20'	28'	Good	5'
21a	Dypsis lutescens	Areca palm	50"	26'	30'	Poor	
21b	Dioon spinulosium	Mexican cycad	0	2'	13'	Good	3'
22	Adonidia merrillii	Christmas palm	36"	35'	28'	Moderate	4'

	E	XISTING TREE INVE	ENTORY & DIS	POS	ITION CH/	ART						
STATUS	REFERENCE #	SCIENTIFIC NAME	COMMON NAME	DBH	HEIGHT/C.T.	CANOPY	CONDITION	TPZ				
REMAIN	1	PODOCARPUS MACROPHYLLUS	PODOCARPUS	21"	25'	25'	GOOD	5'				
REMAIN	3	KIGELIA PINNATA	SAUSAGE TREE	22"	35'	55'	GOOD	18'				
REMOVE	3a	ROYSTONEA REGIA	ROYAL PALM	19"	30'	28'	GOOD	5'				
REMOVE	4	ROYSTONEA REGIA	ROYAL PALM	18"	16'	28'	MODERATE	3'				
REMOVE	5	ADONIDIA MERRILLII	CHRISTMAS PALM	6"	16'	20'	MODERATE	3'		11/18/19	FIRST SUBMITTAL	
REMOVE	6	ADONIDIA MERRILLII	CHRISTMAS PALM	18"	20'	20'	MODERATE	3'	No.	DATE	DESCRIPTION	
REMOVE	9	ROYSTONEA REGIA	ROYAL PALM	21"	55'	26'	MODERATE	6'	s	HEET ISSUE	/ REVISION LOG	
REMOVE	10	ADONIDIA MERRILLII	CHRISTMAS PALM	6"	9'	12'	GOOD	3'	CONFIDENTIALITY NOTICE:			
REMOVE	11	ADONIDIA MERRILLII	CHRISTMAS PALM	13"	17'	15'	MODERATE	4'	The drawing and information contained within is property of Strang Design, LLC. and is intended only for the parties indentified above or of			
REMOVE	13	ROYSTONEA REGIA	ROYAL PALM	45"	35'	32'	GOOD	6'	out the panes indemined above of or governmental position(s). This plan may not be reproduced without written permission from the Project Manager assigned to this project. © 2018- STRANG DESIGN, LLC.			
REMOVE	14	ADONIDIA MERRILLII	CHRISTMAS PALM	7"	12'	16'	GOOD	3'				
REMOVE	15	ADONIDIA MERRILLII	CHRISTMAS PALM	7"	12'	16'	GOOD	3'				
REMOVE	16	VEITCHIA MONTGOMERYANA	MONTGOMERY PALM	6"	20'	14'	MODERATE	4'	,	ect ID: DWAY RE	Drawn By: S. SS / SSM	
REMOVE	17	VEITCHIA MONTGOMERYANA	MONTGOMERY PALM	7"	25'	18'	MODERATE	4'		t Date: 8/2019	Scale: AS INDICATED	
REMOVE	18	ADONIDIA MERRILLII	CHRISTMAS PALM	13"	22'	18'	MODERATE	4'		at Title:		
REMOVE	20	ROYSTONEA REGIA	ROYAL PALM	17"	24'	25	GOOD	4'		TF	REE	
REMOVE	21	ROYSTONEA REGIA	ROYAL PALM	20"	20'	28'	GOOD	5'		DISPC	SITION	
REMOVE	21a	DYPSIS LUTESCENS	ARECA PALM	50"	26'	30'	GOOD	4'		SCH	EDULE	
RELOCATE	21b	DIOON SPINULOSIUM	MEXICAN CYCAD	0	2'	13'	GOOD	4'				
REMOVE	22	ADONIDIA MERRILLII	CHRISTMAS PALM	36"	35'	28'	MODERATE	4'	She	et No:		

PLEASE SEE APPENDIX A FOR TREE DISPOSITION SCHEDULE.

[STRANG]

2900 SW 28TH TERRACE, SUITE 301 MIAMI, FL 33133

PH: 305-373-4990 FIRM LICENSE # AA26001123 WWW.STRANG.DESIGN

PROJECT LOCATION: 1710 W 23rd STREET MIAMI BEACH, FL 33140, USA FOLIO #:

02-3228-001-1660

PROJECT CLIENT(S) / OWNER(S): STEPHEN + ATHENA BRADWAY

ARCHITECT: MAX WILSON STRANG, FAIA LICENSE # AR0017183 2900 SW 28TH TERRACE, SUITE 301 MIAMI, FL 33133

STRUCTURAL ENGINEERING: TBD

MEP ENGINEERING

LANDSCAPE ARCHITECT: [STRANG] LANDSCAPE 330 NORTH ANDREWS AVE, SUITE 301 FT. LAUDERDALE, FL 33301 PH 305-373-4990


CIVIL ENGINEER: TBD

PROJECT NAME: BRADWAY RESIDENCE

PROFESSIONAL SEAL(S):



TD-101

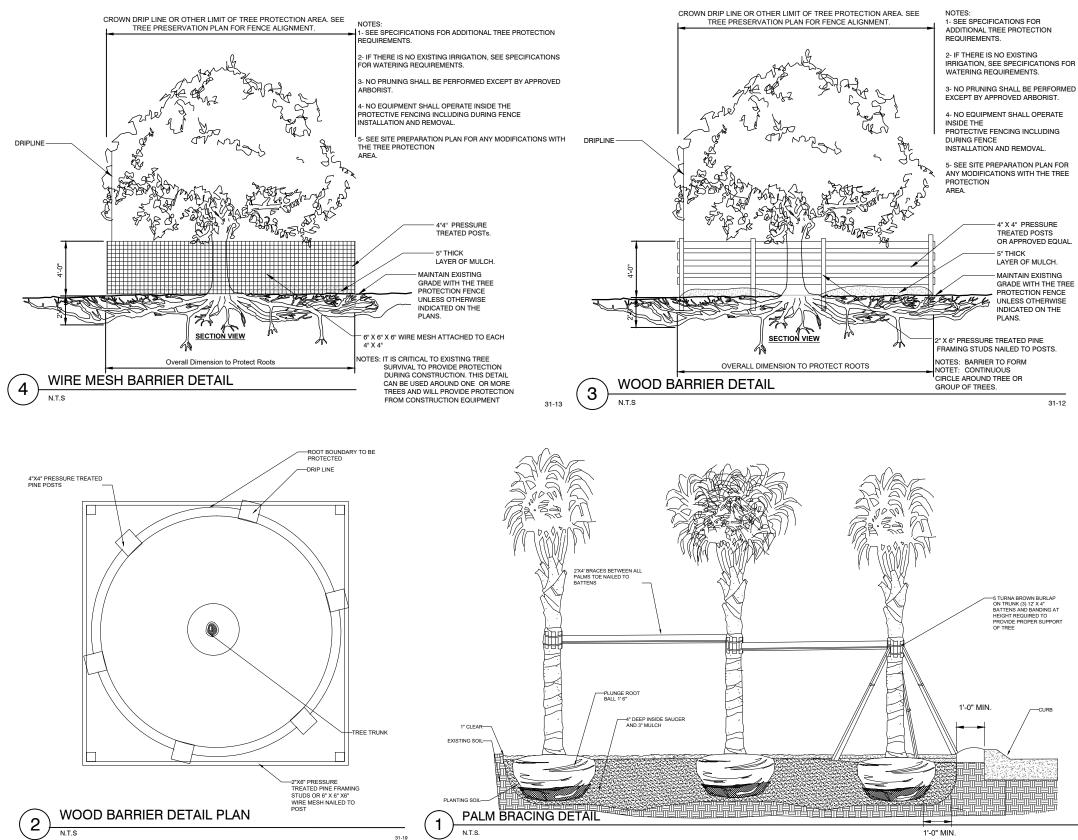

[STRANG]

2900 SW 28TH TERRACE, SUITE 301 MIAMI, FL 33133

PH: 305-373-4990 FIRM LICENSE # AA26001123 WWW.STRANG.DESIGN

PROJECT LOCATION: 1710 W 23rd STREET MIAMI BEACH, FL 33140, USA FOLIO #: 02-3228-001-1660

PROJECT CLIENT(S) / OWNER(S): STEPHEN + ATHENA BRADWAY

ARCHITECT: MAX WILSON STRANG, FAIA LICENSE # AR0017183 2900 SW 28TH TERRACE, SUITE 301 MIAMI, FL 33133

STRUCTURAL ENGINEERING: TBD

MEP ENGINEERING

LANDSCAPE ARCHITECT: [STRANG] LANDSCAPE 330 NORTH ANDREWS AVE, SUITE 301 FT. LAUDERDALE, FL 33301 PH 305-373-4990 CIVIL ENGINEER:

TBD

PROJECT NAME: BRADWAY RESIDENCE

PROFESSIONAL SEAL(S):

11/18/19

DATE

No.

FIRST SUBMITTAL

DESCRIPTION

Drawn By:

Scale: AS INDICATED

SHEET ISSUE / REVISION LOG CONFIDENTIALITY NOTICE: The drawing and information contained within is

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Sheet Title: TREE

BRADWAY RES. SS / SSM

DISPOSITION

DETAILS


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Sheet No:

Project ID:

Print Date:

11/18/2019

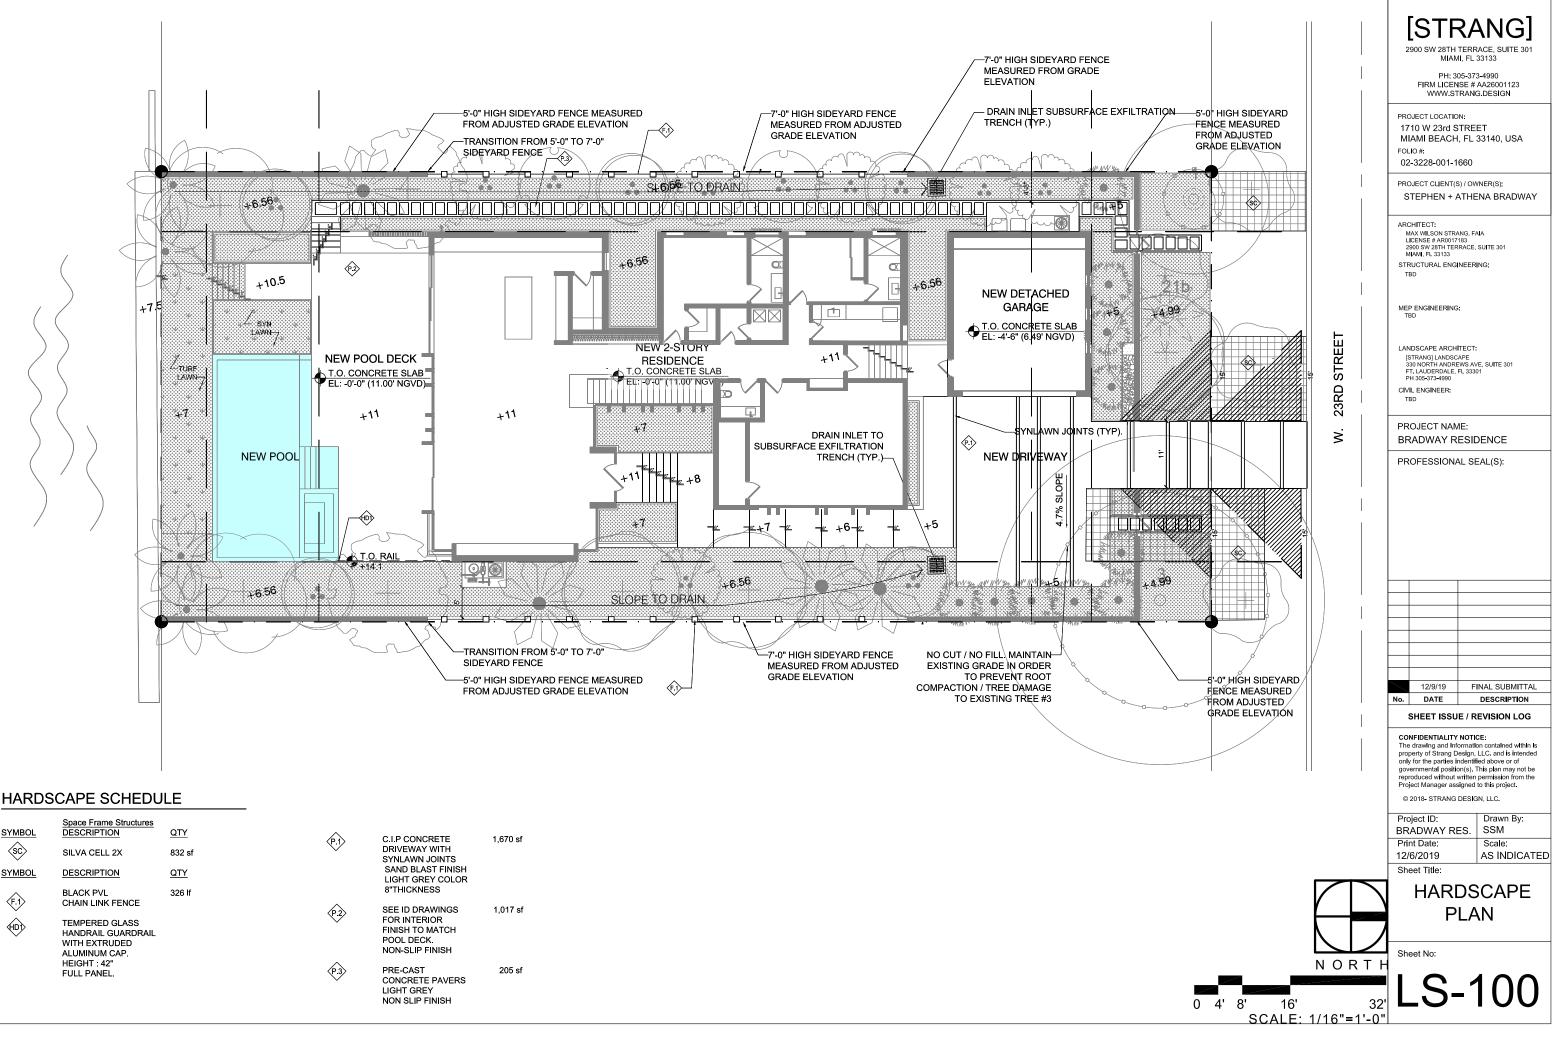

HARDSCAPE SCHEDULE

SYMBOL	Space Frame Structures DESCRIPTION	QTY		C.I.P CONCRETE	1,670 sf
ŚĊ	SILVA CELL 2X	832 sf	(P.1)	DRIVEWAY WITH SYNLAWN JOINTS	1,07001
SYMBOL	DESCRIPTION	QTY		SAND BLAST FINISH LIGHT GREY COLOR	
	BLACK PVL	326 lf		8"THICKNESS	
(F.1)	CHAIN LINK FENCE		(P.2)	SEE ID DRAWINGS	1,017 sf
	TEMPERED GLASS HANDRAIL GUARDRAIL		\checkmark	FOR INTERIOR FINISH TO MATCH	
\checkmark	WITH EXTRUDED			POOL DECK.	
	ALUMINUM CAP. HEIGHT : 42"		^	NON-SLIP FINISH	
	FULL PANEL		⟨₽.3⟩	PRE-CAST CONCRETE PAVERS	205 sf
				LIGHT GREY	

CITY OF MIAMI BEACH

LANDSCAPE LEGEND

INFORMATION REQUIRED TO BE PERMANENTLY AF Zoning District Lot Area

OPEN SPACE

- A. Square feet of required Open Space as indicated or Lot Area = <u>13,125</u> s.f.x <u>*</u> % = <u>*</u>
- B. Square feet of parking lot open space required as i Number of parking spaces _____2 x 10 s.f. parkin
- C. Total square feet of landscaped open space require

LAWN AREA CALCULATION

- A. Square feet of landscaped open space required B. Maximum lawn area (sod) permitted= 1070 to 0.6 5 THEES REQUIRED FOR LOTS UP TO 6.0005 15 REQUIRED FOR EACH ADDITIONAL 1.0005 FO LOT AN REQUIRED / 14 THEE PROVIDED (2 GUMBO LIMPO, 3 GME SEAGRAPE, 3 JAPANESE PROVIDED (2 GUMBO LIMPO, 3 GME)
- A. Number of trees required per lot or net lot acre, le
- trees meeting minimum requirements= 14 trees x 0.3 net lot acres - numbe B. % Natives required: Number of trees provided x 30
- C. % Low maintenance / drought and salt tolerant red Number of trees provided x 50%=
- D. Street Trees (maximum average spacing of 20' o.c.) ___ linear feet along street divided by
- E. Street tree species allowed directly beneath power (maximum average spacing of 20' o.c.):
- ____ linear feet along street divided by

SHRUBS

- A. Number of shrubs required: Sum of lot and street
- B. % Native shrubs required: Number of shrubs prov

LARGE SHRUBS OR SMALL TREES

- A. Number of large shrubs or small trees required: Nu x 10%= B. % Native large shrubs or small trees required: Num
- small trees provided x 50%=

MITIGA

- WE REQUEST FOR A TOTAL MITIGATION TREES PROV (4 WHITE FR/
- WE ARE DEFIC TO THE TREE

Sec, 46-61. Tree replacement.

(1) Tree replacement chart. The tree replacement chart below, shall be used to determine the total number and size of trees that shall be planted as replacement trees for all trees permitted for removal. The replacement tree calculations are based on the total diameter in inches of all trees approved for removal. To determine the required replacement trees, calculate the total sum in inches of the diameters of all trees to be removed. This sum will result in one single number in inches that represents the combined total of the diameters of all trees to be removed. Diameter measurement shall be rounded up to the nearest inch.

TREE REPLACEMENT CHART

Total diameter of tree(s) to be removed (sum of inches at DBH)	Total number of replacement trees required (where each Replacement Tree is a minimum of 2" DBH x 6' spread in Canopy x 12' in height)		Total number of replacement trees required (where each Replacement Tree is a minimum of 4" DBH x 8' spread in Canopy x 16' in height)	OR	Contribution to Tree Trust Fund
2"—3"	1	or	<u>0</u>	or	<u>\$1,000.00</u>
4"6"	2	or	1	or	\$2,000.00
7"—12"	4	or	2	or	\$4,000.00
13"—18"	<u>6</u>	or	3	or	\$6,000.00
19"—24"	<u>8</u>	or	4	or	<u>\$8,000.00</u>
25"—30"	<u>10</u>	or	5	or	\$10,000.00
31"—36"	12	or	<u>6</u>	or	\$12,000.00
37"—42"	<u>14</u>	or	<u>7</u>	or	\$14,000.00
43"—48"	<u>16</u>	or	<u>8</u>	or	\$16,000.00
49"—60"	20	or	<u>10</u>	or	\$20,000.00

A300. The American National Standard for Tree Care Operations - Tree, Shrub, and Other Woody Plant Maintenance - Standard Practices. When more than ten trees are installed as replacement trees, a diversity of species shall be required as per the tree species diversity chart, below.

(a) Tree species diversity chart.

Required number of trees	Required min	Required minimum number of species				
01— 20<u>10</u>	2					
11-20	3					
21 <u>—50-30</u>	4					
31-40	5					
541 or greater	6					

(a) If the sum of the diameter of trees to be removed exceeds a total of 60 inches, the additional inches shall be added cumulatively from the top of the chart, down to the bottom of the chart, to calculate the number of trees required as replacement trees.

(b) Up to 30 percent of the two-inch DBH replacement tree requirement may be met by planting native species within private property, with a minimum height of ten feet (10") and a minimum DBH of one and one-half inches at time of planting.

(c) The removal of a palm shall be replaced with one canopy tree at 12 feet (12') overall height with a two-inch (2") DBH.

(1) Tree replacement chart. The tree replacement chart, below, shall be used to determine the total number of trees that must be planted for the replacement of those non-specimen trees permitted to be removed. A tree replacement plan shall be submitted to the environmen and sustainability department as part of the tree work permit application process that shall include the number of trees, number of species of trees and size of trees proposed for planting. The replacement trees are based on the total square footage of the non-specimer trees to be removed, and such measurement is accomplished through the use of aerial photography, on-site inspection and or review of a submitted tree survey. Canopy measurement shall be rounded up to the nearest foot. Refer to section 46-64, specime tree standards for tree replacement requirements for specimen trees and refer to section 46-63, heritage trees for replacement requirements for heritage trees.

(a) Tree replacement chart.

Replacement Tree Category	Canopy Credit in Square Feet
Category 1 Tree	300
Category 2 Tree	150
Category 3 Tree	400
Category 4 Palm	50


The environment and sustainability department shall maintain a list of approved species for each category of replacement trees. This list may be amended from time to time, as necessary. Replacement tree heights shall be determined by overall height measured from where the tree meets the ground to the top-most branch. All category 1 trees shall be a minimum of 12 feet in height at the time of planting with a two-inch to three-inch minimum caliper. All category 2 trees shall be a minimum of ten feet in height at the time of planting with a two-inch to three-inch minimum caliper. All category 3 trees shall be a minimum of eight feet in height at the time of planting with a two-inch to three-inch minimum caliper. All category 4 palms shall have a nimum six-foot clear trunk.

(2) Tree species and diversity standards. Tree(s) installed as replacement trees shall be tree(s) of native or non-native species and shall be planted according to ISA best management practices, and to ANSI A300 Standards as published in the most current edition of ANSI

11


				SIL		
FFIXED TO PLANS	0.2		2			ACE, SUITE 301 33133
13,125 sf Acr						3-4990
	REQUIRED/ ALLOWED	PROVIDED		FIRM LICEN	SE #	AA26001123
on site plan: "FRONT YARD: REQ REAR YARD: REQ. 7				WWW.51	RAN	G.DESIGN
and the second	0% 01 1,347 st = 1,363 st	-REAR TARD: 62% = 1,210 St	PRC	JECT LOCATIO	N:	-212
indicated on site plan:	20 sf	20 sf		10 W 23rd S AMI BEACH,		
ng space = red: A+B= 750 sf + 1.21	0 sf + 20 sf = 1.980 sf	1,043 sf + 1,210 sf + 20 sf = 2,273 sf	FOL			55140, 05A
		- <u> </u>	02	-3228-001-10	560	
	1,980 sf	2,273 sf	PRO	JECT CLIENT(S		VNER(S):
_%xs.f.	1,136 sf	382 sf	1000000			ENA BRADWAY
SF. 1 ADDITIONAL TREE REA. 14 TREES						
EEN BUTTONWOOD, 2 , 2 EXISTING TREES)				HITECT:		2.220
ess existing number of	EPOLY VARA 3 TREE	S REQ. / 2 TREES PROVIDED	u	AX WILSON STRA CENSE # AR00171	183	6250
er of existing trees=	REAR YARD: 3 TREES	REQ. / 2 TREES PROVIDED	M	00 SW 28TH TERI AMI, FL 33133		
0% = quired:	3	7	STR	UCTURAL ENGI	NEER	ING:
iquirea:	7	7		_		
.)	4	4		-		
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20'=	SEE ABOVE		LAN	DSCAPE ARCHI	TECT	
			[5	TRANG] LANDSCA	APE	
			F	LAUDERDALE, F		
trees required x 12= 1	8X 12 = 216 REQ	604		LENGINEER:		
ided x 50%=	216X .5 = 108	336	TE	D		
umber of required shrubs	216 X .1 = 21			DJECT NAM		DENCE
mber of large shrubs or	21 X .5 = 10.5	25	-		-010	SEITOE
noer of large sin abs of	OR 11 REQ.	25	PR	OFESSIONA	LS	EAL(S):
ATION CALCUL	ATIONS:				-	
THE REMOVAL OF #3a, 4, 5	, 9,10, 11, 13, 14, 1	5, 16, 17, 18, 20, 21, 21a, 22.				
OF 14 AMOUNT OF PALMS. TREE AT 2" MIN DBH / 12' O/	PALMS TO BE REI A. HT.	PLACED WITH 1: 1				
IDED :						
NGIPANI), (2 SIMPSON STO CIENT WITH 6 TREES FOR A			\vdash			
TRUST FUND.	TOTAL OF 6,000.0	US CONTRIBUTION				
				12/9/19	F	INAL SUBMITTAL
			No.	DATE		DESCRIPTION
			5	SHEET ISSU	E/R	EVISION LOG
			The prop only gove repr Proj	erty of Strang De for the parties in ernmental positio	ormati esign, identif on(s). ' vritten igned	on contained within is LLC. and is intended fied above or of This plan may not be permission from the to this project.
				ject ID:		Drawn By:
				ADWAY RE	S.	SSM
				t Date: 5/2019		Scale: AS INDICATED
				et Title:		
					<u> </u>	
				LAND	5	CAPE
			R	EQUIF	٢E	MENTS
			She	et No:		
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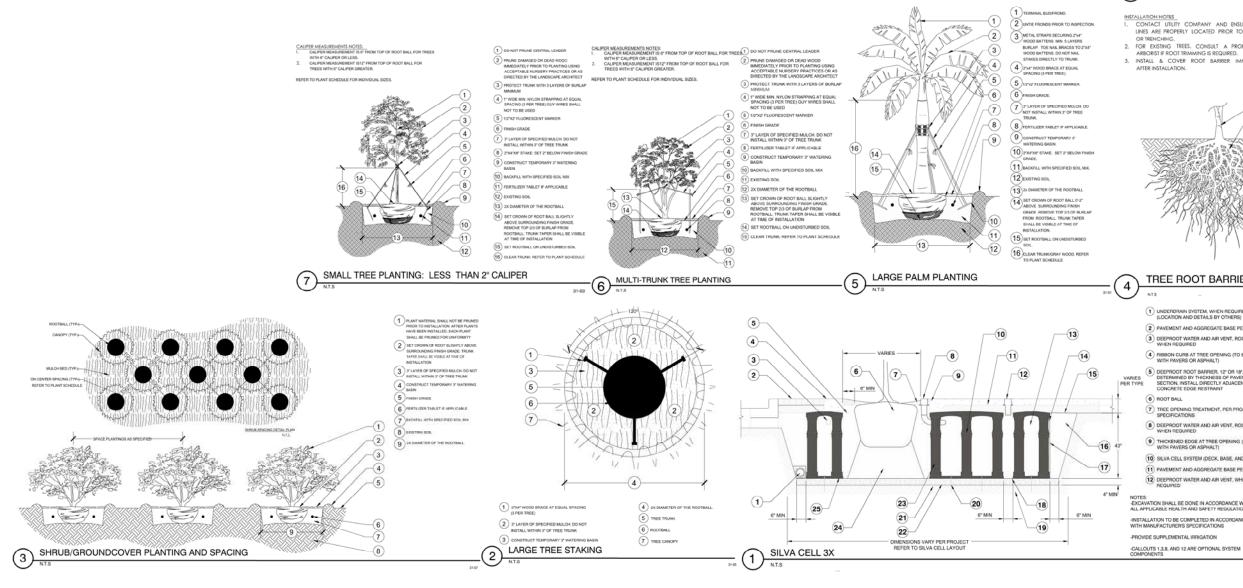
[CTDANC]

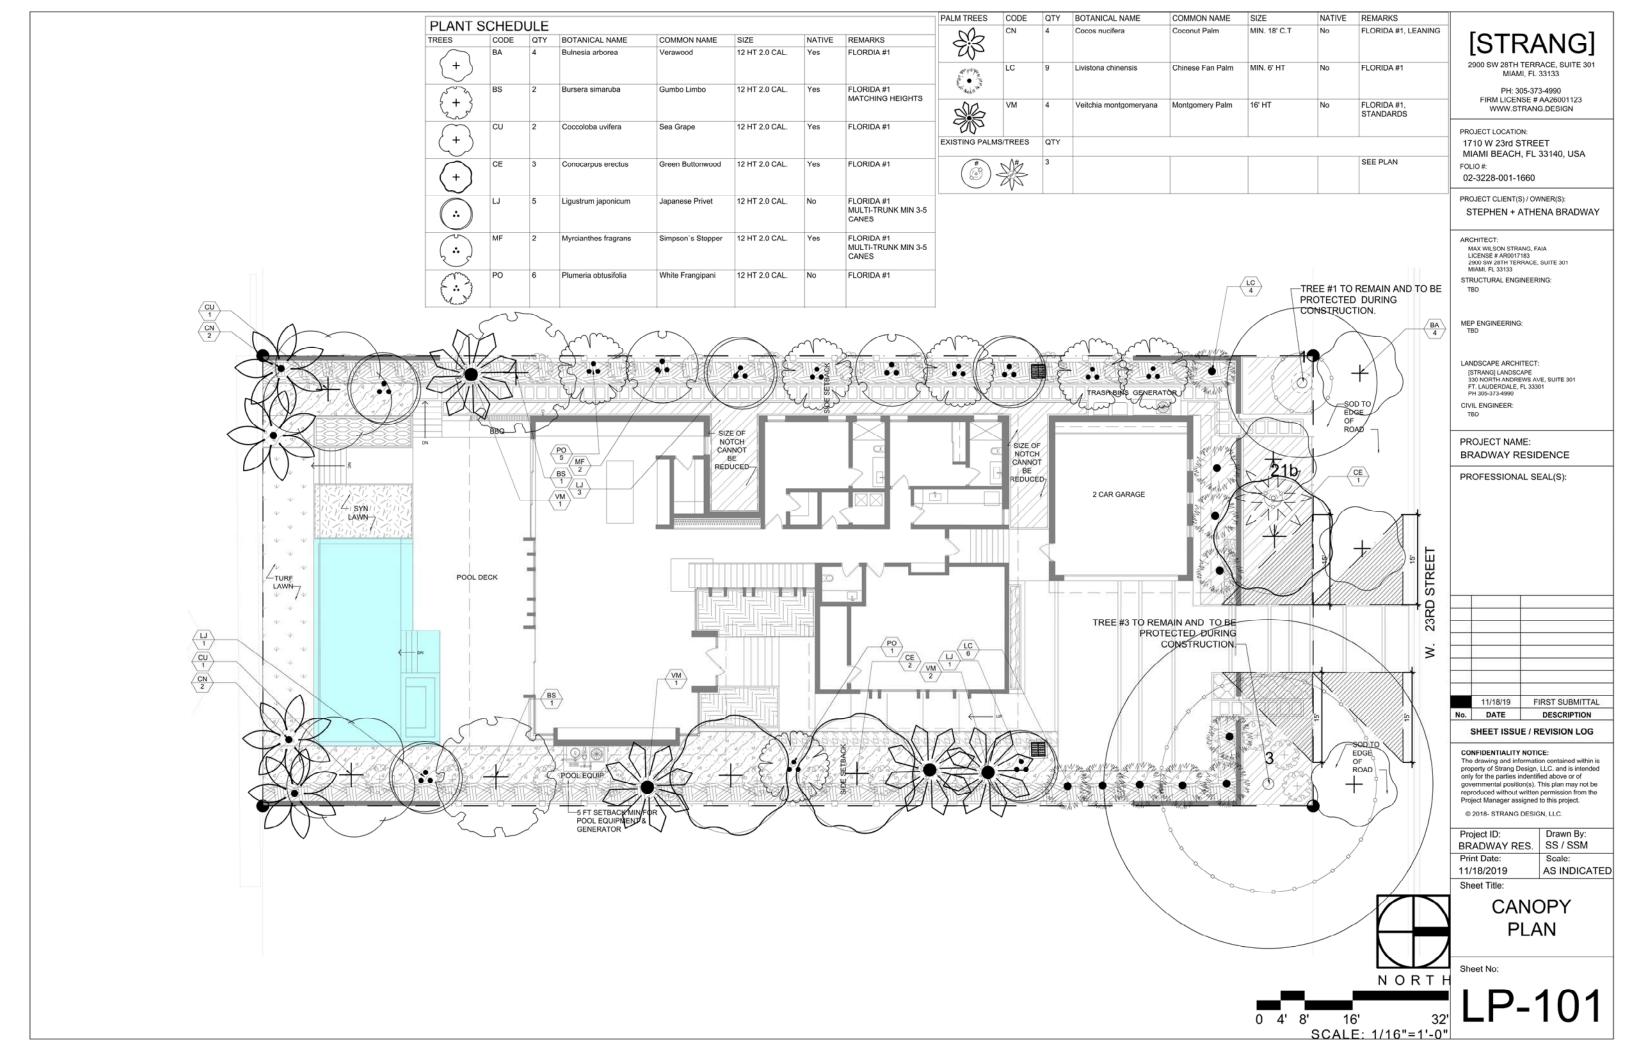

SHRUBS	CODE	QTY	BOTANICAL NAME	COMMON NAME	SIZE	NATIVE	REMARKS
(6.) + 5	THR	25	Thrinax radiata	Florida Thatch Palm	15 gal.	Yes	FLORIDA #1; SEE PLA
SHRUB AREAS	CODE	QTY	BOTANICAL NAME	COMMON NAME	SIZE	NATIVE	REMARKS
ৰাৰাৰাৰাৰ বাৰাৰাৰাৰাৰ	CI	127	Chrysobalanus icaco	Coco Plum	7 gal	Yes	FLORIDA#1: 36" O.C
AU ZOU ZOU ZOU ZOU ZOU ZO	MD	12	Monstera deliciosa	Split-Leaf Philodendron	3 gal.	No	FLORIDA #1 ; 24" O.C
	NE	184	Nephrolepis exaltata	Boston Fern	3 gal.	Yes	FLORIDA #1; 24" O.C
	SS	27	Sanseveria sayuri	Snake Plant	3 gal.	No	FLORIDA #1; 18" O.C
	sw	229	Spathiphyllum sp.	Peace Lily	3 gal.	No	FLORIDA #1; 24" O.C
GROUND COVERS	CODE	QTY	BOTANICAL NAME	COMMON NAME	SIZE	NATIVE	REMARKS
	AN	256	Annuals		4" Pot	No	FLORIDA #1; 6" O.C

	СМ	29	Carissa macrocarpa	Natal Plum	3 gal.
	MR	326	Phymatosorus scolopendria	Wart Fern	3 gal.
	SA	143 sf	Synlawn	Synthertic Lawn	
* * * * * * * * * * * * * *	ZE	382 sf	Zoysia japonica 'Empire'	Zoysia Empire	sod



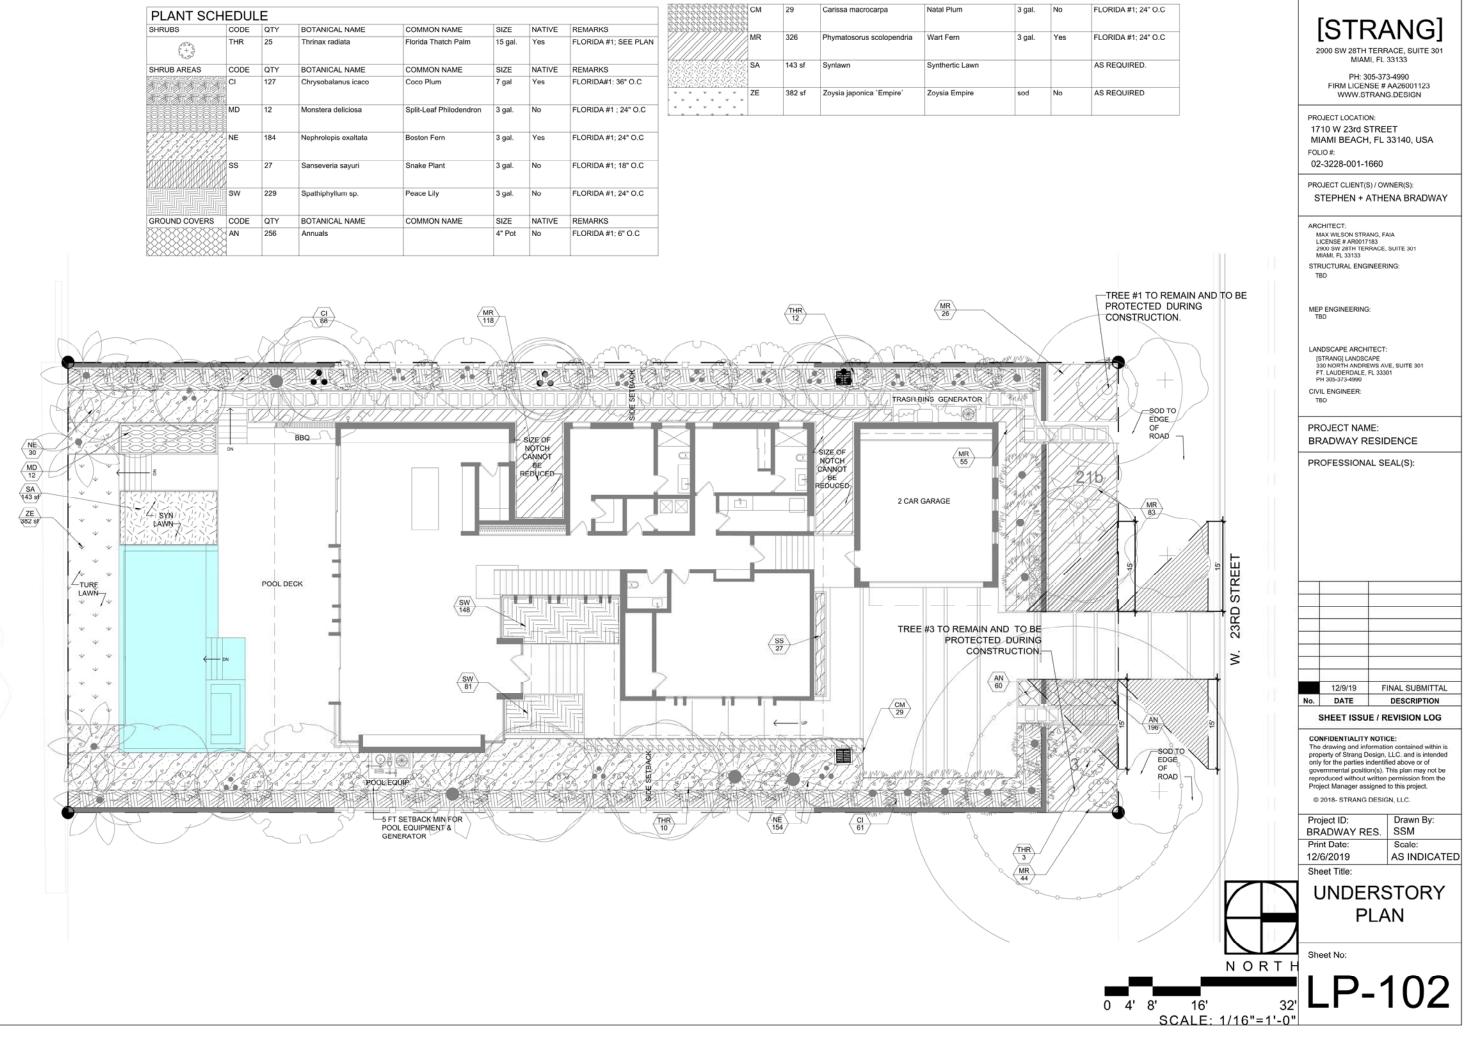

[STRANG] 1 DO NOT PRUNE CENTRAL LEADER CALIFER MEASUREMENTS INOTES. 1. CALIFER MEASUREMENT IS 6⁺ FROM TOP OF ROOT BALL FOR TREES WITH 6⁺ CALIFER REASUREMENT IS 12⁺ FROM TOP OF ROOT BALL FOR TREES WITH 6⁺ CALIFER GREATER. 2900 SW 28TH TERRACE, SUITE 301 2 PRUNE DAMAGED OR DEAD WOOD MIAMI, FL 33133 IMMEDIATELY PROR TO PLINTING USING ACCEPTABLE NURSERY PRACTICES OR AS DIRECTED BY THE LANDSCAPE ARCHITECT PH: 305-373-4990 REFER TO PLANT SCHEDULE FOR INDI 3 PROTECT TRUNK WITH 3 LAYERS OF BURLAF States and FIRM LICENSE # AA26001123 MINIMUM WWW.STRANG.DESIGN 4 1* WIDE MIN. NYLON STRAPPING AT EQUA SPACING (3 PER TREE) GUY WIRES SHALL AP. NOT TO BE USED PROJECT LOCATION: 5 FLUORESCENT MARKING FLAG 6 FINISH GRADE 1710 W 23rd STREET MIAMI BEACH, FL 33140, USA 3" LAYER OF SPECIFIED MULCH: DO NOT INSTALL WITHIN 3" OF TREE TRUNK FOLIO #: 8 FERTILIZER TABLET IF APPLICABLE 02-3228-001-1660 9 CONSTRUCT TEMP 6 (10)2"X4"X8" STAKE: SET 2" BELOW FINISH GRAD PROJECT CLIENT(S) / OWNER(S): (14)-11) SPECIFIED SOIL MIX STEPHEN + ATHENA BRADWAY (8) (12) EXISTING SOIL 17 (15) -(9) 13 2X DIAMETER OF THE ROOTBALL ARCHITECT: (16) 14 SET CROWN OF ROOT BALL SLIGHTLY ABOVE SURROUNDING FINISH GRADE. REIMOVE TOP 23 OF BURLAP FROM ROOTBALL TRUKE TAPER SHALL BE VISIBLE AT TIME OF INSTALLATION MAX WILSON STRANG, FAIA LICENSE # AR0017183 2900 SW 28TH TERRACE, SUITE 301 MIAMI, FL 33133 1 to -10 15 SET ROOTBALL ON UNDISTURBED SOIL STRUCTURAL ENGINEERING 16 REMOVE TOP 23 OF BURLAPIWIRE BASKET TBD 11) -12 17 CLEAR TRUNK: REFER TO PLANT SCHEDULE LARGE TREE PLANTING: 2" CALIPER AND GREATER MEP ENGINEERING: TBD INSTALLATION NOTES CONTACT UTILITY COMPANY AND ENSURE UTILITY LINES ARE PROPERLY LOCATED PRIOR TO DIGGING OR TRENCHING, 2. FOR EXISTING TREES, CONSULT A PROFESSIONAL ARBORDST R FOOT TIMMING IS REQUIRED. 3. INSTALL & COVER ROOT BARRER IMMEDIATELY ARTER INSTALL ALCOVER. 1 PROPOSED OR EXISTING TREE LANDSCAPE ARCHITECT: 2 FUTURE OR EXISTING ROOT STRUCTURI [STRANG] LANDSCAPE 330 NORTH ANDREWS AVE, SUITE 301 FT. LAUDERDALE, FL 33301 PH 305-373-4990 3 SECURE FABRIC USING ADHESIVE (4) EXCAVATE TRENCHES A MINIMUM OF 4" WIDI TRENCHES MUST BE A MINIMUM LENGT MATURE PLANT CANOPY PLUS 10 FEET,

- 5 PROPOSED CONCRETE OR ASPHALT SURFACE 6 RIGID ROOT BARRIER, BY DEEPROOT OR APPROVE EQUAL INSTALL PER MANUFACTURER'S RECOMMENDATIONS. EXTEND 10' ON EITHER SIDE OF THE ADJACENT TREEL UNLESS OTHERWISE NOTED ON PLAN. -(2)
 - 4 23) **X**4 % 5 -(6)

CENTERED ON THE ROOT SOURCE AND ADJACENT TO PROTECTION AREA

TREE ROOT BARRIER - ADJACENT HARDSCAPE

UNDERDRAIN SYSTEM, WHEN REQUIRED (LOCATION AND DETAILS BY OTHERS)

- 2 PAVEMENT AND AGGREGATE BASE PER PROJECT 3 DEEPROOT WATER AND AIR VENT, ROOTBALL, WHEN REQUIRED
- RIBBON CURB AT TREE OPENING (TO BE USED WITH PAVERS OR ASPHALT)
- DEEPROOT ROOT BARRIER, 12' OR 18', DEPTH DETERMINED BY THICKNESS OF PAVEMENT SECTION, INSTALL DIRECTLY ADJACENT TO CONCRETE EDGE RESTRAINT
- TREE OPENING TREATMENT, PER PROJECT SPECIFICATIONS
- B DEEPROOT WATER AND AIR VENT, ROOTBALL WHEN REQUIRED
- THICKENED EDGE AT TREE OPENING (TO BE USED WITH PAVERS OR ASPHALT)
- (10) SILVA CELL SYSTEM (DECK, BASE, AND POSTS) 11 PAVEMENT AND AGGREGATE BASE PER PROJECT
- 12 DEEPROOT WATER AND AIR VENT, WHEN REQUIRED
- EXCAVATION SHALL BE DONE IN ACCORDANCE WITH ALL APPLICABLE HEALTH AND SAFETY REGULATIONS -INSTALLATION TO BE COMPLETED IN ACCORDANCE WITH MANUFACTURERS SPECIFICATIONS
- -PROVIDE SUPPLEMENTAL IRRIGATION

- (13) PLANTING SOIL, PER PROJECT SPECIFICATIONS, PLACED IN LIFTS AND WALK-IN COMPACTED TO 75-69% PROCTOR
- (14) CABLE TIE, ATTACHING GEOGRID TO SILVA CELL AT BASE OF UPPER LEG FLARE, AS NEEDED (15) GEOTEXTILE FABRIC TO EDGE OF EXCAVATION
- 16 COMPACTED BACKFILL, PER PROJECT SPECIFICATIONS
- SYSTEM, WITH 6" TOE (OUTWARD FROM BASE) AND 12" EXCESS (OVER TOP OF DECK)
- 20 ANCHORING SPIKES, CONTACT DEEPROOT FOR ALTERNATIVE
- (18) 1" TO 6" SPACING BETWEEN SILVA CELLS AT BASE (19) SUBGRADE, COMPACTED
- 21) GEOTEXTILE FABRIC, PLACED ABOVE SUBGRADE
- 2 4" MIN AGGREGATE SUB BASE, COMPACTED TO 95% PROCTOR
- 23 SILVA CELL SYSTEM (DECK, BASE, AND POSTS).
- 24 PLANTING SOIL BELOW ROOT BALL, COMPACTED WELL TO PREVENT SETTLING
- 25 SILVA CELL BASE SLOPE, 10% MAX

MUM PAVEMENT PROFILE OPTIONS TO MEET H-20 LC PAVEMENT +AGGREGATE BASE COURSE

4" CONCRETE..... 3" PAVER 4" ASPHALT 2.6" PAVER +4" AGGREGATE +12" AGGREGATE +12" AGGREGATE +5" CONCRETE

CIVIL ENGINEER: TBD

PROJECT NAME: BRADWAY RESIDENCE

PROFESSIONAL SEAL(S):

11/18/19 FIRST SUBMITTAL DATE DESCRIPTION No. SHEET ISSUE / REVISION LOG

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Print Date:	Scale:
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Sheet No:

