
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7 09-09-2019 / VARIANCE REQUEST

A-1.3
CURRENT
APPROVED
FINAL SUBMISSION: 09/09/19
HEARING: 11/05/19

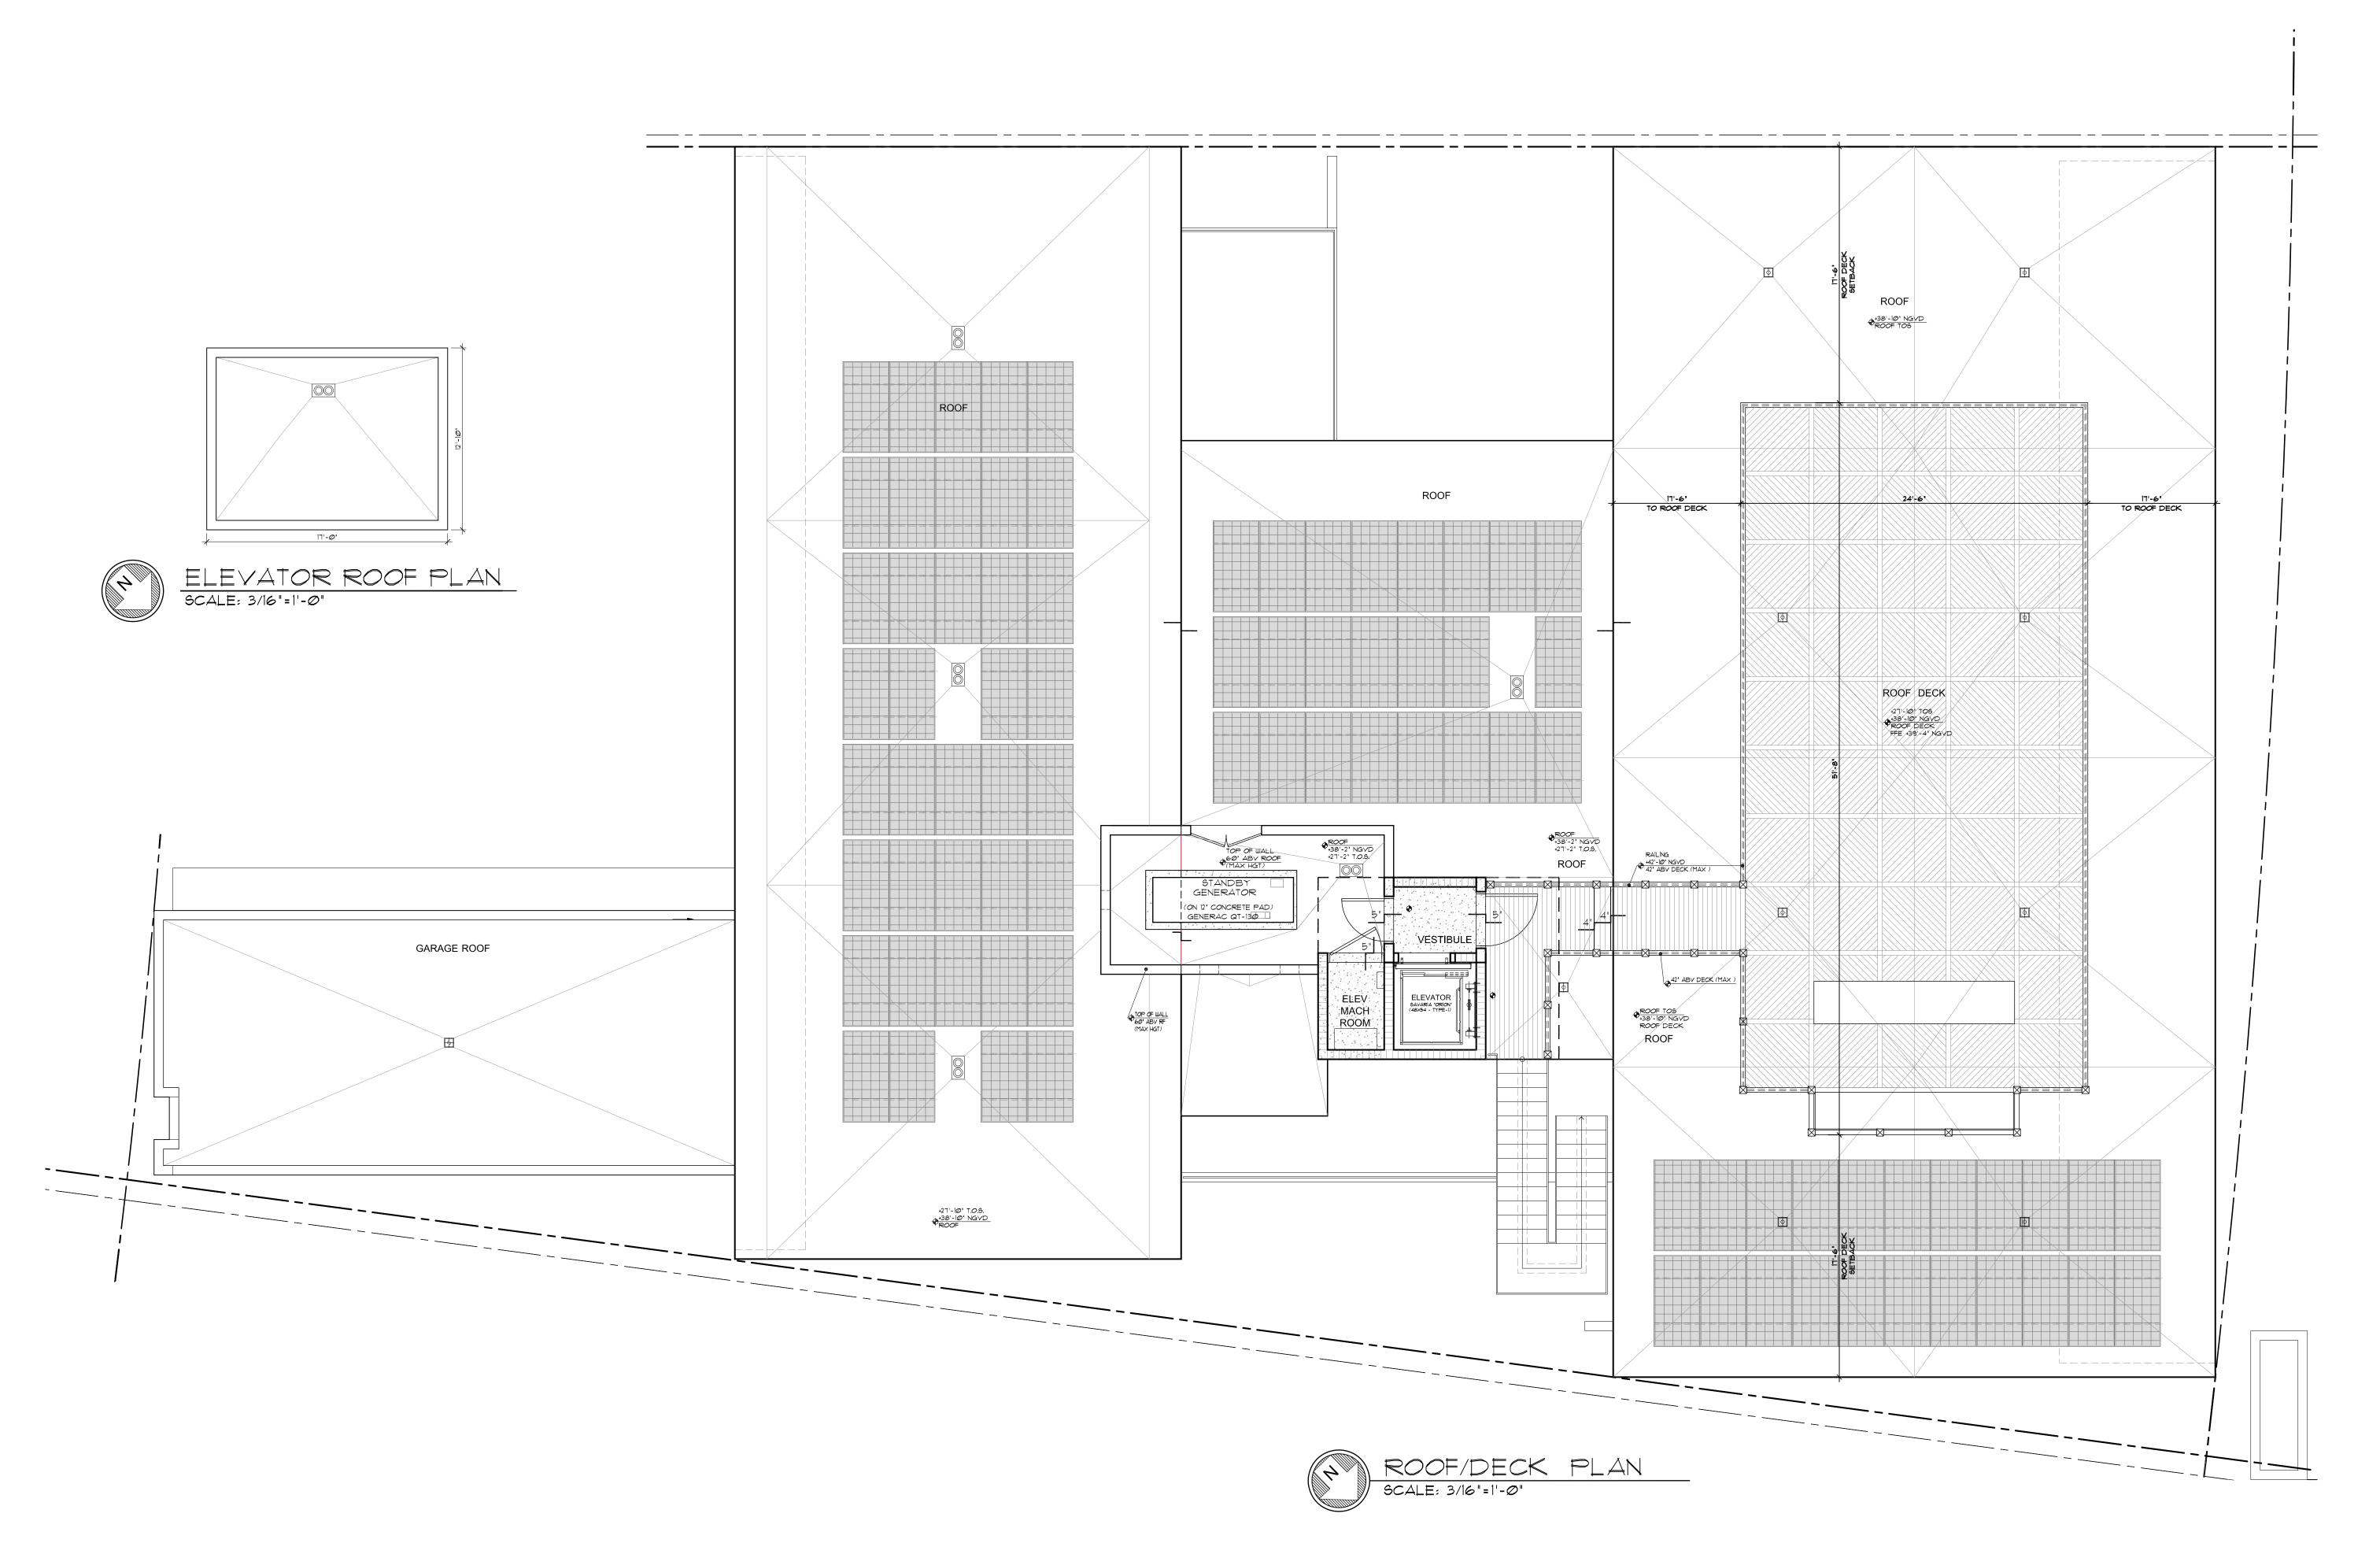

comm no. 1626

date: 12/23/2016

revised:
03-28-2017 / B.D. COMMENTS
05-10-2017 / B.D. COMMENTS
3 06-01-2017 / B.D. COMMENTS
4 04-20-2018 / DFE UPDATE +
5 05-01-2018 / BD COMMENTS
6 06-20-2019 / ROOF UPDATE
7 09-09-2019 / VARIANCE REQUEST

sheet no.



2 05-10-2017 / B.D. COMMENTS 4 04-20-2018 / DFE UPDATE + 5 05-01-2018 / BD COMMENTS


05-16-2018 / BD COMMENTS


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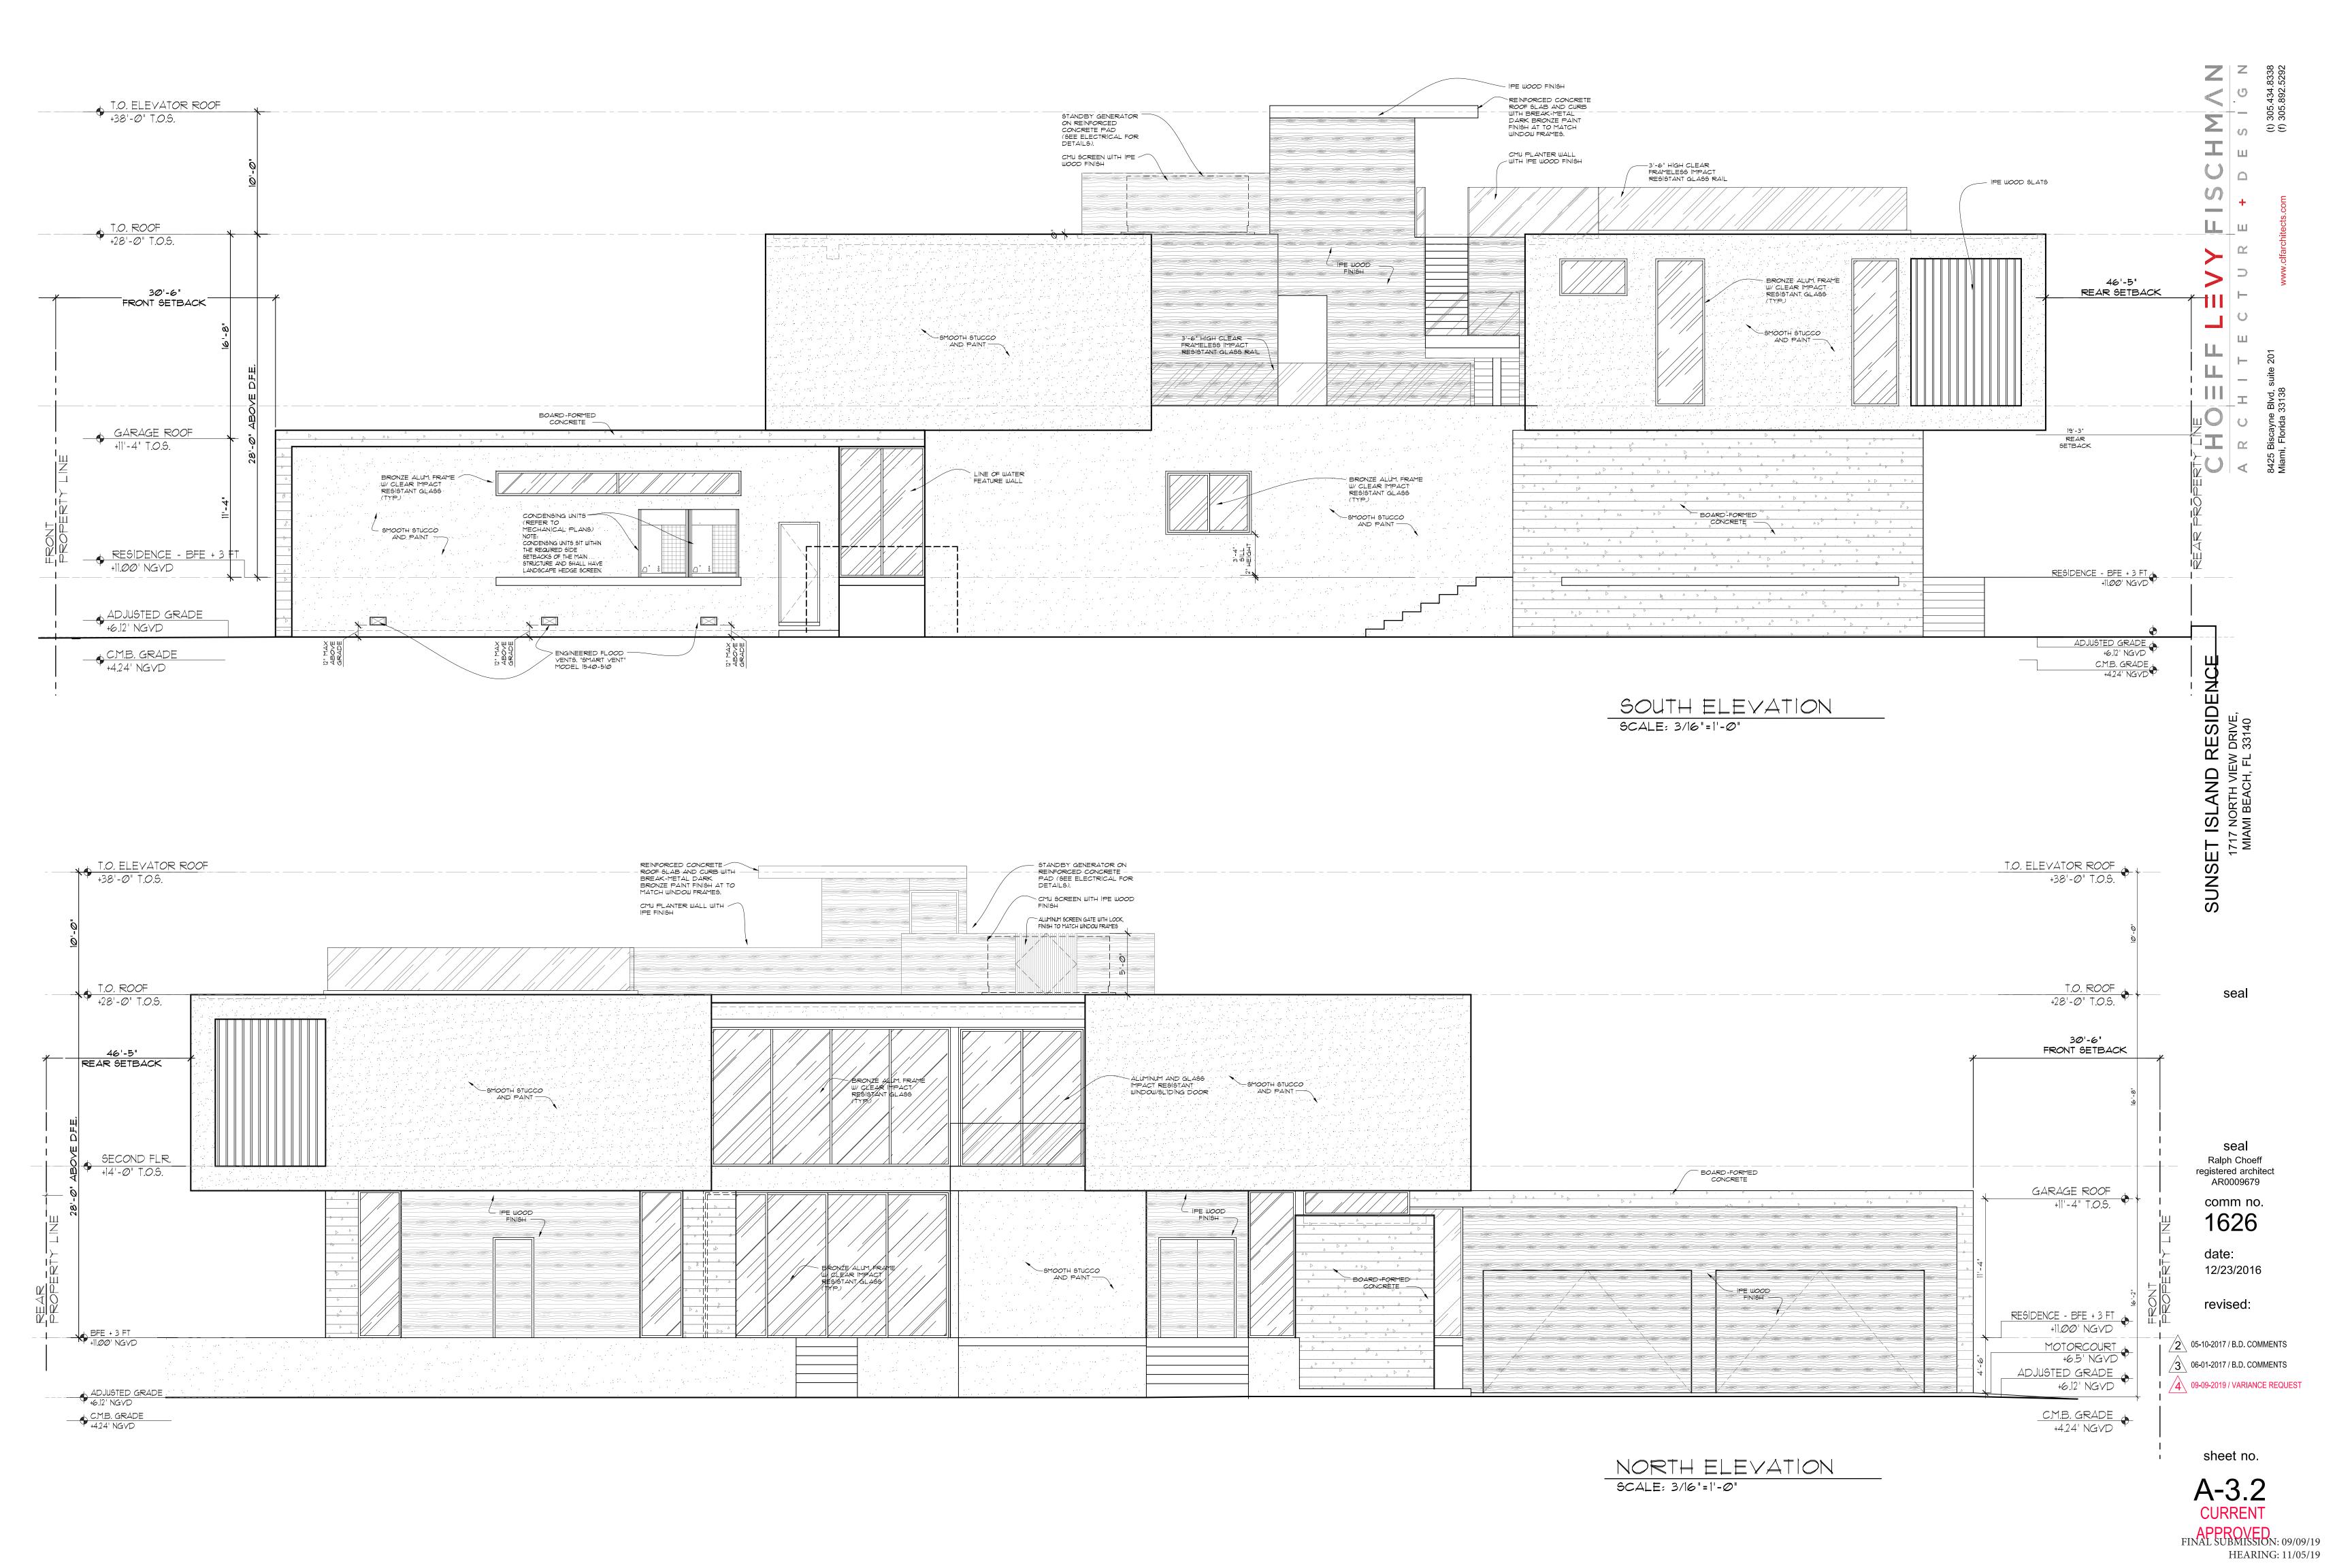
09-09-2019 / VARIANCE REQUEST

sheet no.

A-3.1
CURRENT
APPROVED
FINAL SUBMISSION: 09/09/19
HEARING: 11/05/19



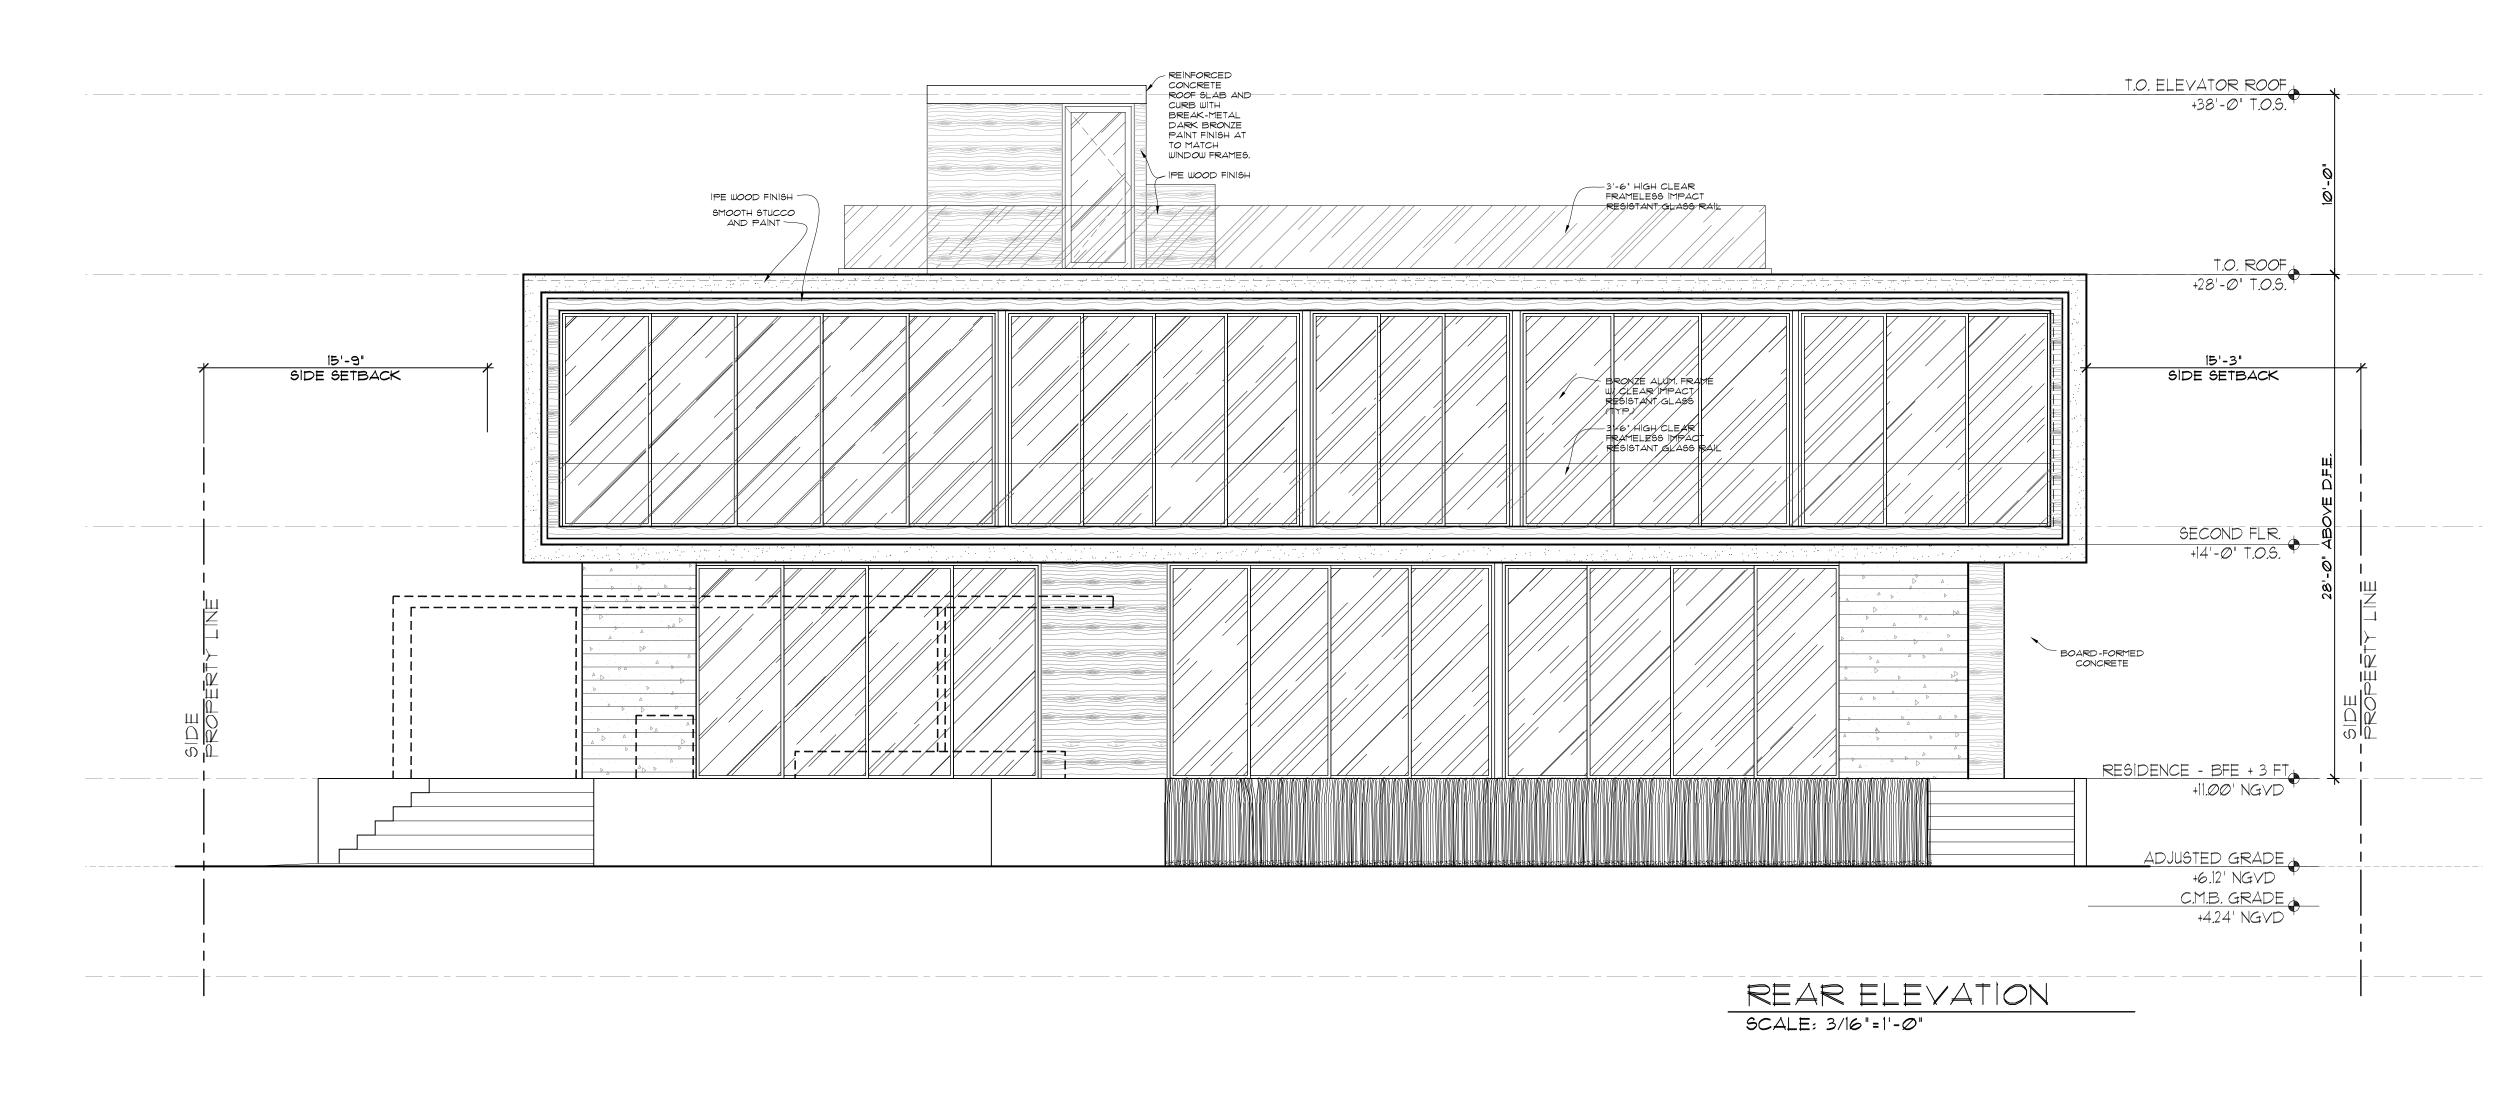

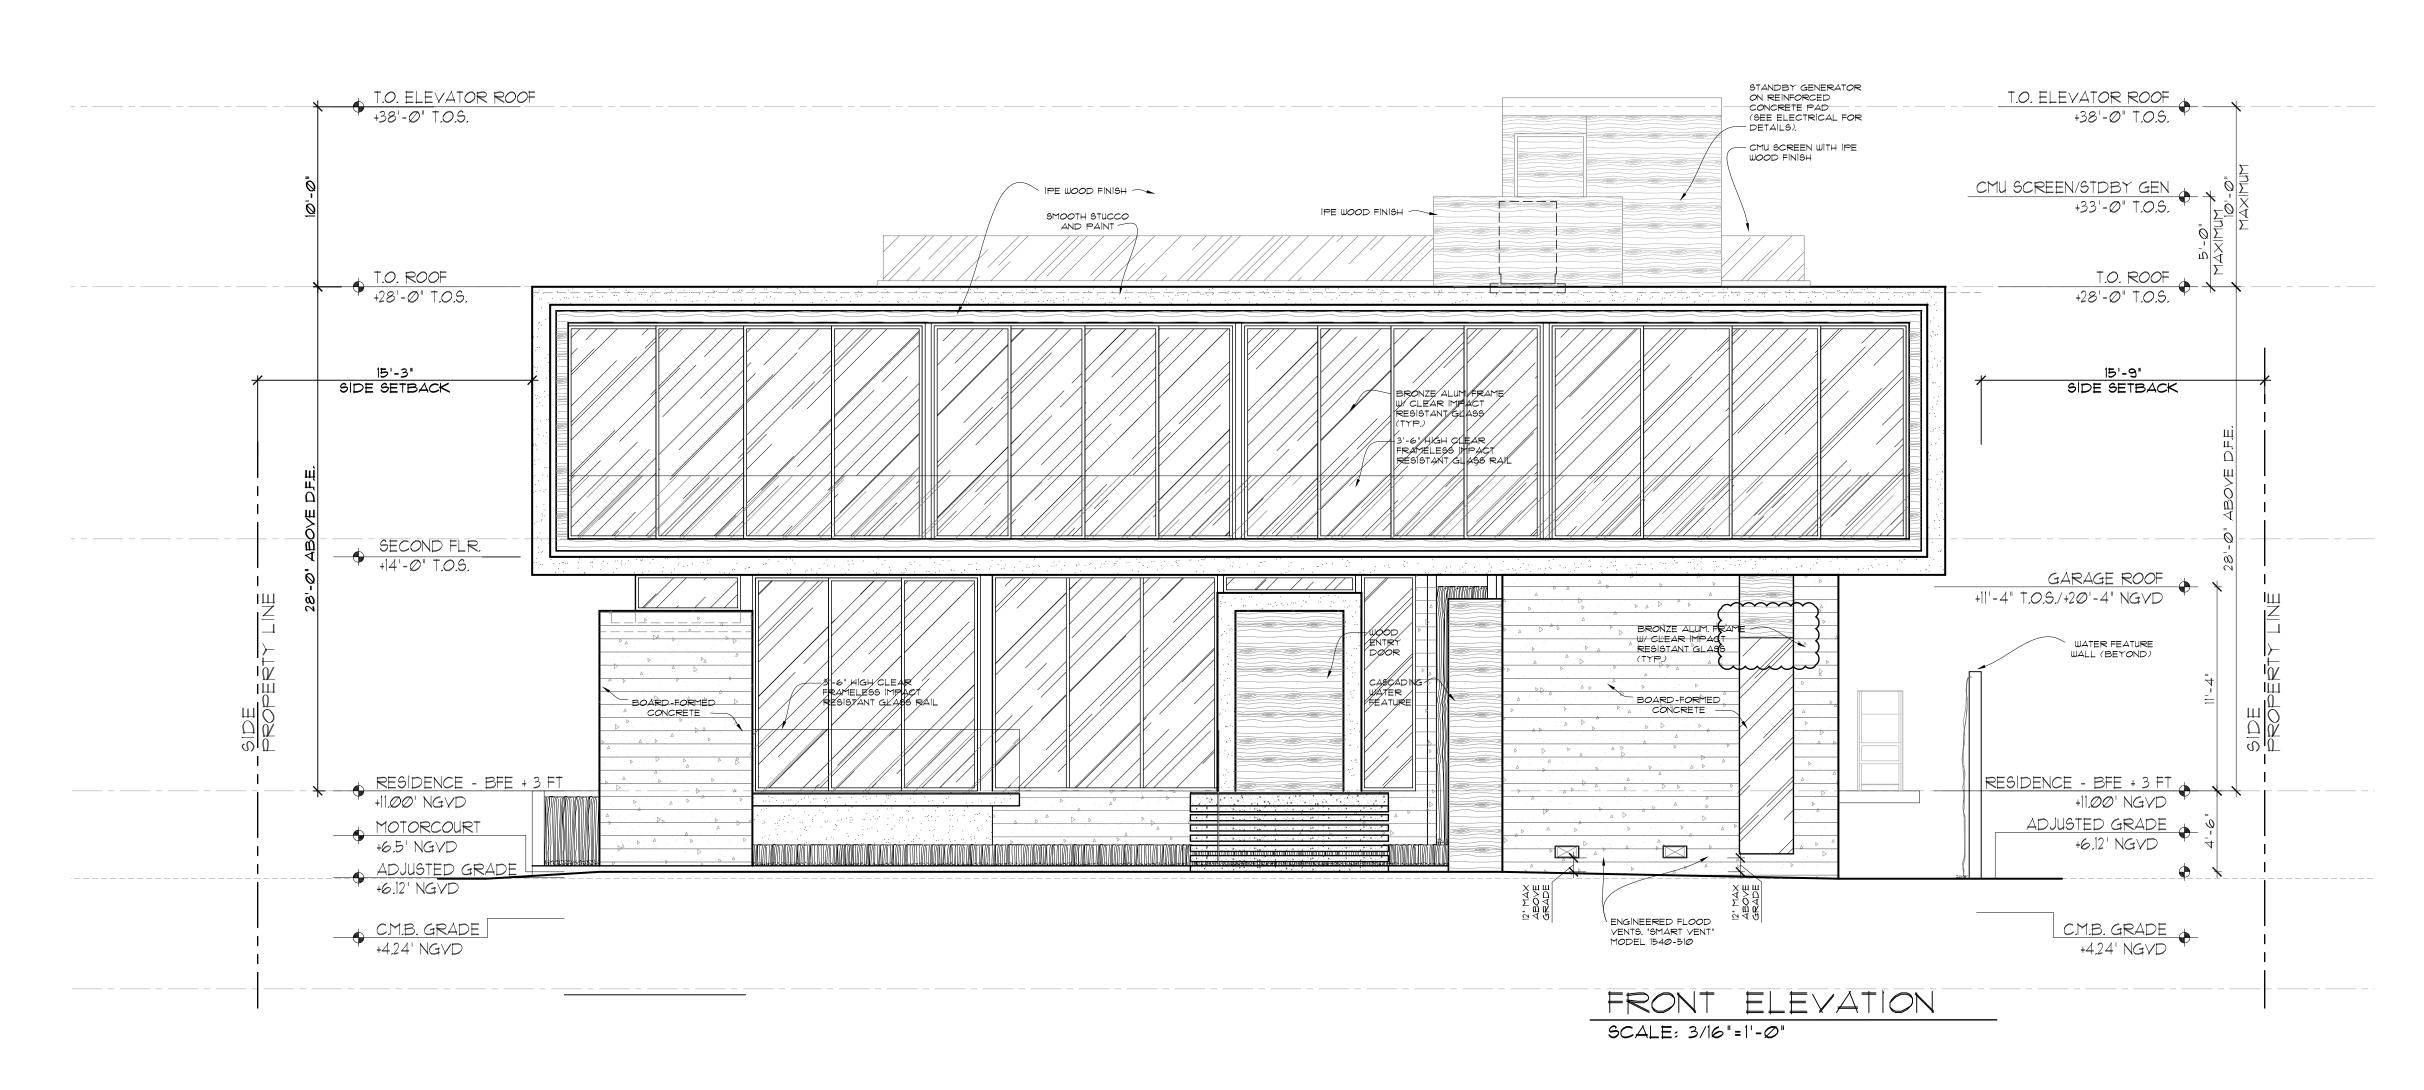


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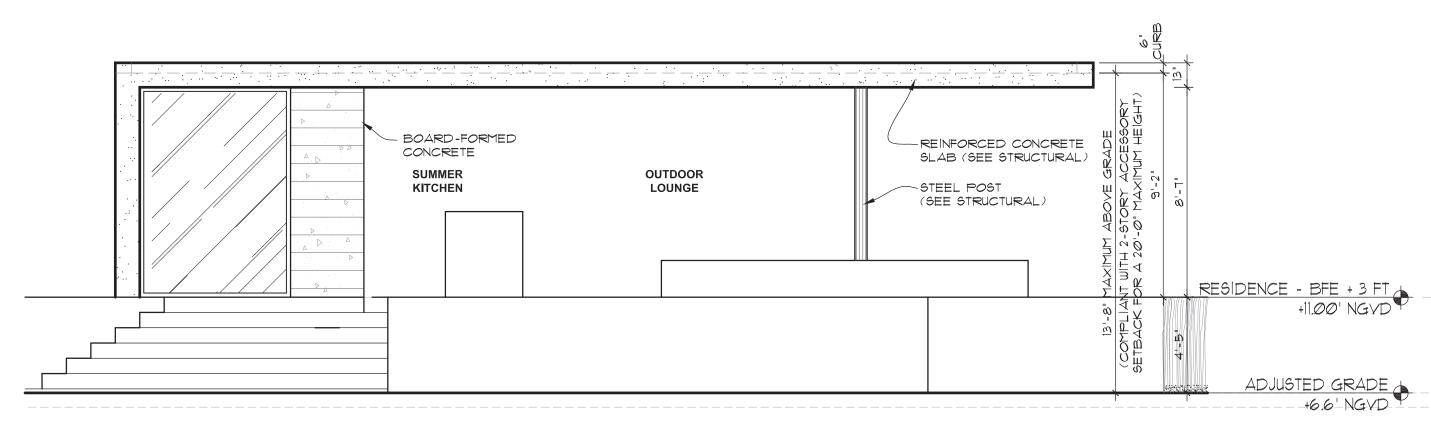


sheet no.

A-3.3







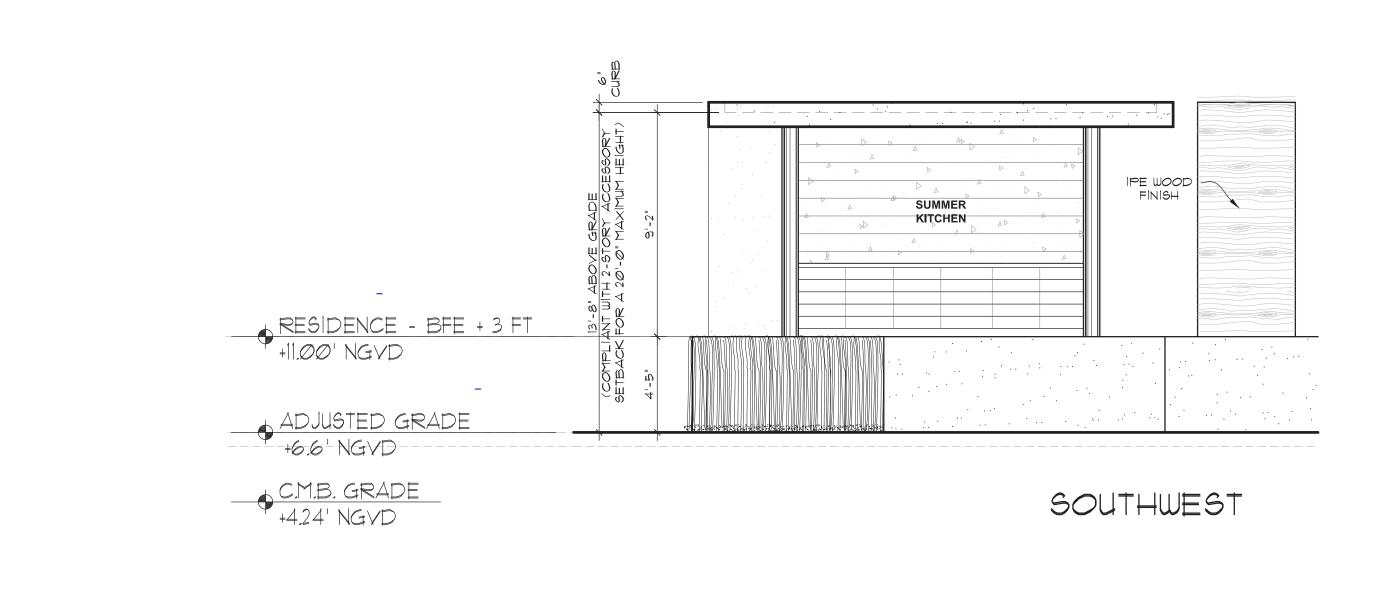


NORTHWEST _____CMB. GRADE +4.24' NGYD

SCALE: 3/16"=1'-0"

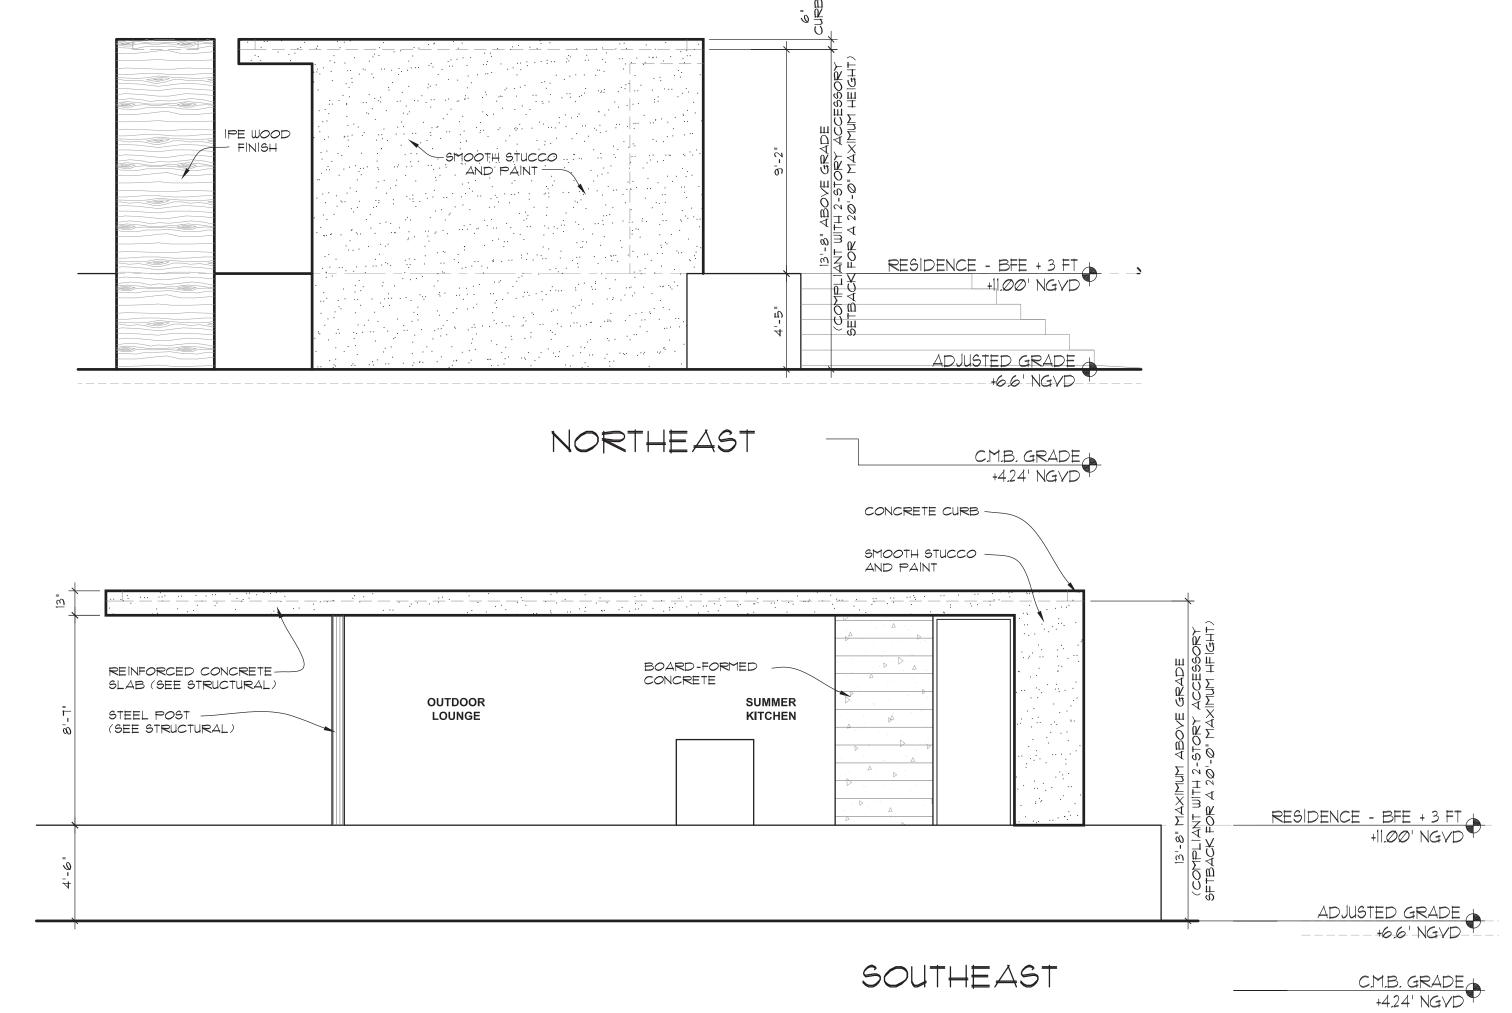

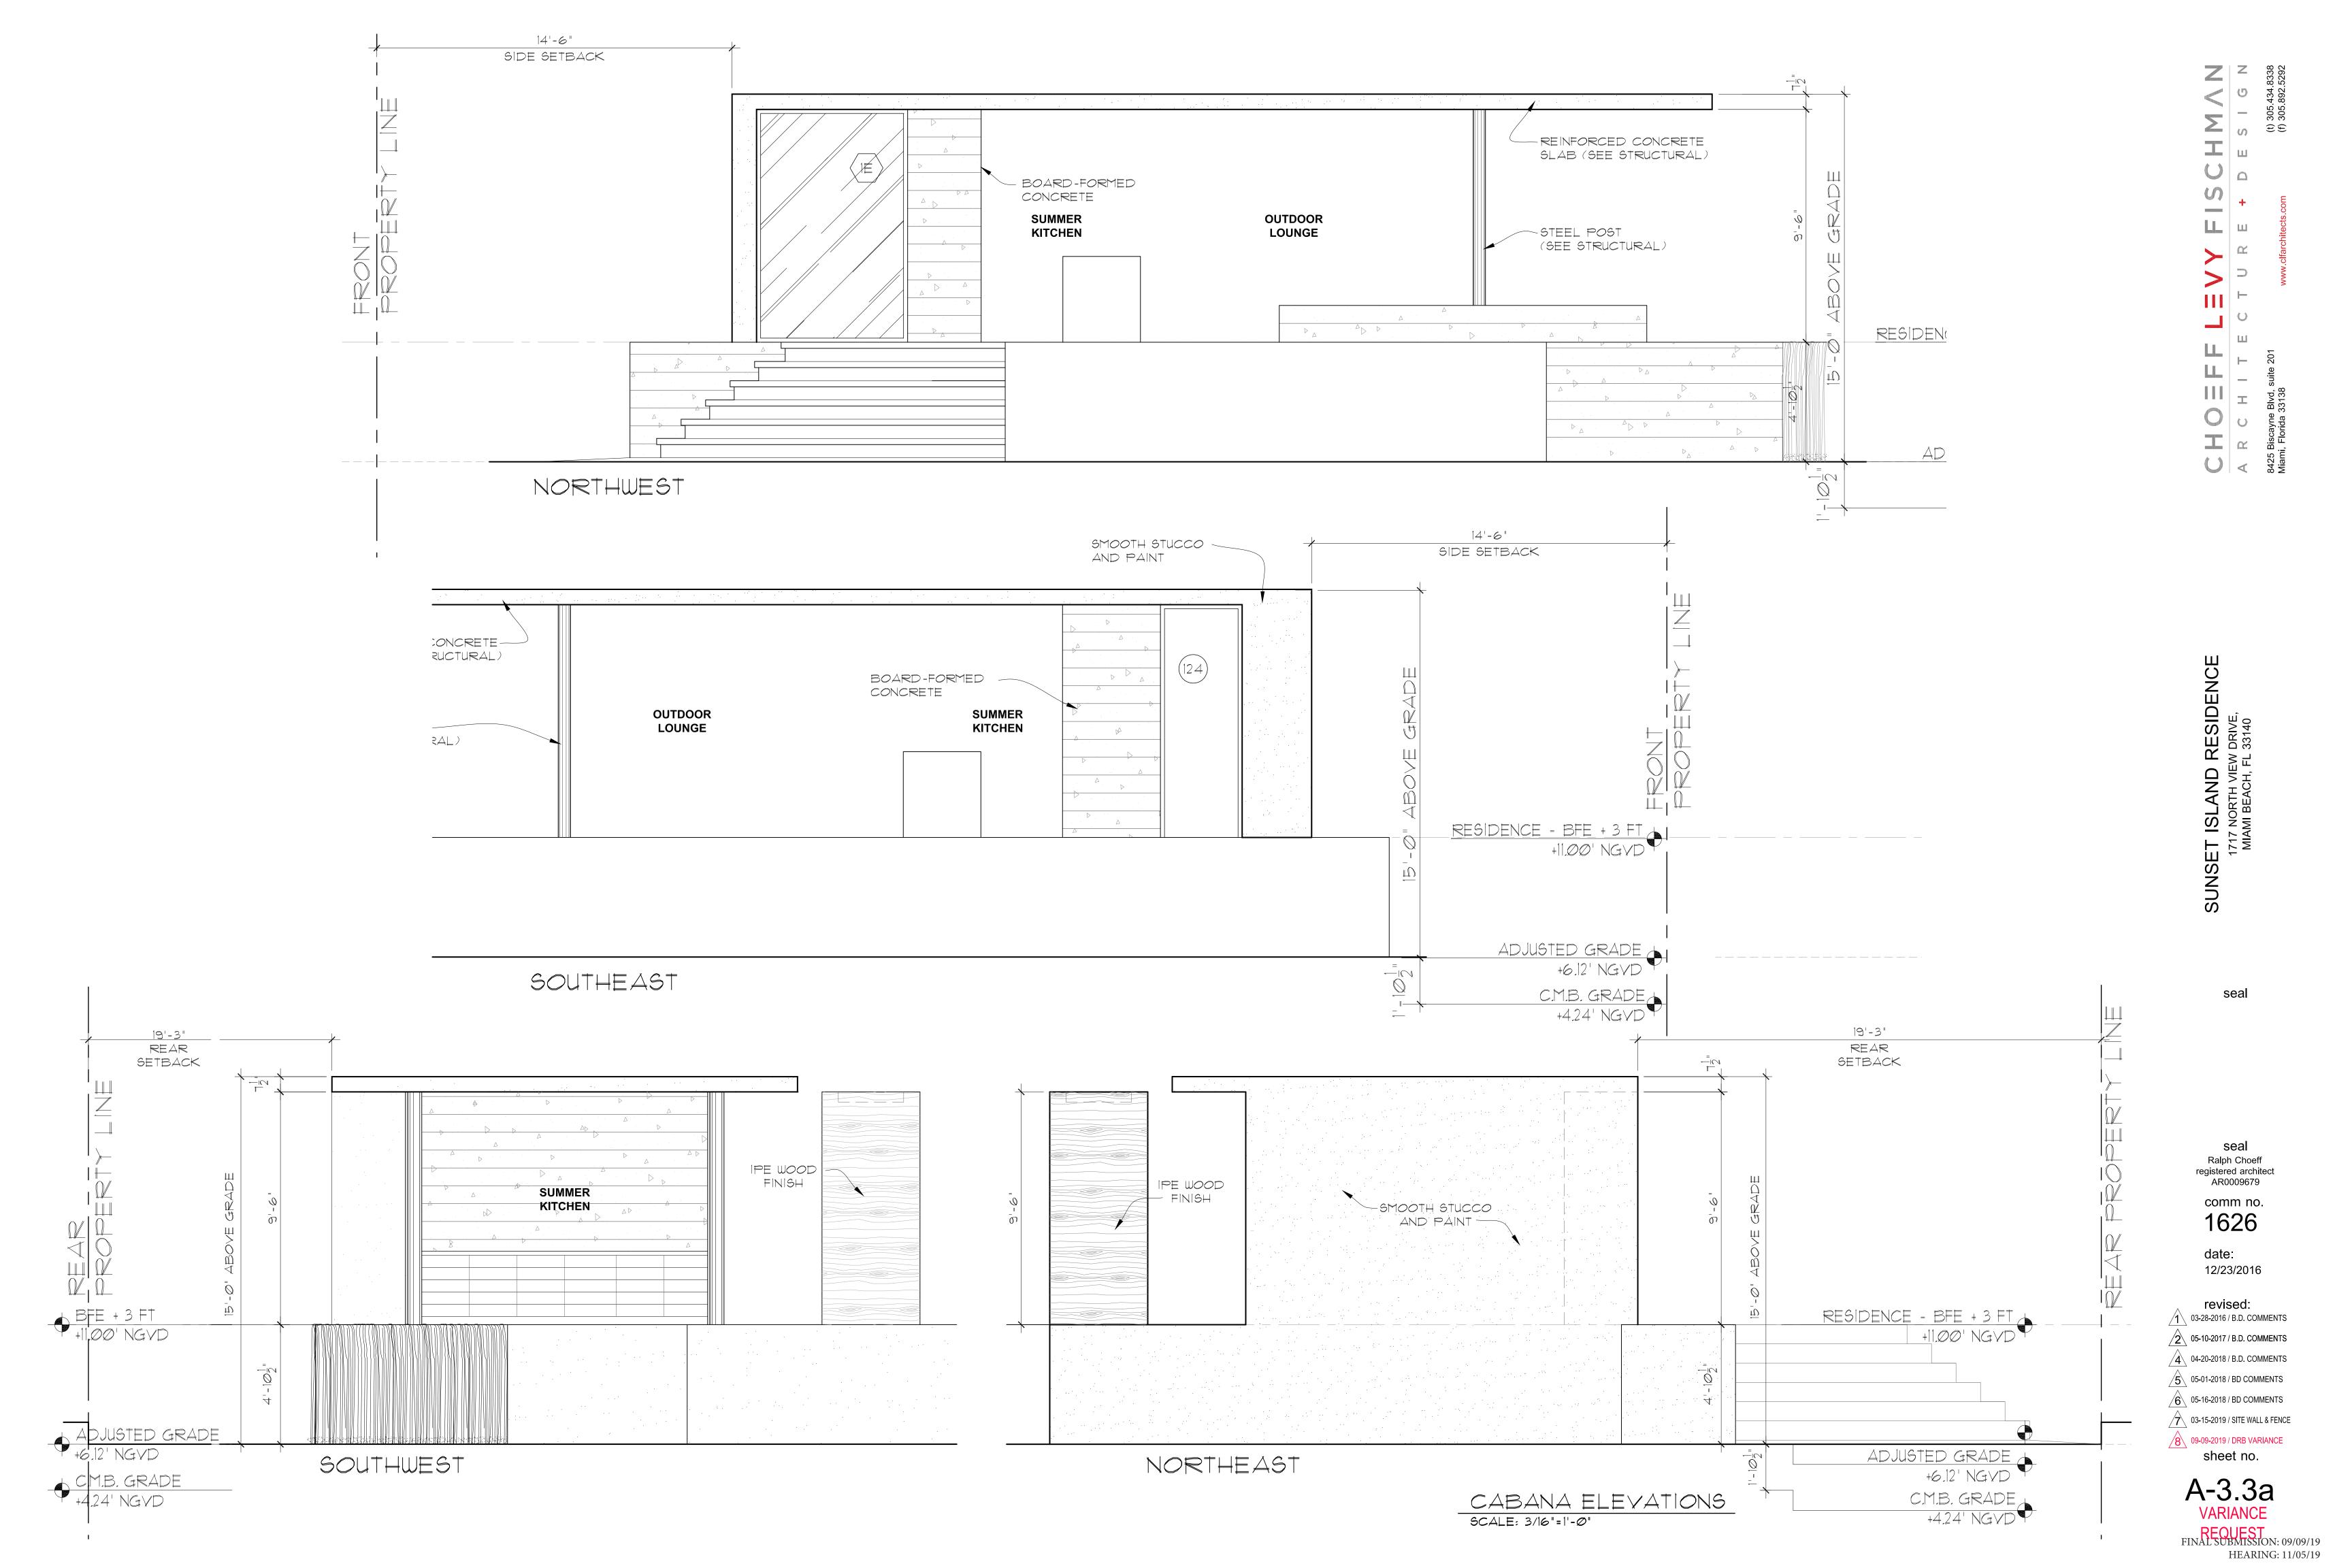

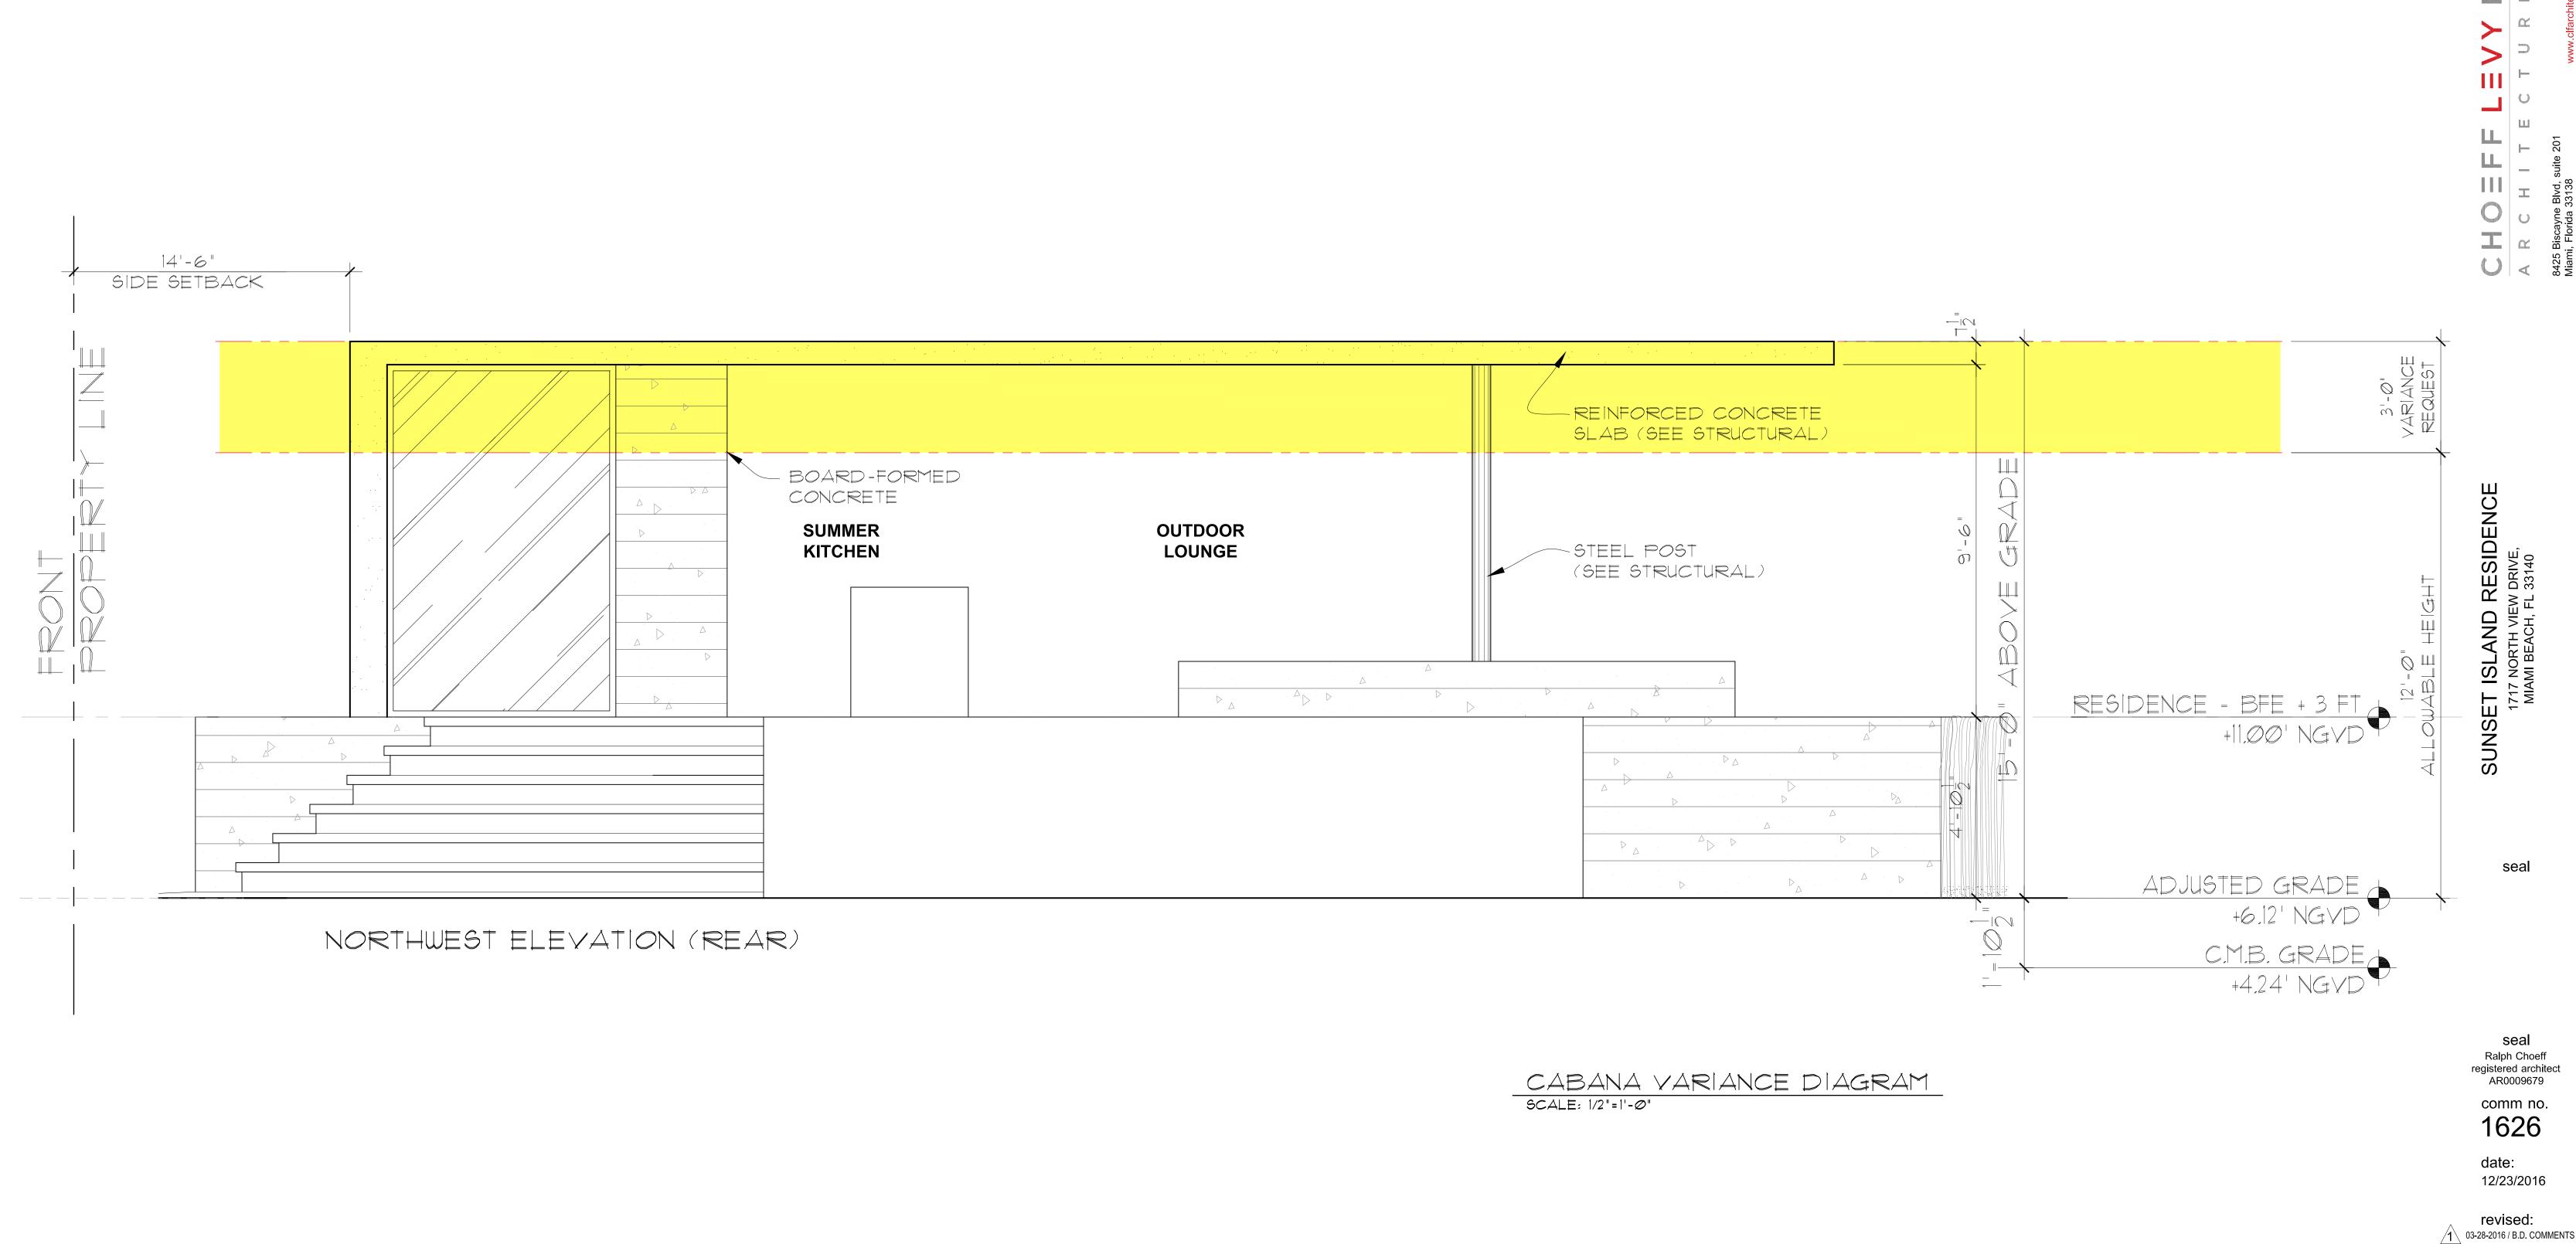

revised:
1 03-28-2016 / B.D. COMMENTS 2 05-10-2017 / B.D. COMMENTS 4 04-20-2018 / B.D. COMMENTS 5 05-01-2018 / BD COMMENTS 6 05-16-2018 / BD COMMENTS 7 03-15-2019 / SITE WALL & FENCE 8 09-09-2019 / DRB VARIANCE sheet no.

A-3.3b

VARIANCE

REQUEST


FINAL SUBMISSION: 09/09/19 HEARING: 11/05/19

5 05-01-2018 / BD COMMENTS 6 05-01-2018 / BD COMMENTS

sheet no.

A-4.3 CURRENT FINAL SUBMISSION: 09/09/19

HEARING: 11/05/19

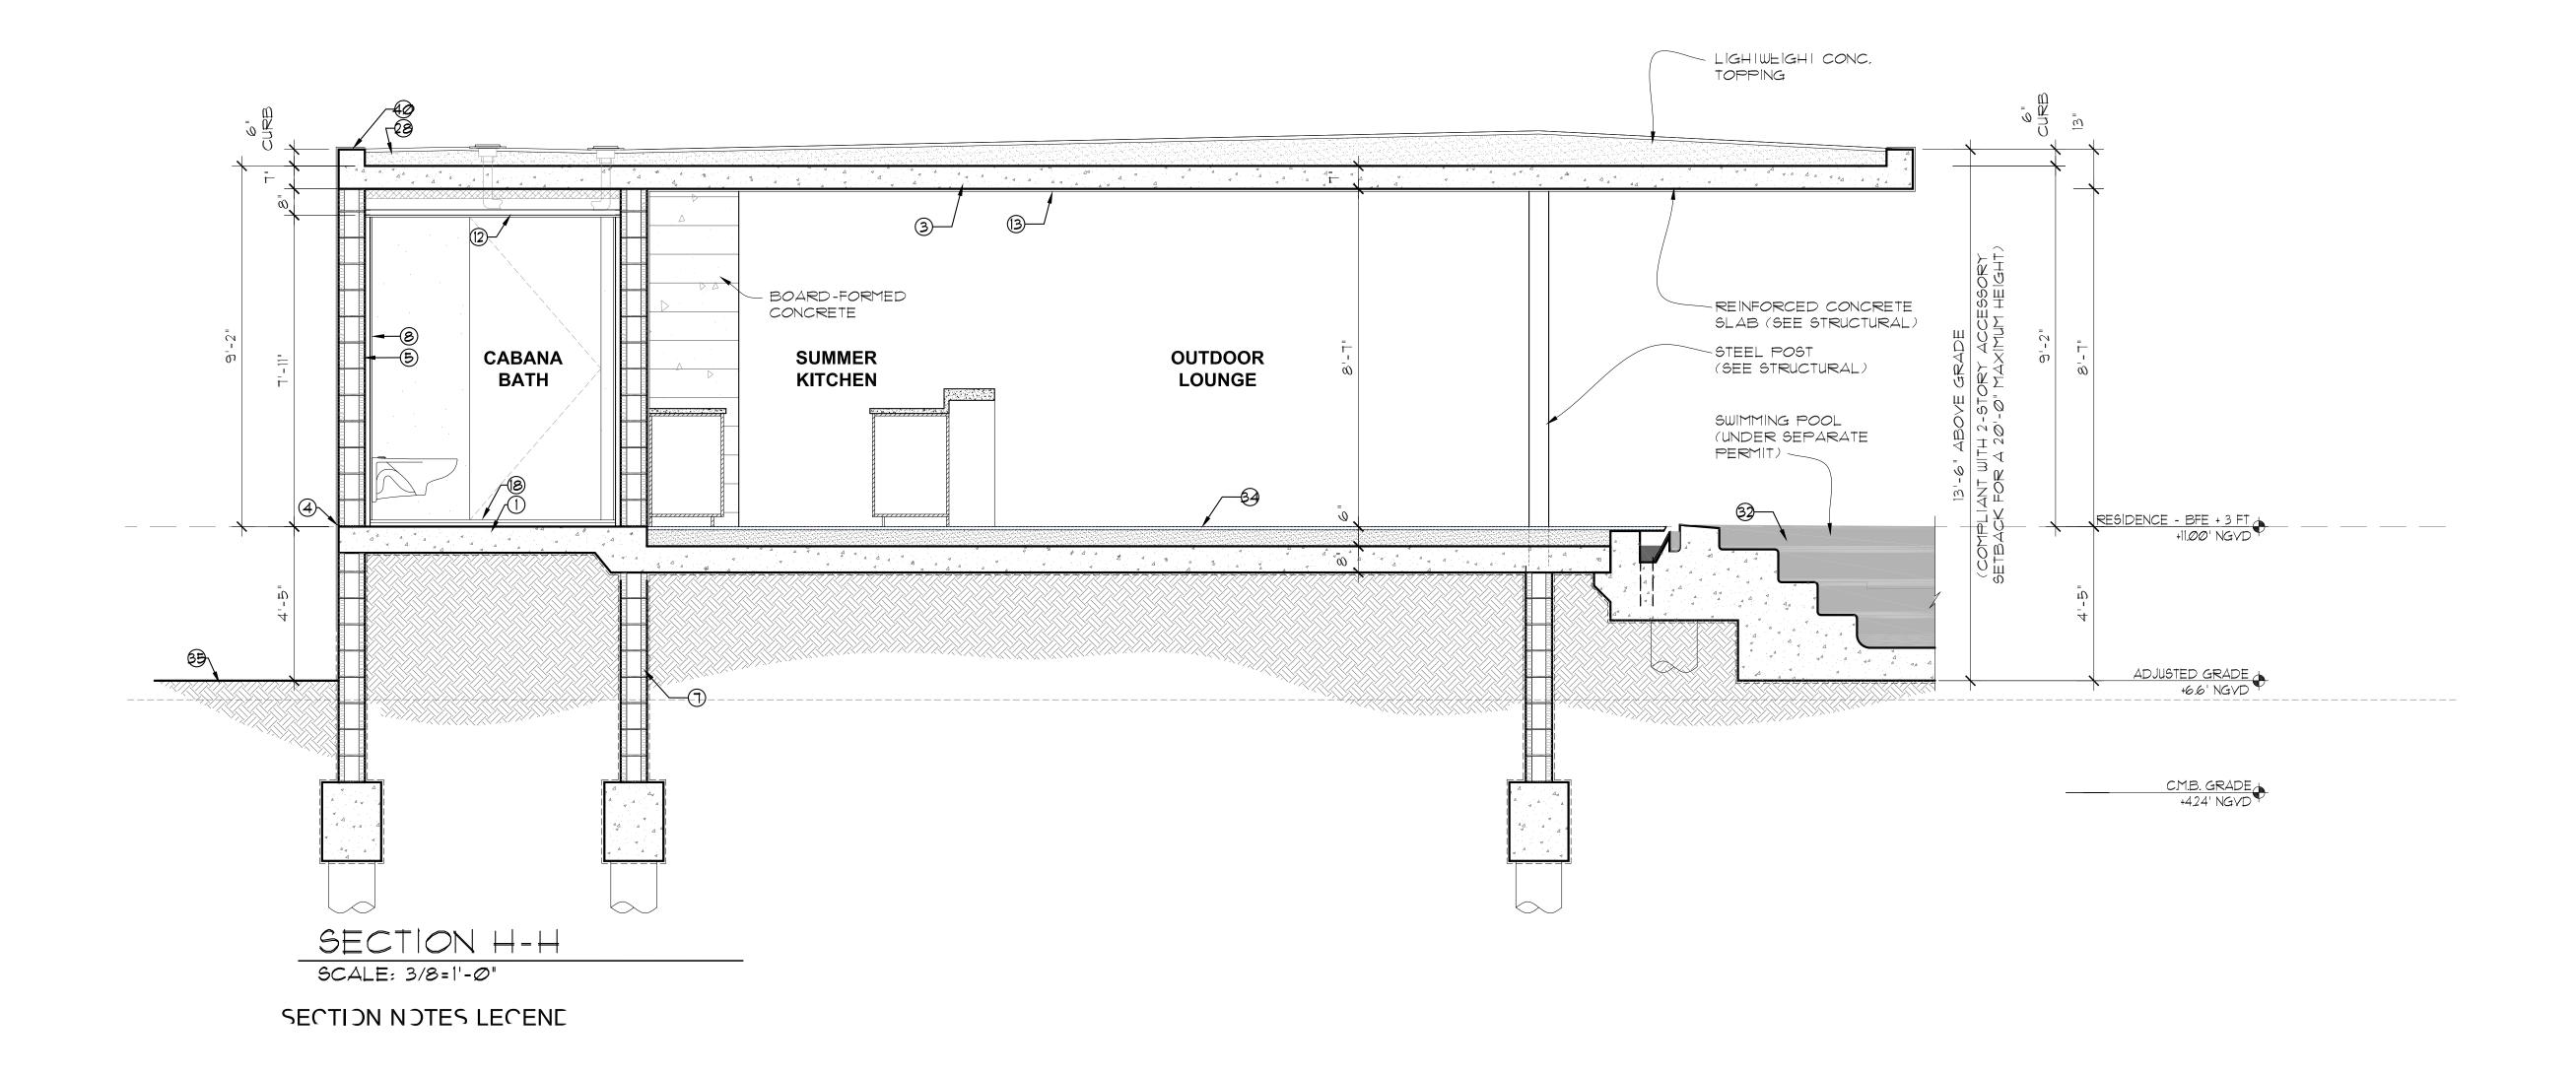

Ralph Choeff registered architect

FINAL SUBMITTAL

sheet no.

revised

04-20-2018 / DFE UPDATE +

42. <u>CASCADE</u> WATER FIXTURE WITH BOTTOM NOZZLE- <u>AQUA STORM SSR</u> (SEE POOL SHOP DWG'S) 05-01-2018 / BD COMMENTS 05-01-2018 / BD COMMENTS

43, C.I.P. CONCRETE 'STEPPING STONES' WITH STONE FINISH. (SEE STRUCTURAL DIGGS)

44, METAL STAIRS (BY OTHERS-UNDER SEPARATE PERMIT). STAIR MANUFACTURER SHALL PROVIDE FULLY ENGINEERED SHOP DRAWINGS FOR ARCHITECT'S APPROVAL PRIOR TO MANUFACTURING. /7\ 03-15-2019/BD COMMENTS

45. NATURAL LAWN, SOIL, SUB-SURFACE. (REFER TO LANDSCAPE DRAWINGS FOR LAWN INFORMATION) $\sqrt{8}$ 09-09-2019 / DRB VARIANCE

46. SYNTHETIC LAWN OVER DRAINAGE BOARD OVER LIGHTWEIGHT CONCRETE TOPPING SLOPED TO DRAIN AT MINIMUM 1/4" SLOPE PER FOOT.


47. WATT6 FD-300 CAST-IRON SINGLE-OUTLET DECK DRAIN WITH 2ND FD-300 DRAIN LOCATED FOR EMERGENCY OVERFLOW LESS THAN 4" ABOVE PRIMARY DRAIN. (SEE ROOF PLAN FOR LOCATIONS)

48. WOOD DECK OVER PT WOOD SLEEPERS OVER LIGHTWEIGHT CONCRETE SLOPED TO DRAINS AT 1/4" PER FOOT MINIMUM WITH KEMPEROL-BRM" COLD FLUID APPLIED WATERPROOFING SYSTEM.

49. LWC TOPPING SLOPED MIN. 1/8" PER FT TO STAINLESS STEEL SLOT DRAIN CHANNEL TO PERIMETER, WITH

"KEMPEROL-BRM" COLD FLUID APPLIED WATERPROOFING SYSTEM BY KEMPER (SEE MFR. SPEC'S, UNDER SEPARATE PERMIT).

REQUEST FINAL SUBMISSION: 09/09/19 HEARING: 11/05/19

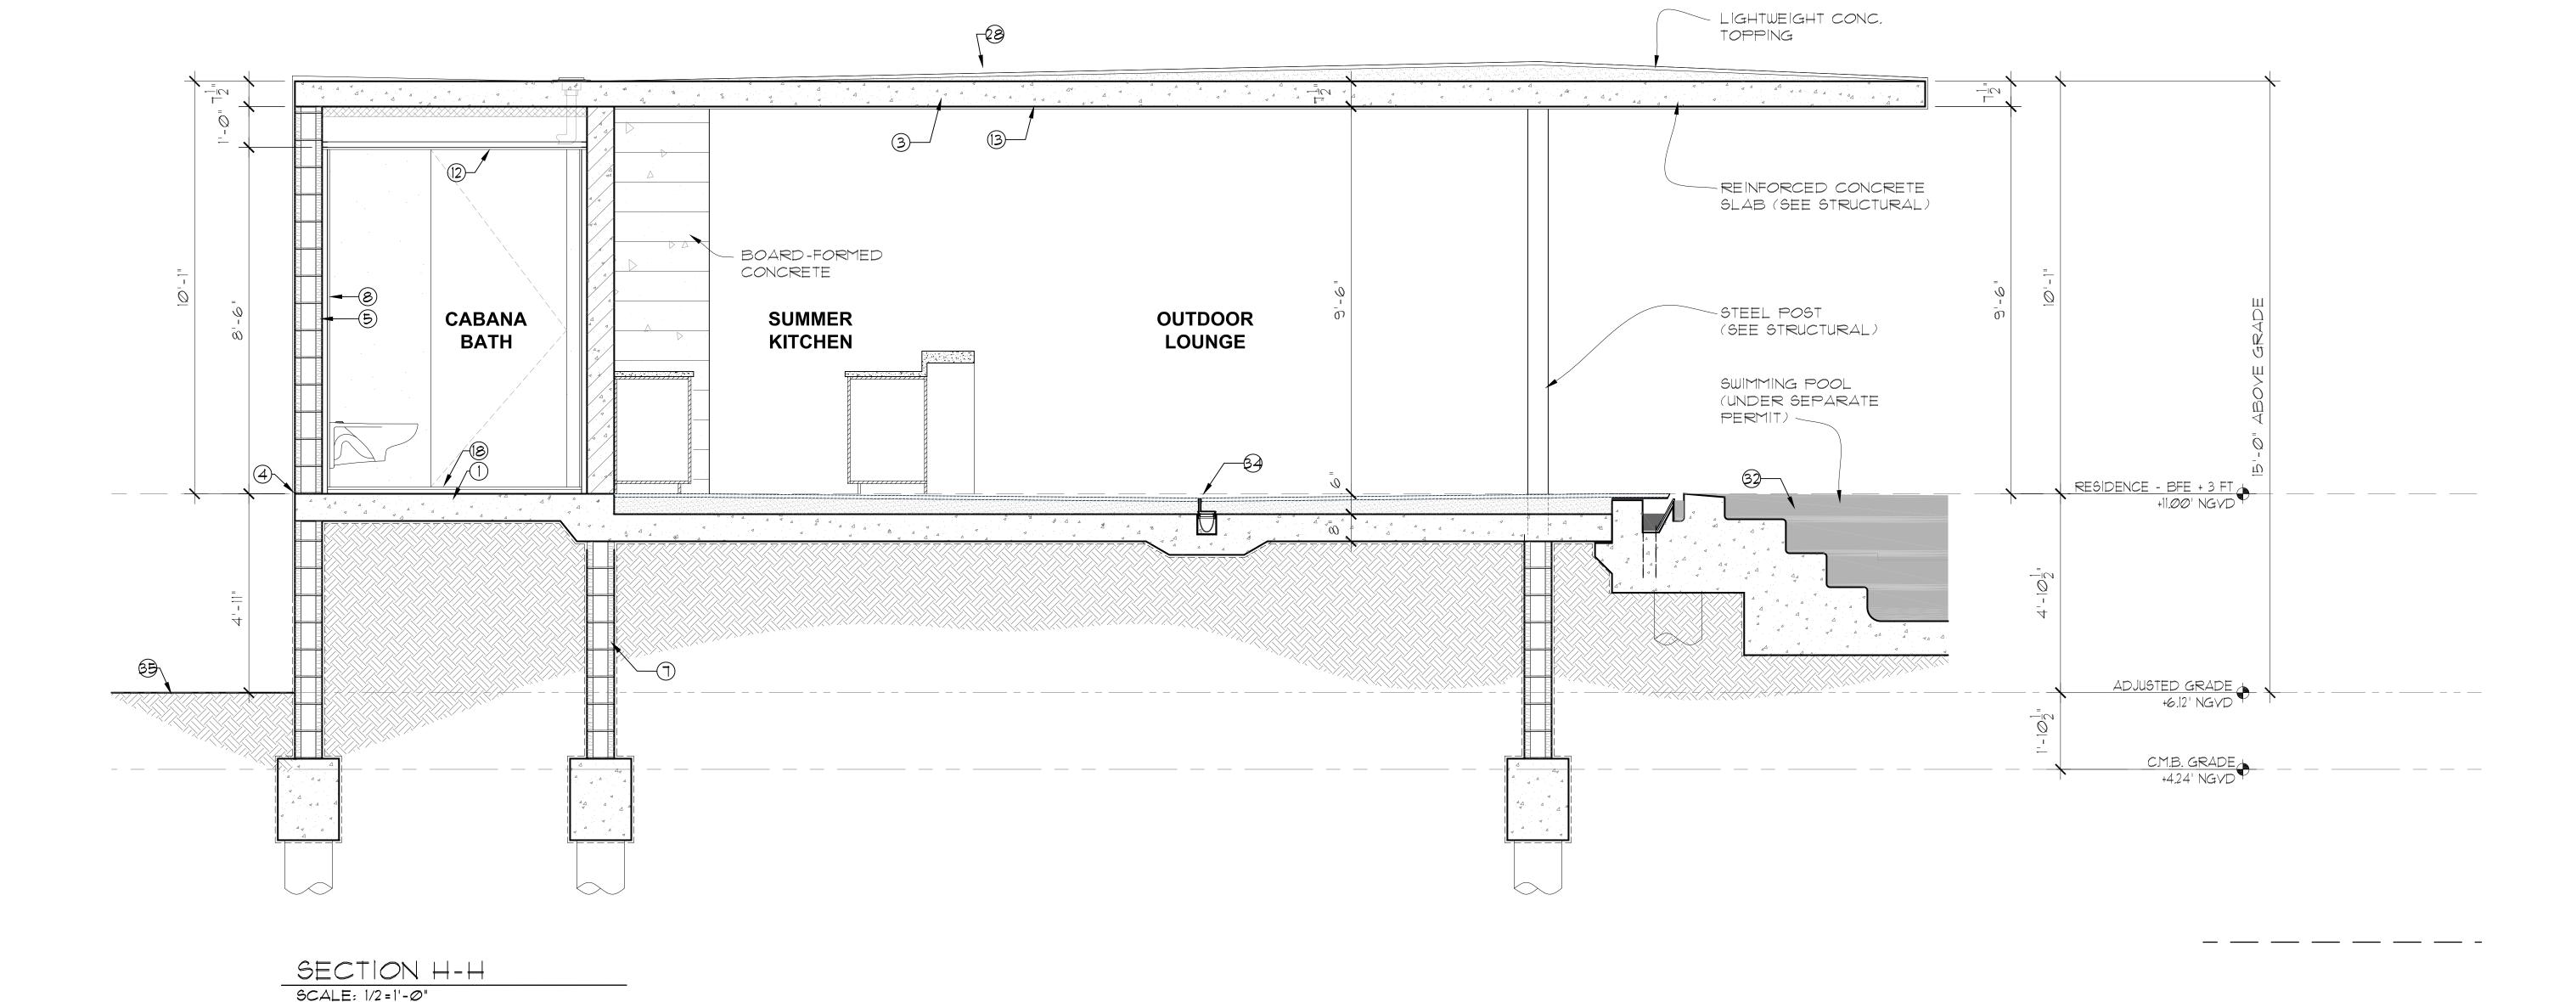

SECTION NOTES LEGEND

- 1. REINFORCED CONCRETE SLAB WITH MINIMUM 6 MIL. VISQUEEN
- VAPOR BARRIER OVER COMPACTED BACK FILL. (SEE STRUCTURAL) 2. REINFORCED CONCRETE BEAM (SEE STRUCTURAL DRAWINGS FOR SIZE AND REINFORCING REQUIREMENTS)
- 3. POST-TENSIONED CONCRETE SLAB (SEE STRUCTURAL DRAWINGS FOR DETAILS).

_ ___ __ __

- 4. $\frac{3}{4}$ " WATER INTRUSION RECESS AT ALL PERIMETER CMU LOCATIONS
- 5. CONCRETE MASONRY UNIT / CONCRETE WALL WITH HIGH QUALITY STUCCO & PAINT FINISH AT EXTERIOR (BENJAMIN MOORE - CHINA WHITE) OR TIG IPE WOOD FINISH - (REFER TO WALL TYPES FOR FINISHES AND REFER TO STRUCTURAL DRAWINGS)
- 6. CAST-IN-PLACE REINFORCED CONCRETE WALL WITH BOARD-FORMED EXPOSED FINISH (SEALED), (REFER TO STRUCTURAL DRAWINGS)
- 7. STRUCTURAL CONCRETE FOUNDATION OVER WELL COMPACTED FILL SEE STRUCT, DRAWINGS FOR SLAB, PILE, & GRADE BEAM SPECIFICATIONS.
- 8. 20 GA. 1-5/8" MTL. STUDS @ 16" O.C. W/ $\frac{5}{6}$ " GWB OR TILE BACKER BOARD -PROVIDE (R=5.0) TUFF R BOARD INSULATION

- 9. 20 GA. $1\frac{1}{2}$ " BY $3\frac{5}{6}$ " MTL STUDS @ 16" O.C. W/ FULL THICK SOUND BATT INSULATION AT ALL WALLS WITHOUT EXCEPTION, TO RECEIVE 5/8" GWB EACH SIDE W/ PAINT FINISH, UNLESS OTHERWISE NOTED & NON-CEMENTITIOUS TILE BACKER BOARD AT ALL WET WALLS. (TYP. THROUGHOUT)
- 10. STEEL TUBE COLUMN OR BEAM CLAD WITH ALUMINUM BREAK-METAL WITH DARK BRONZE 'DURANAR' PAINT FINISH (SEE STRUCTURAL DWG'S)
- 11. MINIMUM 3" (R-19) ICYNENE "PROSEAL" SPRAY FOAM INSULATION (SEE ICC-ES EVALUATION REPORT ESR-3500 FOR CODE COMPLIANCE INFORMATION) UNDER CONCRETE SLAB (AT ALL AREAS WHERE CONC. ROOF SLAB IS EXPOSED TO EXTERIOR) VERIFY R-VALUE WITH ENERGY CALCULATIONS.
- 11a, MINIMUM R-19 TAPERED INSULATION OVER SLAB (FIRESTONE ISO-95 GL OR EQUAL)
- 12. USG I $\frac{1}{2}$ SUSPENDED GRID SYSTEM OR APPROVED EQUAL WITH $\frac{5}{5}$ " GYPSUM WALL BOARD CEILING WITH WHITE PAINT FINISH (SEE REFL. CEILING PLANS FOR HEIGHTS).
- 13. SMOOTH STUCCO FINISH OVER CONCRETE OR OVER MTL. LATHE OVER (BCX) PLYWD. OVER 30# FELT OVER COLD FLUID APPLIED WATERPROOFING.
- 14. 3/4" IPE TOUNGE & GROOVE FRAME OVER (BCX) PLYWD ATTACHED TO METAL FRAMING ASSEMBLY, SEE DETAIL X/A7/XX.

- 15. 3/4' IPE TOUNGE & GROOVE CEILING OVER (BCX) PLYWD. OVER 30* FELT OVER COLD FLUID APPLIED WATERPROOFING ON FURRING OR ATTACHED TO $1\frac{1}{2}$ " $\times 3\frac{5}{8}$ " MTL. FRAMING @ 16" O.C. (SEE STRUCTURAL FOR FRAMING SPECS.)
- 16. 3/4" IPE TOUNGE & GROOVE WOOD FINISH OVER (BCX) PLYWD. OVER COLD FLUID APPLIED WATERPROOFING OVER REINFORCED MASONRY/CONCRETE WALL. INSTALL AND SEAL MATERIAL PER MANUFACTURERS SPECIFICATIONS.
- 17. TILED DECK OVER 3/4" MORTAR BED OVER KEMPEROL "BRM COLD FLUID APPLIED WATERPROOFING MEMBRANE SYSTEM' W/ KEMPERTEC ALKALINITY BARRIER BY "KEMPER"
- 18. FINISH FLOOR WITH SOUNDPROOFING ATLEVEL-2 "WHISPERMAT" CS OR HW, OR APPYD EQUAL (SEE INTERIOR DESIGN PLANS FOR FINAL MATERIAL SELECTION AND FINISH.)
- 19. ALUMINUM SLIDING GLASS DOOR SYSTEM WITH DARK BRONZE 'DURANAR' PAINT FINISH W/ CLEAR IMPACT RESISTANT GLASS (BY OTHERS, UNDER SEPARATE PERMIT)

21. 3'-6" HIGH CLEAR FRAMELESS IMPACT RESISTANT GLASS RAIL (TYP.)

- $2\mathscr{O}$. ALUMINUM WINDOW ASSEMBLY WITH DARK BRONZE 'DURANAR' PAINT FINISH W/ CLEAR IMPACT RESISTANT GLASS (BY OTHERS, UNDER SEPARATE PERMIT)
- 22. REINFORCED CONCRETE GARAGE SLAB W/ BROOM FINISH (SEE STRUCTURAL DRAWINGS FOR DETAILS)

- 23. SMOOTH STUCCO AND PAINT FINISH AT ALL GARAGE INTERIOR WALLS (SEE WALL TYPE 'G'
- 24. GARAGE FLOOD VENTS (SEE CALCULATIONS ON SHEET A-1.1) MOUNTED @ 12" MAX. ABOVE GRADE OR GARAGE FINISH FLOOR ELEVATION. SMART VENT MODEL #1540-524 INSULATED 16"x8" (200 S.l.).
- 25. PRE-MANUFACTURED GARAGE DOOR ASSEMBLY WITH STAINED & SEALED IPE WOOD FINISH. (BY OTHERS, UNDER SEPARATE PERMIT. CONTRACTOR TO PROVIDE ENGINEERED SHOP
- 26. "KEMPEROL-2K-PUR" COLD FLUID-APPLIED WATERPROOFING MEMBRANE SYSTEM W/ WHITE "KEMPERDUR DEKO COATING" BY KEMPER OVER LWC AND R-19 MIN. TAPERED INSULATION (FIRESTONE ISO 95+ GL OR EQUAL) SLOPED TO DRAIN @ 1/4"/FOOT (SEE MFR SPEC'S, UNDER SEPARATE PERMIT)
- 27. WATTS RD-100 DUAL OUTLET LOW PROFILE ROOF DRAIN / EMERGENCY OVERFLOW (SEE ROOF PLAN FOR LOCATIONS)
- 28. SECONDARY LIGHTWEIGHT CONC. POUR SLOPED 1/4"/ FOOT (TYP.)

PROVIDE SPECIFICATIONS)

- 29. RECESSED CURTAIN POCKET WITH CEILING MOUNTED CURTAIN SHADE & MECHANISM (MANF. TO
- 36, SEE SHOWER ENCLOSURE NOTE ON SHT A-1.1 37, 4" x 18" DECORATIVE WOOD LOUVERS

(UNDER SEPARATE PERMIT)

38, LINEAR RECESSED BALCONY DRAIN WITH STAINLESS STEEL GRATE, MODEL S-AG 38 BY

31. CANTILEVERED STEEL STAIR WITH WOOD FINISH. (BY OTHERS)

32. SWIMMING POOL (UNDER SEPARATE PERMIT)

33, REFLECTING POND (UNDER SEPARATE PERMIT)

REINFORCED CONCRETE SLAB/STEPS.

39, DECK DRAIN- 'ACO' KSIOO BRICK SLOT DRAIN OR EQUAL. (SEE DETAIL 1/A-12). TYPICAL

30, CAST-IN-PLACE CONCRETE PAVERS W/ SEALANT FINISH ON COMPACTED SAND

34. STONE DECK OVER MORTAR BED SLOPED AWAY FROM INTERIOR, OVER

35, ADJUSTED GRADE, REFER TO CIVIL DRAWINGS AND SITE PLAN SHEET A-1.0

BASE. PROVIDE 3" GAPS BETWEEN PAVERS FOR GRASS, TYP. ALL DRIVEWAY.

40, 6" HIGH imes 8" WIDE CAST-IN-PLACE CONCRETE CURB.

41. CONTINUOUS DRIP/ TRANSITION "F" REVEAL MOLDING.