SHEET NO:



SALMANSON RESIDENCE | 6626 ROXBURY LANE | MIAMI BEACH, FLORIDA

CLIENT / PROPERTY INFORMATION

Mr. David Salmanson

PROPERTY ADDRESS 6626 ROXBURY LANE

MIAMI BEACH, FL 33141

EXISTING VEGETATION SUMMARY

The existing vegetation located on the property is composed primarily of Coconut Palms, Alexander Palms and a large specimen Ficus nitida tree in the front of the property. All existing trees and palms are to be removed, aside from the (2) Royal Palms in the R.O.W. Mitigation and permits will be provided as per the C.M.B. Tree Preservation and Protection Ordinance.

SCOPE OF WORK

- Preservation of existing vegetation and landscape
- New clean and sophisticated landscape design to complement new residence

INDEX OF SHEETS

- L-0 Landscape Cover + Sheet Index
- **L-1** Existing Tree Survey + Disposition Plan
- L-1.1 Existing Tree Disposition Chart + Arborist Report
- L-1.2 Existing Tree Variance Request **L-2** Landscape Plan
- L-2.1 Landscape Notes + Details
- L-3 Plant Material Images
- L-4 Front Elevations
- L-4.1 Side ElevationsL-4.2 Rear Elevation

AUGUST 5, 2019

SUITE 1106 MIAMI, FL 33138

CHRISTOPHERCAWLEY.COM

REVISION SCHEDULE

EXISTING TREE

SURVEY +

PLAN


DISPOSITION


SHEET TITLE:

780 NE 69TH STREET

Florida Landscape Architecture Business LC

O 786.534.5327 C 305.979.1585

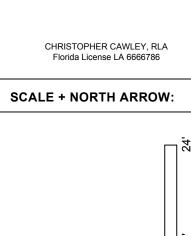


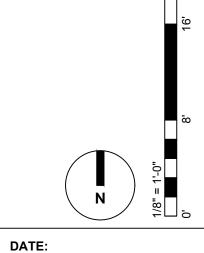

AUGUST 5, 2019

SHEET NO:

L-1

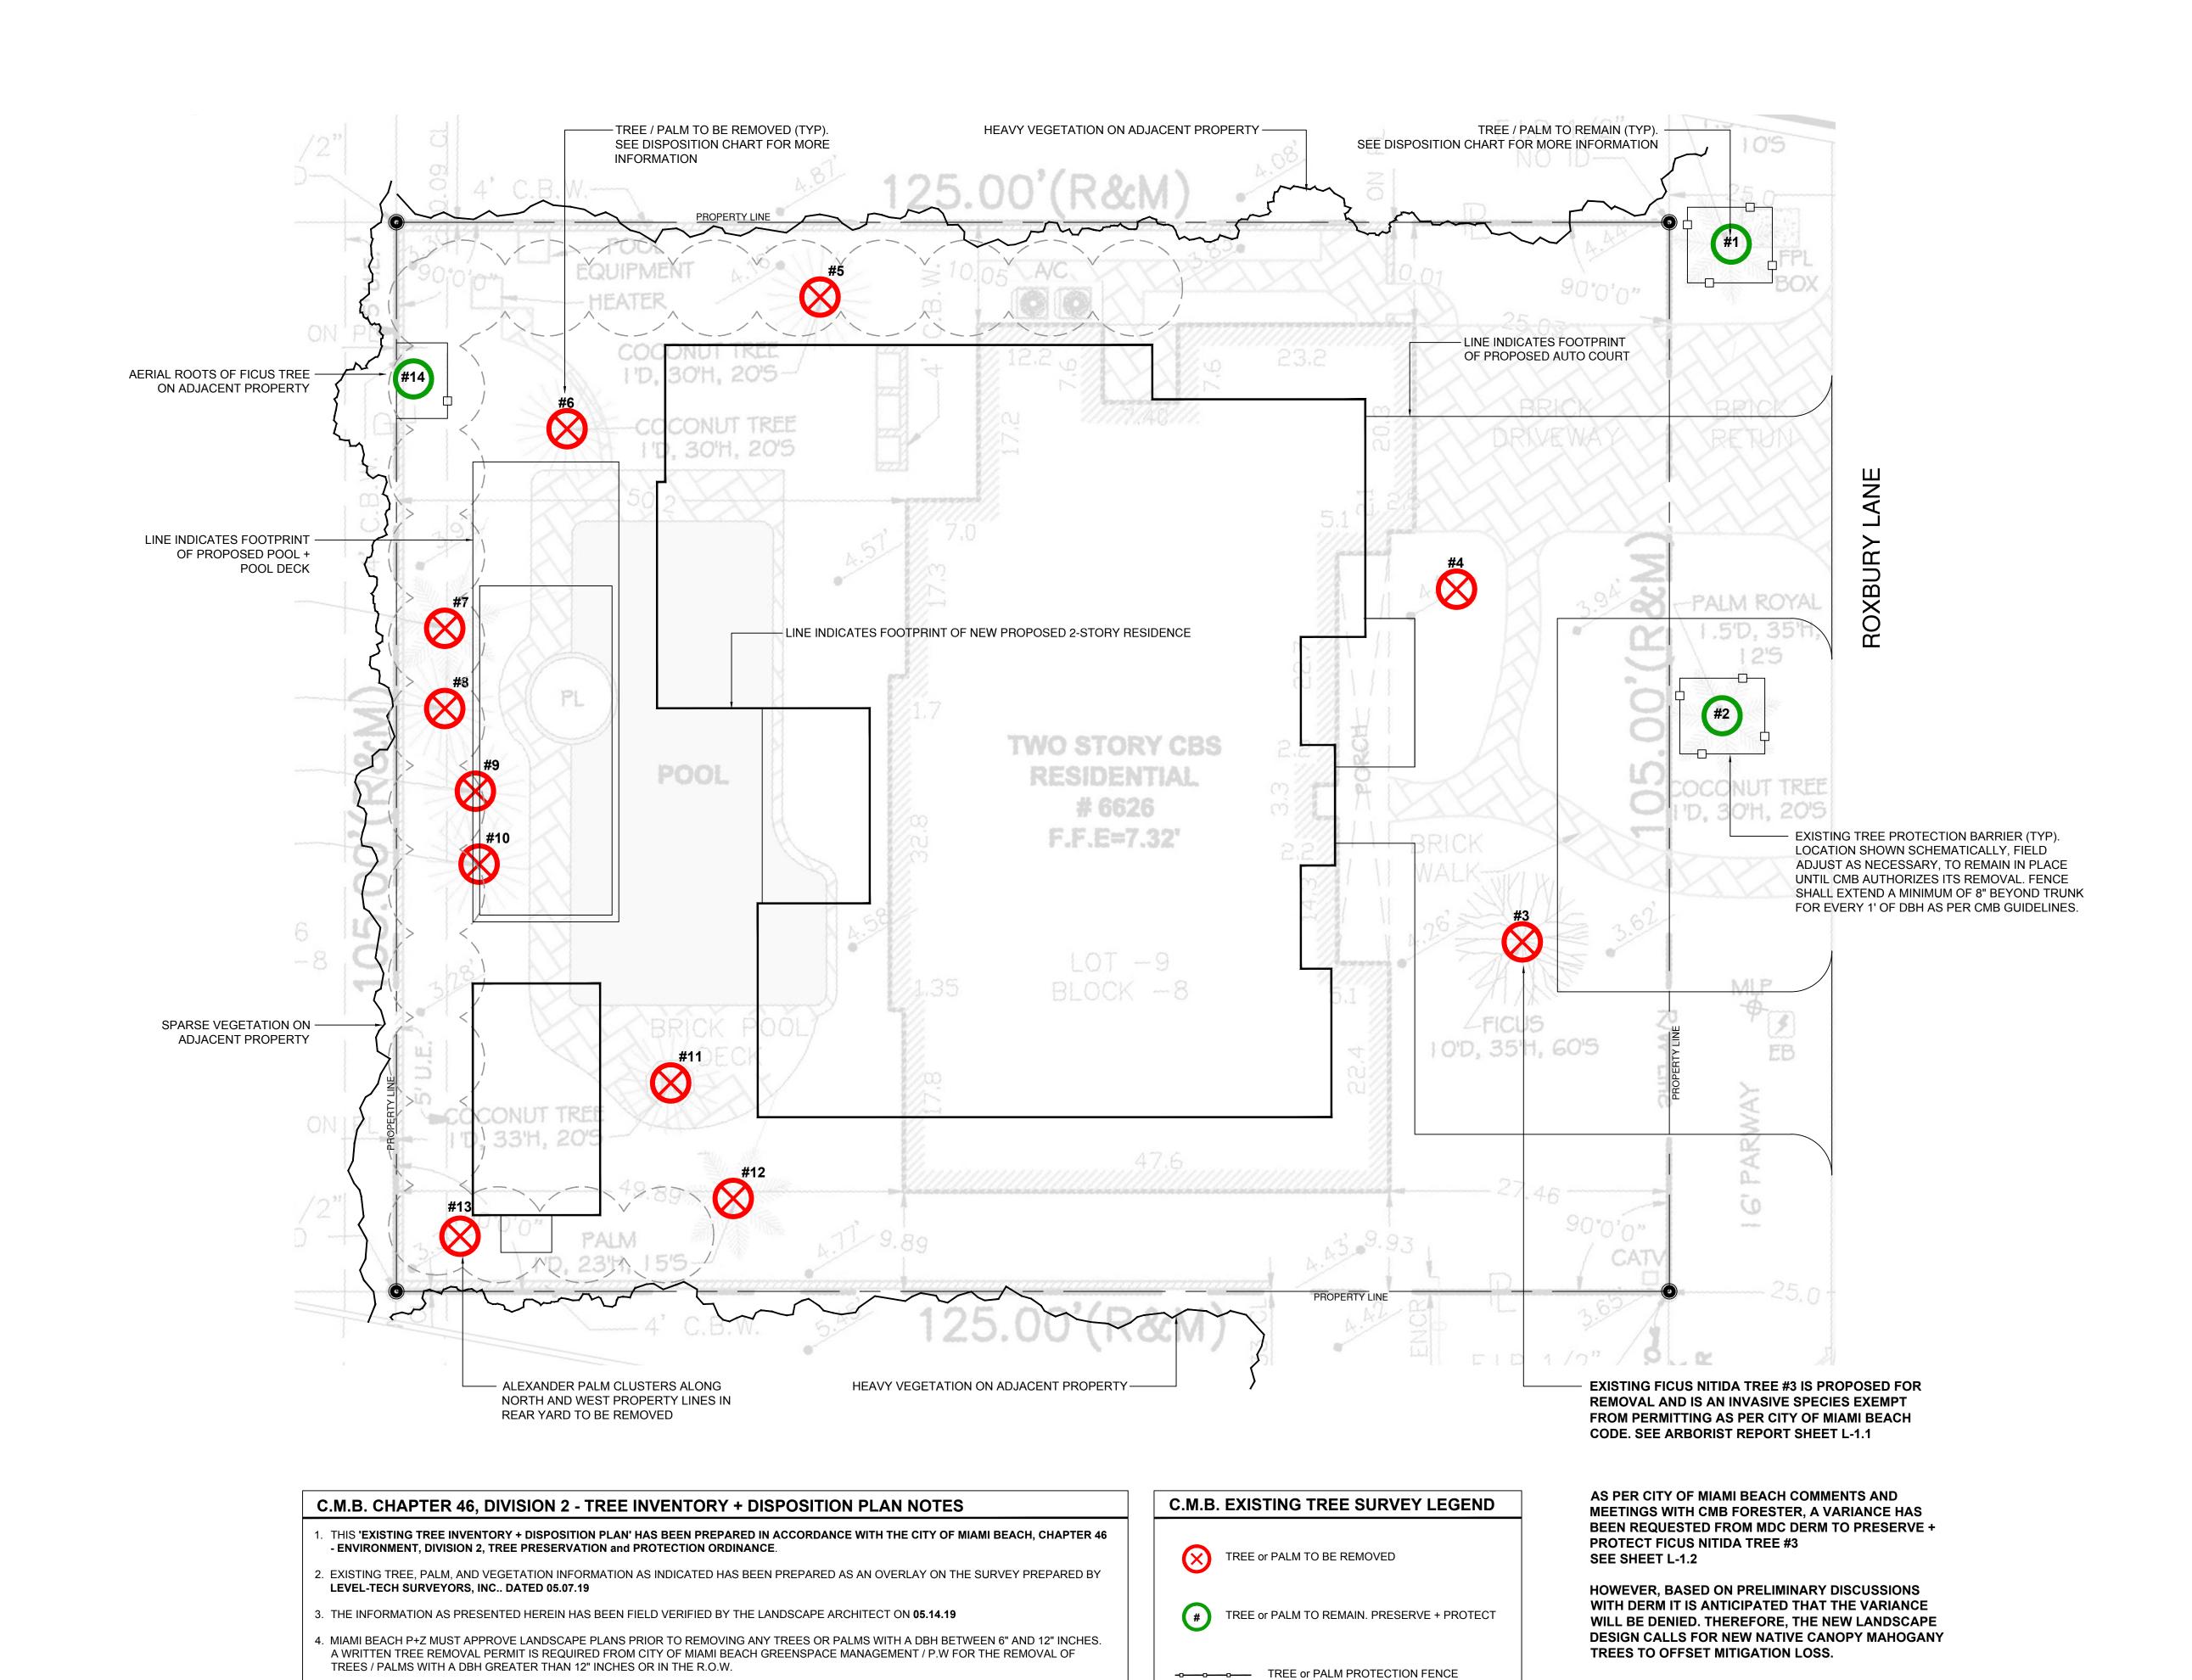

5. THE OWNER RESERVES THE RIGHT TO REMOVE ANY VEGETATION NOT LOCATED WITHIN THE CITY R.O.W. w/ a D.B.H. OF LESS THAN 6" WITHOUT

OBTAINING A TREE REMOVAL PERMIT.

JAMES LEGETTE

Certified Arborist, ISA Registered Consulting Arborist, ASCA President, Chief Arborist Lauderdale Tree Service, Inc. 954-583-1888 www.lauderdaletreeservice.com 4320 S.W. 74th Avenue • Davie, Florida 33314

June 7, 2019 Via Email

Christopher Cawley, RLA, ASLA 780 NE 69th Street, Suite 1106 Miami, FL 33138

RE: 6626 Roxbury Lane, Miami Beach **Evaluation of Ficus Tree**

Dear Mr. Cawley:

Pursuant to your request and authorization, representatives of this firm evaluated the large ficus tree in the front yard of the property. Our findings are as follows.

This tree is a Ficus nitida which is listed as a prohibited species by Miami-Dade County. While it is "exempt" from needing a permit from the City of Miami Beach for its removal, mitigation for the canopy loss will likely be required. The tree has a trunk diameter of \pm 12' at breast height (DBH). The canopy is overgrown due to lack of maintenance and begins approximately 18' above ground and is approximately 50' in overall height. The total canopy area is approximately 7,800 square feet and extends approximately 25' over the roof of the house, 30' over the right-of-way and street, and 19' over the neighbor's property to the south (see attached photos). A large royal palm in growing through the canopy along the street (see Photo 2).


The root system is expansive and likely runs beneath the foundation of the house and beneath the asphalt in the street. A large amount of leaf matter has accumulated between the tree trunk and house slab which can create nuisance conditions (see Photo 6).

The tree does not appear to have any significant structural defects, trunk decay, or insect damage. It appears that the tree was cut back to a height of about 20' above ground after a storm event as evidenced by the branching pattern. In addition, there are some branches in the center of the canopy that were probably broken off during Hurricane Irma in 2017 and are now hanging down toward the ground. These broken branches have caused a hole in the center of the canopy and are hazardous (see Photos 7 & 8). Because of the overgrown canopy, the tree is subject to failure during a

If you have any questions regarding the above findings, please feel free to contact me.

Respectfully submitted,

James (Jimi) LeGette, Certified Arborist, ISA #SO-0502 Registered Consulting Arborist, ASCA #617

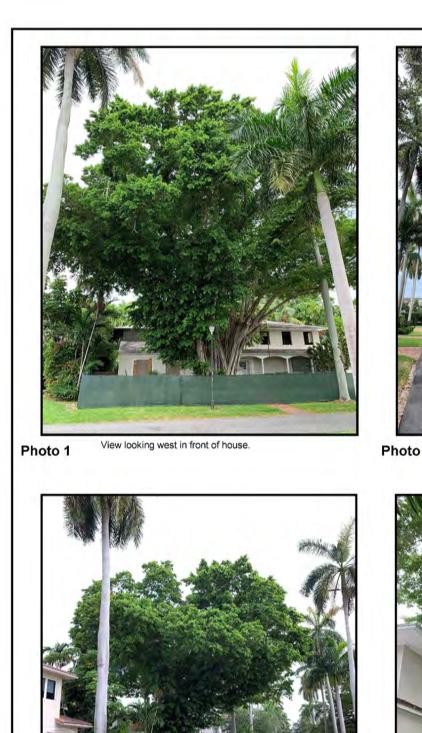

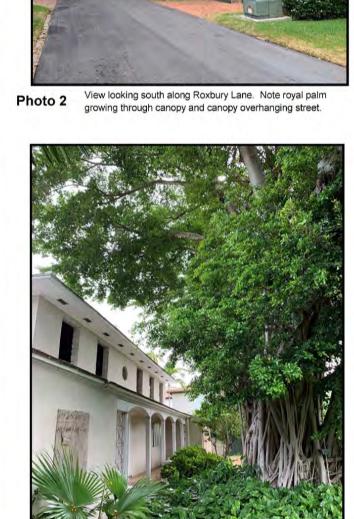


Photo 4 Canopy overhanging roof. View looking north along Roxbury Lane showing canopy overhanging into yard to the south.


Lauderdale Tree Service, Inc. Project: 6626 Roxbury Lane James LeGette, ISA #SO-0502
4320 S.W. 74th Avenue
Sheet Name: Site Photographs
Prepared For: Chris Cawley Davie, FL 33314 Address 6626 Roxbury Lane

tel. 954.583.1888



Davie, FL 33314

tel. 954.583.1888

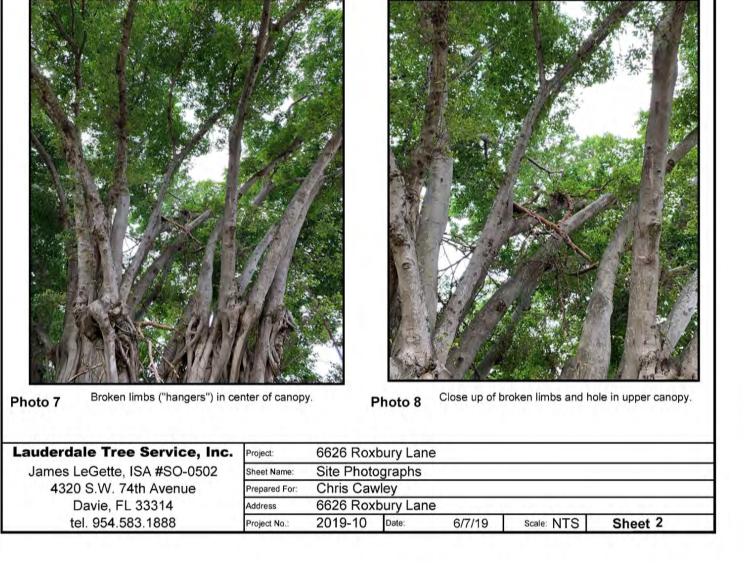

C.M.B. EXISTING TREE INVENTORY + DISPOSITION CHART - 6626 ROXBURY LANE												
IUMBER	COMMON NAME	BOTANICAL NAME	SPECIMEN	D.B.H. (IN)	HEIGHT (FT)	SPREAD (FT)	CONDITION	DISPOSITION	CANOPY AREA	CANOPY LOSS / MIT. REQ. (SF)	COMMENTS	PERMIT REQUIREMENTS P+Z - GPM / PW - N.A.
#1	Royal Palm	Roystonea elata	YES	+/- 18"	+/- 35'	+/- 10'	GOOD	RELOCATE	79 SF	0 SF	PRESERVE + PROTECT DURING CONSTRUCTION	N/A - NO PERMIT REQUIRED
#2	Royal Palm	Roystonea elata	YES	+/- 18"	+/- 35'	+/- 12'	GOOD	RELOCATE	113 SF	0 SF	PRESERVE + PROTECT DURING CONSTUCTION	N/A - NO PERMIT REQUIRED
#3	Indian Laurel Fig	Ficus nitida	YES	+/- 10'	+/- 35'	+/- 60'	POOR	REMOVE	7,800 SF	7,800 x 2 = 15,600 SF	IN CONFLICT WITH SITE DESIGN. MITIGATION PROVIDED	GREEN SPACE MANGMT / PW
#4	Jatropha Tree	Jatropha sp.	NO	+/- 10"	+/- 15'	+/- 7'	GOOD	REMOVE	39 SF	39 SF	IN CONFLICT WITH SITE DESIGN. MITIGATION PROVIDED	MIAMI BEACH P+Z
#5	Coconut Palm	Cocos nucifera	YES	+/- 12"	+/- 30'	+/- 20'	GOOD	REMOVE	314 SF	314 SF	IN CONFLICT WITH SITE DESIGN. MITIGATION PROVIDED	GREEN SPACE MANGMT / PW
#6	Coconut Palm	Cocos nucifera	YES	+/- 12"	+/- 30'	+/- 20'	GOOD	REMOVE	314 SF	314 SF	IN CONFLICT WITH SITE DESIGN. MITIGATION PROVIDED	GREEN SPACE MANGMT / PW
#7	Coconut Palm	Cocos nucifera	YES	+/- 12"	+/- 18'	+/- 12'	GOOD	REMOVE	113 SF	113 SF	IN CONFLICT WITH SITE DESIGN. MITIGATION PROVIDED	GREEN SPACE MANGMT / PW
#8	Coconut Palm	Cocos nucifera	YES	+/- 12"	+/- 29'	+/- 18'	GOOD	REMOVE	254 SF	254 SF	IN CONFLICT WITH SITE DESIGN. MITIGATION PROVIDED	GREEN SPACE MANGMT / PW
#9	Coconut Palm	Cocos nucifera	YES	+/- 12"	+/- 29'	+/- 18'	GOOD	REMOVE	254 SF	254 SF	IN CONFLICT WITH SITE DESIGN. MITIGATION PROVIDED	GREEN SPACE MANGMT / PW
#10	Coconut Palm	Cocos nucifera	YES	+/- 12"	+/- 29'	+/- 18'	GOOD	REMOVE	254 SF	254 SF	IN CONFLICT WITH SITE DESIGN. MITIGATION PROVIDED	GREEN SPACE MANGMT / PW
#11	Coconut Palm	Cocos nucifera	YES	+/- 12"	+/- 33'	+/- 20'	GOOD	REMOVE	314 SF	314 SF	IN CONFLICT WITH SITE DESIGN. MITIGATION PROVIDED	GREEN SPACE MANGMT / PW
#12	Coconut Palm	Cocos nucifera	YES	+/- 12"	+/- 23'	+/- 15'	GOOD	REMOVE	177 SF	177 SF	IN CONFLICT WITH SITE DESIGN. MITIGATION PROVIDED	GREEN SPACE MANGMT / PW
#13	Alexander Palm cluster	Ptychosperma elegans	NO	+/- 2" - 4"	+/- 30' - 40'	+/- 8'	GOOD	REMOVE	50 SF	0 SF	SMALL PALMS. NO MITIGATION REQUIRED	N/A - NO PERMIT REQUIRED
#14	Fig Tree	Ficus sp.	YES	+/- 24"	+/- 30'	+/- 20'	GOOD	REMAIN	314 SF	0 SF	PRESERVE + PROTECT DURING CONSTUCTION	N/A - NO PERMIT REQUIRED
,			•		•	•	_					•

TOTAL MITIGATION REQUIRED: 17,633 SF TOTAL MITIGATION PROVIDED: 11,250 SF

Project No.: 2019-10 Date: 6/7/19 Scale: NTS Sheet 1

C.M.B. CANOPY MITIGATION NOTES

THE CANOPY MITIGATION OF 17,633 SF IS REQUIRED AS PER THE CITY OF MIAMI BEACH, CHAPTER 48 - ENVIRONMENT, DIVISION 2, TREE PRESERVATION and PROTECTION ORDINANCE. A TREE TRUST FUND SHALL BE PROVIDED AT THE TIME OF PERMITTING FOR ANY CANOPY MITIGATION SHORTFALL. TOTAL CANOPY MITIGATION OF 11,250 SF HAS BEEN PROVIDED.

CANOPY MITIGATION SUMMARY:

CATEGORY I TREES PROVIDED: - (4) SPECIMEN NATIVE MAHOGANY TREES: 1,800 SF (MB category I @ 450 SF each) - (30) NATIVE BAY RUM TREES: 9,000 SF (MB category I @ 300 SF each)

CATEGORY II TREES PROVIDED: - (1) FRANGIPANI TREES: 150 SF (MB category II @ 150 SF each)

CATEGORY III TREES PROVIDED:

- (2) NATIVE SIMPSON STOPPER TREES: 200 SF (MB category III @ 100 SF each)

CATEGORY IV PALMS PROVIDED: - (2) SATAKENTIA PALMS: 100 SF (MB category IV @ 50 SF each)

AUGUST 5, 2019

SHEET NO:

CHRISTOPHER CAWLEY LANDSCAPE ARCHITECTURE LLC 780 NE 69TH STREET SUITE 1106 MIAMI, FL 33138 O 786.534.5327 C 305.979.1585 CHRISTOPHERCAWLEY.COM

> Florida Landscape Architecture Business LC 26000460

REVISION SCHEDULE

SHEET TITLE:

EXISTING TREE DISPOSITION CHART + **ARBORIST REPORT**

Florida License LA 6666786

SCALE + NORTH ARROW:

DATE:

Bizcayne Environmental. Inc.

Environmental and Land Development Consultants • Mitigation Design and Contracting

July 30, 2019

Via Email

Lee Hefty, Asst. Director Miami Dade County, RER-DERM 701 NW 1st Ct. 4th Floor Miami, FL 33136

RE: 6626 Roxbury Lane, Miami Beach Variance Request from Sec. 24-49.9 County Code BEI Project No.: 2019-10

Dear Lee,

This firm has been retained by the subject property owner to assist with the tree resource issues associated with the demolition of the existing house and construction of the new house. The property has palms and other ornamental trees including a large Ficus nitida, a prohibited species, in the front yard. As part of the City of Miami Beach's design review process, we had an arborist's evaluation prepared for this ficus tree (copy attached).

The City's Urban Forester has requested hat the ficus be preserved on site, not withstanding the fact that the tree is listed as a prohibited species which is required by Code to be removed at the time of new construction. Therefore, by way of this letter I am respectfully requesting a variance on the property owner's behalf from the provisions of Sec. 24-49.9 of the County Code to allow the tree to remain in place.

Please feel free to contact me if you have any questions regarding this matter, and also let me know if there are any fees associated with this variance request.

Sincerely, BISCAYNE ENVIRONMENTAL, INC.

David Ettman President

DE/ cs

cc: Chris Cawley, RLA
David Salmanson, Property Owner
Omar Leon, Urban Forester

1761 Cleveland Road ♦ Miami Beach, Florida 33141 ♦ Telephone 305-710-2359 ♦ Email biscayneinc@bellsouth.net



CHRISTOPHER CAWLEY LANDSCAPE ARCHITECTURE LLC
780 NE 69TH STREET
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O 786.534.5327
C 305.979.1585

CHRISTOPHERCAWLEY.COM
Florida Landscape
Architecture Business LC
26000460

REVISION SCHEDULE

SHEET TITLE:

EXISTING TREE VARIANCE REQUEST

ALMANSON RESIDENC
6626 ROXBURY LANE
MIAMI BEACH, FL 33141

CHRISTOPHER CAWLEY, RLA Florida License LA 6666786

SCALE + NORTH ARROW:

DATE

AUGUST 5, 2019

SHEET NO:

L-1.2

SUITE 1106 MIAMI, FL 33138

CHRISTOPHERCAWLEY.COM

REVISION SCHEDULE

LANDSCAPE

SHEET TITLE:

780 NE 69TH STREET

O 786.534.5327

C 305.979.1585


26000460

PLAN

Florida Landscape Architecture Business LC

SCALE + NORTH ARROW:


CHRISTOPHER CAWLEY, RLA Florida License LA 6666786

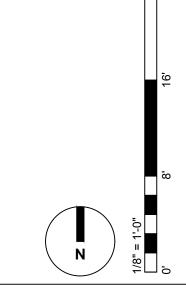

DATE:

AUGUST 5, 2019

SHEET NO:

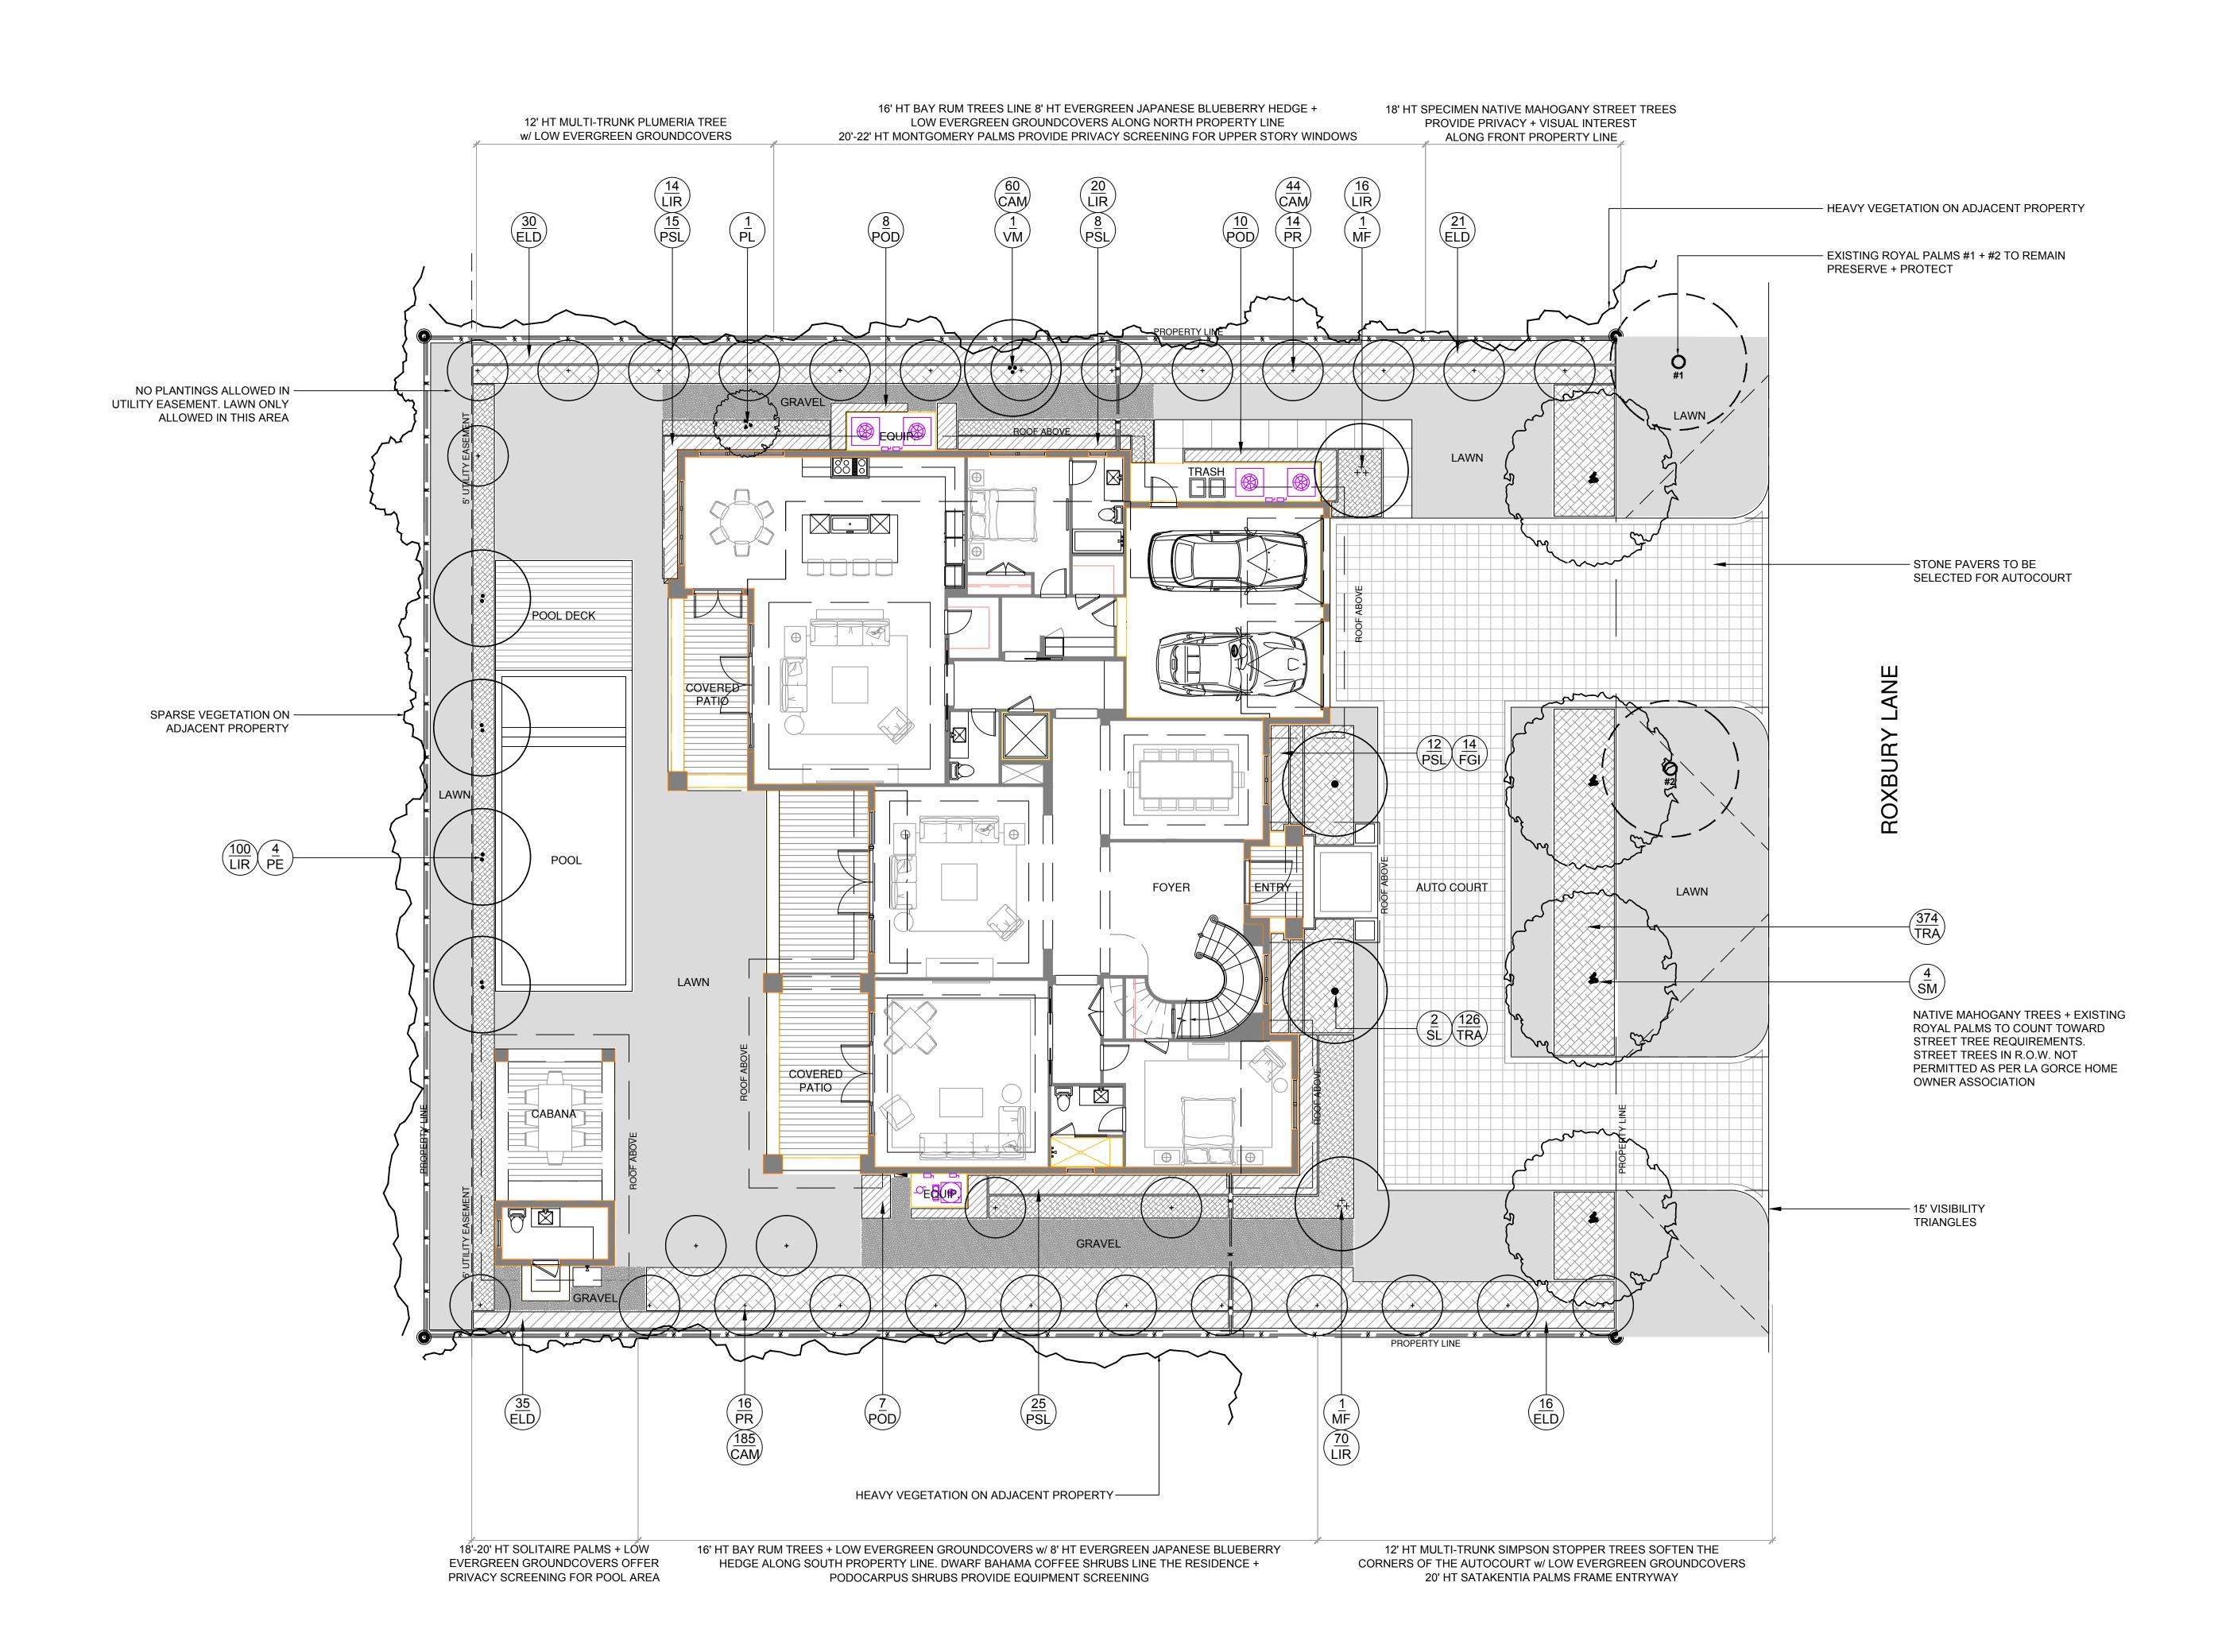

LANDSCAPE NOTES

- 1. ALL PLANT MATERIAL SHALL BE FLORIDA GRADE NO. 1 OR BETTER.
- 2. CONTRACTOR SHALL BECOME FAMILIAR WITH THE LOCATION OF, AVOID, AND PROTECT ALL UTILITY LINES, BURIED CABLES, AND OTHER UTILITIES.
- 3. TREE, PALM, ACCENT AND BED LINES ARE TO BE LOCATED IN THE FIELD AND APPROVED BY THE LANDSCAPE ARCHITECT PRIOR TO INSTALLATION.
- 4. ALL PLANTING SOIL SHALL BE 50:50 TOPSOIL:SAND MIX, FREE OF CLAY, STONES, ROCKS, OR OTHER FOREIGN MATTER. THIS SPECIFICATION INCLUDES ALL BACKFILL FOR BERMS AND OTHER LANDSCAPE AREAS.
- 5. THE SITE CONTRACTOR SHALL BE RESPONSIBLE TO BRING ALL GRADES TO WITHIN 2" OF FINAL GRADES. THIS SHALL INCLUDE A 2" APPLICATION OF 50:50 TOPSOIL:SAND MIX FOR ALL LANDSCAPE AND AREAS TO BE SODDED.
- 6. ALL PLANTING BEDS SHALL BE MULCHED TO A DEPTH OF 2" WITH A SMALL GRAY GRANITE AGGREGATE FREE FROM WEEDS AND PESTS. NO 'CYPRESS MULCH' OR 'RED DYED MULCH' TO BE ACCEPTED. KEEP MULCH 3" AWAY FROM TREE OR PALM TRUNKS AS PER INDUSTRY RECOMMENDATIONS.
- 7. SOD SHALL BE 'EMPIRE TURF' ZOYSIA GRASS IN ALL LAWN AREAS AS SHOWN ON THE PLANS. SOD SHALL BE STRONGLY ROOTED, FREE FROM WEED, FUNGUS, INSECTS AND DISEASE. CONTRACTOR SHALL SOD ALL AREAS AS INDICATED ON THE PLANS OR AS DIRECTED. PAYMENT SHALL BE DETERMINED BY THE TOTAL MEASURED SODDED AREAS X THE UNIT PRICE SUBMITTED AND FIELD VERIFIED. SOD SHALL CARRY A 5-MONTH WARRANTY.
- 8. ALL TREES, PALMS, SHRUBS AND GROUNDCOVERS, AND SOD / LAWN SHALL CARRY A ONE-YEAR WARRANTY FROM THE DATE OF FINAL ACCEPTANCE.
- 9. IRRIGATION SHALL PROVIDE FOR A 100% COVERAGE WITH 50% OVERLAP MINIMUM AND BE PROVIDED BY A FULLY AUTOMATIC IRRIGATION SYSTEM W/ RAIN MOISTURE SENSOR ATTACHED TO CONTROLLER. ALL FLORIDA BUILDING CODE APPENDIX "F" IRRIGATION REQUIREMENTS SHALL BE STRICTLY ADHERED TO FOR INSTALLATION AND PREVAILING WATER MANAGEMENT DISTRICT RESTRICTIONS AND REGULATIONS SHALL BE IN COMPLIANCE FOR POST-INSTALLATION WATERING SCHEDULES.

PLANT LIST - 6626 ROXBURY LANE

CAM NO 289 CARISSA 'EMERALD BLANKET'


MLC DARK BROWN 'FLORI MULCH' SHREDDED ORGANIC MULCH (NO CYPRESS), TO BE DETERMINED

SOD | 'EMPIRE TURF' ZOYSIA GRASS - OVER 2" TOPSOIL BED, SEE PLANTING SPECS

SOD, AGGREGATE & MULCH

KEY NATIVE QTY. COMMON NAME


PALM PROTECTION FENCES SHALL BE CONSTRUCTED PRIOR TO ANY CONSTRUCTION ACTIVITY INCLUDING GRUBBING FOR ALL PALMS THAT ARE 'TO REMAIN, BE PROTECTED, or BE RELOCATED'. NO ACTIVITY OR DISTURBANCE SHOULD OCCUR WITHIN THE FENCED AREAS, INCLUDING VEHICLE USE, STORAGE OF MATERIALS, DUMPING OF LIQUIDS OR MATERIALS, GRADE CHANGES, GRUBBING, AND MECHANICAL TRENCHING FOR IRRIGATION, ELECTRICAL, LIGHTING, ETC.

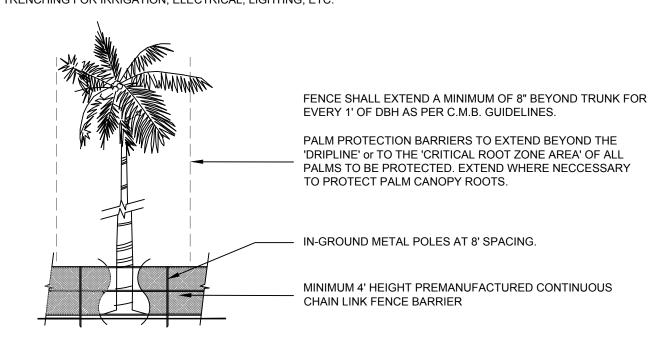



CONTRACTOR TO INSTALL 'PALM PROTECTION FENCE BARRIERS' AROUND ALL EXISTING PALMS AT THE START OF THE PROJECT. BARRIERS TO REMAIN IN PLACE THROUGHOUT THE DURATION OF THE PROJECT AND SHOULD NOT BE REMOVED OR DROPPED FOR ANY REASON WITHOUT AUTHORIZATION FROM THE CITY OF MIAMI BEACH URBAN FORESTER + PLANNING + ZONING DEPARTMENT

C.M.B. PALM PROTEC. DETAIL (CHAINLINK)

HEIGHT, SPECIFICATION, & NOTES

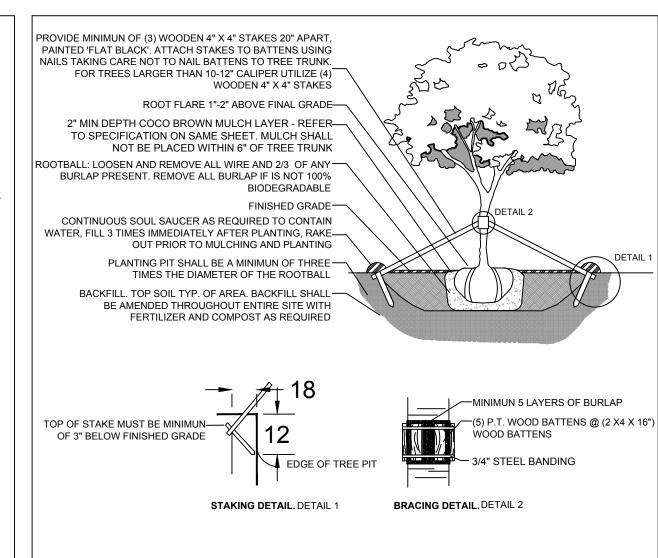

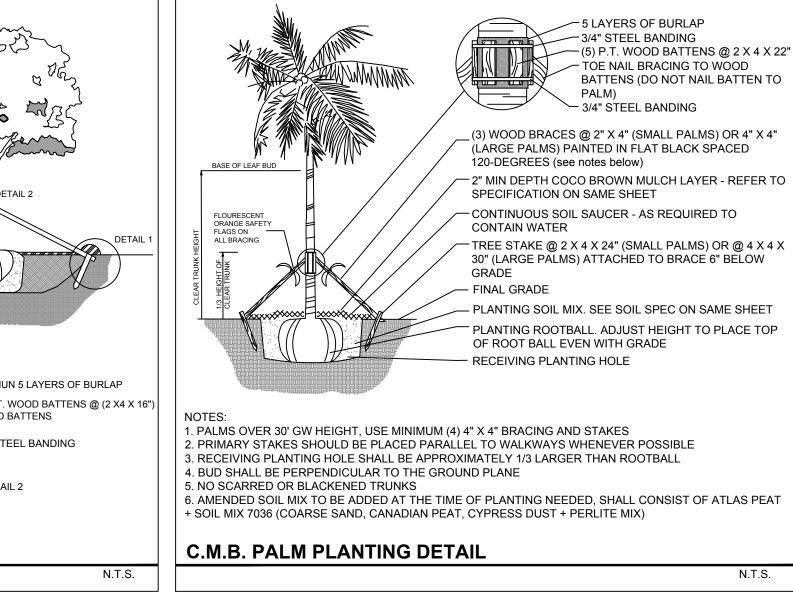

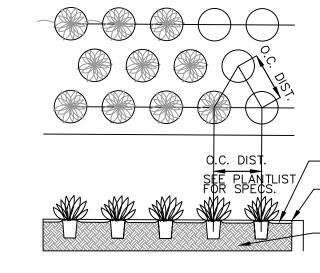

GROUNDCOVERS TO BE STAGGERED AS SHOWN -SPACING BETWEEN ROWS TO BE AT A 60 DEGREE ANGLE OF THE O.C. DISTANCE AS SHOWN

MULCH - SEE SPECS. FOR DEPTH, TYPE, ETC. — MULCH SHALL BE LEVEL WITH ALL EDGES OF PAVEMENT TYPICAL - PLANTING SOIL MIX - SEE NOTES FOR TYPE, DEPTH,

GROUNDCOVER PLANTING DETAIL

N.T.S.

PLANT MATERIAL SHALL NOT BE PRUNED PRIOR TO SHRUB SPACING AS PER SPECS UNDER SHRUB AS NEEDED. SHRUB PLANTING DETAIL

INSTALLATION, AFTER PLANTS HAVE BEEN INSTALLED, EACH PLANT SHALL BE PRUNED FOR UNIFORMITY OR AT THE DIRECTION OF THE PROJECT LANDSCAPE

– MULCH - SEE SPECS. FOR DEPTH, TYPE, ETC. MULCH SHALL BE LEVEL WITH ALL EDGES OF PAVEMENT TYPICAL

2" MIN. SAUCER COLLAR FOR WATER RETENTION LEAVE MOUND OF UNDISTURBED SOIL TO PREVENT SETTLING, OR, COMPACT THOROUGHLY

PLANTING SOIL MIX - SEE LANDSCAPE NOTES, FOR MIX, DEPTH, ETC.

N.T.S.

TREES MF YES 2 SIMPSON STOPPER TREE Myrcianthes fragrens 12' height min, 6'-8' spread, multi-trunk PL NO 1 FRANGIPANI TREE Plumeria rubra 12' height min, 6'-8' spread, multi-trunk PR YES 30 BAY RUM TREE 14'-16' height min, 8' spread, standard Pimenta racemosa SM YES 4 MAHOGANY TREE 18' height min, standard form, matched character Swietenia mahagoni PALMS PE NO 5 SOLITAIRE PALM Field grown, 18'-20' height, full heads, doubles Ptychosperma elegans SL NO 2 SATAKENTIA PALM Satakentia liukiuensis Field grown, 20' height, full heads, standard VM NO 1 MONTGOMERY PALM Field grown, 20'-22' height, full heads, triple Veitchia montgomeryana ELD NO 102 JAPANESE BLUEBERRY SHRUB Eleaocarpus dicipens 3 gallon, full, space 24" on center FGI NO 14 FICUS GREEN ISLAND Ficus macrocarpa 'Green Island' | 3 gallon, full, space 18" on center POD NO 25 PODOCARPUS 3 gallon, full, space 24" on center Podocarpus macrophyllus PSL YES 60 DWARF BAHAMA COFFEE Psychotria ligustrifolia 3 gallon, full, space 24" on center GROUNDCOVERS + ACCENTS TRA NO 500 JASMINE MINIMA Trachelospermum asiat 'Minima' 3 gallon, full, 12" on center LIR NO 220 LILY TURF 1 gallon, full, 18" on center

Carissa macro 'Emerald blanket' 3 gallon, full, 18" on center

DGA 3/8" DECOMPOSED GRANITE AGGREGATE OR STONE TO BE SELECTED, INSTALLED OVER FILTER FABRIC AND WEED BARRIER MATERIAL / OLIMAR, 2" MIN. DEPTH

BOTANICAL NAME

LANDSCAPE LEGEND

MIAMI BEACH LANDSCAPE ORDINANCE CHAPTER 28 (RS1 - RS3 Single Family Home Residential)

ACRES: .30

C.M.B. LARGE TREE PLANTING DETAIL

ZONING: RS-3

N.T.S.

LOT SIZE: 13,125 SF

FRONT YARD - 2 TREES REQUIRED / 4 TREES PROVIDED REAR YARD - 3 TREES REQUIRED / 5 TREES PROVIDED

TOTAL OF 5 TREES REQUIRED FOR LOTS UP TO 6,000 SF. 1 ADDITIONAL TREE REQUIRED FOR EACH ADDITIONAL 1,000 SF OF LOT AREA.

13,125 SF - 6,000 SF = 7,125 SF = 7 ADDITIONAL TREES + 5 REQUIRED TREES = 12 TOTAL TREES REQUIRED / 33 TREES PROVIDED (2 NATIVE SIMPSON STOPPER TREES, 1 FRANGIPANI TREE, AND 30 NATIVE BAY RUM TREES)

30% OF REQUIRED TREES OR .30 X 12 = 4 NATIVE TREES REQUIRED / 32 NATIVE TREES PROVIDED (2 NATIVE SIMPSON STOPPER TREES AND 30 NATIVE BAY RUM TREES)

LOW MAINTENANCE TREES 50% OF REQUIRED TREES OR .50 X 12 = 6 LOW MAINTENANCE TREES REQUIRED / 32 LOW MAINTENANCE TREES PROVIDED

STREET TREE REQUIREMENT AVERAGE STREET TREE SPACING 20' ON CENTER ROXBURY LANE: 105' LF / 20 = 5 STREET TREES REQUIRED / 4 STREET TREES PROVIDED (4 NATIVE MAHOGANY TREES AND 2 EXISTING ROYAL PALMS)

10 SHRUBS REQUIRED FOR EACH REQUIRED TREE or 10 X (12) = 120 SHRUBS REQUIRED / 201 SHRUBS PROVIDED

50% OF TOTAL SHRUBS REQUIRED MUST BE NATIVE or .50 X 120 = 60 NATIVE SHRUBS REQUIRED / **60 NATIVE SHRUBS PROVIDED**

<u>LARGE SHRUBS / SMALL TREES</u>

10% OF TOTAL SHRUBS REQUIRED MUST BE LARGE SHRUBS OR SMALL TREES or .10 X 120 = 12 LARGE SHRUBS REQUIRED / 102 LARGE SHRUBS PROVIDED

NATIVE LARGE SHRUBS / SMALL TREES

50% OF TOTAL LARGE SHRUBS REQUIRED MUST BE NATIVE or .50 X 12 = 6 NATIVE LARGE SHRUBS REQUIRED / 21 NATIVE LARGE SHRUBS / SMALL TREES PROVIDED

50% MAXIMUM OF LANDSCAPE AREA: NEW LAWN AREAS ARE LESS THAN 50% OF LANDSCAPE AREA

100% COVERAGE PROVIDED PURSUANT TO MIAMI DADE CODE

SCALE + NORTH ARROW:

DATE:

AUGUST 5, 2019 SHEET NO:

CHRISTOPHER CAWLEY LANDSCAPE ARCHITECTURE LLC 780 NE 69TH STREET

SUITE 1106 MIAMI, FL 33138 O 786.534.5327 C 305.979.1585 CHRISTOPHERCAWLEY.COM Florida Landscape Architecture Business LC

REVISION SCHEDULE

SHEET TITLE:

LANDSCAPE DETAILS

ALMA

Florida License LA 6666786



CHRISTOPHER CAWLEY LANDSCAPE ARCHITECTURE LLC 780 NE 69TH STREET
SUITE 1106 MIAMI, FL 33138
O 786.534.5327
C 305.979.1585 CHRISTOPHERCAWLEY.COM

Florida Landscape Architecture Business LC 26000460

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SHEET TITLE:

PLANT MATERIAL IMAGES


SCALE + NORTH ARROW:

AUGUST 5, 2019

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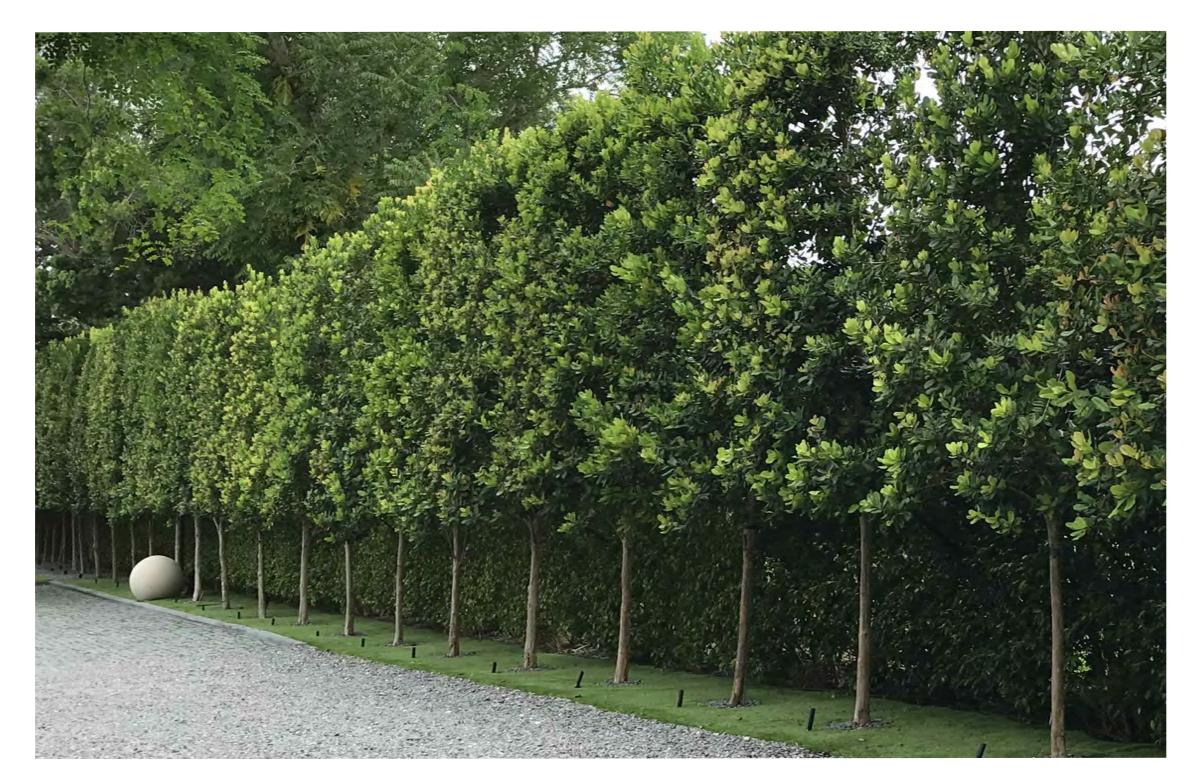





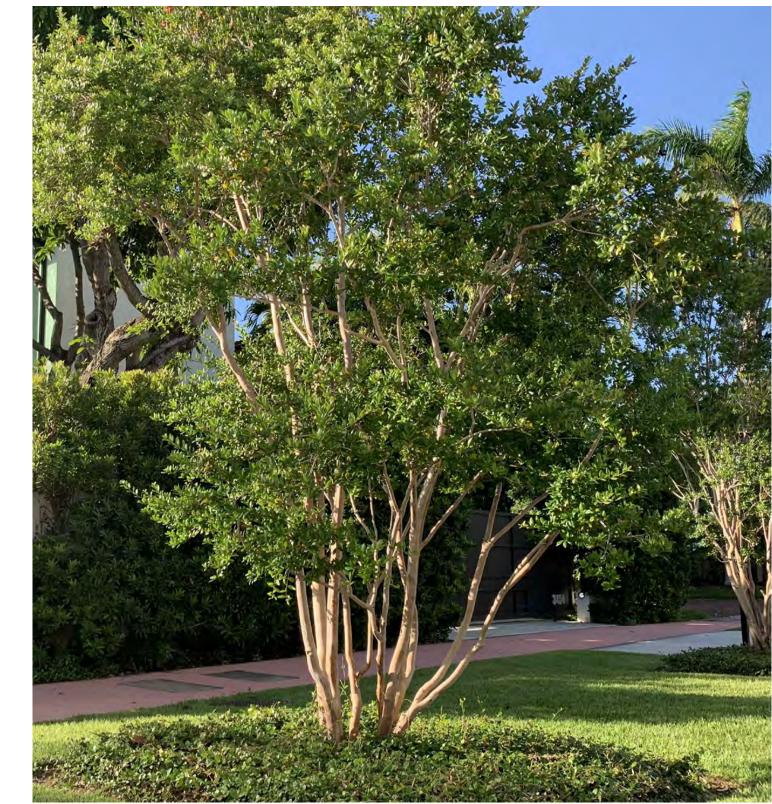

PL / SCULPTURAL PLUMERIA TREE

MF / MULTI-TRUNK SIMPSON STOPPER TREE



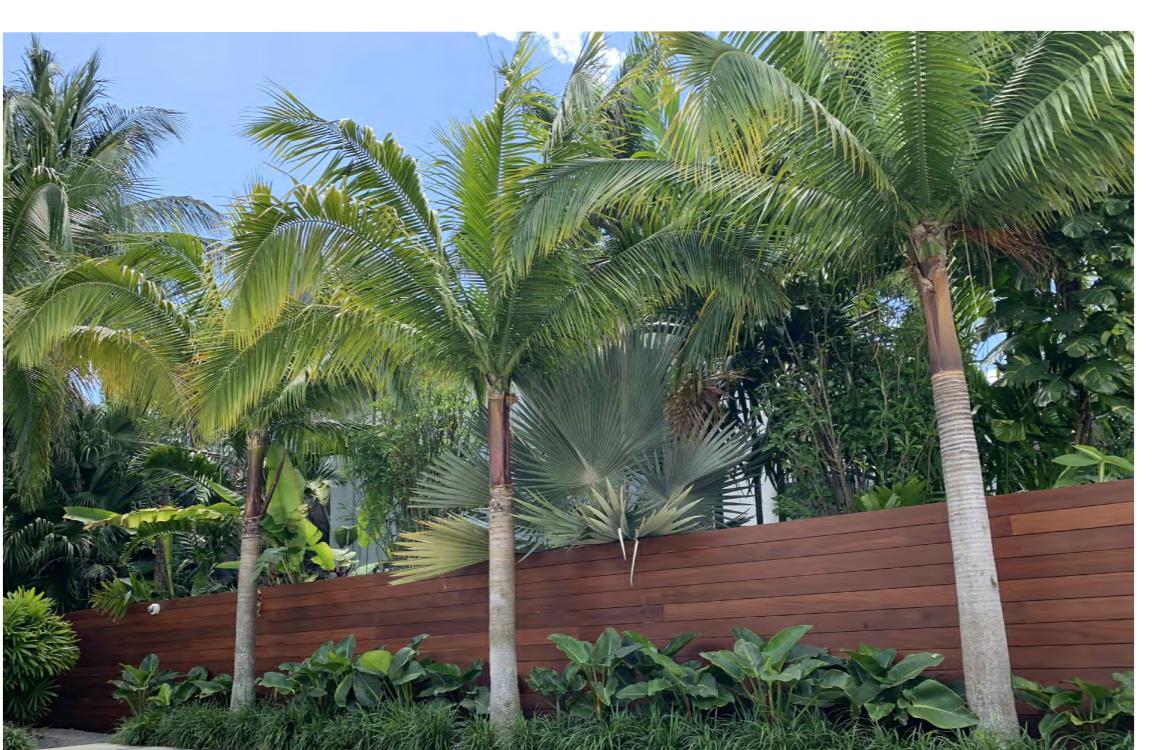

PR / NATIVE BAY RUM TREES AGAINST TALL EVERGREEN HEDGE

SL / SATAKENTIA PALMS WITH LOW EVERGREEN LIRIOPE GROUNDCOVER

FRONT ELEVATION - VIEW FROM ROXBURY LANE

FRONT ELEVATION - VIEW FROM AUTOCOURT

AUGUST 5, 2019 SHEET NO:



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SHEET TITLE:

FRONT ELEVATIONS

780 NE 69TH STREET
SUITE 1106 MIAMI, FL 33138
O 786.534.5327
C 305.979.1585

CHRISTOPHERCAWLEY.COM

Florida Landscape Architecture Business LC 26000460

ELEVATIONS

SIDE

REVISION SCHEDULE

SHEET TITLE:

SCALE + NORTH ARROW:





NORTH SIDE ELEVATION



SOUTH SIDE ELEVATION

780 NE 69TH STREET
SUITE 1106 MIAMI, FL 33138
O 786.534.5327
C 305.979.1585

CHRISTOPHERCAWLEY.COM
Florida Landscape
Architecture Business LC
26000460

REVISION SCHEDULE

REAR

ELEVATION

SHEET TITLE:

CHRISTOPHER CAWLEY, RLA Florida License LA 6666786

AUGUST 5, 2019
SHEET NO:

L-4.2



REAR ELEVATION