
FINK - RESIDENCE

3167 ROYAL PALM AVENUE,

MIAMI BEACH, FL. - 33140

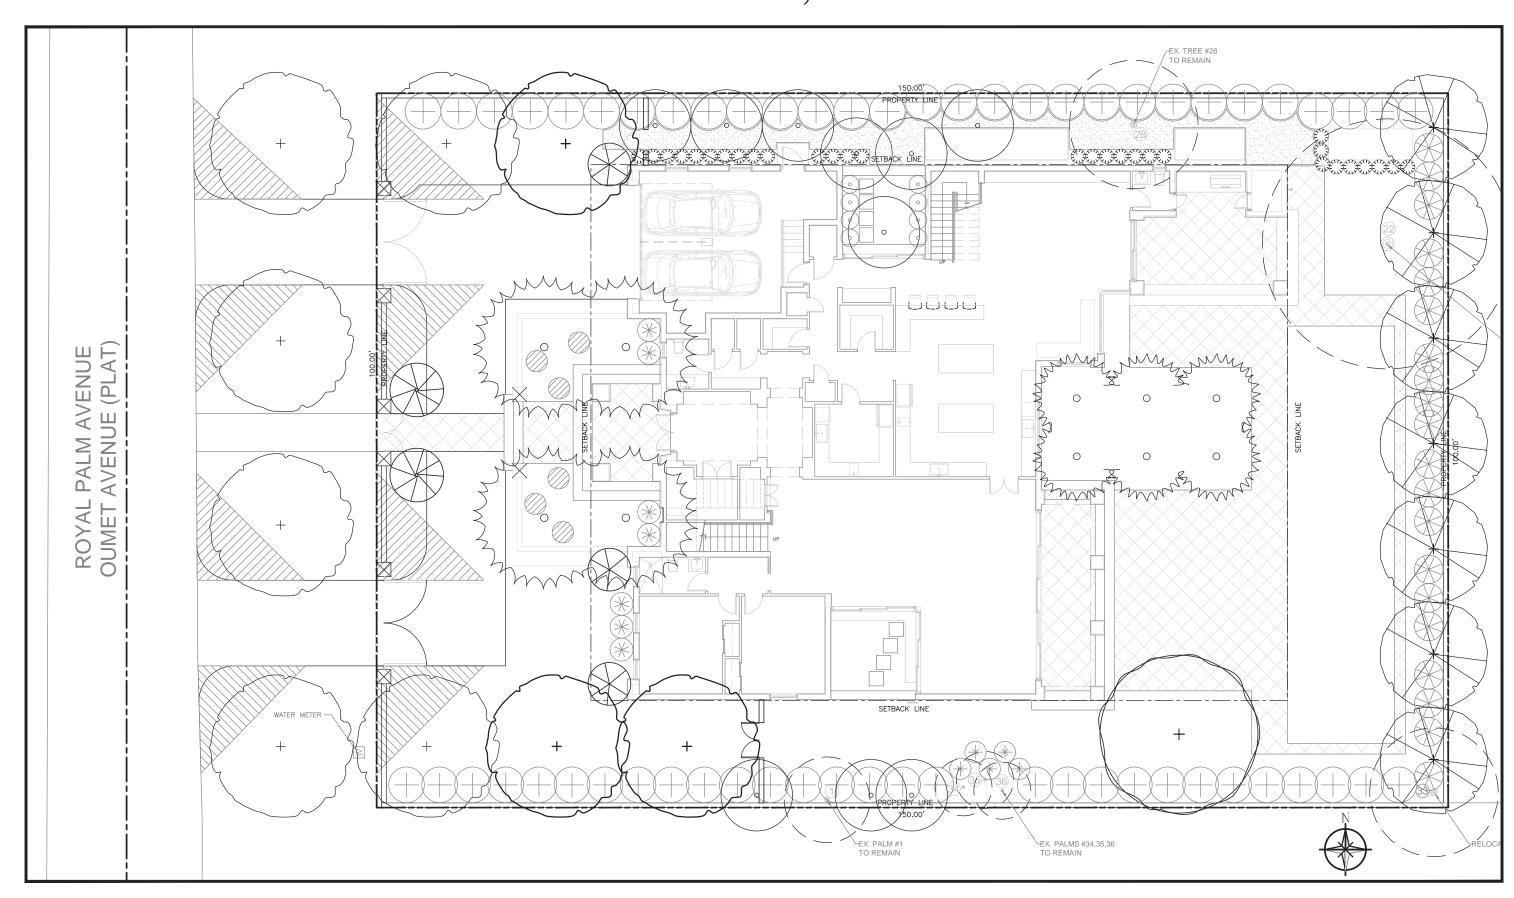

FINAL SUBMITTAL

INDEX

- TD-1 TREE DISPOSITION PLAN
- TR-1 TREE REPLACEMENT PLAN
- TM-1 TREE MITIGATION PLAN
- L-1 LANDSCAPE PLAN
- L-1 RENDERED LANDSCAPE PLAN
- L-2 PLANT LIST AND PLANTING DETAILS
- L-3 LANDSCAPE SPECIFICATION
- L-4 LANDSCAPE LIGHTING PLAN
- IB-1 IMAGE BOARD



FAX: (305) 661-1865

IMAGE BOARD

TREES AND PALMS



Alexander Palm




Coccothrinax Angentata



Phoenix Sylvestris



False Tamarind

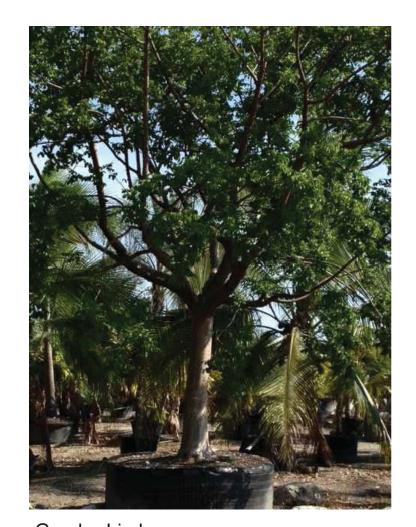

Gumbo Limbo



Japanese Blueberry Cone




Japanase Privet



Satin Leaf Tree

SHRUBS AND GROUNDCOVER

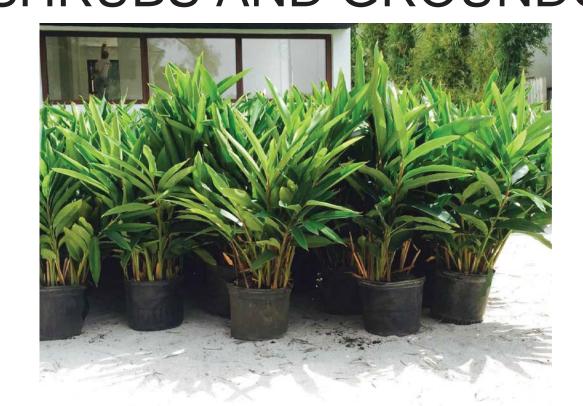

Green Shell Ginger



Green Buttonwood



Green Island Ficus



Wild Coffee



IMAGE BOARD


Monstera



Boston Fern



Philodendron"Rojo Congo"

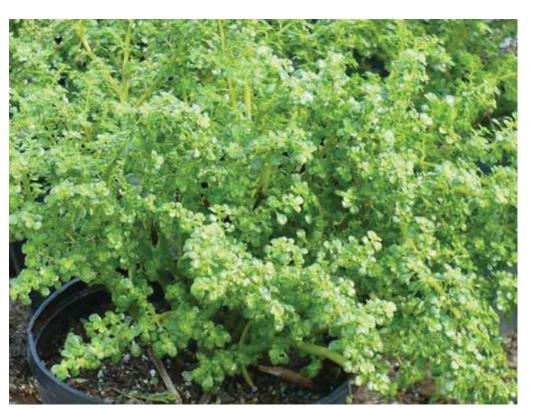


Pilea Fern



Rhapis Excelsa



Vreisia Imperialis

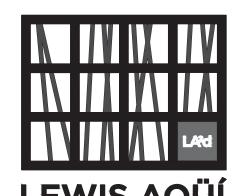

LEWIS AQÜÍ

LANDSCAPE + ARCHITECTURAL DESIGN,
LLC

LC 26000479
7408 B SW 48th STREET
MIAMI, FL 33155
PHONE: (305) 661-1855
FAX: (305) 661-1865

Z.W. JAROSZ ARCHI
3 3 2 6 M A R Y S T R E E T
C O C O N U T G R O V E , F L O
3 0 5 . 4 4 6 . 0 8 8 8 W W W . J A R C

FINK RESIDENCE
3167 Royal Palm Avenue,
Miami Beach, FL. 33140

Digitally signed by LEWIS AQUI Date: 2019.04.30 16:13:18 -04'00'

REVISIONS

NO. DATE DESCRIPTION

COPYRIGHT 2018 ALL RIGHTS RESERVED. THESE DR.
AND SPECIFICATIONS ARE INSTRUMENTS OF SERVICE
SHALL REMAIN THE PROPERTY OF Z.W. JAROSZ ARCHITE
IS EXECUTED OR NOT, THEY ARE NOT TO BE USED
MANNER ON OTHER PROJECTS OR EXTENSIONS T
PROJECT EXCEPT BY ACREEMENT IN WRITING AND WI
APPROPRIATE COMPENSATION TO Z.W. JAROSZ ARCHITE
REPRODUCTIONS OF DRAWINGS AND SPECIFICA
WITHOUT THE WRITTEN CONSEN
Z.W. JAROSZ ARCHITECTS, P.A. IS PROHIE
CONTRACTOR IS RESPONSIBLE FOR VERIFYING AL
CONTRACTOR IS RESPONSIBLE FOR VERIFYING AL
CONTRACTOR IS RESPONSIBLE FOR VERIFYING AL
CONDITIONS PRIOR TO PROCEEDING WITH


DATE: 04/08/19

DRAWN BY: LG

CHECKED BY: LA

SCALE: AS SHOWN

IB-1

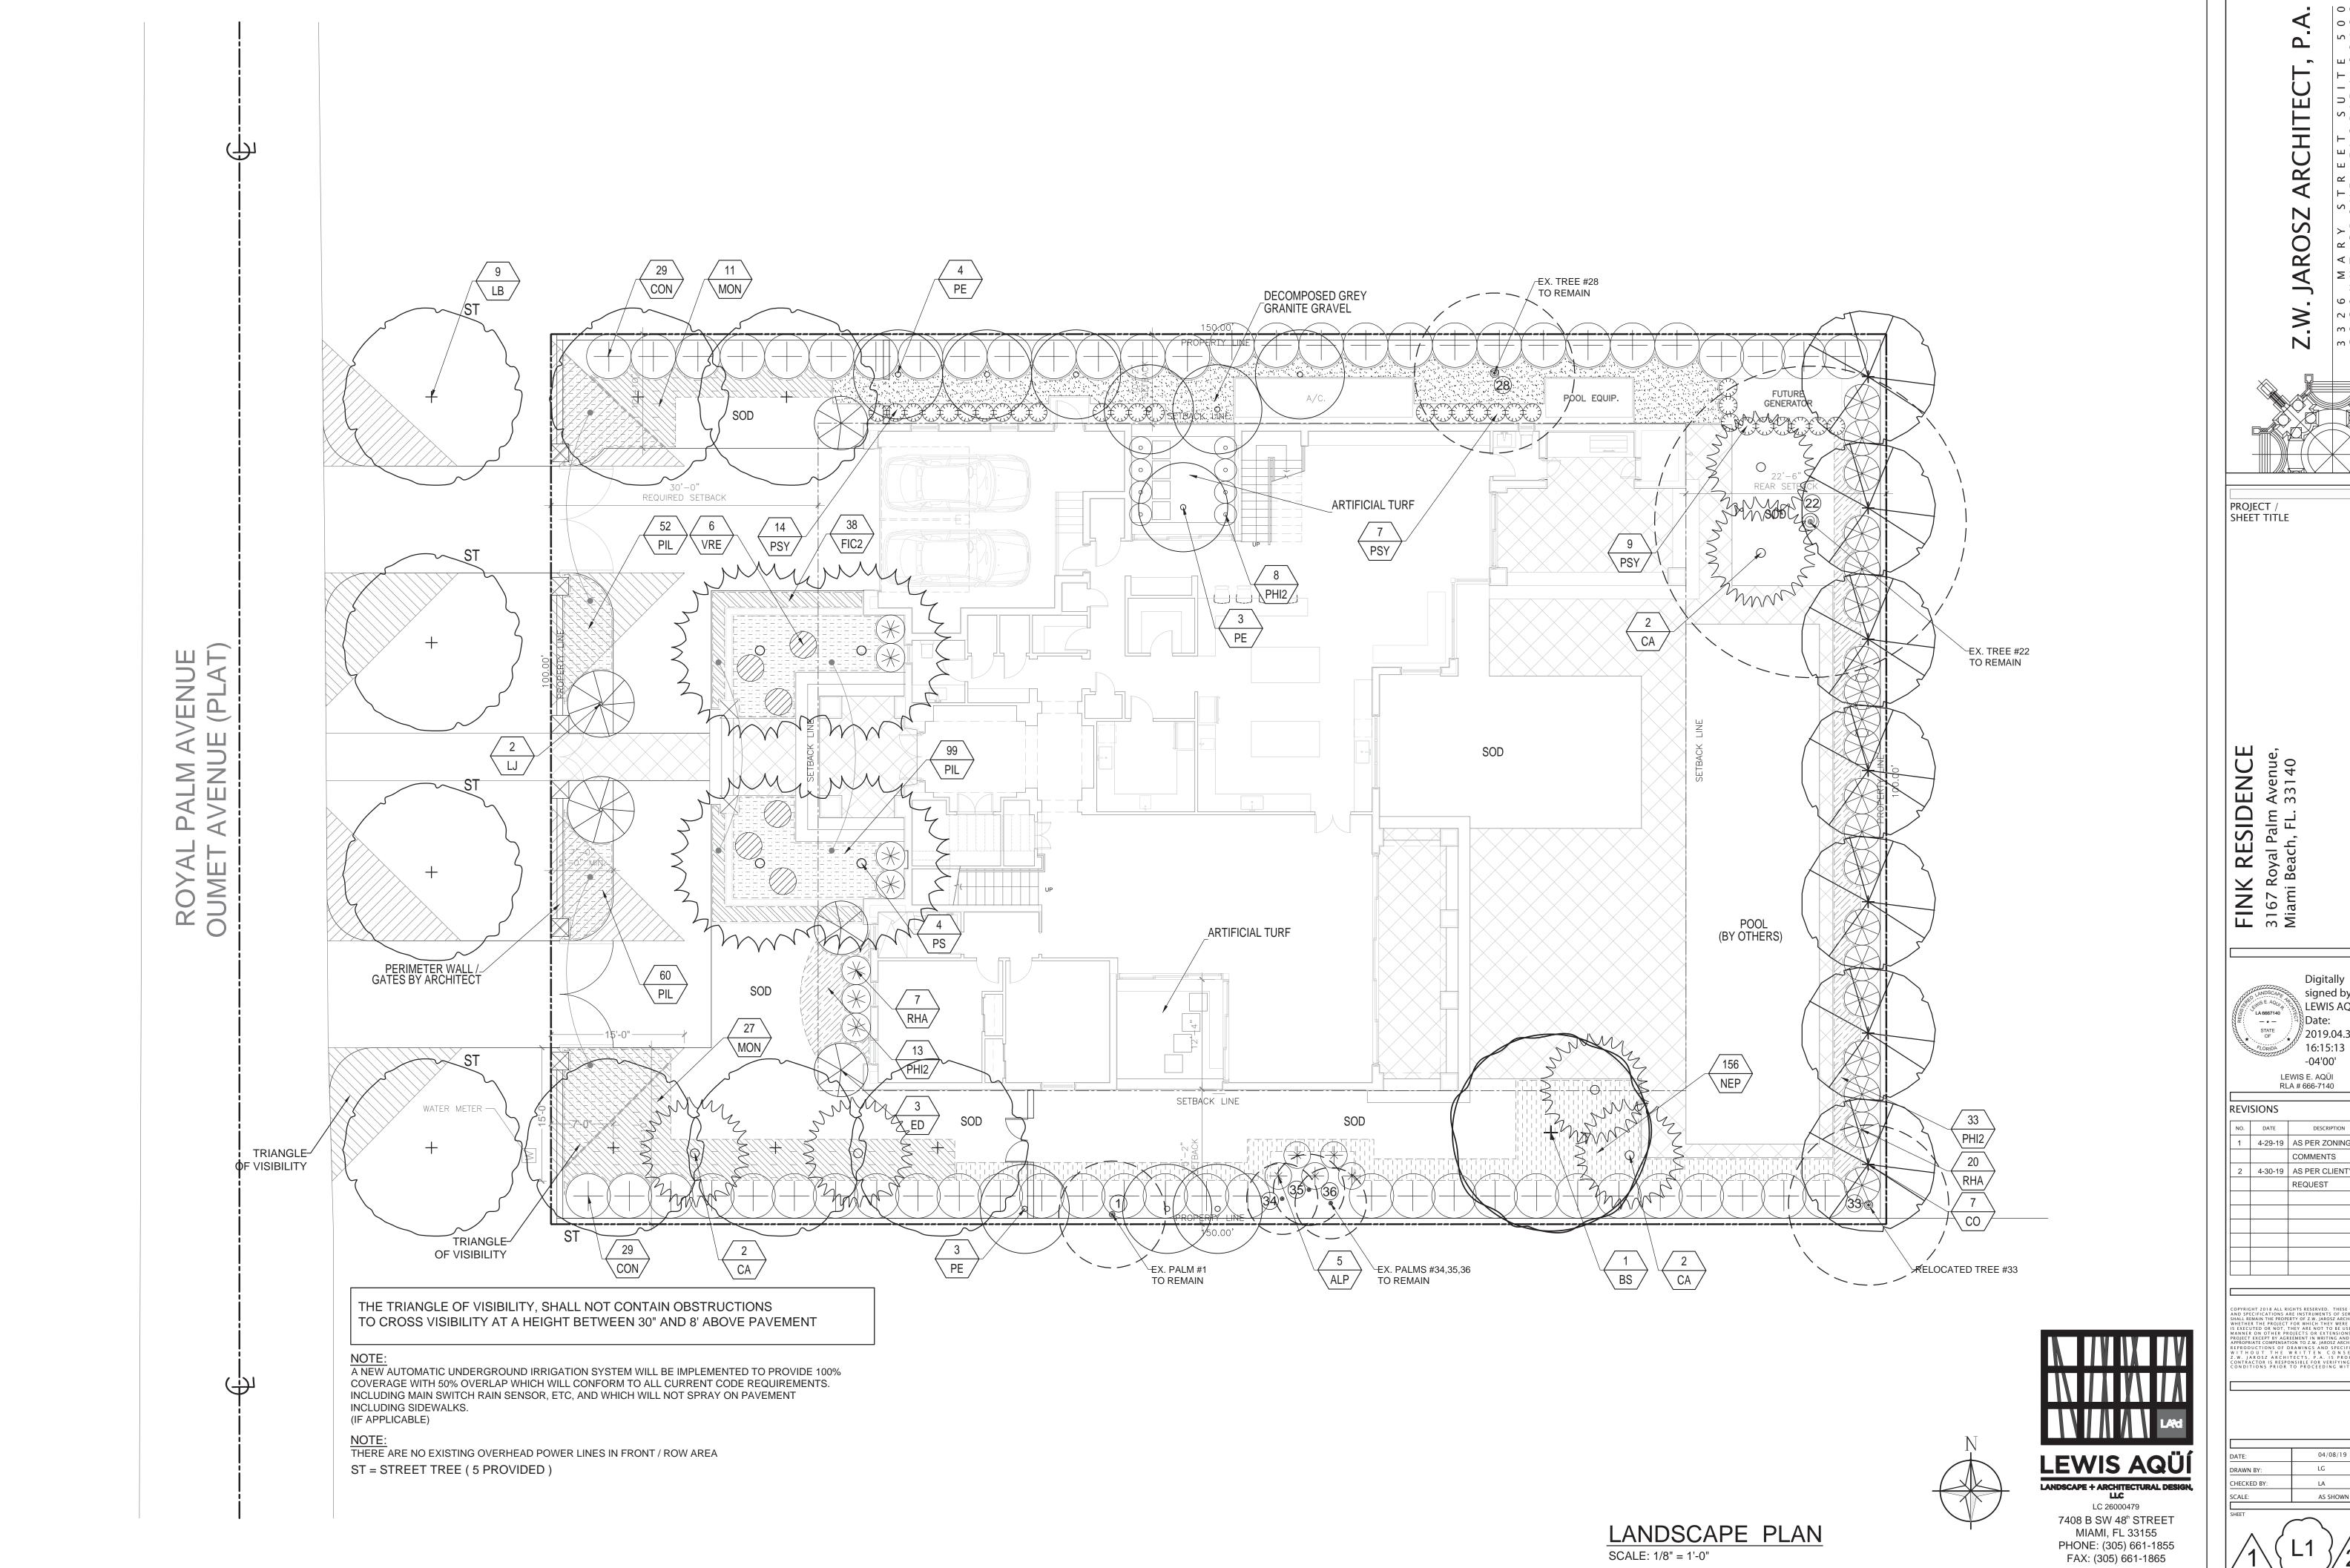

0 0 4


Digitally signed by LEWIS AQUI Date: 2019.04.30 16:15:13

-04'00'

1 4-29-19 AS PER ZONING COMMENTS 2 4-30-19 AS PER CLIENT'S

04/08/19

AS SHOWN

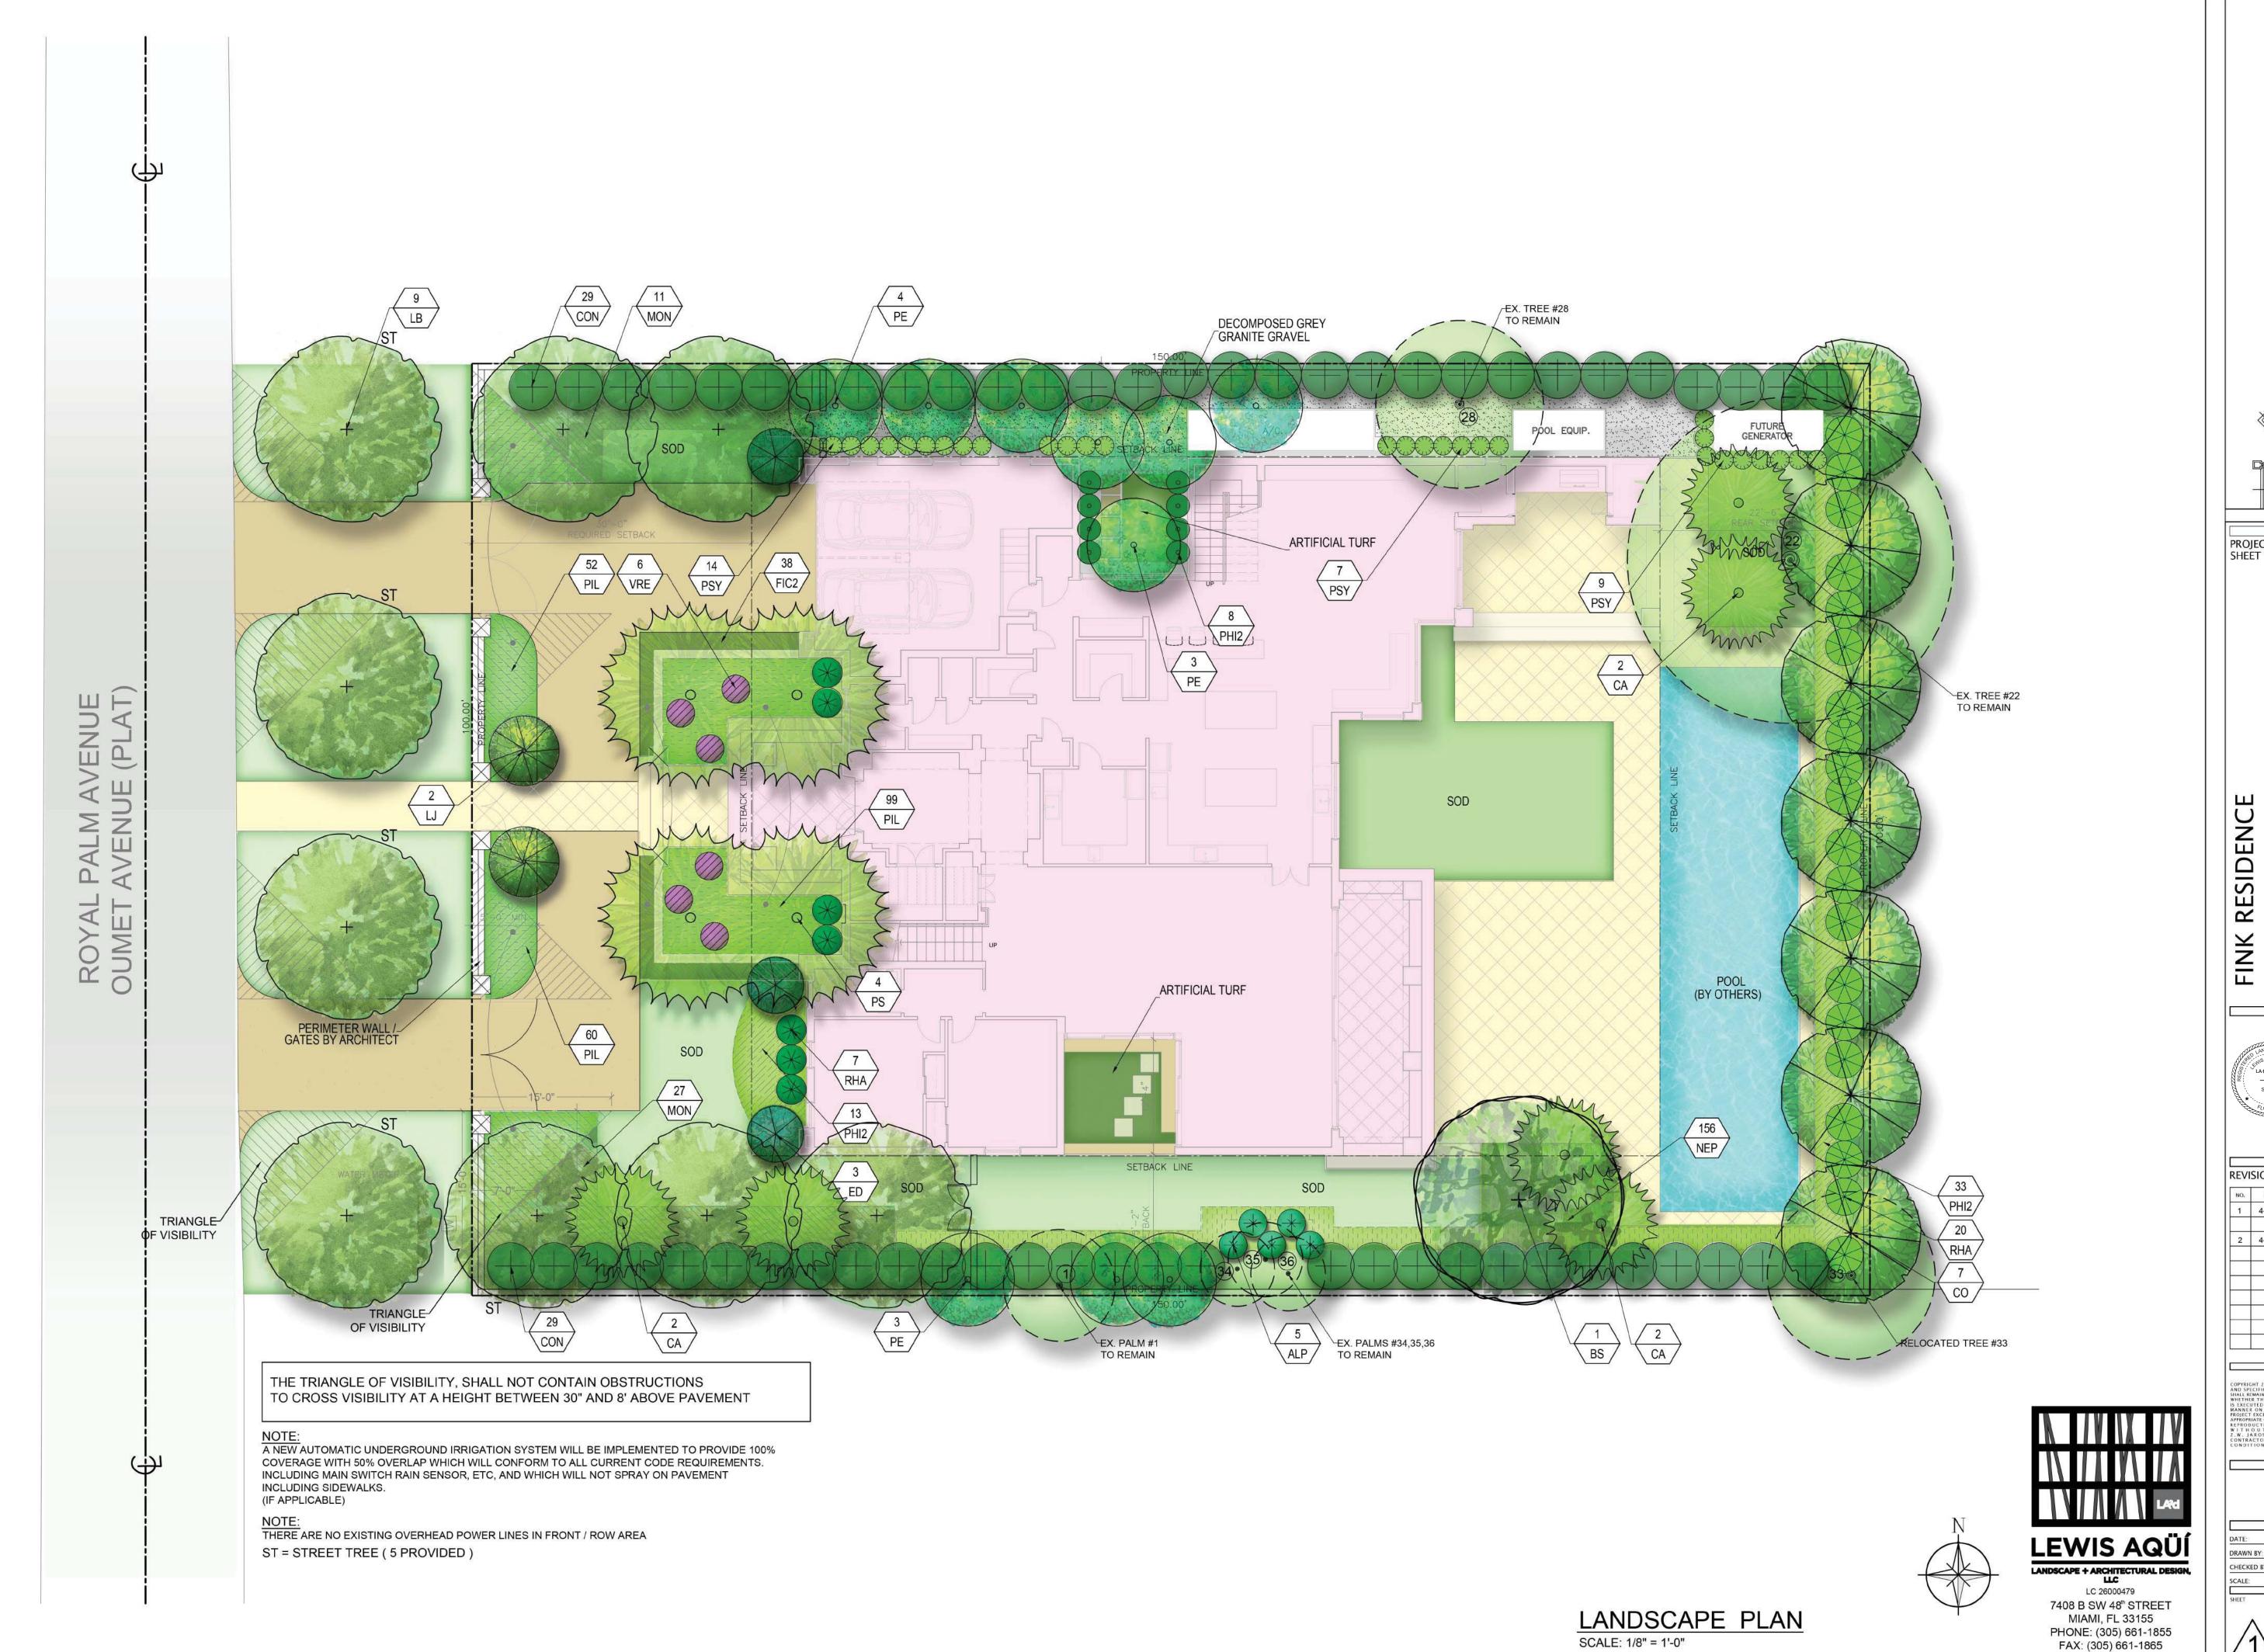

ARCHITEC **JAROSZ** 9 0 4

PROJECT / SHEET TITLE

FINK RESIDENCE
3167 Royal Palm Avenue,
Miami Beach, FL. 33140

Digitally signed by LEWIS AQUI

LA 6667140


Date:


STATE
OF 2019.05.01 LEWIS AQUI -04'00'

LEWIS E. AQÜI RLA # 666-7140

REVISIONS 1 4-29-19 AS PER ZONING COMMENTS 2 4-30-19 AS PER CLIENT'S REQUEST

04/08/19 CHECKED BY: AS SHOWN

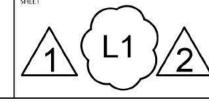


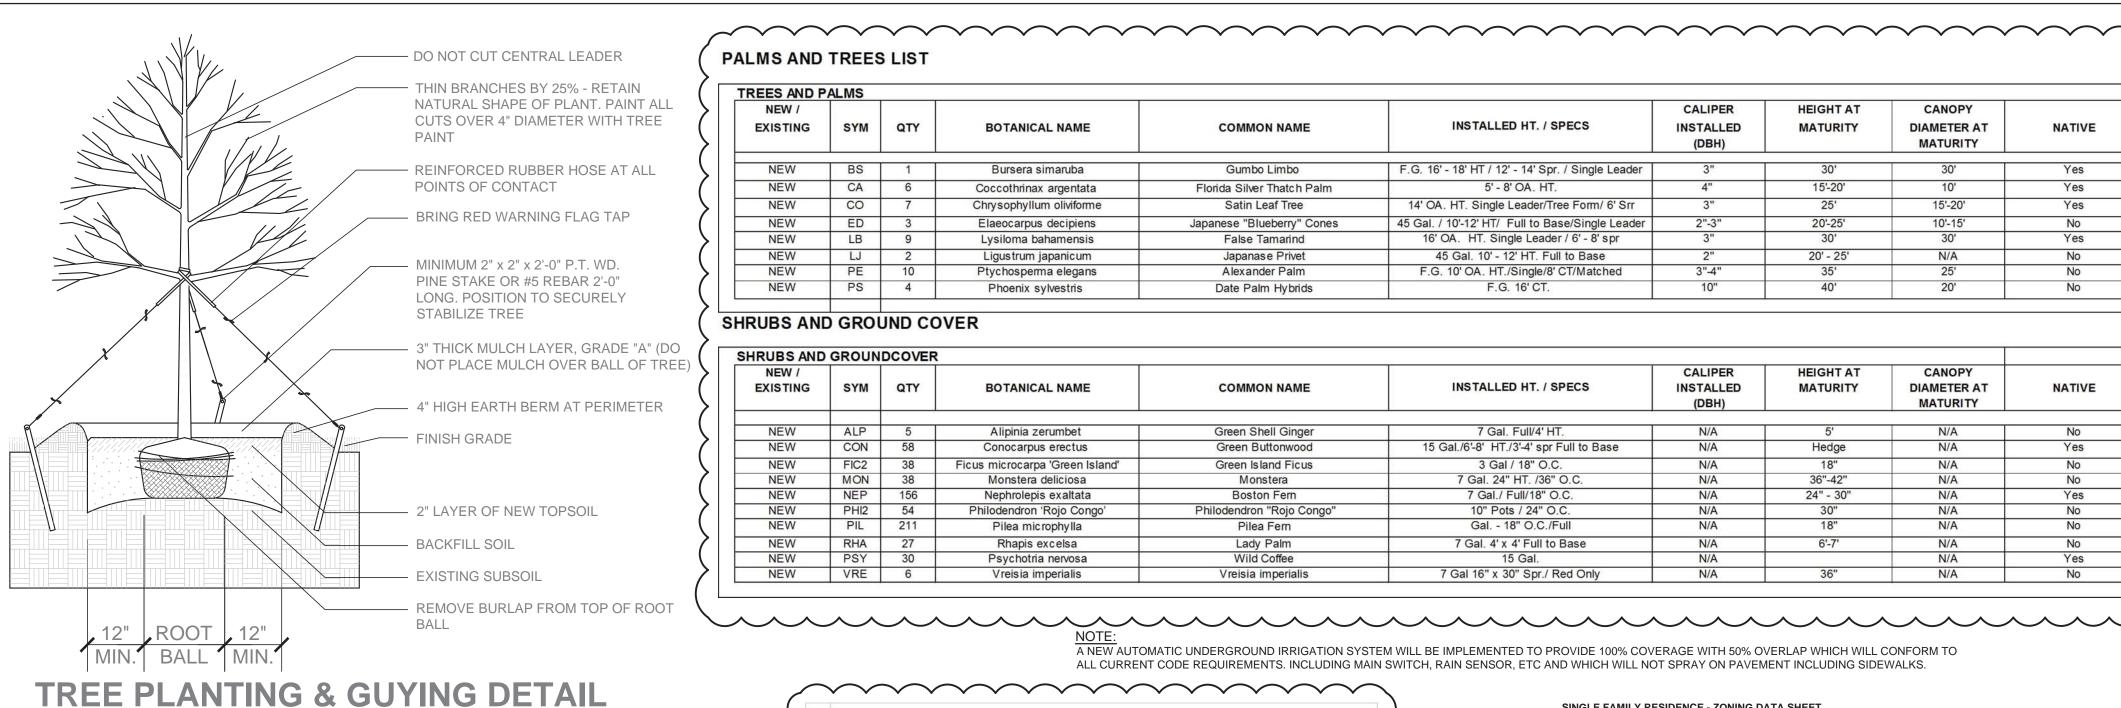

	N.T.S.
	DO NOT CUT CENTRAL LEADER
	THIN BRANCHES BY 25% - RETAIN NATURAL SHAPE OF PLANT. PAINT ALL CUTS OVER 4" DIAMETER WITH TREE PAINT GUY WIRE - #12 DOUBLE STRAND TWISTED - WRAP TWICE AROUND TREE TRUNK W/ REINFORCED RUBBER HOSE AT ALL POINTS OF CONTACT, ATTACH WIRE TO STAKES.
	- MINIMUM 2" x 2" x 6'-0" P.T. WOOD PINE STAKES OR #5 REBAR, (THREE PER TREE), POSITION TO SECURELY STABILIZE TREE
% OF TREE HEIGHT MAX	- 3" THICK MULCH LAYER, GRADE "A" (DO NOT PLACE MULCH OVER BALL OF TREE)
HEIGO HEIGO	- 4" HIGH EARTH BERM AT PERIMETER - FINISH GRADE
	NOTE: TREES OF SAME SPECIES TO BE MATCHED IN GROWTH CHARACTER
- N W N - 0 - 0 - 0 - 0 - 0 - 0 - 0 - 0 - 0 -	- 2" LAYER OF NEW TOPSOIL
2 2	- BACKFILL SOIL
	- EXISTING SUBSOIL
9" PLANT 9"	REMOVE BURLAP FROM TOP OF ROOT BALL
MIN. BALL MIN.	

SPECIMEN TREE GUYING DETAIL

N.T.S.

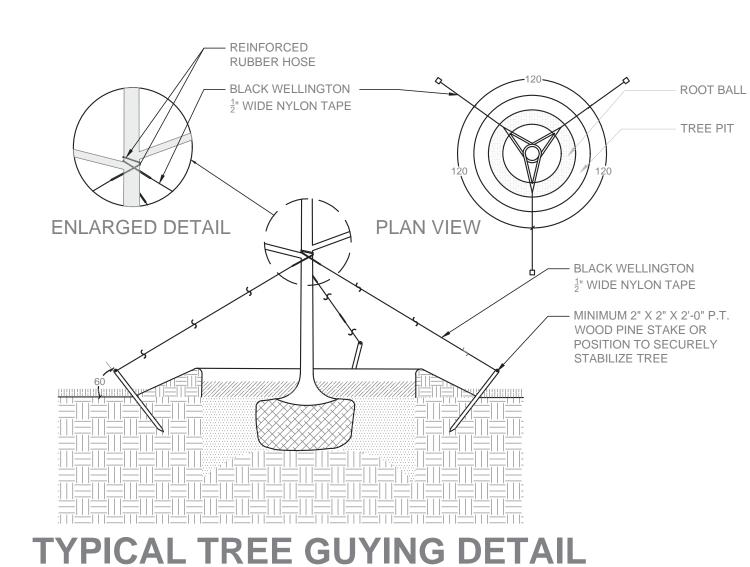

N.T.S.

PALMS AND TREES LIST

TREES AND P	PALMS								
NEW /						CALIPER	HEIGHT AT	CANOPY	
EXISTING	SYM	QTY	BOTANICAL NAME	COMMON NAME	INSTALLED HT. / SPECS	INSTALLED (DBH)	MATURITY	DIAMETER AT MATURITY	NATIVE
NEW	BS	1	Bursera simaruba	Gumbo Limbo	F.G. 16' - 18' HT / 12' - 14' Spr. / Single Leader	3"	30'	30'	Yes
NEW	CA	6	Coccothrinax argentata	Florida Silver Thatch Palm	5' - 8' OA. HT.	4"	15'-20'	10'	Yes
NEW	co	7	Chrysophyllum oliviforme	Satin Leaf Tree	14' OA. HT. Single Leader/Tree Form/ 6' Srr	3"	25'	15'-20'	Yes
NEW	ED	3	Elaeocarpus decipiens	Japanese "Blueberry" Cones	45 Gal. / 10'-12' HT/ Full to Base/Single Leader	2"-3"	20'-25'	10'-15'	No
NEW	LB	9	Lysiloma bahamensis	False Tamarind	16' OA. HT. Single Leader / 6' - 8' spr	3"	30'	30'	Yes
NEW	LJ	2	Ligustrum japanicum	Japanase Privet	45 Gal. 10' - 12' HT. Full to Base	2"	20' - 25'	N/A	No
NEW	PE	10	Ptychosperma elegans	Alexander Palm	F.G. 10' OA. HT./Single/8' CT/Matched	3"-4"	35'	25'	No
NEW	PS	4	Phoenix sylvestris	Date Palm Hybrids	F.G. 16' CT.	10"	40'	20'	No

SHRUBS AND GROUND COVER

CITY OF MIAMI BEACH

LANDSCAPE LEGEND

LAWN AREA CALCULATION

Zoning District____RS-4_____ Lot Area _15,000 SF___

A. Square feet of required Open Space as indicated on site plan: Lot Area = ______ s.f.x ______ % = _____ s.f.

Number of parking spaces _____ x 10 s.f. parking space =

B. Maximum lawn area (sod) permitted=___50___ % x 15,000 s.f.

A. Number of trees required per lot or net lot acre, less existing number

___14____ trees x ______ net lot acres - number of existing trees= 12

C. Total square feet of landscaped open space required: A+B=

A. Square feet of landscaped open space required

of trees meeting minimum requirements=

B. % Natives required: Number of trees provided x 30% =

D. Street Trees (maximum average spacing of 20' o.c.)

C. % Low maintenance / drought and salt tolerant required:

_____99.84_____ linear feet along street divided by 20'=

linear feet along street divided by 20'=

A. Number of shrubs required: Sum of lot and street trees req. x 12=

A. Number of large shrubs or small trees required: Number of required

B. | % Native large shrubs or small trees required: Number of large shrubs

899.28 sf

2,100.72 sf

2,250.00 sf

674.56 sf

1,575.44 sf

B. % Native shrubs required: Number of shrubs provided x 50%=

E. Street tree species allowed directly beneath power lines:

(14 Trees minus 2 existing = 12)

Number of trees provided x 50%=

LARGE SHRUBS OR SMALL TREES

or small trees provided x 50%=

-LANDSCAPE PERVIOUS AREA:

REAR YARD CALCULATIONS

-LANDSCAPE PERVIOUS AREA:

PLANT MATERIAL SHALL NOT BE PRUNED ____

HAVE BEEN INSTALLED, EACH PLANT

SHALL BE PRUNED FOR UNIFORMITY.

PRIOR TO INSTALLATION. AFTER PLANTS

-IMPERVIOUS AREA:

-IMPERVIOUS AREA:

B. Square feet of parking lot open space required as indicated on site


HRUBS AND	GROUN	DCOVER						U*	
NEW / EXISTING	SYM	QTY	BOTANICAL NAME	COMMON NAME	INSTALLED HT. / SPECS	CALIPER INSTALLED (DBH)	HEIGHT AT MATURITY	CANOPY DIAMETER AT MATURITY	NATIVE
						10 10 10 10	\ -	*	
NEW	ALP	5	Alipinia zerumbet	Green Shell Ginger	7 Gal. Full/4' HT.	N/A	5'	N/A	No
NEW	CON	58	Conocarpus erectus	Green Buttonwood	15 Gal./6'-8' HT./3'-4' spr Full to Base	N/A	Hedge	N/A	Yes
NEW	FIC2	38	Ficus microcarpa 'Green Island'	Green Island Ficus	3 Gal / 18" O.C.	N/A	18"	N/A	No
NEW	MON	38	Monstera deliciosa	Monstera	7 Gal. 24" HT. /36" O.C.	N/A	36"-42"	N/A	No
NEW	NEP	156	Nephrolepis exaltata	Boston Fern	7 Gal./ Full/18" O.C.	N/A	24" - 30"	N/A	Yes
NEW	PHI2	54	Philodendron 'Rojo Congo'	Philodendron "Rojo Congo"	10" Pots / 24" O.C.	N/A	30"	N/A	No
NEW	PIL	211	Pilea microphylla	Pilea Fern	Gal 18" O.C./Full	N/A	18"	N/A	No
NEW	RHA	27	Rhapis excelsa	Lady Palm	7 Gal. 4' x 4' Full to Base	N/A	6'-7'	N/A	No
NEW	PSY	30	Psychotria nervosa	Wild Coffee	15 Gal.	N/A		N/A	Yes
NEW	VRE	6	Vreisia imperialis	Vreisia imperialis	7 Gal 16" x 30" Spr./ Red Only	N/A	36"	N/A	No

NOTE: A NEW AUTOMATIC UNDERGROUND IRRIGATION SYSTEM WILL BE IMPLEMENTED TO PROVIDE 100% COVERAGE WITH 50% OVERLAP WHICH WILL CONFORM TO ALL CURRENT CODE REQUIREMENTS. INCLUDING MAIN SWITCH, RAIN SENSOR, ETC AND WHICH WILL NOT SPRAY ON PAVEMENT INCLUDING SIDEWALKS.

1,426.05 SF	1 ADDRESS AND LIGAL DESCRIPTION 216F Roys Pain Avenue, More Bash, Fi. 2140. LOT 16 AND 16, E. ACOL 46, DREMARD SIMPROCENNA 1, ACCORDING TO THE PLATFIERED AND ARROWS AND FILE ANTHERED AND ARROWS AND FILE AND ARROWS AND ARROWS AND FILE AND ARROWS AND FILE AND ARROWS AND FILE AND ARROWS)	SINGLE FAMILY RESI	DENCE - ZONING D	PATA SHEET		
REQUIRED PROVIDED	COT 1 AND 16 IN DOCAS CORPORT SURPRISED AND SURPRISED AN				ITEM	# ZONING INFORMATION				
REQUIRED PROVIDED	COT 1 AND 16 IN DOCAS CORPORT SURPRISED AND SURPRISED AN									
REQUIRED / ALLOWED PROVIDED REPRET TOSITE DATA BY ARCHITECTS N/A N/A REFER TOSITE DATA BY ARCHITECTS 7, 500 SF 1, 426,05 SF 1 1 12 12 12 12 13 3 12 12 15 5 5 5 5 5 5 5 5 5 5 5 5 5 5 5	To the Part Triester Add Recorded on Part Triester Add Sections of MAN INCIDENT CONTROL From The Part Triester Add Recorded on Part Triester Add Triester Triest				1	ADDRESS AND LEGAL DESCRIPTION	3167 Royal Palm Avenue	e, Miami Beach, FL 33140.		
RECURRED / ALLOWED PROVIDED	REPRITORIED ALLOWED PROVIDED	es	0.34		{		TO THE PLAT THEREOF	F AS RECORDED IN PLAT BOOK	6, PAGE 111, OF	
PRINT PRIN	REFER TO SITE DATA			DROVIDED	/					
BYARCHIECIS N/A N/	Section Sect		ALLOWED	PROVIDED)					
N/A	S				2	FOLIO NUMBER(S):	02-3227-001-0610			
NA NA NA REFER TO SITE DATA BY ARCHITECTS	N/A N/A REFER TOSITE DATA BY ARCHITECTS S BASE PLODO ELEVATION AE 8.007 GRADE VALUE IN NOVID S S S S S S S S S		REFER TO SITE DATA	BY ARCHITECTS	3	BOARD AND FILE NUMBERS:	N/A			
REFER TOSITE DATA	REPERTOSITE DATA SYARCHITECTS				4	-YEAR BUILT:-	N/A	ZONING DISTRICT:		RS-4
Total Control Contro	Total		N/A	N/A	5	BASE FLOOD ELEVATION:	AE 8.00'	GRADE VALUE IN NGVD:		3.89'
REFER TO SITE DATA BYARCHITECTS 7,500 SF 1,426.05 SF 1,246.05	REFER TOSITE DATA BY ARCHITECTS 7,500 SF 1,426.05		REFER TO SITE DATA	BY ARCHITECTS	6	ADJUSTED GRADE (FLOOD + GRADE /2):	5.94' NGVD	FREEBOARD:		9.00' NGVD
NA	NAX NA NA NA NA NA NA NA				7	LOT AREA:	15,000 SF			
7,500 SF 1,426.05 SF 10	7,500 SF				8	LOT WIDTH:	100'-0"	LOT DEPTH:		150'-0"
1	11		REFER TO SITE DATA	BY ARCHITECTS	9	MAX LOT COVERAGE SF AND %:	4,500 SF (30%)	PROPOSED LOT COVERAGI	E SF AND%:	4,184.04 SF (27.89%
12 MAX UNIT SIZE SF AND %: 7.500 SF (50%) PROPOSED UNIT SIZE SF AND %: 7.400.86 (49.93%) 13 ENDITING FIRST FLOOR UNIT SIZE: 4.084.87 SF 14 PROPOSED FIRST FLOOR UNIT SIZE SF AND %: 4.084.87 SF 14 PROPOSED SERIEST FLOOR UNIT SIZE SF AND %: 4.084.87 SF FROM %: NOTE: 10 EXCELO TO NO.07 UNIT SIZE SF AND %: NOTE: 10 EXCELO TO NO.07 UNIT SIZE SF AND %: NOTE: 10 EXCELO TO NO.07 UNIT SIZE SF AND %: NOTE: 10 EXCELO TO NO.07 UNIT SIZE SF AND %: NOTE: 10 EXCELO TO NO.07 UNIT SIZE SF AND %: NOTE: 10 EXCELO TO NO.07 UNIT SIZE SF AND %: NOTE: 10 EXCELO TO NO.07 UNIT SIZE SF AND %: NOTE: 10 EXCELO TO NO.07 UNIT SIZE SF AND %: NOTE: 10 EXCELO TO NO.07 UNIT SIZE SF AND %: NOTE: 10 EXCELO TO NO.07 UNIT SIZE SF AND %: NOTE: 10 EXCELO TO NO.07 UNIT SIZE SF AND %: NOTE: 10 EXCELO TO NO.07 UNIT SIZE SF AND %: NOTE: 10 EXCELO TO NO.07 UNIT SIZE SF AND %: 15.20 SIZE SIZE SERIES S	12		7,500 SF	1,426.05 SF	10	-EXISTING LOT COVERAGE SF AND %:	N/A	LOT COVERAGE DEDUCTED) (GARAGE) SF AND %:	190 SF
13	13				11	FRONT YARD OPEN SPACE SF AND %:	2,100.72 SF (70%)	REAR YARD OPEN SPACE S	SF AND %:	1575.44 SF (70.01%
PROPOSED FIRST FLOOR UNIT SIZE VOLUMETRIC:	12 12 12 14				12	MAX UNIT SIZE SF AND %:	7,500 SF (50%)	PROPOSED UNIT SIZE SF A	ND %:	7,490.88 (49.93%)
## 12 12 14	12 12 14	er			13	-EXISTING FIRST FLOOR UNIT SIZE:	N/A	PROPOSED FIRST FLOOR L	JNIT SIZE:	4,084.87 SF
AND % (NOTE: TO EXCEED 70% OF THE FIRST FLOOR OF THE MAIN HOME REQUIRE ORS APPROVAL)	AND % (NOTE: DECREED 7%) of THE FIRST FLOOR OF THE MAN HOME REQUIRED BY APPROVALE TO THE MAN HOME REQUIRE DREAPPROVALE IS 3,406.01 SF PROPOSED SECOND FLOOR UNIT SIZE: 3,406.01 SF PROPOSED SECOND FLOOR UNIT SIZE: 1,406.01 SF PROPOSED SECOND FLOO)			PROPOSED FIRST FLOOR L	INIT SIZE VOLUMETRIC:	4,584.87 SF
15	15	5= 12 12		14			AND % (NOTE: TO EXCEED 70% OF THE FIRST FLOOR OF		3,426.76 SF (74.74%	
12	12				15	\dashv		l	<u> </u>	3.406.01 SF
12 12 16 27-0"	12		3	12						
16	16 27-0' 2)		REQUIRED		PROPOSED	
17	S S S S S S S S S S		2	12	16					
18	18)		- 21-0	•	27-0	
N/A	18 MAIN HOUSE SETBACKS: 30'-0' 39'-10' 10'-2'		5	5	17	HEIGHT:	20' 0"		30' 2"	
N/A	N/A				18	MAIN HOUSE SETBACKS:				
N/A N/A N/A	N/A N/A N/A				19	FRONT FIRST LEVEL:				
21 SIDE (NORTH): 22'-6" 22'-8"	21 SIDE (NORTH): 22-6° 22-8°		N/A	N/A	20	FRONT SECOND LEVEL:				
228 429 23 REAR: 25'-0" (25%) 25'-4"	228 429 215 244 23 REAR: 24 SUM OF SIDE YARD: 25 POOL SETBACKS (WATERS EDGE / STRUCTURE): 26 SIDE (SOUTH): 27 REAR: 28 29 30 30				21	SIDE (NORTH):				
228 429 23 REAR: 25-0" (25%) 25-4" 25 24 24 SUM OF SIDE YARD: 9-0" / 7'-6" 9-0" / 7'-6" 25 POOL SETBACKS (WATERS EDGE / STRUCTURE): 7-6" / 6-0" 7'-9" / 6'-2" 26 SIDE (SOUTH): 27 REAR: 28 29 29 29 20 20 20 20 20	228 429 215 244 23 REAR: 24 SUM OF SIDE YARD: 25 POOL SETBACKS (WATERS EDGE / STRUCTURE): 26 SIDE (SOUTH): 27 REAR: 28 29 30				22	SIDE (SOUTH):				
215 244	215 244		220	420	\ —		25'-0" (25%)	1	25'-4"	
215	215		10000000	0.0000000000000000000000000000000000000	/		1	1	1	 I
26 SIDE (SOUTH): 27 REAR: 28 29 29	26 SIDE (SOUTH): 27 REAR: 28 29 30		215	244	→					
27 REAR: 28 29	23 58 29 30 S				/	·	7'-6" / 6'-0"		7'-9" / 6'-2"	
23 58 29	23 58 29 30 S) 	<u> </u>				
23 58 29	23 58 29 30 30	7			< ⊢	- Constitution of the Cons				
	30	a	22	F0) ⊢	+		+		J
		1		58	\ —					

SINGLE FAMILY RESIDENCE - ZONING DATA SHEET

ITEM#	ZONING INFORMATION	AE+8
1	FLOOD ZONE:	8.00' NGVD
2	FIRM MAP NUMBER:	9.00' NGVD
3	BASE FLOOD ELEVATION (BFE):	3.89' NGVD
4	PROPOSED FLOOD DESIGN ELEVATION:	CATEGORY II
5	CROWN OF ROAD ELEVATION:	SINGLE-FAMILY RESIDENCE, GARAGE
6	CLASSIFICATION OF STRUCTURE:	9.00' NGVD
7	BUILDING USE:	
8	LOWEST ELEV. OF EQUIPMENT:	

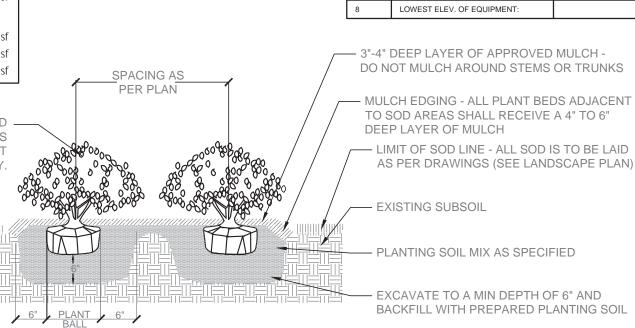

TYPICAL SHRUB PLANTING DETAIL

Acres__0.34___

ON GROUND LEVEL CONVENTIONAL BRACING / GUYING SYSTEM CAN BE SUBSTITUTED BY A SUBGRADE ANCHORING SYSTEM. WWW.PLATIPUS.US (919) 628 - 3147 OR APPROVED EQUAL

N.T.S.

PALM PLANTING DETAIL

TOE NAIL BRACE TO 2"x 4" WOOD BATTEN —

FLAT DARK GREEN

2"x 4" WOOD BRACE (3 TOTAL);—

PAINT TWO COATS EXTERIOR PAINT -

ANT WITH ROOT BALL AT GRADE AND AT A MINIMUM OS 1" ABOVE

GRADE BUT NOT TO EXCEED 2"

2"x4"x12" FOOT PAD FOR SOFT/

SOIL CONDITIONS SUCH AS SAND

BURIED 3 INCHES BELOW GRADE.

N.T.S.

METAL STRAPS SECURING

2"x 4" WOOD BATTENS

— 5 LAYERS BURLAP

— 2" DEEP LAYER OF

APPROVED MULCH


SOIL BERM TO HOLD WATER

— 2"x 4" WOOD STAKE

— GRANULAR FILL MATERIAL


OR EXISTING GRADE

UNEXCAVATED FOR SUPPORT

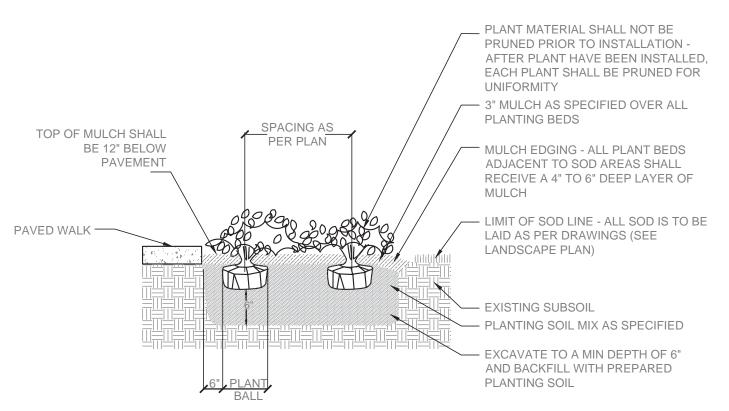

TYP. GROUNDCOVER PLANTING DETAIL

N.T.S.

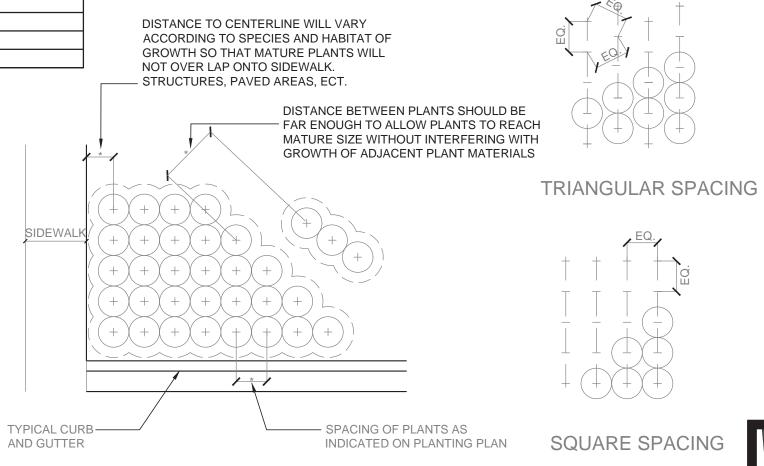

IN MOST CASES TRIANGULAR SPACING IS PREFERRED. USE SQUARE SPACING ONLY IN SMALL RECTILINEAR AREAS

TYPICAL CONTAINER SPACING

N.T.S.

PLANTING LIST AND PLANTING DETAILS



LEWIS AQÜÍ ANDSCAPE + ARCHITECTURAL DESIGN

LC 26000479 7408 B SW 48th STREET MIAMI, FL 33155 PHONE: (305) 661-1855 FAX: (305) 661-1865

Щ **ARCHIT** S 0

RE FINK RE 3167 Royal Miami Beach

PROJECT /

SHEET TITLE

Digitally signed by LEWIS AQUI Date: **2019.04.30** 2019.04.30 -04'00'

LEWIS E. AQÜI RLA # 666-7140

REVISIONS 1 4-29-19 AS PER ZONING

CHECKED BY: AS SHOWN

- 1.00 GENERAL
- 1.01 The Contractor is reminded that the General Conditions and / or Special Conditions of this contract govern the work of this section of the Specifications whether attached hereto or not. Subcontractors undertaking to perform work under this Section shall be made fully aware of these documents and of their responsibilities and obligations thereunder. In the event of any discrepancies between the drawings and specifications and the following 'Scope of Work', the latter shall prevail.
- 2.00 SCOPE OF WORK
- 2.01 The work of this Section shall include all labor, materials, equipment, appliances, and accessories necessary for the complete performance of all excavation, grading, planting and backfill work in accordance with these Specifications and the Contract Drawing. Without restricting the generality of the foregoing, the items listed below and similar items shown on the Contract Drawings shall constitute the work of this Section:
 - A. Finish grading and final site preparation of all areas to be landscaped.
 - B. Furnishing and incorporating fertilizer and other soil amendments.
 - C. Furnishing plant materials and grass materials and installing same.
 - D. Furnishing and placing 'Planting Mixture' and other miscellaneous items to complete the work.
 - E. Replacement of unsatisfactory plant material.
 - F. Clean-up.
- 3.00 SITE PREPARATION and SITE SITEWARDSHIP FOR SUSTAINABLE SITES
- 3.01 The Contractor shall provide finish grading and final preparation of all areas to be landscaped to within 6" of finish grade. This will require raking and pulverizing of all areas in order to crumble dirt, clogs and / or debris. The Landscape Contractor shall be responsible for finish grading, which is the top 6" of the site.
- 3.02 The Contractor must perform the following preventative measures for erosion controls during construction:
 - Stockpile and Protect disturbed Topsoil from erosion;
 - Control the path and velocity of runoff with silt fencing or equivalent;
 - Protect sewer inlets, streams, and lakes with straw bales or silt fencing;
 - Provide swales to divert surface water from hillsides, use tiers, erosion blankets, compost blankets, etc. on sloped areas.
- 3.03 Contractor must minimize disturbed area of site where site is not previously developed by following tree / plant protection plan and enforcing 'No Disturbance Zones' quarantined by use of Construction tape or Fencing.

 When site is previously developed, Contractor must enforce Tree / Plant protection Plan and use Hay bales, silt fencing, etc. for erosion controls.
- 3.04 All Landscaping must be 24" from finish wall of structures for pest control measures.
- 4.00 MATERIALS
- 4.01 Plant materials shall be furnished by the Landscape Contractor and as indicated on the plans.
 - All plant materials shall meet or exceed the following standards.

 A. Plant species and sizes shall conform with plant list. Nomenclature shall conform to
 - Standardized plant names, in accordance with the latest edition of the Florida Department of Agriculture's Grades and Standards for Nursery Plants.
 - B. All plants shall be nursery grown or as stipulated herein and shall comply with all required inspections, grading standards and plant regulations as set forth in the Florida Department of Agriculture 'Grades and Standards for Nursery Plants', including revisions. Ensure that plant materials are shipped with tags stating the botanical and common name of the plant.
 - C. The minimum grade for all trees, palms, shrubs, and groundcovers shall be Florida No. 1 and shall meet or exceed the size and quality standards of the American Association of Nursery Stock, sponsored by the American Association of Nurserymen, latest addition, unless otherwise indicated and all plants shall be sound, healthy and vigorous, well-branched and densely foliated when in leaf. They shall have healthy, well developed root systems and shall be free of disease and insect pests, eggs or larvae. Florida Fancy material shall be provided where plant list specifies 'specimen'.
 - D. The determining measurements for trees shall be the height and spread, and shall be measured from the top of the plant to the root crown, not to include the immediate terminal growth. Their width shall be measured across the normal spread of the branches. Both measurements shall be made with the plants in their normal position.
 - E. Plants larger in size than those specified may be used with approval of the Landscape Architect. If the use of the larger plants is approved, the
 - ball of earth or spread of roots shall be increased proportionately.
 - F. Container grown plants the same quality as balled and burlapped plants may be substituted in lieu thereof. Plants grown in containers shall be delivered and remain in the containers in a shady location until planted. Plants in containers shall be watered prior to transportation and shall be kept moist until planted. The container must be removed prior to planting, with care as not to injure the roots.
 - G. Grass materials shall consist of the following:
 - 1. Sod: Solid sod shall be as indicated on the drawings. Sod must be strongly rooted and free of pernicious weeds. Mow to a height not to exceed 1 1/2" before lifting. Lifts shall have a uniform thickness of 1 inch to 1 1/2 inches. Sod containing nutgrass, lippia water sedge, dollar weed, or other common turfweed species (if applicable), will not be accepted.
 - 2. Sodding installation:
 - a) Sodding shall be done as soon as practical following finish grading. Ground shall be covered with a 4" blanket of soil using specified 60/40 top soil mixture where necessary to create a 4" soil blanket. The day before sod installation, the contractor shall rake 50# Milorganite per 1000 sf of area to receive sod. Ground shall be leveled with the back of a rake and sod laid with joints closely butted so that no voids are visible, keeping surface of sod flush with the adjoining seeded areas and or pavements. Lay sod to form a solid mass with tightly fitted joints. Butt ends and sides of sod strips; do not overlap. Hand tamp to ensure contact with subgrade, and water thoroughly with a fine spray immediately after laying.

- b) After sod is in place, it shall be top dressed with sufficient sharp, clean 60% sand/40% muck soil mix to fill all voids remaining and thoroughly watered to wash the top dressing into the sodded surface.
- c) All sod areas shall then be rolled using a vibrating #1500 sod roller. The contractor shall apply a preemergent herbicide to all sodded areas.
- d) It is the Landscape Contractor's responsibility to keep new sod properly watered until completion of the contract. All watering shall meet specifications according to 'Grades and Standards' Section 983.
- H. Substitutions in plant species or size will be made only with prior written permisson of the Landscape Architect.
- I. If, in the opinion of the Landscape Architect, materials and /or work do not conform with the plans and specifications, it may be rejected and upon rejection, must be removed immediately from the site by the Contractor and replaced.
- J.The Contractor shall be responsible for the certification and inspection of plant material that may be required by local, state, or federal authorities and shall bear the cost of the same, if
- 4.02 Materials used to install the job shall meet or exceed the following standards:
- A. Planting soil mix to be used for 4" soil blankets and backfilling around trees shall be: similar to the existing soil in PH, texture, permeability and other characteristics. The use of structural soil is required in paved sites to provide adequate soil volumes for tree roots under pavement.
- B. Fertilizers: Fertilizer shall be delivered mixed as specified in standard bags, sealed, and showing weight by analysis and name of manufacturer. Fertilizer shall be stored in weatherproof storage and in such a manner that its effectiveness will not be impaired.
- C. Mulch: Mulch shall be shredded melaleuca, Grade B, clean, bright, and free of weeds, moss, sticks, and other debris. Install at 3" deep.
- D. Water: All water required for the execution of the work shall be supplied at the site by the Owner.
- 5.00 INSTALLATION
- 5.01 The Planting operations used to install the job shall meet or exceed the following standards:
- A. Excavation of Plant Pits: Plant pit excavations shall be roughly cylindrical in shape, with their side approximately vertical. Pit shall be excavated so that bottom of pit is same depth as root ball. Plants shall be centered in the hole, with the trunk location as shown in the plans. Holes for balled and burlapped plants shall be large enough to allow 12" minimum (depending on root ball size) of back fill around the sides of the root ball, and 12" of back fill beneath the root ball. In all cases the diameter of the plant hole shall be twice the diameter of the root ball. Where excess material has been excavated from the plant hole, the excavated material may be used to backfill to the proper level. Mix existing excavated material in 50% / 50% ratio with new planting soil mix. The Contractor, in excavation for plantings shall take care not to damage underground utilities or other sub-surface obstructions, and shall be held liable for their repair, if damaged.
- B. Setting Plants: All trees shall be set so, that when settled, the top of the root ball will be flush with the surrounding area of the finish grade or slightly above finish grade. Each plant shall be planted in planting soil mix in the center of the pit. Shrubs shall be set flush with the surrounding finish grade of the planting area. The back fill shall be made with prepared planting in mixture as specified herein and shall be firmly rodded and watered, so that no air-pockets remain. The quantity of water applied immediately upon planting shall be sufficient to thoroughly moisten all of the backfilled earth. Plants shall be kept in a moistened condition the duration of the planting.
- C. Staking and Guying: All trees shall be staked or guyed as shown in the details and according to the following specifications.
- 1. Use wide plastic, rubber or other flexible strapping materials to support the tree to stakes or ground anchors that will give as the tree moves in any direction up to 30 degrees. Use strapping material 'Arbor Tie' by Deep Root (800) 458-7668 dark green color, or approved equal. Do not use rope or wire through a hose. Use guy chords, hose or any other thin bracing or anchorage material which has a minimum 12" [300 mm] length of high visibility flagging tape secured to guys, midway between the tree and stakes for safety.
- 2. Stake trees larger than 1" [25 mm] diameter and smaller than 2" [50 mm] diameter with a 2" by 2" [50 by 50 mm] stake, set at least 2' [0/6 m] in ground and extending to the crown of the plant. Firmly fasten the plant to the stake with flexible strapping materials as noted above
- 3. TREES OF 2 TO 3 1/2" [50 MM TO 90 MM] CALIPER: Stake all trees, other than palm trees, larger than 2" [50 mm] caliper and smaller than 3 1/2" [90 mm] caliper with two 2" by 4" [50 by 100 mm] stakes, 8' [2.4 m] long, set 2' [0.6 m] in the ground. Place the tree midway between the stakes and hold it firmly in place by flexible strapping materials as noted above.
 - LEWIS AQÜÍ

LC 26000479 7408 B SW 48th STREET

MIAMI, FL 33155

PHONE: (305) 661-1855 FAX: (305) 661-1865

- 4.LARGE TREES: Guy all trees, other than palm trees, larger than 3 1/2" [90 mm] caliper, from at least three points, with flexible strapping materials as noted above. Anchor flexible strapping to 2" by 4" by 24" [50 by 100 by 600 mm] stakes, driven into the ground such that the top of the stake is at least 3" [75 mm] below the finished ground.
- 5.SPECIAL REQUIREMENTS FOR PALM TREES: Brace palms which are to be staked with three 2" by 4" [50 by 100 mm] wood braces, toe-nailed to cleats which are securely banded at two points to the palm, at a point one third the height of the trunk. Pad the trunk with five layers of burlap under the cleats. Place braces approximately 120 degrees apart and secure them underground by 2" by 4" by 12" [50 by 100 by 300 mm] stake pads. Paint wood flat dark green exterior paint, two coats.
- 6.TREE PROTECTION AND ROOT BARRIERS: Install tree barriers when called for in the Contract Documents or by the Landscape Architect to protect existing trees from damage during project construction. Place barricades at the drip line of the tree foliage or as far from the base of the tree trunk as possible. Barricades shall be able to withstand bumps by heavy equipment and trucks. Maintain barricades in good condition. When called for in the Contract Documents, install root barriers or fabrics in accordance with the details shown.
- D. Pruning: All broken or damaged roots or branches shall be cut smoothly and the tops of all trees shall be pruned in a manner complying with standard horticultural practice. At the time pruning is completed, all remaining wood shall be alive.
- E. Mulching: Within one week after planting, mulch material, consisting of shredded Eucalyptus or Pinebark shall be uniformly applied to a minimum loose thickness of 2 inches, over the entire area of the backfilled hole or bed. The mulch shall be maintained continuously in place until the time of final inspection, and must be a minimum of 2 inches thick to be accepted. Mulch shall not be placed against stems or trunks.
- F.Fertilizing: Feeding of all trees and specimen shrubs shall be done with slow release, 'Woodace' Briquettes, 17 gram, tablet fertilizer, analysis 14-3-3, as per manufacturer's instructions. Fertilizing shall not occur until after flush of new growth.
- 6.00 MAINTENANCE
- 6.01 Maintenance shall include watering, weeding, mowing, fertilizing, treating, mulching, trimming, removal or replacement of dead or diseased plants and removal of refuse and debris on a regular basis so as to continue a healthy growing condition and present a neat and well-kept appearance at all times.
- 6.02 Shade trees shall be maintained at a minimum canopy diameter of thirty (30) feet in accordance with the American National Standards Institute, A-300 standards or similar accepted standards as published.
- 6.03 A landscape sight triangle shall be provided and visibility maintained as per local code requirements.
- 6.04 Plant material which block visibility shall be removed by the property owner or maintained so as to allow clear visibility of oncoming traffic.(pending public works department approval)
- 6.05 Landscaping shall be inspected periodically by the department to insure proper maintenance. The owner, tenant or other agent shall be notified in writing, of any areas which are not being properly maintained and shall provide corrective action within thirty (30) calendar days from the time of notification.
- 7.00 GUARANTEE
- 7.01 The Landscape Contractor shall guarantee and maintain all new field grown trees for a period of one year, and all field grown palms for a period of one year. All containerized trees, palms, shrubs and groundcovers for a period of 90 days, and all sod for a period of 90 days. The Landscape Contractor shall replace at the direction of the Landscape Architect all trees, shrubs, or groundcovers deemed by the Landscape Architect to be unacceptable, due to death or damage; acts of God, Owner negligence and vandalism excepted.
- 7.02 New material used to replace material unacceptable to the Landscape Architect, shall be guaranteed for similar period from date of installation
- 8.00 FINAL INSPECTION AND ACCEPTANCE
- 8.01 The Landscape Contractor shall advise the Landscape Architect in writing at the end of the guarantee period that the project is ready for final inspection. Only upon notification to the Landscape Architect by the Landscape Contractor in writing and subsequent inspection attended by the Landscape Contractor shall the requirements of the guarantee be met.
- 9.00 CLEAN-UP
- 9.01 Upon completion of all work under this section, and intermittently as required, the Landscape Contractor shall clear the site of all debris, superfluous material and all equipment to the satisfaction of the Landscape Architect
- All plant material is subject to the specifications of Florida's Grades and Standards, Revised unless otherwise noted. Compliance with ANSI A300, part 5, 6 & 8 and other relevant ANSI A300 standards shall be adhered to in the strictest sense of the standard language. All work shall be in compliance with ANSI Z133.1 and other industry safety standards. Any questions or concerns regarding the specifications should be immediately addressed in writing to the landscape architect of record or the owner's representative. Without such questions or concerns it is assumed and accepted that the landscape contractor has a full and complete understanding of all standards which may affect the performance in the execution of these specifications. Landscape contractor is responsible for the selection of plant material that fits the grade specified in this document. The plant material shall be considered accepted by the landscape contractor at the exact time of installation.
 - All plant material shall be Grade #1 or better.
 - Landscape contractor shall perform his own quantity take off. Plan supersedes plant list.
 - Any discrepancy should be called to the attention of LA
 - No substitution on species on size or quantity can be made without approval from LA

11.00 End

LANDSCAPE SPECIFICATION

Z.W. JAROSZ ARCHITECT, P.A.

3.2.6 MARY STREET SUITE 500
COCONUT GROVE, FLORIDA 33133
3.05.446.0888 WWW.JAROSZARCH.COM

N	m O m

PROJECT / SHEET TITLE

FINK RESIDENCE
3167 Royal Palm Avenue,
Miami Beach, FL. 33140


STATE OF	Date: 2019.04.30 16:16:58 -04'00'
	LEWIS E. AQÜI
	RLA # 666-7140

EVIS	SIONS	
NO.	DATE	DESCRIPTION
	·	

COPYRIGHT 2018 ALL RIGHTS RESERVED. THESE DRAI AND SPECIFICATIONS ARE INSTRUMENTS OF SERVICE SHALL REMAIN THE PROPERTY OF Z.W. JAROSZ ARCHICE: WHETHER THE PROJECT FOR WHICH THEY WERE PREIS EXECUTED OR NOT. THEY ARE NOT TO BE USED IN MANNER ON OTHER PROJECTS OR EXTENSIONS TO PROJECT EXCEPT BY ACREEMENT IN WRITING AND WIT APPROPRIATE COMPENSATION TO Z.W. JAROSZ ARCHITECT REPRODUCTIONS OF DRAWINGS AND SPECIFICAT WITHOUT THE RESERVENCE OF THE R
CONDITIONS PRIOR TO PROCEEDING WITH W

DATE:	04/08/19
DRAWN BY:	LG
CHECKED BY:	LA
SCALE:	AS SHOWN
·	
SHEET	

L3

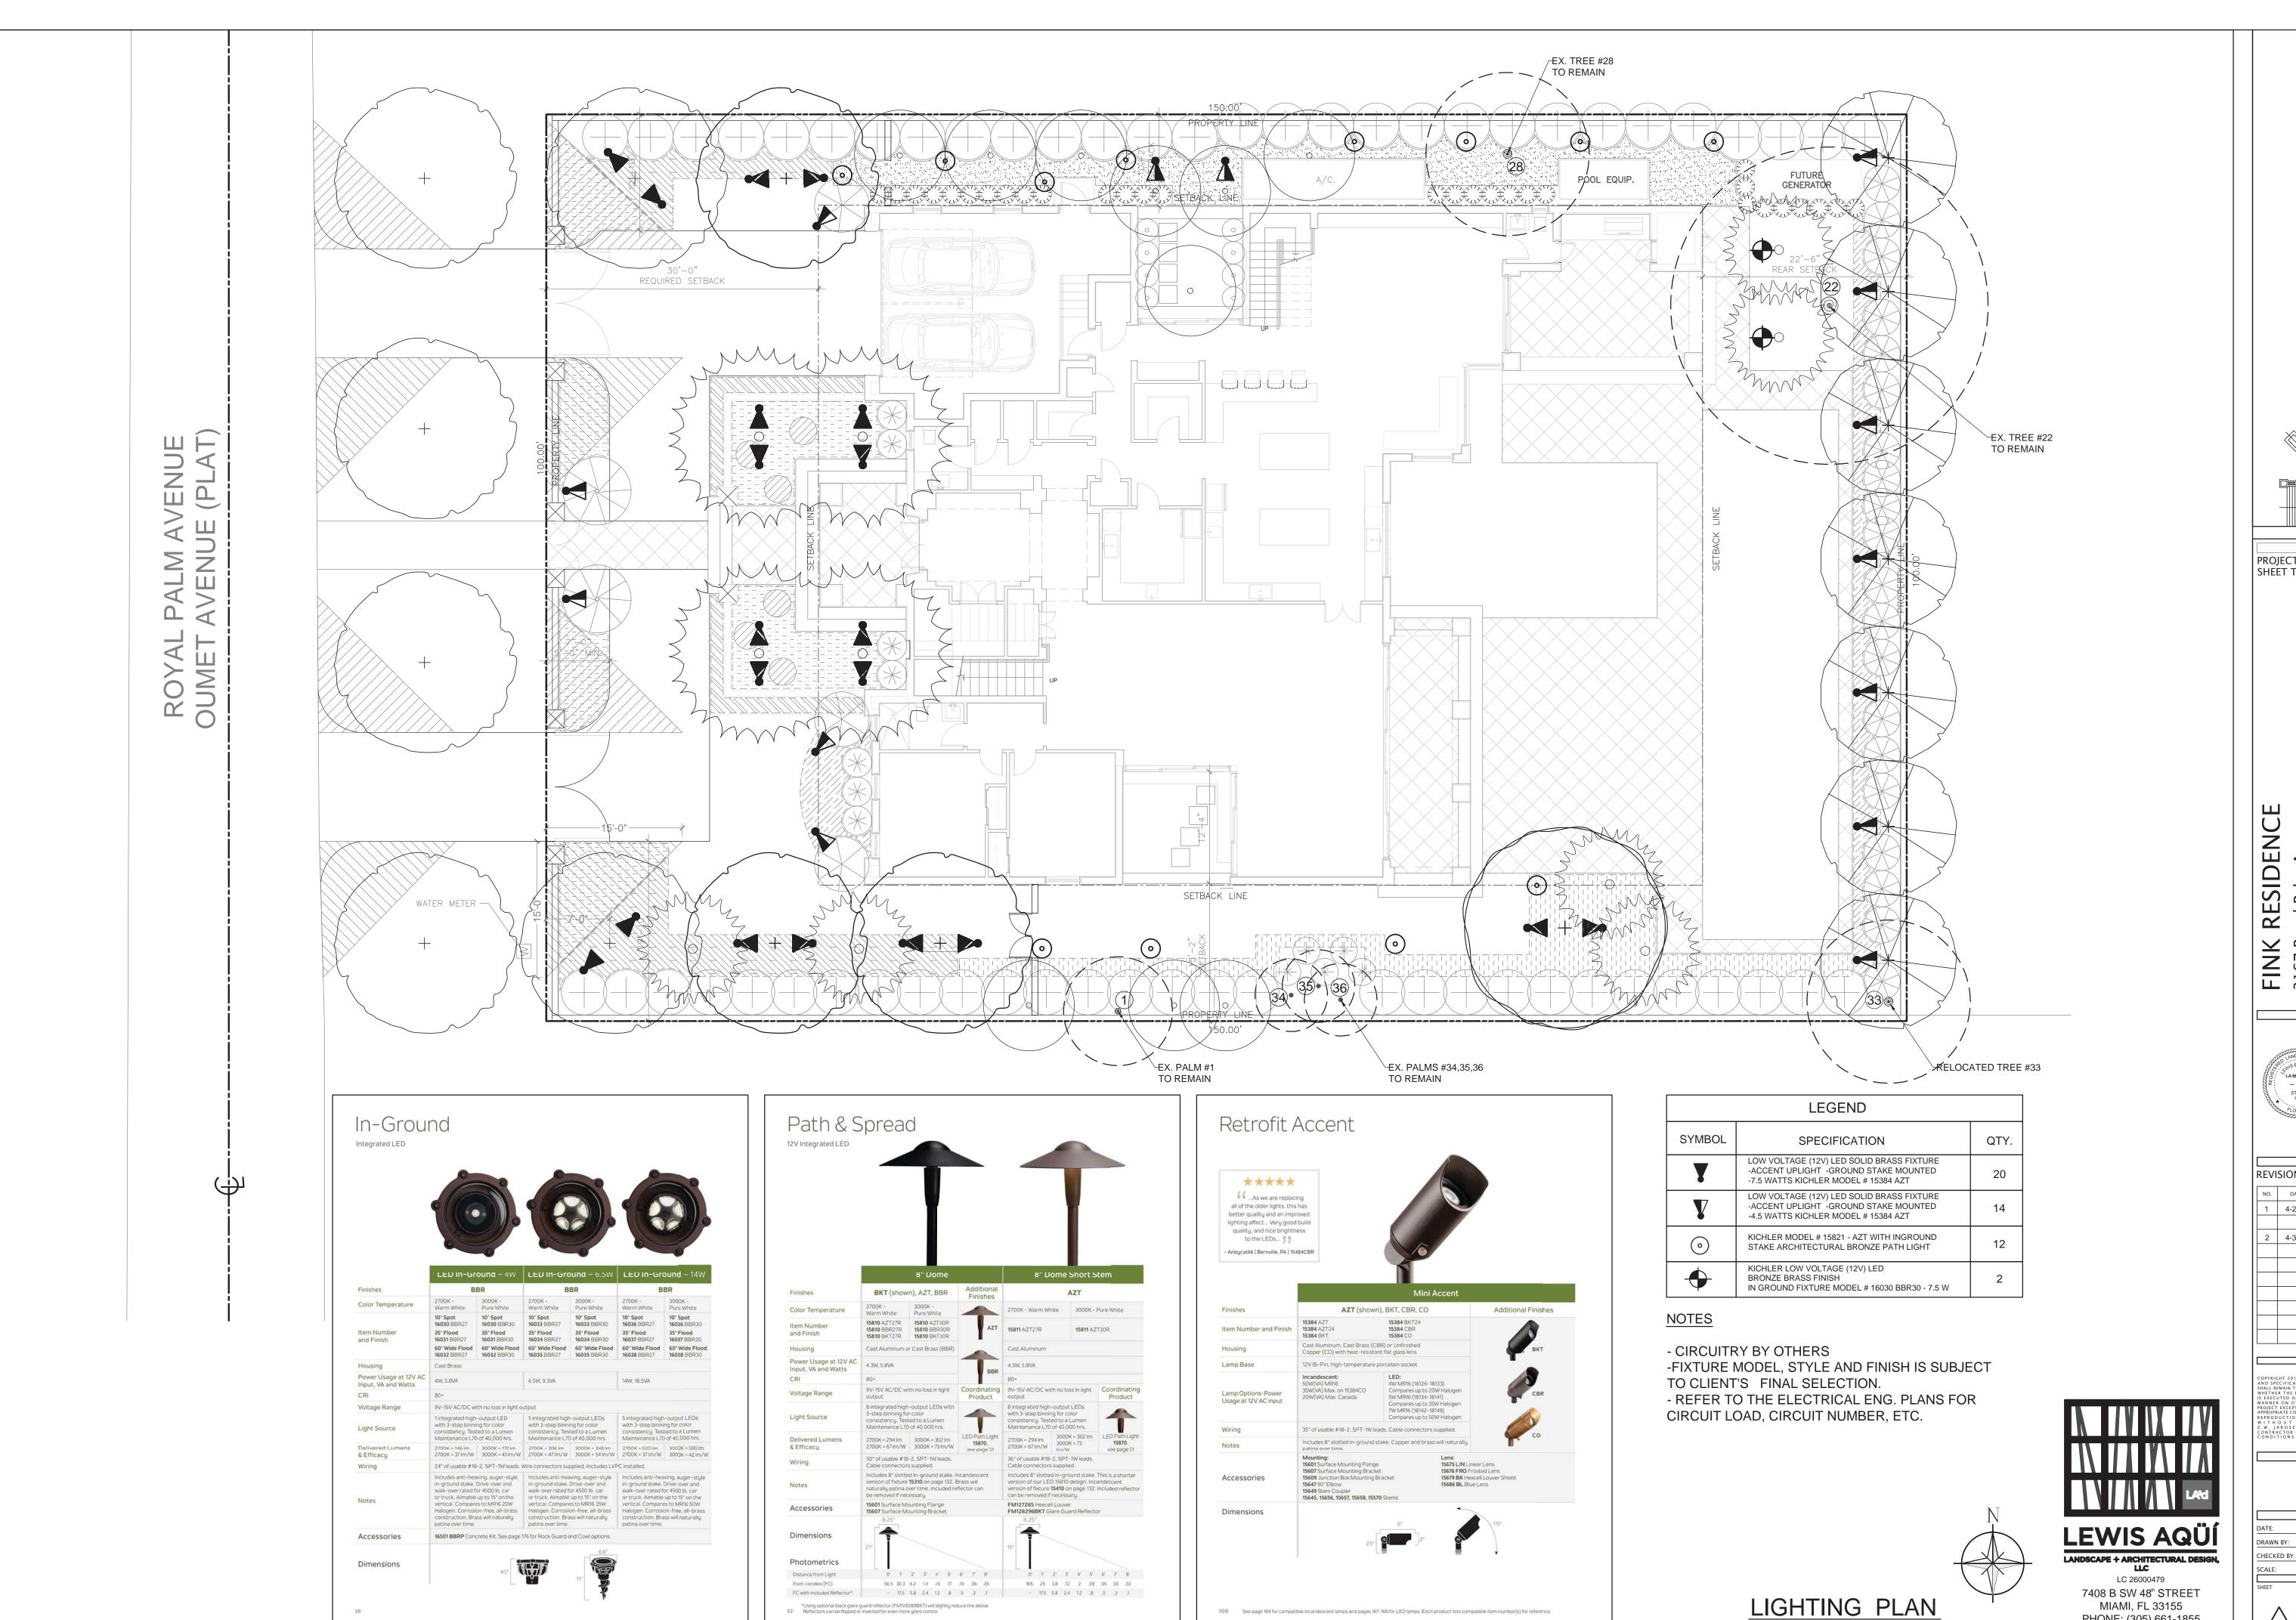

ARCHITEC JAROSZ 0 0 4

PROJECT / SHEET TITLE

IDENCE Im Avenue, FL. 33140 FINK RESI 3167 Royal Pal Miami Beach, F

> Digitally signed by LEWIS AQUI LA6667140 Date: STATE OF 2019.04.30 [′] 16:17:42

-04'00' LEWIS E. AQÜI RLA # 666-7140

REVISIONS NO. DATE DESCRIPTION 1 4-29-19 AS PER ZONING COMMENTS 2 4-30-19 AS PER CLIENT'S REQUEST


04/08/19 CHECKED BY: AS SHOWN



PHONE: (305) 661-1855

FAX: (305) 661-1865

SCALE: 1/8" = 1'-0"

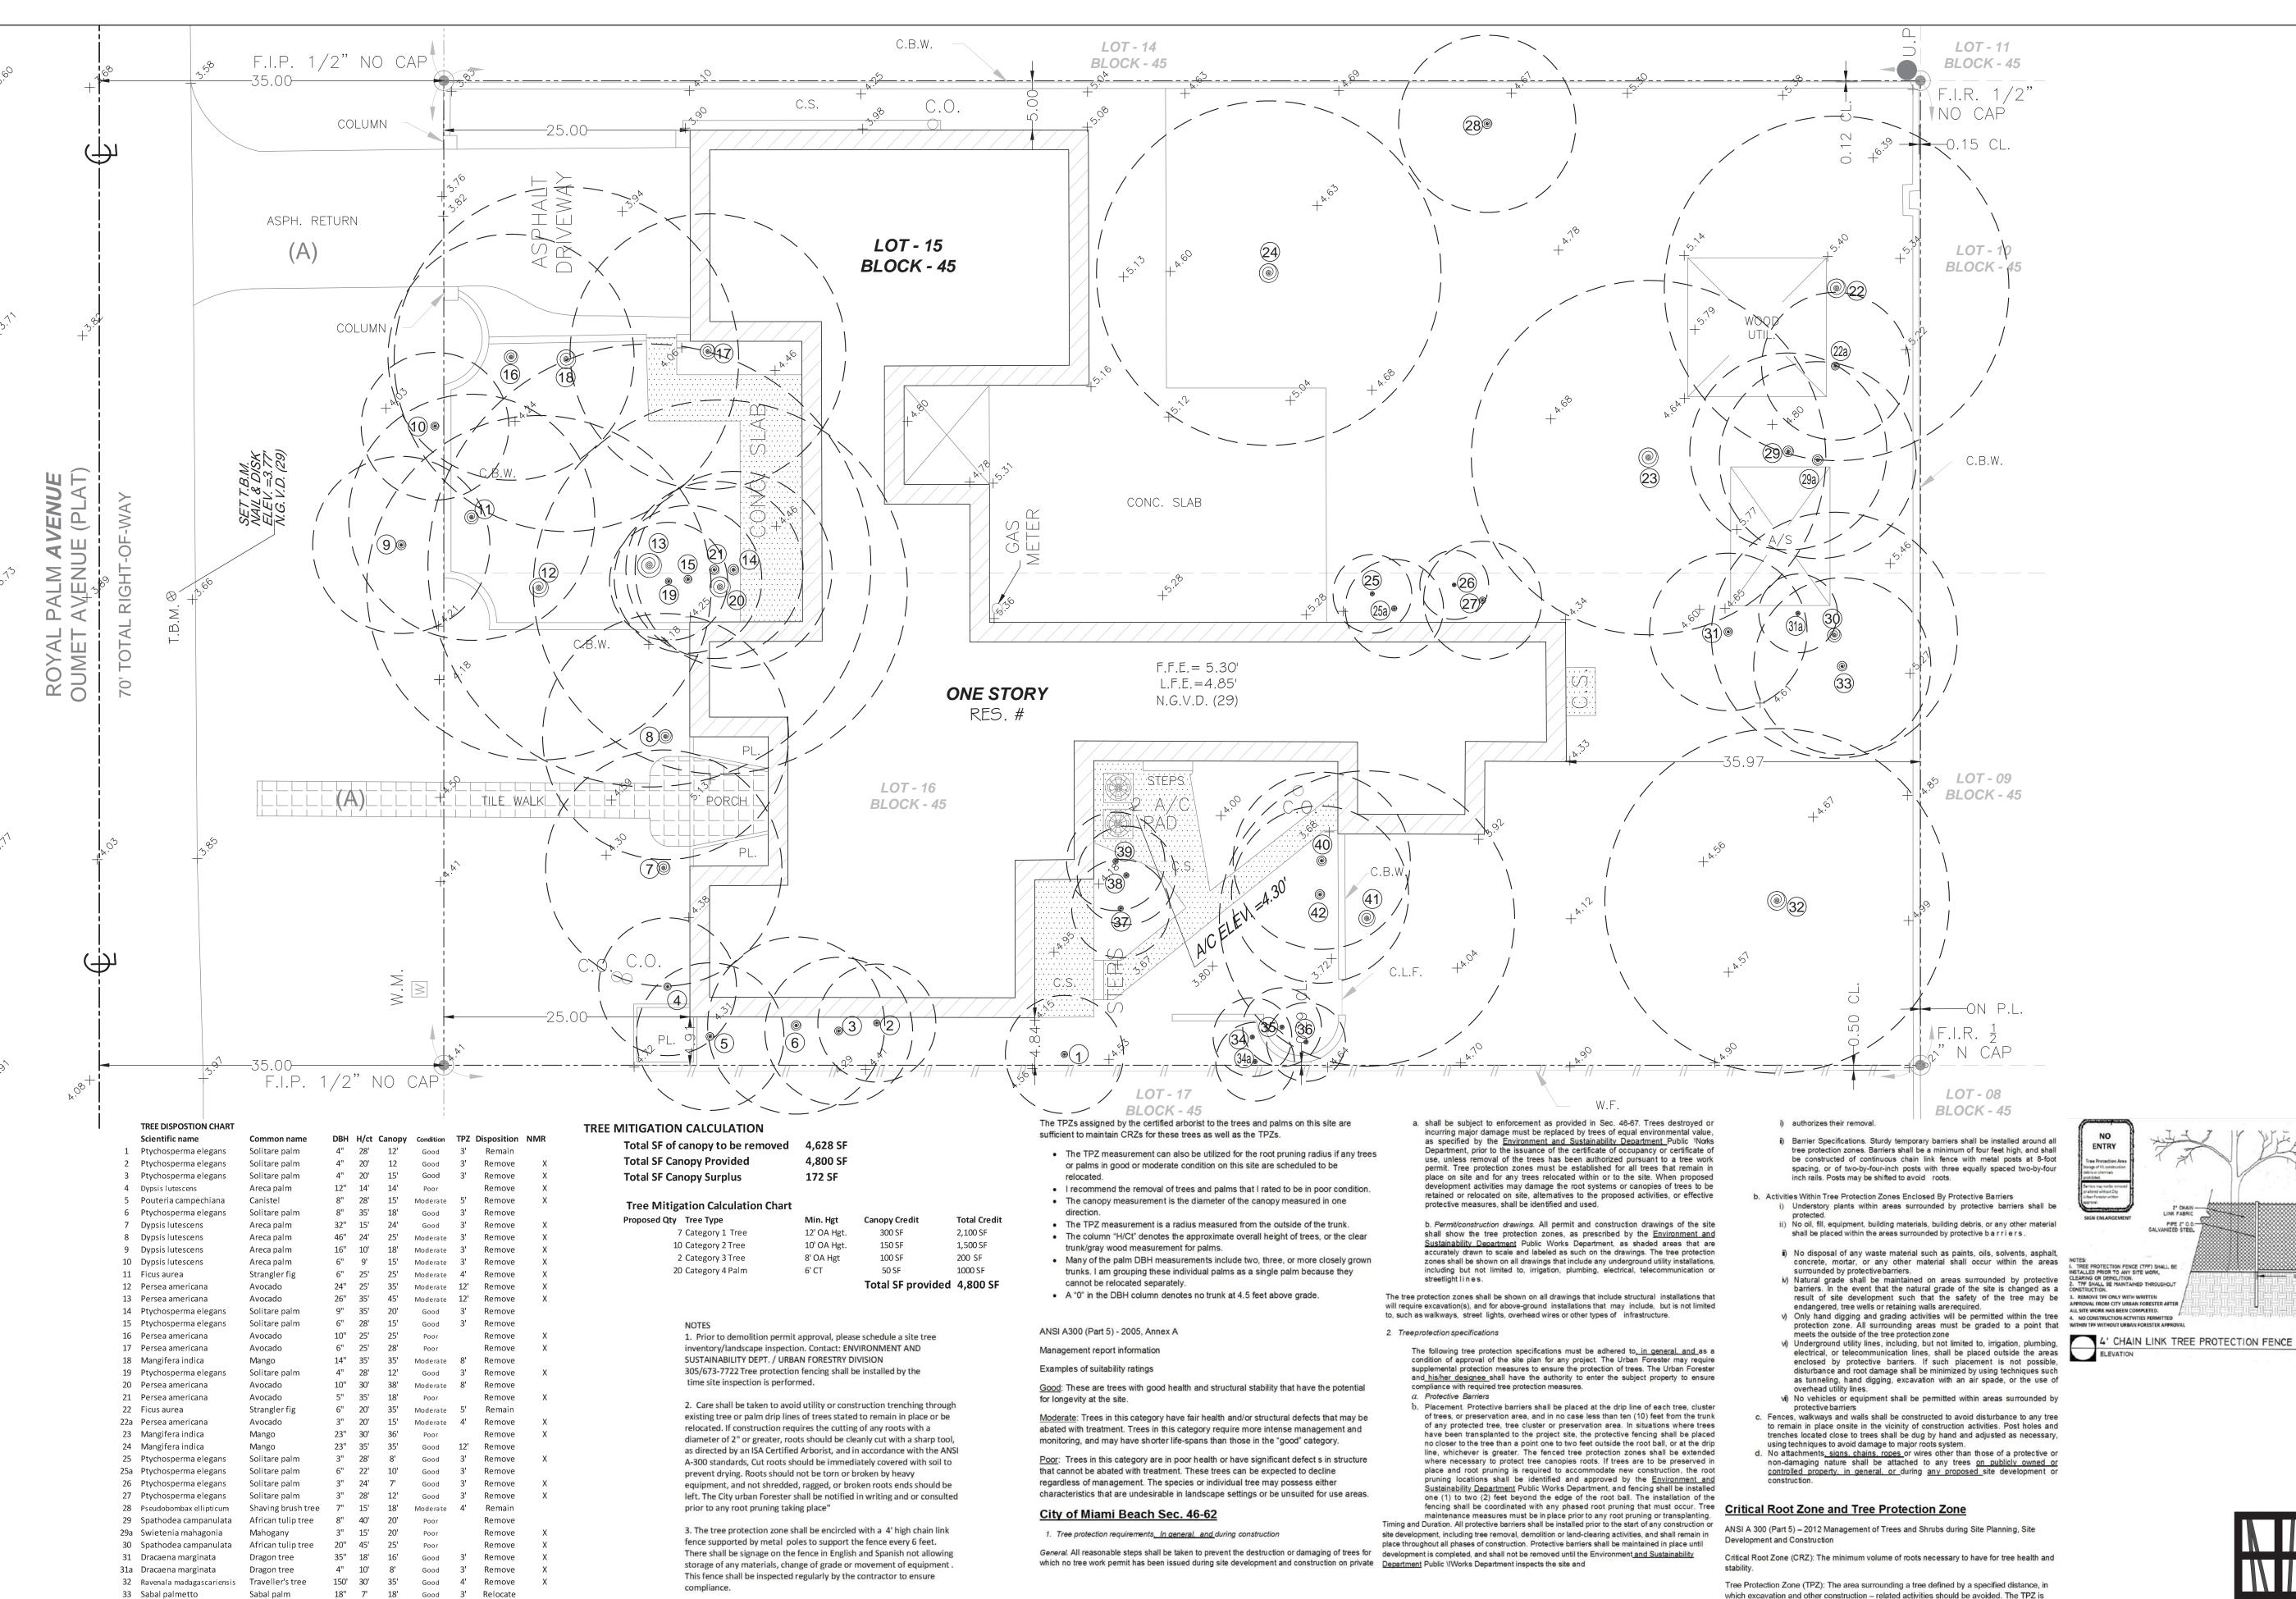

CANOPY MITIGATION CALCULATIONS HAVE BEEN PREPARED BASED ON THE EXISTING TREE

AT THE TIME OF PLANS REVIEW.

INVENTORY/REPORT AND IN ACCORDANCE TO CITY OF MIAMI BEACH CHAPTER 46 ENVIRONMENT

DIVISION 2 TREE PRESERVATION AND PROTECTION ORDINANCE; HOWEVER, SUCH CALCULATIONS

ARE SUBJECT TO CHANGE AT THE DISCRETION OF THE REGULATORY AGENCY (URBAN FORESTRY)

34 Ptychosperma elegans

35 Ptychosperma elegans

36 Ptychosperma elegans

37 Ptychosperma elegans

38 Ptychosperma elegans

39 Ptychosperma elegans

40 Ptychosperma elegans

41 Nerium oleander

34a Clerodendrum quadriloculare Starburst

42 Clerodendrum quadriloculare Starburst

TREE EVALUATION REPORT

Solitare palm

Oleander

Remove

Remove

Remove

Poor

NMR Indicates No Mitigation Required due to the existing tree/palm condition (Evidence of Ganoderma, Decaying Poor Trunk Connection

Conflict with existing Power Lines, Size of caliper and/or any other condition that the certified arborist has mentioned on the EXISTING

(SEE ENLARGEMENT) LEARING OR DEMOLITION. . TPF SHALL BE MAINTAINED THROUGHOUT ALL SITE WORK HAS BEEN COMPLETED.


which excavation and other construction - related activities should be avoided. The TPZ is variable depending on species, factors, age and health of the plant, soil conditions, and proposed construction. The zone may be accomplished by physical barriers or soil protection

ANSI A300 (Part 5) - 2012 54.7

A tree protection zone (TPZ) shall be delineated around all trees to be protected during a project

 54.7.1 The area and dimensions of the TPZ should be calculated on the basis of species tolerance, age, and health, root structure, rooting depth and soil conditions.

TREE DISPOSITION PLAN SCALE: 1/8" = 1'-0"

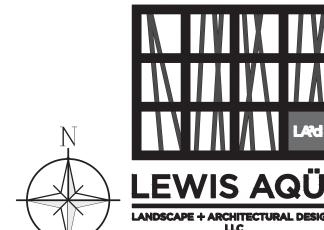

LC 26000479 7408 B SW 48th STREET MIAMI, FL 33155 PHONE: (305) 661-1855 FAX: (305) 661-1865

LANDSCAPE + ARCHITECTURAL DESIGN,

HECKED BY:

04/08/19 AS SHOWN

Digitally

Date:

signed by

LEWIS AQUI

⁹ 2019.04.30

16:19:10

-04'00'

DESCRIPTION

LEWIS E. AQÜI

RLA # 666-7140

ARCHITE

JAROSZ

PROJECT / SHEET TITLE

DENCI

 Δ

LA 6667140


- * -

STATE OF

REVISIONS

NO. DATE

TD1

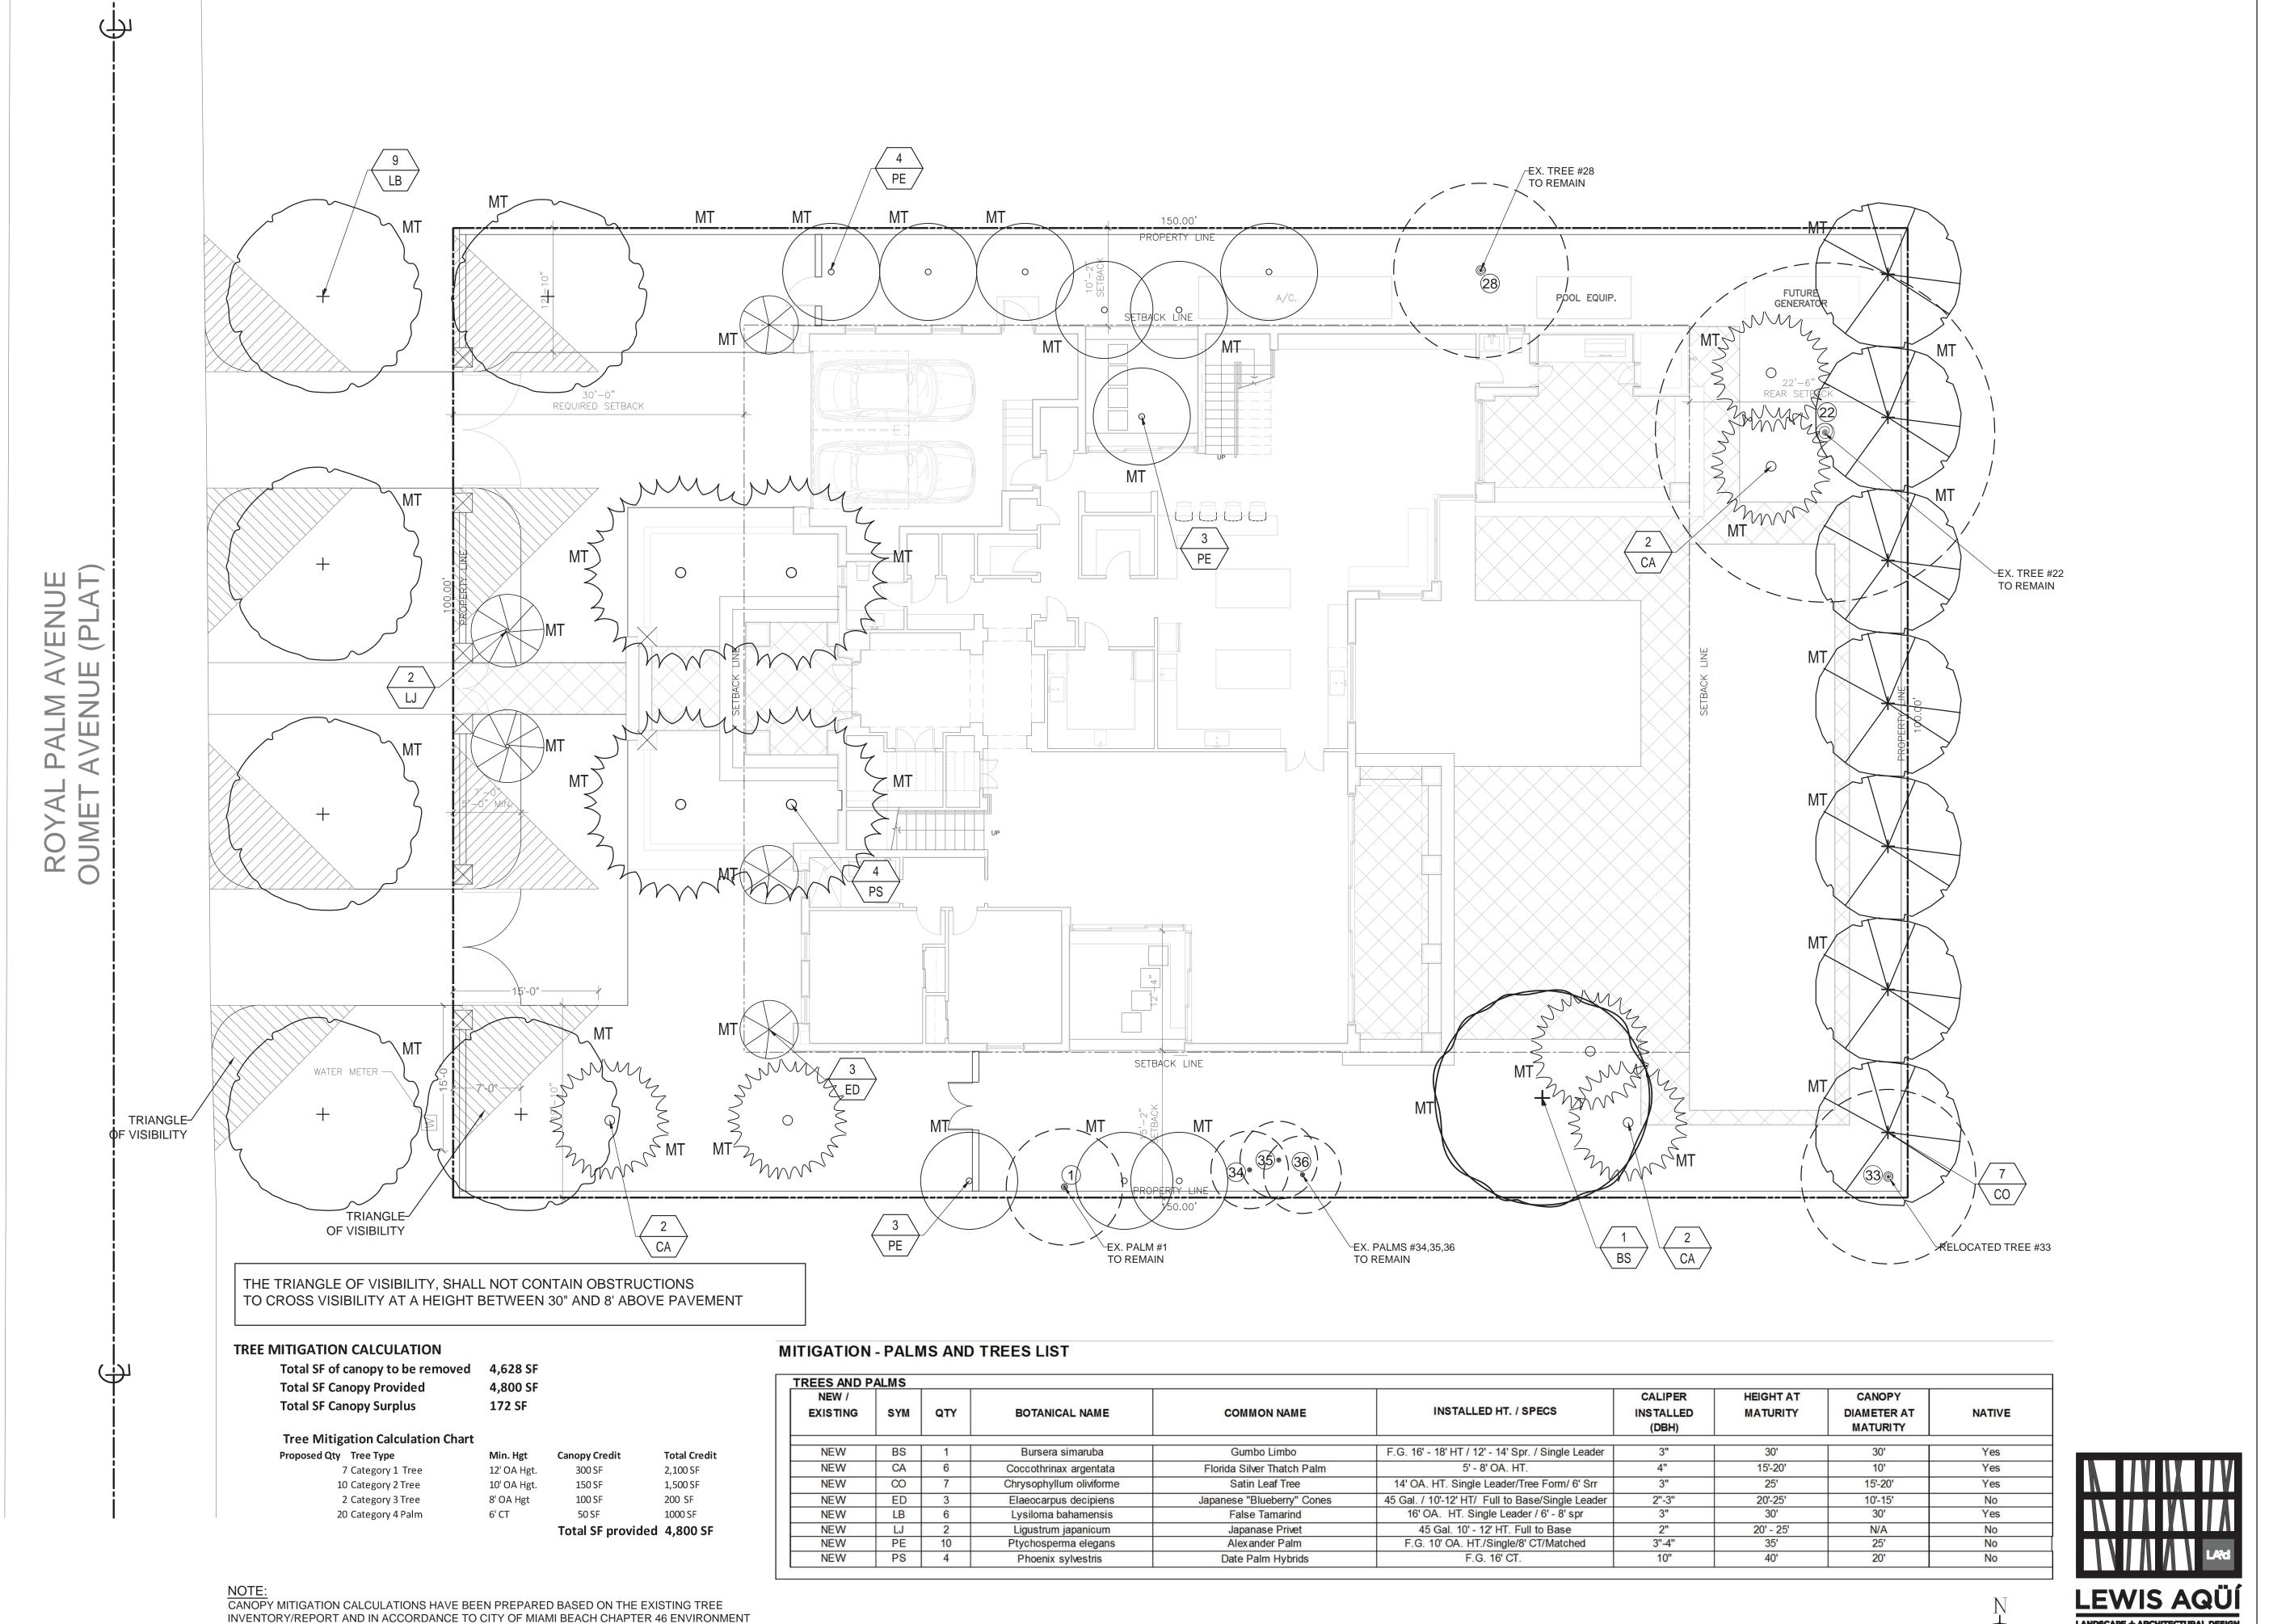


DIVISION 2 TREE PRESERVATION AND PROTECTION ORDINANCE; HOWEVER, SUCH CALCULATIONS

ARE SUBJECT TO CHANGE AT THE DISCRETION OF THE REGULATORY AGENCY (URBAN FORESTRY)

AT THE TIME OF PLANS REVIEW.

TREE MITIGATION PLAN SCALE: 1/8" = 1'-0"

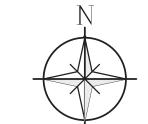



LC 26000479 7408 B SW 48th STREET MIAMI, FL 33155 PHONE: (305) 661-1855 FAX: (305) 661-1865

04/08/19 CHECKED BY: AS SHOWN

ARCHITEC

JAROSZ

PROJECT / SHEET TITLE

IDENCE alm Avenue, FL. 33140

FINK RESI 3167 Royal Pal Miami Beach, F

LA 6667140

- *
STATE
OF

REVISIONS

Digitally signed by LEWIS AQUI

2019.04.30

LEWIS E. AQÜI RLA # 666-7140


NO. DATE DESCRIPTION

1 4-30-19 AS PER CLIENT'S

REQUEST

16:19:42 -04'00'

0 0 4

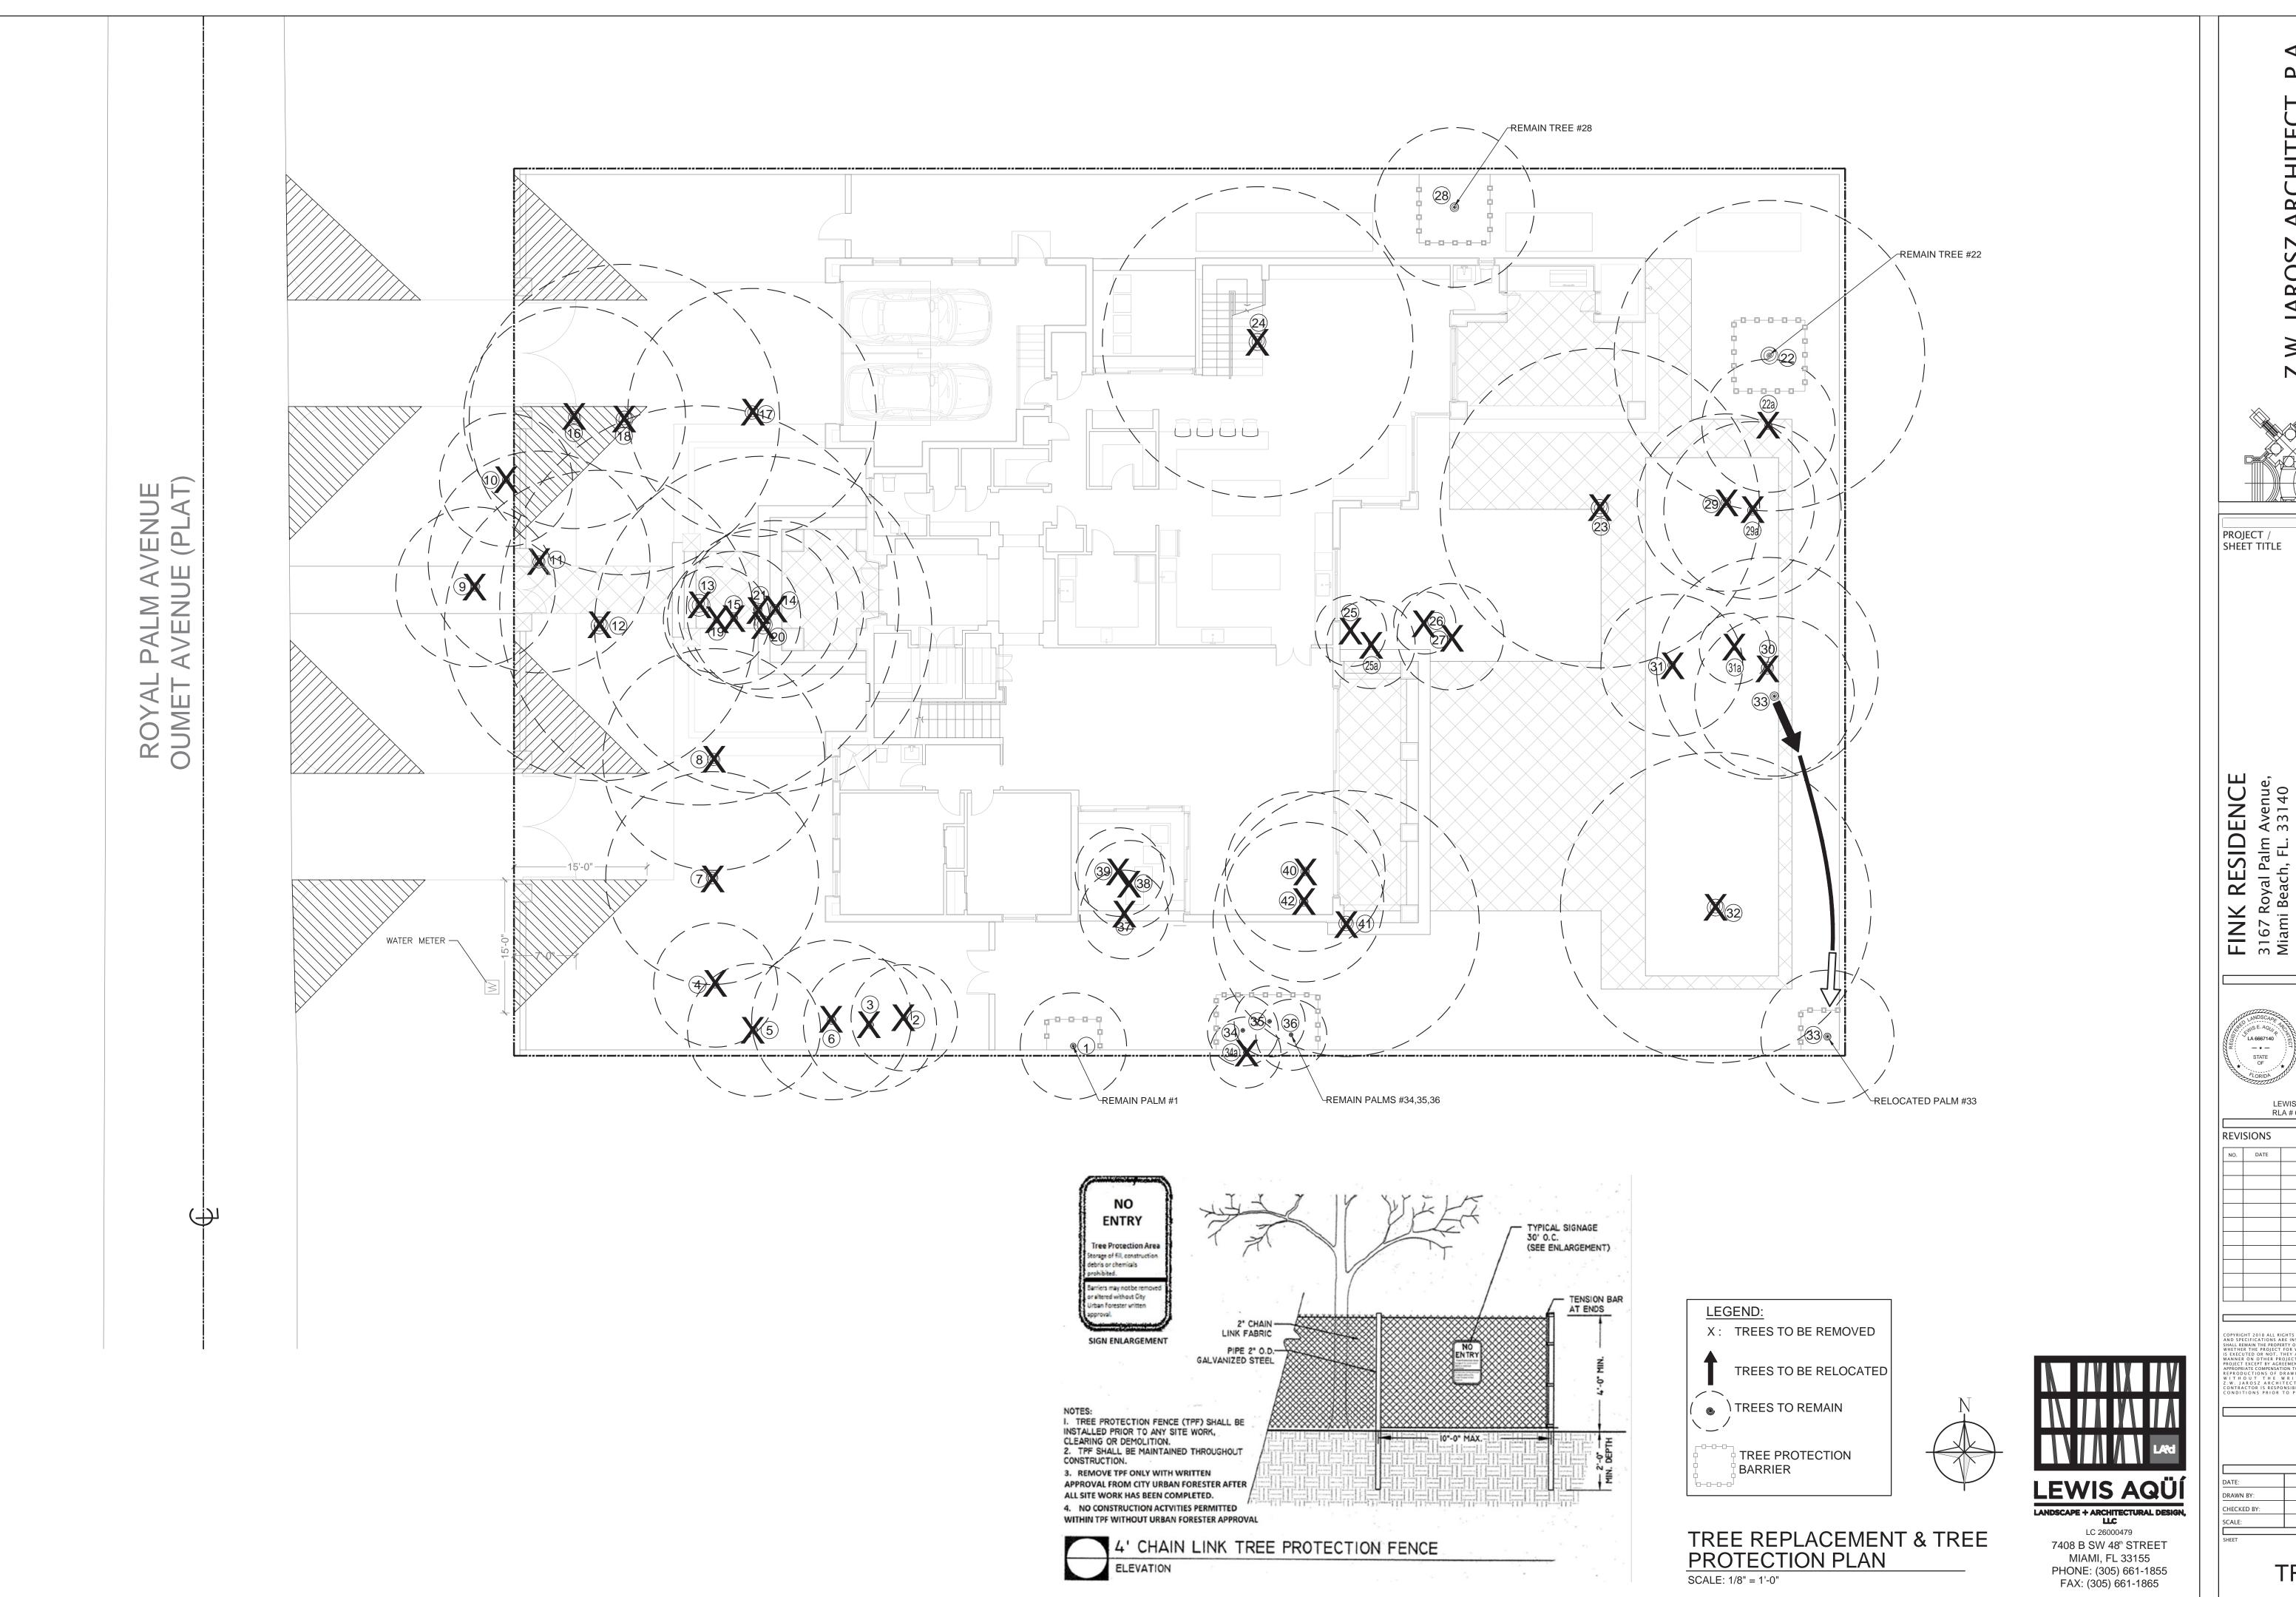

ARCHITECT JAROSZ ,

Digitally signed by LEWIS AQUI 2019.04.30 16:20:10

-04'00'

LEWIS E. AQÜI RLA # 666-7140

04/08/19 AS SHOWN

TR1