CITY OF MIAMI BEACH         LANDSCAPE LEGEND         INFORMATION REQUIRED TO BE PERMANENTLY AFFIXED TO PLANS         Zoning District CPS-2       Lot Area 19500 sq. ft. Acres 0.44         REQUIRED/         OPEN SPACE         A Square feet of required Open Space as indicated on site plan:         Lot Area = 19500 s.f. 2000 s.f.         Square feet of parking lot open space required as indicated on site plan:         Number of parking spaces				
INFORMATION REQUIRED TO BE PERMANENTLY AFFIXED TO PLANS         Zoning District       CPS-2         Lot Area       19500 sq. ft.         Acres       0.44         REQUIRED/         AllOWED       PROVIDED         A. Square feet of required Open Space as indicated on site plan:       1000 sq. ft.         Lot Area       19500 s.f. 20% % = 3.900 s.f.         Square feet of parking bot open space required as indicated on site plan:       Number of parking spaces       9 x 10 s.f. parking space =       n/a       90         C. Total square feet of landscaped open space required:       Auwn AREA CALCULATION         A. Square feet of landscaped open space required       3.900       3.937         B. Maximum lawn area (sod) permitted=       20% % x 3.900 s.f.       780       0         A. Number of trees required per lot or net lot acre, less existing number of trees meeting minimum requirements=       2       0         22       trees x       0.44       0       0         3       0       0       0         4. Number of trees provided x 30% =       10 <td></td> <td>CITY OF MIAMI BEACH</td> <td></td> <td></td>		CITY OF MIAMI BEACH		
INFORMATION REQUIRED TO BE PERMANENTLY AFFIXED TO PLANS         Zoning District       CPS-2         Lot Area       19500 sq. ft.         Acres       0.44         REQUIRED/         AllOWED       PROVIDED         A. Square feet of required Open Space as indicated on site plan:       1000 sq. ft.         Lot Area       19500 s.f. 20% % = 3.900 s.f.         Square feet of parking bot open space required as indicated on site plan:       Number of parking spaces       9 x 10 s.f. parking space =       n/a       90         C. Total square feet of landscaped open space required:       Auwn AREA CALCULATION         A. Square feet of landscaped open space required       3.900       3.937         B. Maximum lawn area (sod) permitted=       20% % x 3.900 s.f.       780       0         A. Number of trees required per lot or net lot acre, less existing number of trees meeting minimum requirements=       2       0         22       trees x       0.44       0       0         3       0       0       0         4. Number of trees provided x 30% =       10 <td></td> <td></td> <td></td> <td></td>				
Zoning District       CPS-2       Lot Area _ 19500 sq. ft.       Acres       0.44         OPEN SPACE       REQUIRED/ ALLOWED       PROVIDED         A. Square feet of required Open Space as indicated on site plan: Lot Area =				
OPEN SPACEALLOWEDPROVIDEDA. Square feet of required Open Space as indicated on site plan: Lot Area =		-	0.44	
OPEN SPACEALLOWEDPROVIDEDA. Square feet of required Open Space as indicated on site plan: Lot Area =			REQUIRED/	
Lot Area =		OPEN SPACE		PROVIDED
Number of parking spaces9x 10 s.f. parking space = $n/a$ 90C. Total square feet of landscaped open space required: A+B= $3.900$ $4.027$ LAWN AREA CALCULATIONA. Square feet of landscaped open space required $3.900$ $3.937$ B. Maximum lawn area (sod) permitted = $20\%$ % x $3.900$ $s.f.$ 7800TREESA. Number of trees required per lot or net lot acre, less existing number of trees meeting minimum requirements=22trees x $0.44$ 22trees x $0.44$ Number of trees provided x 30% = $3$ 0 $0$ 8. % Natives required: Number of trees provided x 30% = $5$ 0 $0$ 9. Street Trees (maximum average spacing of 20' o.c.)150linear feet along street divided by 20'=8. Street tree species allowed directly beneath power lines:(maximum average spacing of 20' o.c.): $N/A$ N/AN/AN/AN/AN/AN/AN/AN/AN/AA. Number of shrubs required: Sum of lot and street trees required x 12=8. % Native shrubs required: Number of shrubs provided x 50%=4. Number of large shrubs or small trees required: Number of required shrubs x 10%=908. % Native large shrubs or small trees required: Number of large shrubs or small trees required: Number of large shrubs or	Α.		3.900	3.937
C.       Total square feet of landscaped open space required: A+B=       3.900       4.027         LAWN AREA CALCULATION       A.       Square feet of landscaped open space required       3.900       3.937         B.       Maximum lawn area (sod) permitted=       20%       % x 3.900       s.f.       780       0         TREES       A.       Number of trees required per lot or net lot acre, less existing number of trees meeting minimum requirements=       10       0         22       trees x       0.44       net lot acres - number of existing trees=       10       0         B.       % Natives required: Number of trees provided x 30% =       3       0       0         C.       % Low maintenance / drought and salt tolerant required:       Number of trees provided x 50% =       5       0         D.       Street Trees (maximum average spacing of 20' o.c.)       150       linear feet along street divided by 20'=       8       8         E.       Street tree species allowed directly beneath power lines:       (maximum average spacing of 20' o.c.):       N/A       N/A         M/A       linear feet along street divided by 20'=       N/A       N/A       A         A.       Number of shrubs required: Sum of lot and street trees required x 12=       86       162         B.       % Native shrubs or smal	в.	Square feet of parking lot open space required as indicated on site plan:		
LAWN AREA CALCULATION         A.       Square feet of landscaped open space required       3.900       3.937         B.       Maximum lawn area (sod) permitted=       20%       % x 3.900       s.f.       780       0         TREES       A.       Number of trees required per lot or net lot acre, less existing number of trees meeting minimum requirements=       10       0         22       trees x       0.44       net lot acres - number of existing trees=       10       0         B.       % Natives required: Number of trees provided x 30% =       3       0       0         C.       % Low maintenance / drought and salt tolerant required: Number of trees provided x 50%=       5       0         D.       Street Trees (maximum average spacing of 20' o.c.)       150       linear feet along street divided by 20'=       8       8         E.       Street tree species allowed directly beneath power lines: (maximum average spacing of 20' o.c.):       N/A       N/A         MAX       N/A       Inear feet along street divided by 20'=       8       8         E.       Street tree species allowed directly beneath power lines: (maximum average spacing of 20' o.c.):       N/A       N/A         M/A       Inear feet along street divided by 20'=       N/A       N/A         SHRUBS       A       Number of		Number of parking spaces <u>9</u> x 10 s.f. parking space =	n/a	90
A.       Square feet of landscaped open space required       3.900       3.937         B.       Maximum lawn area (sod) permitted=       20%       % x _ 3.900       s.f.       780       0         TREES       A.       Number of trees required per lot or net lot acre, less existing number of trees meeting minimum requirements=       10       0         22	C.	Total square feet of landscaped open space required: A+B=	3.900	4.027
A.       Square feet of landscaped open space required       3.900       3.937         B.       Maximum lawn area (sod) permitted=       20%       % x _ 3.900       s.f.       780       0         TREES       A.       Number of trees required per lot or net lot acre, less existing number of trees meeting minimum requirements=       10       0         22				
B. Maximum lawn area (sod) permitted=       20%       % x 3.900 s.f.       780       0         TREES         A. Number of trees required per lot or net lot acre, less existing number of trees meeting minimum requirements=       22_trees x 0.44_net lot acres - number of existing trees=       10       0         B. % Natives required: Number of trees provided x 30% =       3       0       0         C. % Low maintenance / drought and salt tolerant required:       Number of trees provided x 50%=       5       0         D. Street Trees (maximum average spacing of 20' o.c.)	A.		3.900	3.937
<ul> <li>A. Number of trees required per lot or net lot acre, less existing number of trees meeting minimum requirements=</li> <li>22 trees x 0.44 net lot acres - number of existing trees=</li> <li>8 % Natives required: Number of trees provided x 30% =</li> <li>9 0</li> <li>8 % Natives required: Sum of lot and street trees required x 12=</li> <li>8 % Native shrubs required: Sum of lot and street trees required x 12=</li> <li>8 % Native shrubs required: Number of shrubs provided x 50%=</li> <li>9 0</li> <li>8 % Native large shrubs or small trees required: Number of large shrubs or</li> </ul>				
<ul> <li>A. Number of trees required per lot or net lot acre, less existing number of trees meeting minimum requirements=</li> <li>22 trees x 0.44 net lot acres - number of existing trees=</li> <li>8 % Natives required: Number of trees provided x 30% =</li> <li>9 0</li> <li>8 % Natives required: Sum of lot and street trees required x 12=</li> <li>8 % Native shrubs required: Sum of lot and street trees required x 12=</li> <li>8 % Native shrubs required: Number of shrubs provided x 50%=</li> <li>9 0</li> <li>8 % Native large shrubs or small trees required: Number of large shrubs or</li> </ul>				
trees meeting minimum requirements= 22_trees x_0.44_net lot acres - number of existing trees=100B. % Natives required: Number of trees provided x 30% =30C. % Low maintenance / drought and salt tolerant required: Number of trees provided x 50%=50D. Street Trees (maximum average spacing of 20' o.c.) 		TREES		
22trees x0.44net lot acres - number of existing trees=100B. % Natives required: Number of trees provided x 30% =30C. % Low maintenance / drought and salt tolerant required: Number of trees provided x 50%=50D. Street Trees (maximum average spacing of 20' o.c.) 	Α.			
B. % Natives required: Number of trees provided x 30% =       3       0         C. % Low maintenance / drought and salt tolerant required:       Number of trees provided x 50%=       5       0         D. Street Trees (maximum average spacing of 20' o.c.)       5       0       0 <u>150</u> linear feet along street divided by 20'=       8       8         E. Street tree species allowed directly beneath power lines:       7       7         (maximum average spacing of 20' o.c.):       7       7				
C. % Low maintenance / drought and salt tolerant required:       5       0         Number of trees provided x 50%=       5       0         D. Street Trees (maximum average spacing of 20' o.c.)       5       0				
Number of trees provided x 50%=       5       0         D. Street Trees (maximum average spacing of 20' o.c.)       8       8         E. Street tree species allowed directly beneath power lines:       8       8         (maximum average spacing of 20' o.c.):       N/A       N/A			3	0
Image: 150       linear feet along street divided by 20'=       8       8         E. Street tree species allowed directly beneath power lines: (maximum average spacing of 20' o.c.):       N/A       N/A         M/A       linear feet along street divided by 20'=       N/A       N/A         SHRUBS       Number of shrubs required: Sum of lot and street trees required x 12=       86       162         B. % Native shrubs required: Number of shrubs provided x 50%=       43       0         LARGE SHRUBS OR SMALL TREES       Number of large shrubs or small trees required: Number of required shrubs x 10%=       9       0         B. % Native large shrubs or small trees required: Number of large shrubs or       9       0	0.		5	0
E. Street tree species allowed directly beneath power lines:       (maximum average spacing of 20' o.c.):         N/A       Inear feet along street divided by 20'=       N/A       N/A         SHRUBS       A. Number of shrubs required: Sum of lot and street trees required x 12=       86       162         B. % Native shrubs required: Number of shrubs provided x 50%=       43       0         LARGE SHRUBS OR SMALL TREES       A. Number of large shrubs or small trees required: Number of required shrubs x 10%=       9       0         B. % Native large shrubs or small trees required: Number of large shrubs or       9       0	D.	Street Trees (maximum average spacing of 20' o.c.)		
(maximum average spacing of 20' o.c.):       N/A       N/A			8	8
SHRUBS         A. Number of shrubs required: Sum of lot and street trees required x 12=         B. % Native shrubs required: Number of shrubs provided x 50%=         43         0         LARGE SHRUBS OR SMALL TREES         A. Number of large shrubs or small trees required: Number of required shrubs x 10%=         9       0         B. % Native large shrubs or small trees required: Number of large shrubs or	E.			
SHRUBS         A. Number of shrubs required: Sum of lot and street trees required x 12=         B. % Native shrubs required: Number of shrubs provided x 50%=         43         0         LARGE SHRUBS OR SMALL TREES         A. Number of large shrubs or small trees required: Number of required shrubs x 10%=         9       0         B. % Native large shrubs or small trees required: Number of large shrubs or		<u>N/A</u> linear feet along street divided by 20'=	N/A	N/A
A. Number of shrubs required: Sum of lot and street trees required x 12=       86       162         B. % Native shrubs required: Number of shrubs provided x 50%=       43       0         Image: A street of the structure of the				
B. % Native shrubs required: Number of shrubs provided x 50%=       0         LARGE SHRUBS OR SMALL TREES         A. Number of large shrubs or small trees required: Number of required shrubs x 10%=         9       0         B. % Native large shrubs or small trees required: Number of large shrubs or		SHRUBS		
LARGE SHRUBS OR SMALL TREES         A. Number of large shrubs or small trees required: Number of required shrubs x 10%=         9       0         B. % Native large shrubs or small trees required: Number of large shrubs or	A.	Number of shrubs required: Sum of lot and street trees required x 12=	86	162
A. Number of large shrubs or small trees required: Number of required shrubs         x 10%=       9       0         B. % Native large shrubs or small trees required: Number of large shrubs or	В.	% Native shrubs required: Number of shrubs provided x 50%=	43	0
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x 10%= 9 0 B. % Native large shrubs or small trees required: Number of large shrubs or	_			
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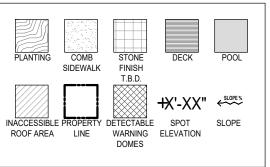
	INDEX
SHEET #	SHEET TITLE
L-0.00	COVER SHEET & NOTES
L-0.01	EXISTING TREE SURVEY
L-1.01	GROUND LVL HARDSCA
L-1.02	LVL 7 HARDSCAPE PLAN
L-1.03	ROOF LVL HARDSCAPE
L-2.01	GROUND LVL HARDSCA
L-2.02	LVL 7 HARDSCAPE SECT
L-2.03	ROOF LVL HARDSCAPE
L-2.04	ROOF LVL HARDSCAPE
L-3.00	TREE DISPOSITION PLA
L-3.01	GROUND LVL LANDSCAF
L-3.02	LVL 6 LANDSCAPE PLAN
L-3.03	ROOF LVL LANDSCAPE F
L-3.04	GENERAL PLANTING NO
L-3.05	GENERAL PLANTING NO
L-3.06	GREEN ROOF GENERAL
L-3.07	LVL 7 OPEN SPACE DIAG
L-3.08	ROOF LVL OPEN SPACE
L-4.01	GROUND LVL LANDSCAF
L-4.02	LVL 7 LANDSCAPE LIGH
L-4.03	ROOF LVL LANDSCAPE L
IR-1.01	GROUND LVL IRRIGATIO
IR-1.02	LVL 7 IRRIGATION PLAN
IR-1.03	ROOF LVL IRRIGATION F
IR-2.00	IRRIGATION NOTES & DE

## SCOPE OF WORK

## **GENERAL SITE NOTES**

- CONTRACTOR'S ATTENTION. BUILDING CODE, MANUFACTURER'S RECOMMENDATIONS, AND SPECIFICATIONS.
- FACILITIES. SHOP FABRICATION. 9.
- EQUIPMENT AT ALL TIMES.

## GRAPHIC LEGEND



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•HARDSCAPE, LANDSCAPE, IRRIGATION, AND LANDSCAPE LIGHTING WITHIN THE PROPERTY LINE AND THE LANDSCAPE AND LANDSCAPE LIGHTING FOR THE R.O.W.

1. GENERAL CONTRACTOR, SUBCONTRACTORS, AND INSTALLERS SHALL CROSS REFERENCE ARCH. DWGS, ENGINEERING DWGS., AND LANDSCAPE DWGS., THROUGHOUT THE IMPLEMENTATION TO ENSURE THE DESIGN INTENT IS MET. ANY DISCREPANCIES SHALL BE NOTED AND BROUGHT TO THE GENERAL

SEE CIVIL AND ARCHITECTURE DRAWINGS FOR F.F.E & SURFACE DRAINAGE SEE MEP AND CIVIL DRAWINGS FOR IRRIGATION CONNECTIONS. SEE STRUCT. ENG. DRAWINGS FOR STRUCTURAL COMPONENTS. SEE ELECTRICAL ENG. DRAWINGS FOR LANDSCAPE LIGHTING WIRING. ALL WORK, MATERIALS, AND EQUIPMENT UTILIZED IN THIS PROJECT SHALL BE INSTALLED IN STRICT ACCORDANCE WITH THE GOVERNING ZONING &

CONTRACTOR SHALL BE RESPONSIBLE FOR VISITING SITE PRIOR TO BIDDING IN ORDER TO FAMILIARIZE THEMSELVES WITH ALL EXISTING CONDITIONS AFFECTING THE WORK, INCLUDING BUT NOT LIMITED TO PRIVATE AND PUBLIC UTILITIES, ON AND OFF SITE, ACCESS ROADS, AND OTHER SUPPORT


CONTRACTOR MUST NOTIFY LANDSCAPE ARCHITECT IMMEDIATELY OF ANY UNEXPECTED OR UNKNOWN CONDITIONS OR DISCREPANCIES IN THE DRAWINGS AND CONTRACT DOCUMENTS, AS WELL AS ANY ERRORS OR OMISSIONS ON THE DRAWINGS PRIOR TO PROCEEDING WITH THE WORK OR

CONTRACTOR SHALL PREPARE AND MAINTAIN ALL CONSTRUCTION AREAS, AS WELL AS SURROUNDING AREAS FREE OF DEBRIS OR HAZARDOUS PROJECT

TORINO GARAGE 400 COLLINS AVE., MIAMI BEACH, FL 33139 Owner: Savoy Hotel Partners, LLC c/o Allied Partners 770 Lexington Ave 17th Floor New York, NY 10065-8165 Architect: Brandon Haw Architecture LLP 375 Park Avenue, Suite 3308 New York, NY 10152 License # AA26003249 CONSULTANTS Structural Engineer: DeSimone 800 Brickell Avenue, 6th Floor Miami, FL 33131 MEP Engineer: Stantec 3915 Biscayne Blvd, Suite 401 Miami, FL 33137-3737 VSN Engineering, Inc. 8660 W. Flagler Street, Suite 113 Miami, FL 33144 Geo-tech Engineer: Langan 15150 NW 79th Court, Suite 200 Miami Lakes, FL 33016-5848 Life Safety Consultant: SLS Consulting, Inc. 260 Palermo Avenue Coral Gables, FL 33134 Parking Consultant: Timothy Haahs & Associates, Ir 40 NW 3rd Street, Suite 1102 Miami, FL 33128 Elevator Consultant: Van Deusen & Associates, Inc. 8201 Peters Road, Suite 1000 Plantation, FL 33324 Acoustic Consultant: Electro-Media Design, Ltd. 973-C Russell Avenue Gaithersburg, MD 20879 Gaithersburg, MD 20879 Landscape Architect: Naturalficial, Inc. 6915 Red Road, Suite 224 Coral Gables, FL 33143 Contact: Andres Arcila O: 786.717.6564 / M: 305.321.2341 Firm Reg. No. LC26000548 NO. DESCRIPTION DATE OF ISSUE DRAWN BY 04/08/2019 PS & AR SCALE CHECKED BY AA & PA NTS PROJECT NO. & TITLE Project Title TORINO GARAGE PROJECT STATUS FINAL PLANNING BOARD SUBMIT KEY PLAN SCALE & ORIENTATION Ð SEAL & SIGNATURE


Peter Anselmo R.L.A. FL# 6667221 DRAWING TITLE

L-0.00 COVER SHEET & NOTES

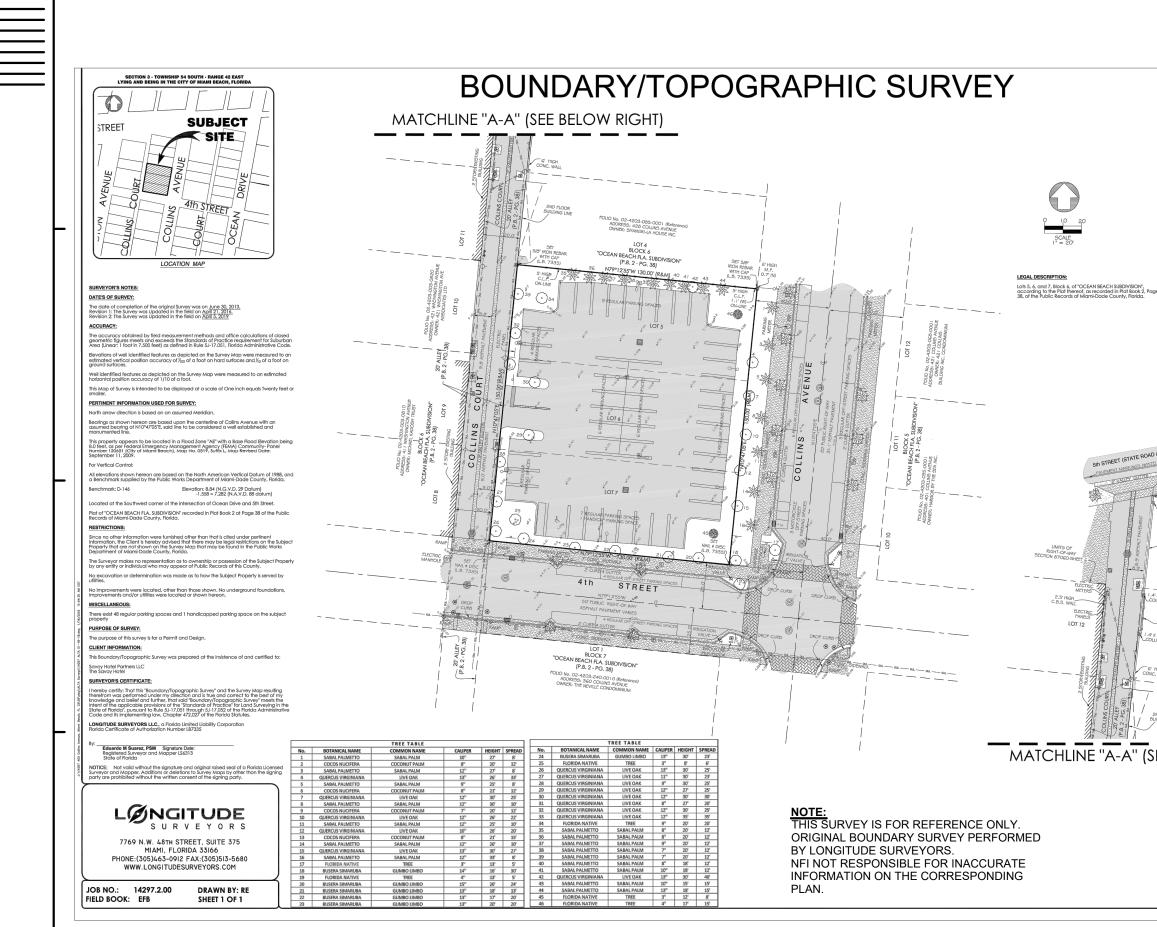


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2 Nou In-	·
2' HIGH LIMITS CON GATE SECTION 8706 4'	OF -WAY -O-SHEET 6
LOT 2 IGH WALL	
BLOCK 6 A <u>N BEACH FLA, SUBDIVISK</u> (P.B. 2 - PG. 38) H H LOT 3	24"
(P.B. 2 - PG. 38)	2
(P.B. 2 - PG. 38)	2
(P.B. 2 - PG, 38) (P.B. 2 - PG, 38)	24"
(P.S. 2 - PG, 38)	
(P.B. 2 - PG, 38)	
USERALH FLA_SUBDIVISIE (P.B. 2 - P.G. 38)	
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2012FALH FLA_SUBDIVISION (P.B. 2 - P.G. 38) z LOT 3	
USERALH FLA_SUBDIVISIE (P.B. 2 - P.G. 38)	
(P.8. 2 - PG, 38)	
(P.S. 2 - PG, 38)	

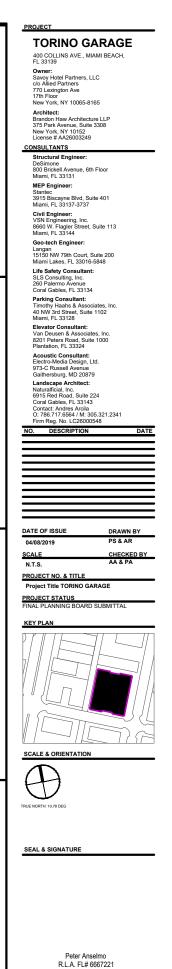


L-0.01 EXISTING TREE SURVEY

DRAWING TITLE

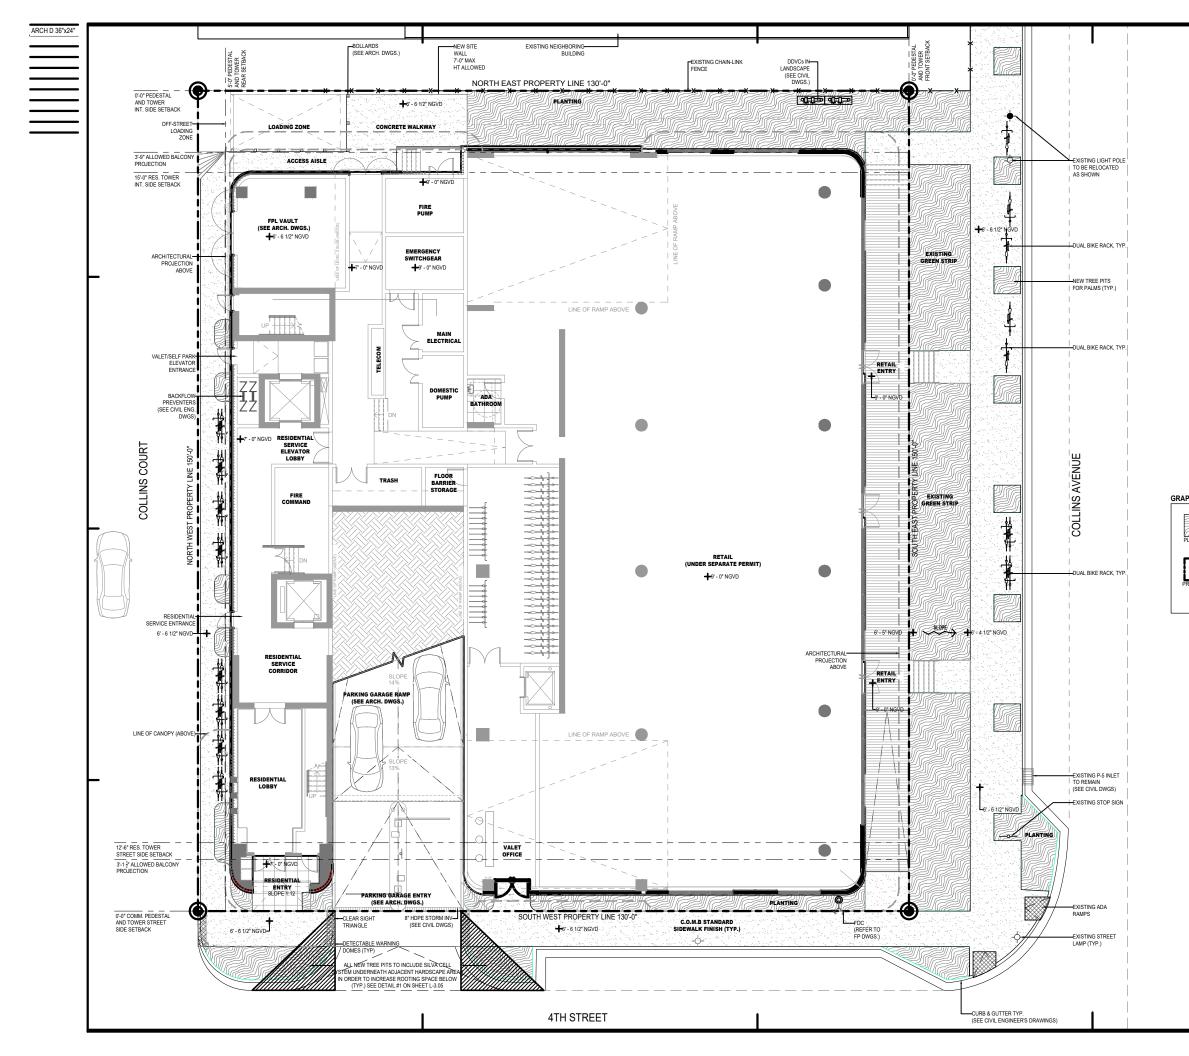

## GRAPHIC LEGEND

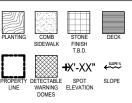

## PROJECT

## TORINO GARAGE

400 COLLINS AVE., MIAMI BEACH, FL 33139 Owner: Savoy Hotel Partners, LLC có Alied Partners 770 Lexington Ave 17th Floor New York, NY 10065-8165

Architect: Brandon Haw Architecture LLP 375 Park Avenue, Suite 3308 New York, NY 10152 License # AA26003249

CONSULTANTS Structural Engineer:

Structural Engineer: DeSimone 800 Brickell Avenue, 6th Floor Miami, FL 33131

MEP Engineer: Stantec 3915 Biscayne Blvd, Suite 401 Miami, FL 33137-3737 Civil Engineer:

Civil Engineer: VSN Engineering, Inc. 8660 W. Flagler Street, Suite 113 Miami, FL 33144 Geo-tech Engineer:

Geo-tech Engineer: Langan 15150 NW 79th Court, Suite 200 Miami Lakes, FL 33016-5848

Life Safety Consultant: SLS Consulting, Inc. 260 Palermo Avenue Coral Gables, FL 33134

Parking Consultant: Timothy Haahs & Associates, Ir 40 NW 3rd Street, Suite 1102 Miami, FL 33128

Elevator Consultant: Van Deusen & Associates, Inc. 8201 Peters Road, Suite 1000 Plantation, FL 33324

Acoustic Consultant: Electro-Media Design, Ltd. 973-C Russell Avenue Gaithersburg, MD 20879

Gaithersburg, MD 20879 Landscape Architect: Naturalficial, Inc. 6915 Red Road, Suite 224 Coral Gables, FL 33143 Contact: Andres Arcila O: 786.717.6564 / M: 305.321.2341 Firm Reg. No. LC26000548

## NO. DESCRIPTION

DATE OF ISSUE

04/08/2019 SCALE 1/8" = 1'-0"

CHECKED BY AA & PA

DRAWN BY

PS & AR

PROJECT NO. & TITLE Project Title TORINO GARAGE

PROJECT STATUS FINAL PLANNING BOARD SUBMITTA

## KEY PLAN



SCALE & ORIENTATION




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SEAL & SIGNATURE


Peter Anselmo R.L.A. FL# 6667221

L-1.01 GROUND LVL HARDSCAPE PLAN

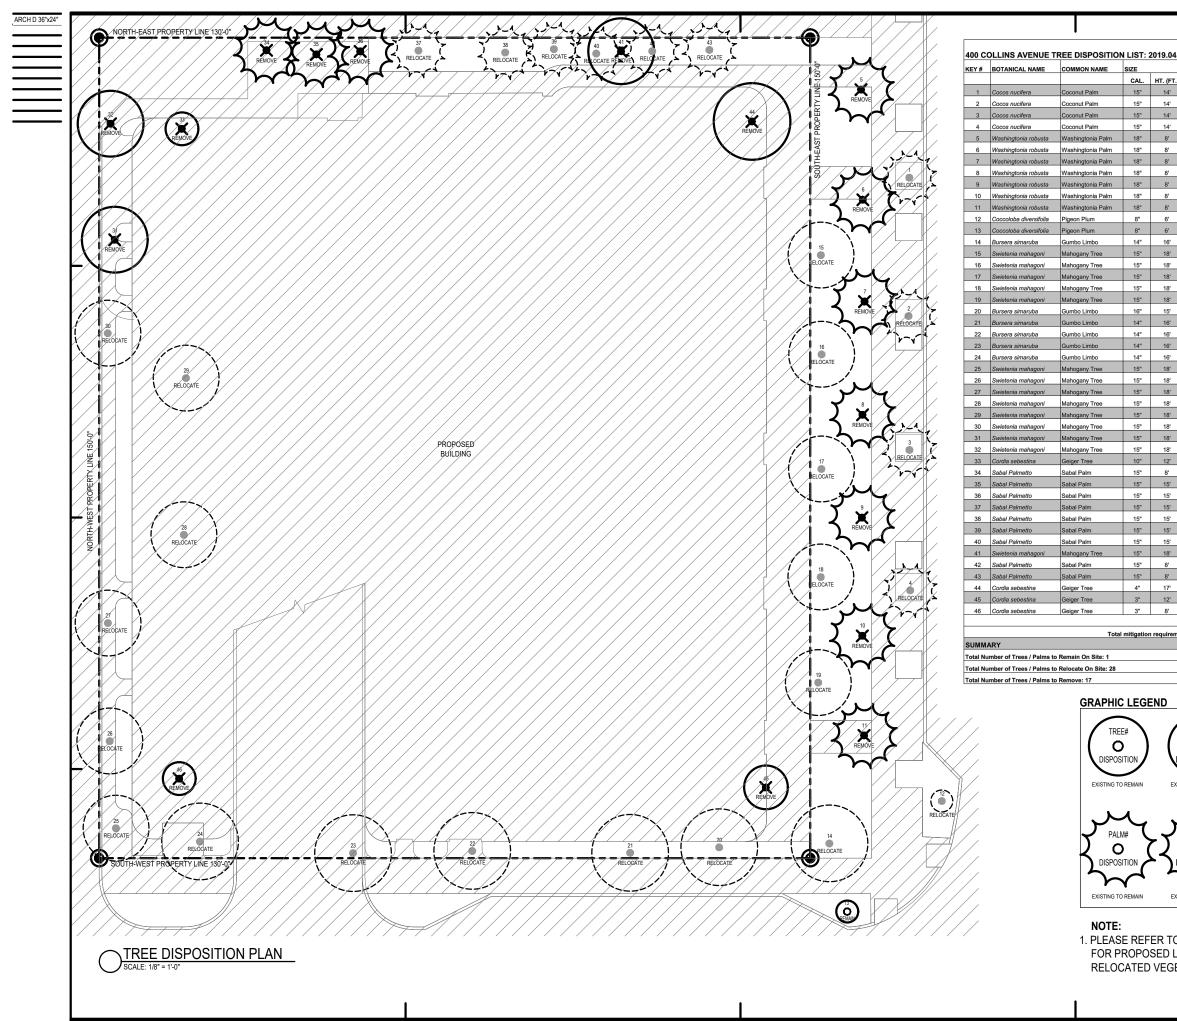

	DISPOSITIO	N		CANOPY MITIGATION
SPD. (FT.)	REMAIN	REMOVE	RELOCATE	CANOPY SQ.FT.
10'			x	
10' 10'			x x	
10'			x	
12'		x		N/A
12'		x		N/A
12'		x		N/A
12'		X		N/A
12' 12'		x		N/A N/A
12'		x		N/A
3'			x	
3'	х			
15'			X	
12' 12'			x x	
12'			x	
12'			x	
12'			x	
15'			x	
15' 15'			x x	
15'			x	
15'			x	
12'			x	
12'			x	
12'			x	
12' 12'			x x	
12'			x	
12'		х		113
12'		x		113
6'		X		28
10' 8'		x		78 50
8'		x		50
8'			x	
8'			x	
8'			x	
8' 12'		x	X	113
12'		~	x	113
10'			x	
15'	_	x		176
8'		х		50
6'		X	ved Canopy:	28 <b>799</b>
			try Reviewer	
_				
TREE#		DISPO	SITION	FOOTPRINT OF PROPOS STRUCTURES INCLUDI HARDSCAPE AREAS
		PAL DISPO		

PROJECT **TORINO GARAGE** 400 COLLINS AVE., MIAMI BEACH, FL 33139 Owner: Savoy Hotel Partners, LLC c/o Allied Partners 770 Lexington Ave 17th Floor New York, NY 10065-8165 Architect: Brandon Haw Architecture LLP 375 Park Avenue, Suite 3308 New York, NY 10152 License # AA26003249 CONSULTANTS Structural Engineer: DeSimone 800 Brickell Avenue, 6th Floor Miami, FL 33131 MEP Engineer: Stantec 3915 Biscayne Blvd, Suite 401 Miami, FL 33137-3737 VSN Engineering, Inc. 8660 W. Flagler Street, Suite 113 Miami, FL 33144 Geo-tech Engineer: Langan 15150 NW 79th Court, Suite 200 Miami Lakes, FL 33016-5848 Life Safety Consultant: SLS Consulting, Inc. 260 Palermo Avenue Coral Gables, FL 33134 Parking Consultant: Timothy Haahs & Associates, Ir 40 NW 3rd Street, Suite 1102 Miami, FL 33128 Elevator Consultant: Van Deusen & Associates, Inc. 8201 Peters Road, Suite 1000 Plantation, FL 33324 Acoustic Consultant: Electro-Media Design, Ltd. 973-C Russell Avenue Gaithersburg, MD 20879 Gaithersburg, MD 20879 Landscape Architect: Naturalficial, Inc. 6915 Red Road, Suite 224 Coral Gables, FL 33143 Contact: Andres Arcila O: 786.717.6564 / M: 305.321.2341 Firm Reg. No. LC26000548 NO. DESCRIPTION **ATE** DATE OF ISSUE DRAWN BY 04/08/2019 PS & AR SCALE CHECKED BY AA & PA 1/8" = 1'-0" PROJECT NO. & TITLE Project Title TORINO GARAGE PROJECT STATUS FINAL PLANNING BOARD SUBMI KEY PLAN SCALE & ORIENTATION E 5' SEAL & SIGNATURE Peter Anselmo R.L.A. FL# 6667221 DRAWING TITLE L-3.00 TREE DISPOSITION PLAN

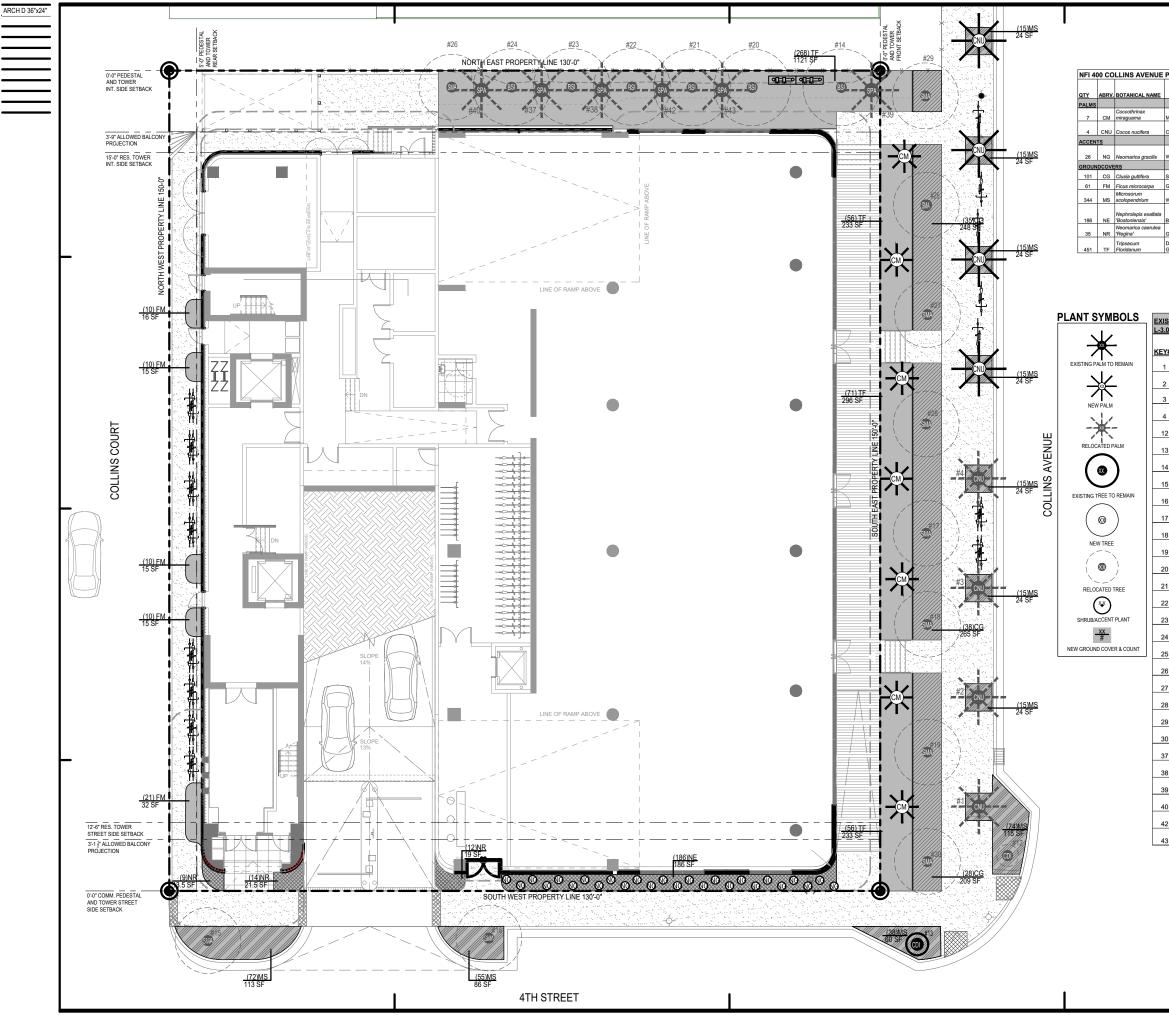

## NFI 400 COLLINS AVENUE PLANT LIST: GROUND FLOOR - 2019.04.23

COMMON NAME	SPECIFICATIONS	FL. NATIVE		DROUGHT TOLERANT		MITIGATION CREDIT
		YES	NO	YES	NO	
Miraguama Palm	4'-6' HT.	x		x		
Coconut Palm	14' HT. to match existing		x	x		800
White Walking Iris	3G @ 15" O.C.		x		x	
Small Leaf Clusia	15G @ 36" O.C.	х		х		
Green Island Ficus	3G @ 15" O.C.		х		х	
Wart Fern	3G @ 15" O.C.		x	x		
Boston fern	3G @ 12" O.C.	x		x		
Giant Apostle's Iris	3G @ 15" O.C.		х		х	
Dwarf Fakahatchee Grass / Gama Grass	3G @ 24" O.C.	x		x		

		EES & DISPOSITIO	<u>N (Refer to Tree Dis</u>	position List on
.00	for size	es & specs)	-	1
<u>Y#</u>	ABRV.	BOTANICAL NAME	COMMON NAME	DISPOSITION
1	CNU	Cocos nucifera	Coconut Palm	Relocate
2	CNU	Cocos nucifera	Coconut Palm	Relocate
3	CNU	Cocos nucifera	Coconut Palm	Relocate
4	CNU	Cocos nucifera	Coconut Palm	Relocate
2	CDI	Coccoloba diversifolia	Pigeon Plum	Relocate
3	CDI	Coccoloba diversifolia	Pigeon Plum	Remain
4	BSI	Bursera simaruba	Gumbo Limbo	Relocate
5	SMA	Swietenia mahagoni	Mahogany Tree	Relocate
6	SMA	Swietenia mahagoni	Mahogany Tree	Relocate
7	SMA	Swietenia mahagoni	Mahogany Tree	Relocate
8	SMA	Swietenia mahagoni	Mahogany Tree	Relocate
9	SMA	Swietenia mahagoni	Mahogany Tree	Relocate
0	BSI	Bursera simaruba	Gumbo Limbo	Relocate
:1	BSI	Bursera simaruba	Gumbo Limbo	Relocate
2	BSI	Bursera simaruba	Gumbo Limbo	Relocate
3	BSI	Bursera simaruba	Gumbo Limbo	Relocate
4	BSI	Bursera simaruba	Gumbo Limbo	Relocate
25	SMA	Swietenia mahagoni	Mahogany Tree	Remain
6	SMA	Swietenia mahagoni	Mahogany Tree	Relocate
7	SMA	Swietenia mahagoni	Mahogany Tree	Relocate
		Swietenia		
8	SMA	mahagoni Swietenia	Mahogany Tree	Relocate
9	SMA	mahagoni Swietenia	Mahogany Tree	Relocate
0	SMA	mahagoni	Mahogany Tree	Relocate
7	SPA	Sabal Palmetto	Sabal Palm	Relocate
8	SPA	Sabal Palmetto	Sabal Palm	Relocate
9	SPA	Sabal Palmetto	Sabal Palm	Relocate
0	SPA	Sabal Palmetto	Sabal Palm	Relocate
2	SPA	Sabal Palmetto	Sabal Palm	Relocate
3	SPA	Sabal Palmetto	Sabal Palm	Relocate

## PROJECT

## TORINO GARAGE 400 COLLINS AVE., MIAMI BEACH, FL 33139 Owner: Savoy Hotel Partners, LLC c/o Allied Partners 770 Lexington Ave 17th Floor New York, NY 10065-8165 Architect: Brandon Haw Architecture LLP 375 Park Avenue, Suite 3308 New York, NY 10152 License # AA26003249 CONSULTANTS Structural Engineer: DeSimone 800 Brickell Avenue, 6th Floor Miami, FL 33131 MEP Engineer: Stantec 3915 Biscayne Blvd, Suite 401 Miami, FL 33137-3737 Civil Engineer: VSN Engineering, Inc. 8660 W. Flagler Street, Suite 113 Miami, FL 33144 Geo-tech Engineer: Langan 15150 NW 79th Court, Suite 200 Miami Lakes, FL 33016-5848

Life Safety Consultant: SLS Consulting, Inc. 260 Palermo Avenue Coral Gables, FL 33134

Parking Consultant: Timothy Haahs & Associates, Ir 40 NW 3rd Street, Suite 1102 Miami, FL 33128

Elevator Consultant: Van Deusen & Associates, Inc 8201 Peters Road, Suite 1000 Plantation, FL 33324

Acoustic Consultant: Electro-Media Design, Ltd. 973-C Russell Avenue Gaithersburg, MD 20879

Gaithersburg, MD 20879 Landscape Architect: Naturalficial, Inc. 6915 Red Road, Suite 224 Coral Gables, FL 33143 Contact: Andres Arcila O: 786.717.6564 / M: 305.321.2341 Firm Reg. No. LC26000548

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DATE OF ISSUE DRAWN BY 04/08/2019 PS & AR CHECKED BY SCALE AA & PA 1/8" = 1'-0"

PROJECT NO. & TITLE Project Title TORINO GARAGE

PROJECT STATUS FINAL PLANNING BOARD





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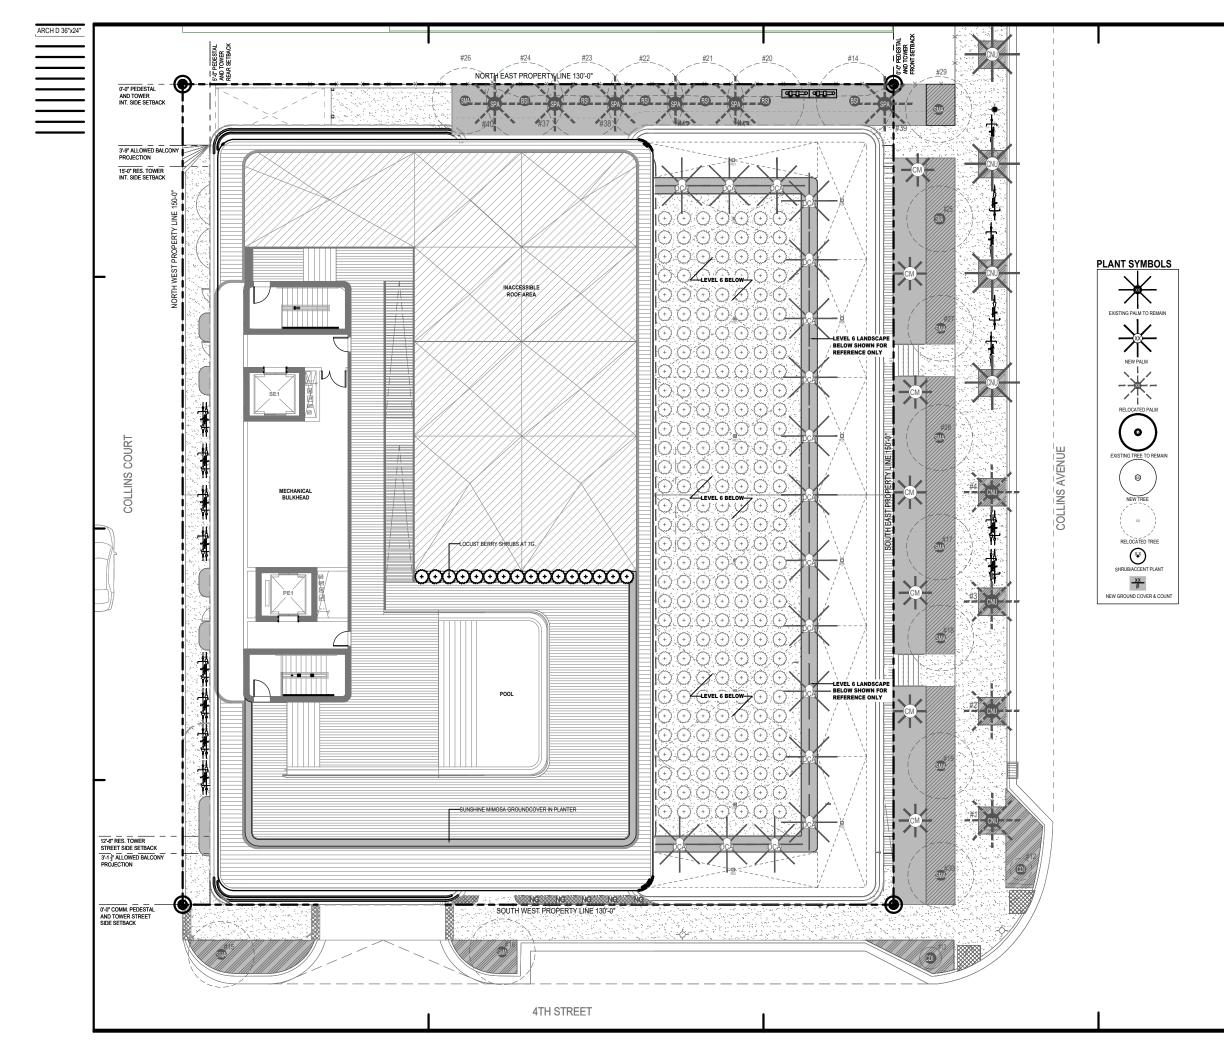


Peter Anselmo R.L.A. FL# 6667221 DRAWING TITLE

L-3.01 GROUND LVL LANDSCAPE PLAN



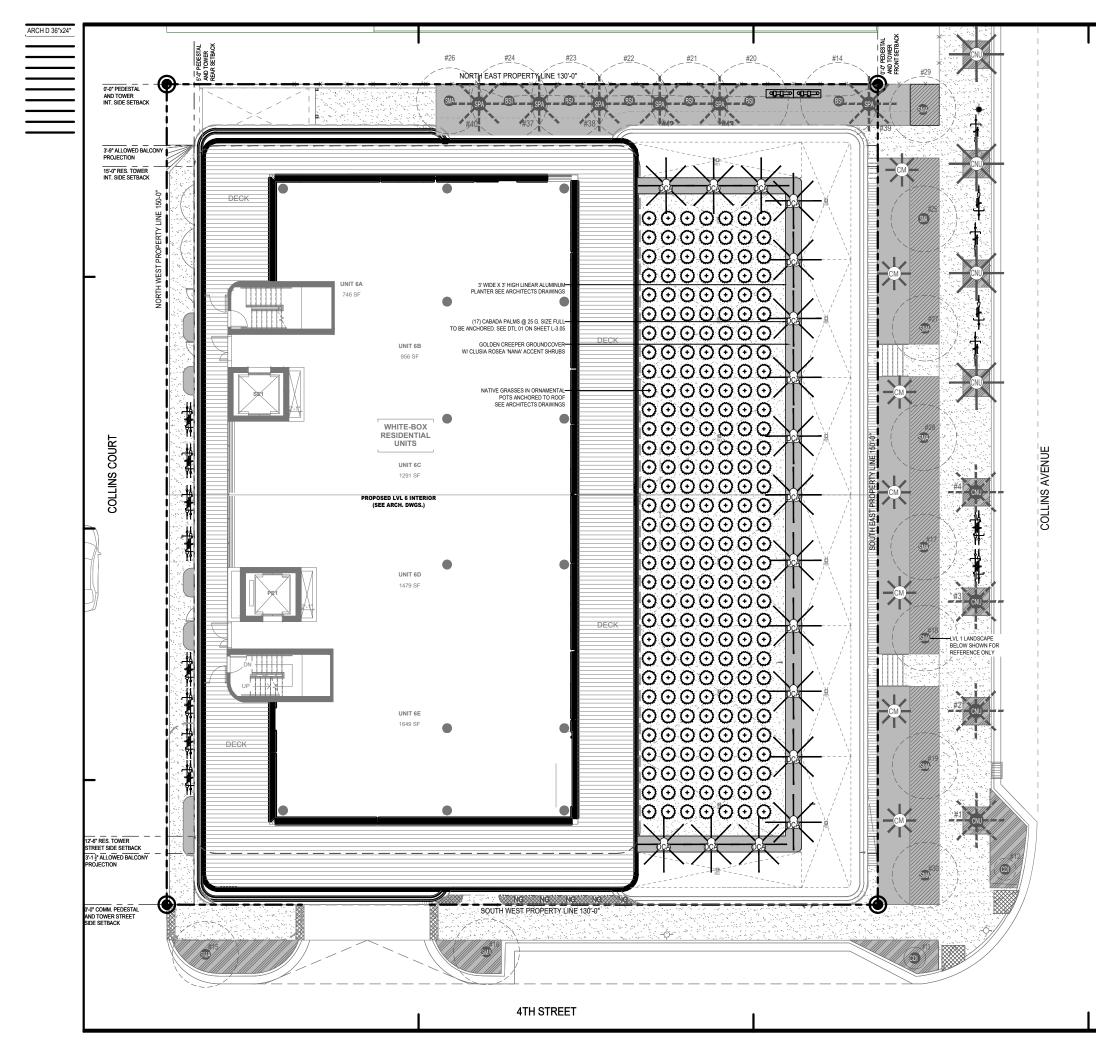

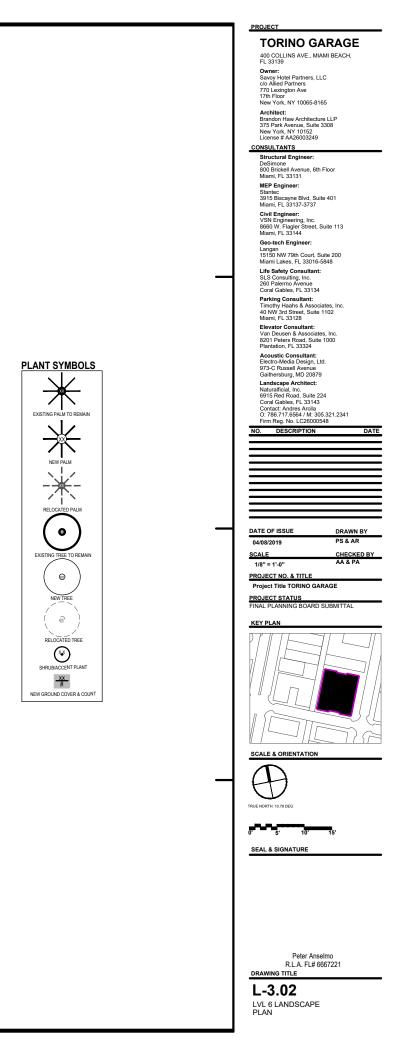

PROJECT
TORINO GARAGE
400 COLLINS AVE., MIAMI BEACH,
FL 33139
Owner: Savoy Hotel Partners, LLC
c/o Allied Partners 770 Lexington Ave
17th Floor New York, NY 10065-8165
Architect:
Brandon Haw Architecture LLP 375 Park Avenue, Suite 3308
375 Park Avenue, Suite 3308 New York, NY 10152 License # AA26003249
CONSULTANTS
Structural Engineer: DeSimone
800 Brickell Avenue, 6th Floor Miami, FL 33131
MEP Engineer:
Stantec 3915 Biscayne Blvd, Suite 401
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## GENERAL PLANTING NOTES AND SPECIFICATIONS:

AIN WHICH ARE SCARRED OR DESTROYED WILL BE REPLACED AT CONTRACTORS EXPENSE, WITH SIMILAR SPECIES, SIZE AND 7158 123rd Circle N EXISTING TREES DESIGNATED TO BE STORED OFF-SITE, SHALL BE PH: 1.888.947.3256

TECTED AND CARED FOR ACCORDING TO INDUSTRY STANDARD. PL7235844000 TITEES ON SHUBS SCARED OR DESTROYED WILL BE REPLACED LE CONTRACTORS DEPRESS, WITH SMULAR SPECIES, SZE AND 2. POSTS & RAIL: METAL POST, SUFFICIENT TO HOLD FABRIC PLUMB AND TAUT

ANDSCAPE CONTRACTOR SHALL BECOME FAMILAR WITH ALL DERGROUND UTILITIES OR STRUCTURES FRIOR TO DIGGING. 4. METAL CATE: SHALL PERMIT FREE PASSAGE OF WATER, AIR AND SHALL DIGCAPE CONTRACTOR SHALL REPAIR ALL DAMAGE TO UTILITIES, ACCEPT CONSTRUCTION CAUSED BY CONSTRUCTION OR DIGGING, AT OSTTO THE OWNER. OST TO THE OWNER

ALL PLANT MATERIALS SHALL BE GUARANTEED FOR A PERIOD OF 12 1 LANDSCAPE CONTRACTOR SHALL PROVIDE A MINIMUM OF ONE (1) YEA THS AFTER DATE OF SUBSTANTIAL COMPLETION.

DSCAPE CONTRACTOR SHALL VERIFY ALL ESTIMATED QUA

ALL BUILDING CONSTRUCTION MATERIAL AND FOREIGN MATERIAL ALL BE REMOVED FROM PLANTING AREAS AND REPLACED WITH 80/20 FILL SOIL, OR AS PER SPECIFICATIONS. ALL ISLANDS IN PARKING S AND AROUND BUILDINGS, SHALL BE EXCAVATED TO A DEPTH OF 3

TIS AND AROUND BUILDINGS SHALL BE EXCAVITED TO A DEPTH OF 9 THE L/PAUM RELOCATION NOTES IN AND REPLACED WITH 8020 PLAYTIMK, OR AS PER SPECIFICATIONS IN AND REPLACED WITH 8020 PLAYTIMK, OR AS PER SPECIFICATIONS AUL PLAYTIMETERIAL SYNBOLS SHOWN ON LANDSCAPE PLAN SHALL DOWNINGS AND THOSE TAGGED IN THE PLEU DOWNESSYNU AS TO NUMBER AND DESCRIPTION. AN' DISCREPANCIES SHALL BE BROUGHT TO THE DATIONS ANT DISCREPANCIES SHALL BE BROUGHT TO THE AND DESCREPANCIES SHALL BE BROUGHT TO THE DESTRUCTIONS AFTER CONSULTING THE LANDSCAPE AROUNDES IL SIZES SHOWN OR PLAYTIMET, THE PLAN DESCREPANCIES SHALL BE RESTRUCTIONS AFTER CONSULTING THE LANDSCAPE AROUNDES AND DESCREPANCIES SHALL BE RESPONSIBLE FOR TREE-PLAN RETO BE CONSIDERED MINIMAL ALL PLAYTI MATTERIAL MIST MEET TO RECONSIDERED MINIMA ALL PLAYTI MATTERIAL MIST MEET TO PREAD. ANY OTHER RECUIREDERS FOR SPECIFIC SHALE OR EFFECT 3. THEE ROOT BALL SHALL BE DER FORINGE FOR SPECIFIC SHALE OR EFFECT 3. THEE ROOT BALL SHALL BE DER FORINGE FOR SPECIFIC SHALE OR EFFECT 3. THEE ROOT BALL SHALL BE DER FORINGE FOR SPECIFIC SHALE OR EFFECT 3. THEE ROOT BALL SHALL BE DER FORINGE FOR SPECIFIC SHALE OR EFFECT 3. THEE ROOT BALL SHALL BE DER FORINGE FOR SPECIFIC SHALE OR EFFECTION 3. THEE ROOT BALL SHALL BE DER FORINGE FOR SPECIFIC SHALE OR EFFECTION 3. THER ROOT BALL SHALL BE DOTS THE FORMER SO THE FORMER DO DAYS FOR TO TAXASPLAYTIME. 3. THERE ROOT BALL SHALL BE DOTS TO BE FORMED DO DAYS FOR TO TAXASPLAYTIM. 3. THERE ROOT BALL SHALL BE DOTS THE FREID AND DE BALS 3. THERE ROOT BALL SHALL BE DOTS THE REDUCTION DATE BALS 3. THERE ROOT BALL SHALL BE TO STER STER THE REDUCTION AND REMOVE 3. THERE ROOT BALL SHALL AND THE BE DOTS THE FORMER DATE TO TAXESPLAY. 3. THERE ROOT BALL SHALL AND THE BAL BALS 3. THERE ROOT BALL SHALL AND THE SHOULD DATE THE DATE THE ROOT BALL SHALE DATE TO TAXESPLAY. 3. THERE ROOT BAL

ALL PLANT MATERIAL TO BE FLORIDA #1 OR BETTER, AS DEFINED BY FLORIDA DEPARTMENT OF AGRICULTURES "CODES AND STANDARDS I NURSERY PLANTS PART I AND II".

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ON-SITE LAYOUT OF PLANT MATERIAL MUST BE COORDINATED WITH E LANDSCAPE ARCHITECT PRIOR TO INSTALLATION. LA. TO BE GIVEN IN. OF (1) WEEK NOTICE TO REVIEW PRIOR TO IMPLEMENTATION.

IN O 1() WEEN KONGE LONE LEVER FROM TO MIRE ALLANDATIONS LANSCAPE, CONTRACTOR TO INCLUDE FREMOVAL NING AND OR REPACEMENT. ANY CORRECTIVE ACTIONS REQUIRED LI BE PERFORMED OR DIRECTED BY AN IS AO A SACC ACHTIFED SORST IN ACCORDANCE WITH IMAIN DADE COUNTY CODE AVSI A000 RT(I) PRUNING STANDARDS AND OR AN ISSUED ERM TREE OR IRFORMENTAL PERMIT.

5'-5 % 48" THEE PROTECTION BARRIERS MUST BE INSTALLED AT THE DRIP LINES ALL TREES AND PALMS TO REMAIN OR BE RELOCATED PRIOR TO THE BORDROTTOMULY AT TURES (NUMCER OF BOATS AND THE AND THE PROTECTION AND AT TURES (NUMCER OF BOATS AND THE AND THE E UNTIL CONSTRUCTION HAS COMPLETED

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ANULL ANY CORRECTIVE STRUCTURAL PRUNING BE NECESSARY THEES PROPOSED TO REMAIN ON SITE, DUE TO CLEARANCE, ETY OR FOR CONSTRUCTION RELATED REASONS THE PRUNING LI BE PERFORMED OR DIRECTED BY AN ISA OR ASCA CERTIFIED LEE PENHOUNDE OF BUILDERE LETEST VERSION IF THE ANSI A300 REMOVED, INCLUDING THE COMPLETE AND INFORMATION AND PARTS THEREOF. ING STANADARDS AND GOOD HORTICULTURAL PRACTICES. THE CITY MORDESTE SHALL BE PROVIDED WITH A WRITEN CONFORM OF OF THE RESIDUEL ROOTS, STUMPS AND PORTIONS AND PARTS THEREOF. IS RESTORE THE SURFACE WITH MATERIAL TO MARKADE ADDRESS AND PORTIONS AND PARTS THEREOF. IS RESTORE THE SURFACE WITH MATERIAL TO MARKADE ADDRESS AND PORTIONS AND PARTS THEREOF. IS RESTORE THE SURFACE WITH MATERIAL TO MARKADE ADDRESS AND PORTIONS AND PARTS THEREOF. IS RESTORE THE SURFACE WITH MATERIAL TO MARKADE ADDRESS AND PORTIONS AND PARTS THEREOF. IS RESTORE THE SURFACE WITH MARKADE ADDRESS AND PORTIONS AND PARTS THEREOF. IS RESTORE THE SURFACE WITH MARKADE ADDRESS AND PORTIONS AND PARTS THEREOF. IS RESTORE THE SURFACE WITH MARKADE ADDRESS AND PORTIONS AND PARTS THEREOF. IS RESTORE THE SURFACE WITH MARKADE ADDRESS AND PORTIONS AND PARTS THEREOF. IS RESTORE THE SURFACE WITH MARKADE ADDRESS AND PORTIONS AND PARTS THEREOF. IS RESTORE THE SURFACE WITH MARKADE ADDRESS AND PORTIONS AND PARTS THEREOF. IS RESTORE THE SURFACE WITH MARKADE ADDRESS AND PORTIONS AND PARTS THEREOF. IS RESTORE THE SURFACE WITH MARKADE ADDRESS AND PORTIONS AND PARTS THEREOF. IS RESTORE THE SURFACE WITH MARKADE ADDRESS AND PORTIONS AND PARTS THEREOF. IS RESTORE THE SURFACE WITH MARKADE ADDRESS AND PORTON ADDRESS AND P

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 MAREINAL TO BE APPROVED BY LANGSCAPE ARCHITECT. CONTRACTOR TO CARE SHALL BE TKEN TO AVOID UTLITY OR CONSTRUCTION NOTHING THROUGH EXISTING THEE OR PAUL DREPLAYES OF THESE TO THE MILL BE INCOME. THE COLOCATE J. FORSTRUCTION BUT NOT LIMITED TO BEARRING HAMEBRAL, PROTECTION FENCING, FLAGSING, BUT NOT LIMITED TO BEARRING HAMEBRAL, PROTECTION FENCING, FLAGSING, BUT NOT LIMITED TO BEARRING HAMEBRAL, PROTECTION FENCING, FLAGSING, BUT NOT LIMITED TO BEARRING HAMEBRAL, PROTECTION FENCING, FLAGSING, BUT NOT LIMITED TO BEARRING HAMEBRAL, PROTECTION FENCING, FLAGSING, BUT NOT LIMITED TO BEARRING HAMEBRAL, PROTECTION FENCING, FLAGSING, BUT NOT BUT TO TALL BUFLAP OF SHIRK WAPP. SANG ASSO STANDARDS, OUT PROTS SHOLLD BE IMMEDIATELY NOT BROKEN BY TEAMY EQUIPMENT. SPREDEL, DRIGGED SEPTION SYSTEMS, ETC) ARE DOCARTING TO BUTHED, UNDERGING SEPTION SYSTEMS, ETC) ARE DECAMING FOR DUCLARLY MARKED AS SEPTION SYSTEMS, ETC) ARE DECAMING FOR HAMING THE STANDARD AN ARBORT MORE BUT HEAVY EQUIPMENT. SPREDEL, DRIGGED SEPTION SYSTEMS, ETC) ARE DECAMING FOR DUCLARLY MARKED AS SEPTION SYSTEMS, ETC) ARE DECAMING FOR MAINTING PROFILE PROFENDING DUCARLY MARKED AS SEPTIONS STANDARDS, OULD BE NOTE SHOLLD AN ARBORT MORE BUT HEAVY EQUIPMENT. SPREDEL, DRIGGED SEPTION SYSTEMS, ETC) ARE DECAMING FOR THE ADVISION OF DESTINGTIONS ON DESTINCTIONS (UTLITES, SEPTION SYSTEMS, ETC) ARE DECAMING FOR THE OR THE COLCARIES OF THE ADVISION OF DESTINGTIONS ON DESTINCTIONS ON DESTINCTIONS ON DESTINCTIONS ON DESTINCTIONS (UTLITES, SEPTION SYSTEMS, ETC) ARE DECAMING TO THE DUCLARED AND AND ARBORT SEPTION SYSTEMS, ETC) ARE DECAMING TO THE DUCLARED AND AND ARBORT SEPTIONS STANDARDS OULD BE NOTED AND AND ARBORT SEPTION SYSTEMS AND AND AND ARA DUCLARED AND AND THE DUCLARED AND AND THE DUCLARED AND AND THE D LD BE CONSULTED PRIOR TO ANY ROOT PRUNING TAKING PLACE

### HANDLING AND TRANSPORTATION

IBS, BRANCHES, AND FRONDS. DAMAGE TO TREE/PALM MAY BE JUSE FOR ITS REJECTION, AND MAY REQUIRE MITIGATION

OR CLIENT

ANDSCAPE CONTRACTOR SHALL BE RESPONSIBLE FOR INSTALLING ANDSCAPE CONTRACTOR SHALL BE RESPONSIBLE FOR INSTALING IN MAITAINNE TREEPAUL PROTECTION. INSTALL BARRCACE. OF VANZED WELDED WIRE FABRIC OR PLASTIC MESH TO ENCOMPASS DRIPLINE OF THE TREEPAUL BARRICADE SHALL BE PLUMB, TAUT, ) SURDY, BARRICADE TO BE LEFT UP AND MAINTAINED UNTIL ICTED TO REMOVE BY LANDSCAPE ARCHITECT.

TREE PROTECTION MATERIALS XISTING TREES DESIGNATED TO REMAIN SHALL BE PROTECTED 11. BARRICADE SHALL BE GALVANZED AND WELDED WIRE FABRIC: 1X1\* INIS ALL CONSTRUCTION PHAGES. ANY TREES DESIGNATED TO WESH 083, 48' IN HEIGHT RECOMMENDED CONTACT: INIS ALL CONSTRUCTION IN LEGEN AND IN THE AND INTERVENTION AND INTE

WARRANTY

GUARANTEE FOR ALL RELOCATED TREES/PALMS AFTER FINAL ACCEPTANCE BY LANDSCAPE ARCHITECT AND/OR CLIENT.

ANDSCAPE CONTRACTOR SHALL VERIFY ALL SETIMATED QUANTITIES MATERIAL SHOWN ON THE DRAWINGSPRIOT TO SIGNIFICATION SHALL BEAVING COMPLETELY AND DISPOSE OF POFSITE. ANY RELOCATED TREEPAUL THAT FALLS TO THRIVE AS DETEMINED BY PLANTING PLANT IN TAKE PRECEDENCE OVER PLANT LIST. EXISTING PLANT TAKEPRECEDENCE PLANT TAKEPRECEDENT PLANT LIST. EXISTING PLANT PLANT PLANT LIST. EXISTING PLANT PLANT PLANT LIST. EXISTING PLANT PLANT

TREE / PALM RELOCATION NOTES

NOTES

STE REPEARATION SHALL INCLUDE THE ERADICATION AND REMOVAL ANY WEEDS AND/OR GRASS, AS WELL AS CLEAN-UP OF ANY DEAL TERLA, AND RINKS GRADING AS PARTIES FEES. 5. ROOTS TO BE PRUNED WITH CLEAN, SHARP TOOLS, ROOTS ONE (1) INCH A 5. ROOTS TO BE PRUNED WITH CLEAN, SHARP TOOLS. ROOTS ONE (1) INCH AND LARGER IN DIAMETER SHALL BE NEATLY AND CLEANLY CUT WITH A HAND SAW ATERNU. AND FINISH GRAUININ AS YEAR INC STOLD. I. THE LANDSCAPE CONTRACTOR SHALL AT ALL TIMES KEEP THE JOB OR OTHER APPROVED CUITING IMPLEMENT AS DIRECTED BY AN ISA OR ASCA CERTIFIED ARBORIST.

ITE CLEAN AND FIRE FROM ACCUMULATION OF WASTE MATERIAL DEBRS, AND DUBBENH 21 THE LANDSCAPE CONTRACTOR SHALL DEPROISE CAUTION TO PROTECT 21 THE LANDSCAPE CONTRACTOR SHALL DEPROISE CAUTION TO PROTECT 21 THE LANDSCAPE CONTRACTOR SHALL DEPROISE CAUTION TO PROTECT 21 THE LANDSCAPE CONTRACTOR SHALL DEPROISE CAUTION TO PROTECT 21 THE LANDSCAPE CONTRACTOR SHALL DEPROISE CAUTION TO PROTECT 21 THE LANDSCAPE CONTRACTOR SHALL DEPROISE CAUTION TO PROTECT 21 THE LANDSCAPE CONTRACTOR SHALL DEPROISE CAUTION TO PROTECT 21 THE LANDSCAPE CONTRACTOR SHALL DEPROISE CAUTION TO PROTECT 21 THE LANDSCAPE CONTRACTOR SHALL DEPROISE CAUTION TO PROTECT 21 THE LANDSCAPE CONTRACTOR SHALL DEPROISE CAUTION TO PROTECT 21 THE LANDSCAPE CONTRACTOR SHALL DEPROISE CAUTION TO PROTECT 21 THE LANDSCAPE CONTRACTOR SHALL DEPROISE CAUTION TO PROTECT 21 THE LANDSCAPE CONTRACTOR SHALL DEPROISE CAUTION TO PROTECT 21 THE LANDSCAPE CONTRACTOR SHALL DEPROISE CAUTION TO PROTECT 21 THE LANDSCAPE CONTRACTOR SHALL DEPROISE CAUTION TO PROTECT 21 THE LANDSCAPE CONTRACTOR SHALL DEPROISE CAUTION TO PROTECT 21 THE LANDSCAPE CONTRACTOR SHALL DEPROISE CAUTION TO PROTING 21 THE LANDSCAPE CONTRACTOR SHALL DEPROISE CAUTION TO PROTING 21 THE LANDSCAPE CONTRACTOR SHALL DEPROISE CAUTION TO PROTING 21 THE LANDSCAPE CONTRACTOR SHALL DEPROISE CAUTION TO PROTING 21 THE LANDSCAPE CONTRACTOR SHALL DEPROISE CAUTION TO PROTING 21 THE LANDSCAPE CAUTION TO PROTING CONTRACTOR TO APPLY MICE CAUTION TO PROTING 21 THE LANDSCAPE CAUTION TO PROTING CAUTION TO PROTING TO PROTING THE AND SHALL DEPROISE CAUTION TO PROTING THE AND SHALL DEPROISE CAUTION TO PROTING TO PROTING THE AND SHALL DEPROTECT 21 THE LANDSCAPE CAUTION TO PROTING TO PROTING TO PROTING THE AND SHALL DEPROISE CAUTION TO PROTING TO PROTING THE AND SHALL DEPROTECT 21 THE CAUTION TO PROTING TO PROTECT AND TO PROTING TO PROTECT AND TO PROTING TO PR MULCH ALL PLANTING AREAS WITH SHREDDED ORGANIC MULCH TO INNUM DEPTH OF 2. WITH THE EXCEPTION OF BEACH PLANTING. 9 EXCEPTION 2. WITH THE EXCEPTION OF BEACH PLANTING. 9 EXCEPTION 2. WITH THE EXCEPTION OF BEACH PLANTING. 9 EXCEPTION 2. WITH THE EXCEPTION OF BEACH PLANTING.

DIAMETER

FLOHIDA DEPARTMENT OF AGR	IGULIUNE)
TREE/PALM CALIPER	MINIMUM ROOT BALL
" - 1 ½"	16'
1 1/2" - 1 3/4"	20"
1 3/4" - 2"	24"
2" - 2 1/2"	28"
2 1/2" - 3 1/2"	32"
3 1/2" - 4"	36"
4" - 4 1/2"	40"
4 1/2" - 5"	44"
5" - 5 1/2"	48"

I REES AND PALMS TO HEMAIN OF BE RELOCATED PHIOR TO THE OF CONSTRUCTION ACTIVITIES ONSITE AND SHALL REMAIN IN INCREASE OF ONE (1) INCH IN CALIPER OR FRACTION THEREOF.

34RK BROWN) SHREDDED MULCH OR A CITY APPROVED 10 ALL TREES TO BE FLOODED FOR FIVE (5) DAYS PRIOR TO TRANSPLANT 11. ALL PITS TO BE FILLED THE SAME DAY AND WITH CLEAN FILL IN 18 INCH

LIFTS/LAYERS, EACH THEN COMPACTED BEFORE A SUBSEQUENT 18" LIFT/LAYEI IS PLACED. REPEAT UNTIL BACKFILL IS FLUSH WITH SURROUNDING GRADE. 12. CORRECT ALL PROBLEMS RELATED TO SETTLEMENT, EROSION, OR OTHE DISTRESS OF EXCANTEDIBACKFILED PIT FROM WHICH TREEPAUM HAS BEE PROVVED, INCLUDING THE COMPLETE AND THROUGH REMOVAL OF AI RESIDUAL ROOTS, STUMPS AND PORTIONS AND PARTS THEREOF.

1 VERIPY ALL UNDERGROUND CONSTRUCTIONS OR OBSTRUCTIONS (UTILITIES, SEPTIC SYSTEMS, ETC.) ARE IDENTIFIED, LOCATED AND CLEARLY MARKED AS APPROPRIATE PRIOR TO EXCAVATION OF PATILING PITS FOR FELOCATED TREES AND PAILS. ANY UNINGOIN OBJECTS SHALL BE BONGURFIT OTHE ATTENTION OF THE LANDSCAPE ARCHITECT IMMEDIATELY, PRIOR TO INSTALLING AND PARVIELING. BACKFILLING.


REESPALMS SHALL BE PROPERLY HANDLED DURING EXCAVATION. 2 LANDSCAPE CONTRACTOR TO FLAG ALL PROPOSED PLANT LOCATIONS FOR NMS, STORAGE, RELOCATION, AND REPLANTING, DO NOT SCAP OR REMISE DAMAGE TRUNS AND BRANKING SAPACHETICST S.PROVALPRIOR TO INSTLATION. 3. PLANTING PITS SHALL BE A MINIMUM OF TWO (2) TIMES LARGER IN DIAMET

AD ONE AND A HALF (1-12) TIMES LARGER IN DEPTH THAN THE ROOT BALL ROUGHEN SIDES AND BOTTOM OF PIT. TURCHENT. NORTIMICTOR SHALL BE RESPONSIBLE FOR THE MANUAL WATERING A AFTER EACH PARTING PT IS EXCAVATED, PLACE SUFFICIENT PLANTING MIX IN ALL RELOCATED TREESPALING DURING MAINTENANCE PERIOD, UNTIL BOTTOM OF EXCAVATION, AND SEAT FLANT, INSURING TOP OF ROOT BALL IS ALL ACCEPTANCE OF ALL WORK BY THE LANDSCAFE RACHTECT FLUXHWITH IMMEDIATELY ANALCERT FINAL OF PROPOSED GRADE

5. LANDSCAPE CONTRACTOR TO INSURE ALL PLANT MATERIAL IS INSTALLED A THE CORRECT ELEVATION. REFER TO GRADING PLAN. 6 LANDSCAPE CONTRACTOR TO INSURE ALL BOOT FLARES ARE EXPOSED.

7. CENTER EACH RELOCATED TREE/PALM IN ITS PLANTING PIT AND BACKFILL WITH SPECIFIED PLANTING MIX. 8. PLACE PLANTING MIX IN 12 INCH LIFTS/LAYERS AROUND ROOT BALL AND COMPACT UNTIL ALL VOIDS ARE FILLED WITH COMPACTED PLANTING MIX.

9. BUILD SOIL SAUCER OF MOUNDED EXCAVATED SOIL AROUND PERIMETER EACH PLANTING PIT TO FORM WATERING BASIN. MULCH TO A DEPTH OF 3".

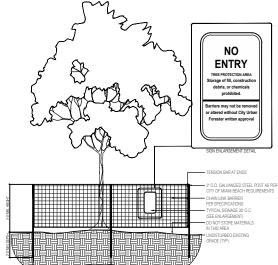


.) TREE BARRICADE APPROVAL: OBTAIN CITY APPROVAL OF TREE BARRICADES BEFORE BEGINNING CLEARING

WIT GRAVANUEU STEEL POSTS AT (9) FOOT SPACING, OF OF 24 FOSTS WITH THREE ELOUALT SPACED 2AH PAILS. POSTS MAY GE SHIFTED TO ANDID FOOTS. 4) THE BARRER SHALL BE FUNCED AT THE DIP LINE OF EACH TREE OR PRESERVATION AREA, AND IN NO CASE LESS THAN TO FROM THE TUNN, OF AWY PORTOCTED THEE FOR AWY DSCRAMICIS RELATED TO PLACEMENT OF THE BARRIER, THE CITY'S URBAN FORESTER SHOLLD BE CONTACTED FOR APPROVAL. 5) HAD WORK ONLY WITHIN TREE BARREDGES, NO CONSTRUCTION ACTIVITES PERMITTED WITHIN TREE PROTECTION FEACEWITHOUT URBAN FORESTER APPROVAL.

THEE MOTION PROVIDENT AND A COMPARENT AND A CONSTRUCTION. THEE PROTECTION FENCE SHALL BE MAINTAINED THROUGHOUT CONSTRUCTION. ) REMOVE TREE PROTECTION FENCE ONLY WITHIN WRITTEN APPROVAL FROM CITY URBAN FORESTER AFTER ALL SITE

. PERATIONS OR ANY SITE DEVELOPMENT. )TREE PROTECTION FENCE SHALL BE INSTALLED PRIOR TO ANY SITE WORK, CLEARING, OR DEMOLITION.

OCOMB TREE PROTECTION DETAIL

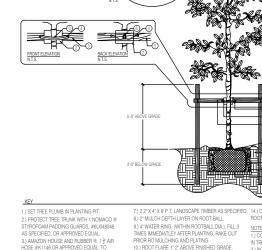

OVER 10 GAUGE WIRE. ) 1 10 GAUGE GALVANIZED WIRE. WIRE

ODUCT @ OR APPROVED FOUA

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-7)


) 2 2" X 4" X 8" P.T. LANDSCAPE TIMBER AS SPECIFIED. 14.) COMPACT SOIL IMMEDIATELY BENEATH THE ROOT BALL TO PREVENT SETTLING. NOTES: 1.) CONTRACTOR TO ASSURE PERCOLATION

IN TREE PITS. 2.) NO MULCH WITHIN 4" OF TRUNK.


10.) ROOT FLARE 1"-2" ABOVE FINISHED GRADE. 10, NOOT PLANE 1-2 ABOVE HINISHED GNADE. 11.) B&B OR CONTAINERIZED ROOTBALL REMOVE ALL BURLAP IF NOT 10% BIODEGRADABLE. REMOVE CONTAINER FROM ROOTBALL PRIOR TO PLANTING


1.2" X 4" X 4" NON TREATED LANDSCAPE 12.) BACKFILL TOP SOIL TYP. OR AREA. BACKFIL SHALL BE AMENDED THROUGHOUT ENTIRE SITE WITH FERTILIZER AND COMPOST AS REQUIRED. CK SCREWS TO 2" X 4" X 8" P.T. LANDSCAPE

6.) 1 # MALLEABLE CLAMP FASTENER FOR WIRE. SUPPLIER: FLORIDA WIRE ® OR APPROVED EQUAL 2 MEDIUM TREE PLANTING & STAKING DETAIL

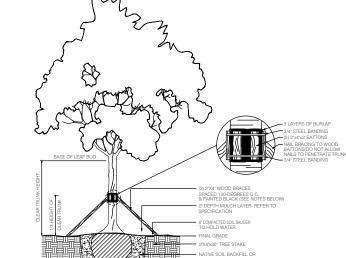



# LARGE TREE PLANTING AND STAKING DETAIL

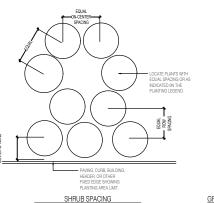


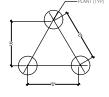


ROW

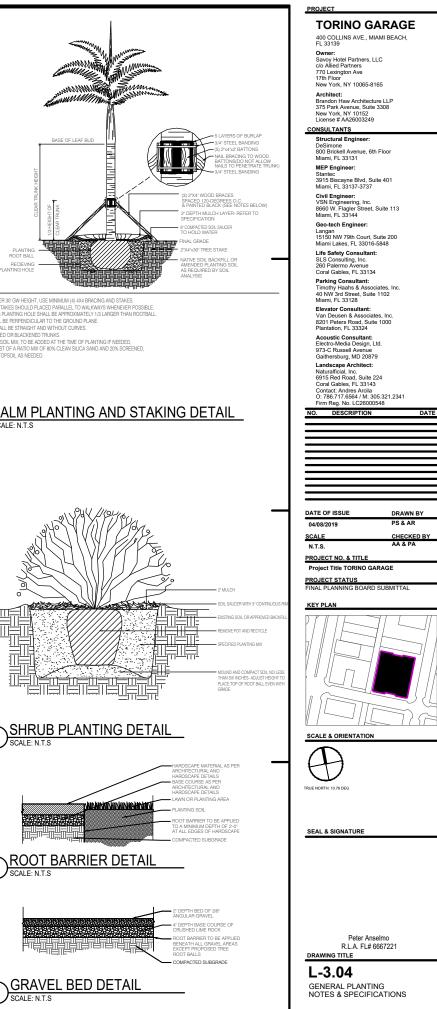

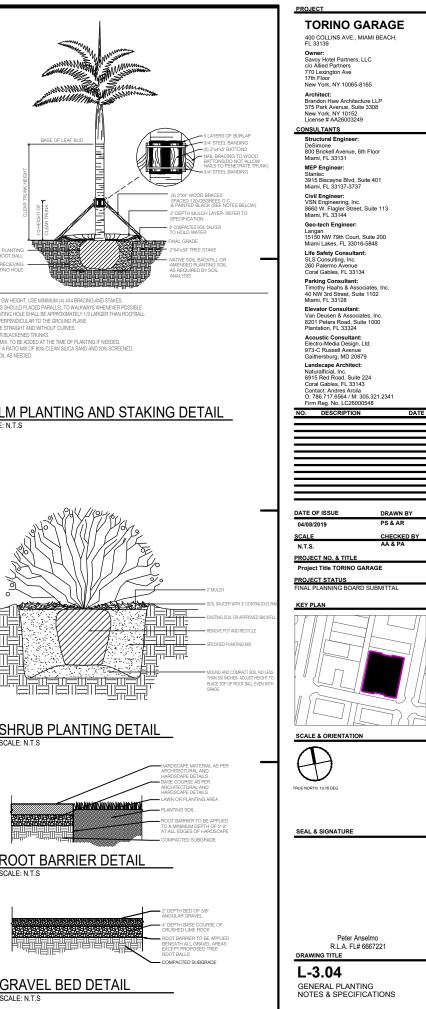

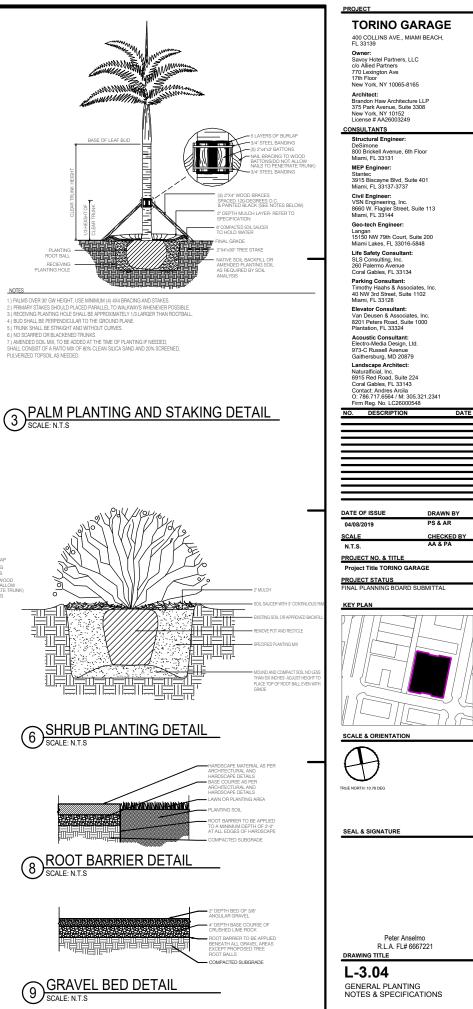


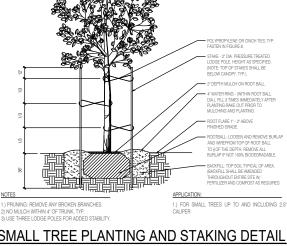



4 SMALL TREE PLANTING AND STAKING DETAIL

NOTES

## 2) NO MULCH WITHIN 4" OF TRUNK, TYP 3) USE THREE LODGE POLES FOR ADDED STABILITY

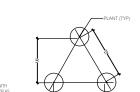

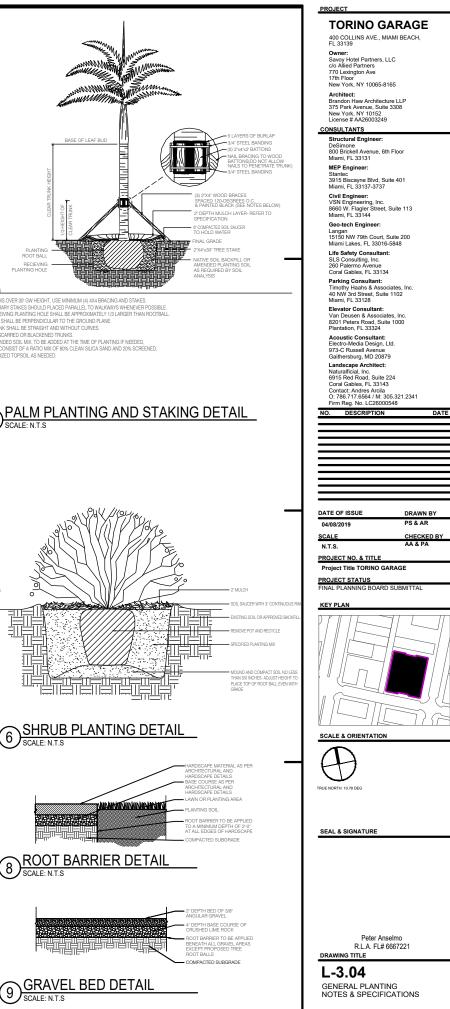


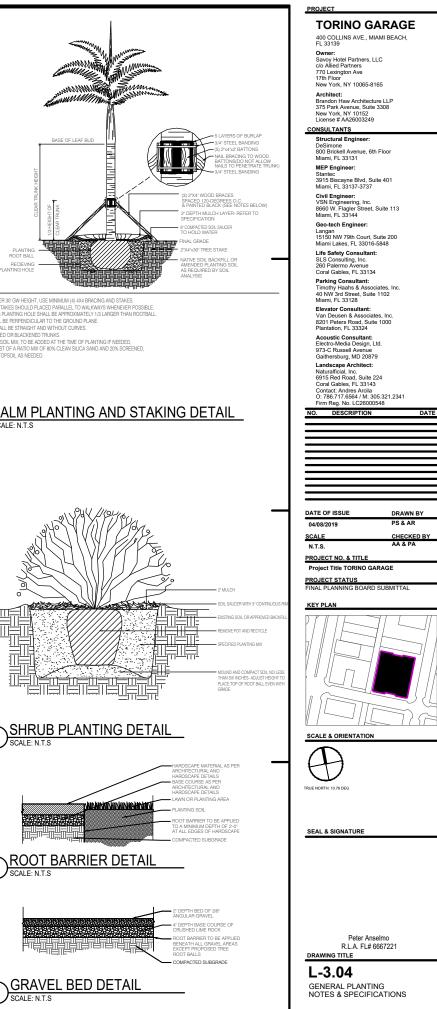







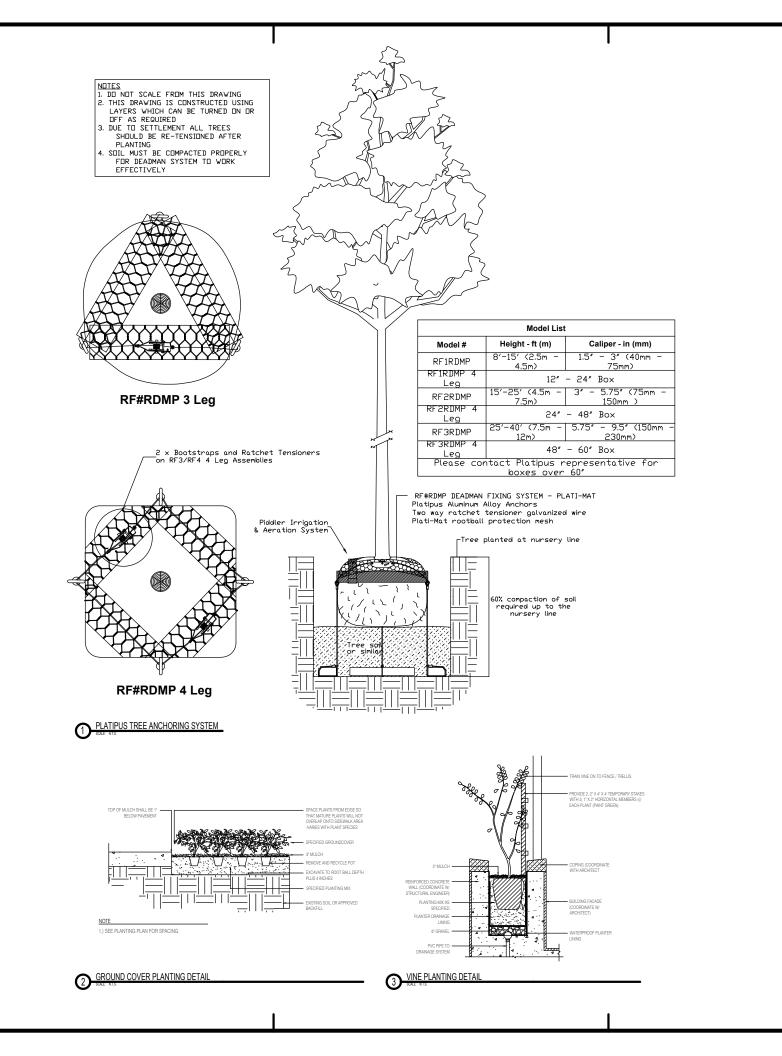


ARCH D 36"x24"

TORINO GARAGE 400 COLLINS AVE., MIAMI BEACH, FL 33139 Owner: Savoy Hotel Partners, LLC c/o Allied Partners 770 Lexington Ave 17th Floor New York, NY 10065-8165 Architect: Brandon Haw Architecture LLP 375 Park Avenue, Suite 3308 New York, NY 10152 License # AA26003249 CONSULTANTS Structural Engineer: DeSimone 800 Brickell Avenue, 6th Floor Miami, FL 33131 MEP Engineer: Stantec 3915 Biscayne Blvd, Suite 401 Miami, FL 33137-3737 VSN Engineering, Inc. 8660 W. Flagler Street, Suite 113 Miami, FL 33144 Geo-tech Engineer: Langan 15150 NW 79th Court, Suite 200 Miami Lakes, FL 33016-5848 Life Safety Consultant: SLS Consulting, Inc. 260 Palermo Avenue Coral Gables, FL 33134 Parking Consultant: Timothy Haahs & Associates, Ir 40 NW 3rd Street, Suite 1102 Miami, FL 33128 ates Inc Elevator Consultant: Van Deusen & Associates, Inc. 8201 Peters Road, Suite 1000 Plantation, FL 33324 Acoustic Consultant: Electro-Media Design, Ltd. 973-C Russell Avenue Gaithersburg, MD 20879 Gaithersburg, MD 20879 Landscape Architect: Naturalficial, Inc. 6915 Red Road, Suite 224 Coral Gables, FL 33143 Contact: Andres Arcila O: 786.717.6564 / M: 305.321.2341 Firm Reg. No. LC26000548 NO. DESCRIPTION DATE OF ISSUE DRAWN BY 04/08/2019 PS & AR CHECKED BY AA & PA SCALE N.T.S. PROJECT NO. & TITLE Project Title TORINO GARAGE PROJECT STATUS FINAL PLANNING BOARD KEY PLAN SCALE & ORIENTATION Ð RUE NORTH: 10.78 DE SEAL & SIGNATURE Peter Anselmo R.L.A. FL# 6667221 DRAWING TITLE L-3.05

GENERAL PLANTING NOTES & SPECIFICATIONS

PROJECT

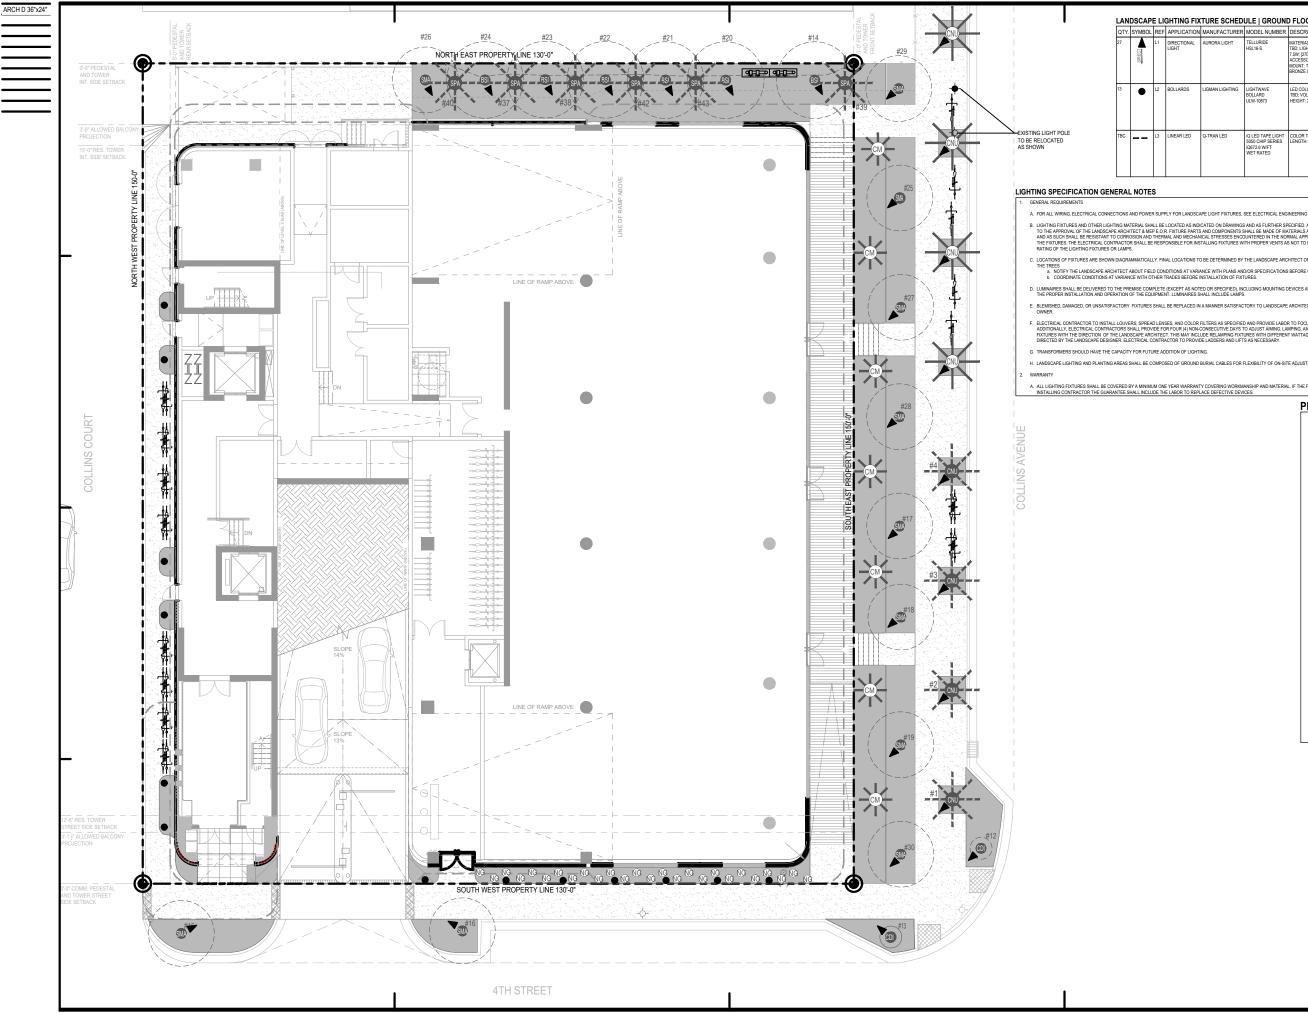

## LANDSCAPE LIGHTING FIXTURE SCHEDULE | GROUND FLOOR

F	APPLICATION	MANUFACTURER	MODEL NUMBER	DESCRIPTION	NOTES
	DIRECTIONAL LIGHT	AURORA LIGHT	TELLURIDE HSL16-S		U.L LISTED FOR WET LOCATION
	BOLLARDS	LIGMAN LIGHTING	LIGHTWAVE BOLLARD ULW-10873	LED COLOR: W40; COLOR: TBD; VOLTAGE: TBD; HEIGHT: 22.2"	U.L LISTED FOR WET LOCATION
	LINEAR LED	Q-TRAN LED	IQ LED TAPE LIGHT 5050 CHIP SERIES IQ672.6 W/FT WET RATED	COLOR TEMP: TBD; LENGTH: TBD.	U.L LISTED FOR WET LOCATION

A FOR ALL WIRING ELECTRICAL CONNECTIONS AND POWER SUPPLY FOR LANDSCAPE LIGHT FIXTURES. SEE ELECTRICAL ENGINEERING DRAWINGS

B. LIGHTING FIXTURES AND OTHER LIGHTING MATERIAL SHALL BE LOCATED AS INDICATED ON DRAWINGS AND AS FURTHER SPECIFIED. ALL MATERIAL SHALL BE SUBJECT TO THE APPROVAL OF THE LANDSCAPE ARCHITECT & MEPE O.R. FIXTURE PARTS AND COMPONENTS SHALL BE MUBE OF MATERIAL SHAPPLOPHATE TO THERE I RUNTON AND AS SUCH SHALL BE RESISTANT O CORRISION AND THERMIL AND VEHANICAL STRESS EXCOUNTEED IN THE NORMAL APPLATION AND FUNCTIONNO OF THE FIXTURES. THE ELECTRICAL CONTRACTOR SHALL BE RESPONSIBLE FOR INSTALLING FIXTURES WITH PROPER VENTS AS NOT TO EXCEED THE TEMPERATURE RATING OT THE LIGHTING FIXTURES OF LAWFR.

ENCING INSTALLATION

F. ELECTRICAL CONTRACTOR TO INSTALL LOWERS, SPREAD LENSES, AND COLOR FILTERS AS SPECIFIED AND PROVIDE LABOR TO FOCUS ALL ADJISTABLE FIXTURES, ADDITIONALLY, ELECTRICAL CONTRACTORS SHALL PROVIDE FOR FOUN (A) NON-CONSECUTIVE DAYS TO ADJIST ANING, LANENG, AND COLORING OF LIGHTING FIXTURES WITH THE DIRECTION OF THE LANDSCAPE ARCHTECT. THIS MAY INCLUDE RELAMING FIXTURES WITH DIFFERENT WATAGES OR BEAM SPREADS AS DIRECTED BY THE LANDSCAPE DESIGNER. ELECTRICAL CONTRACTOR TO PROVIDE LADDER'S AND LIFTS AS INCESSARY.

H. LANDSCAPE LIGHTING AND PLANTING AREAS SHALL BE COMPOSED OF GROUND BURIAL CABLES FOR FLEXIBILITY OF ON-SITE ADJUSTMENT OF FIXTURE LOCATION

MANSHIP AND MATERIAL. IF THE FIXTURES ARE SUPPLIED BY THE



## PROJECT

## TORINO GARAGE

400 COLLINS AVE., MIAMI BEACH, FL 33139 Owner: Savoy Hotel Partners, LLC c/o Allied Partners 770 Lexington Ave 17th Floor New York, NY 10065-8165

Architect: Brandon Haw Architecture LLP 375 Park Avenue, Suite 3308 New York, NY 10152 License # AA26003249

CONSULTANTS

Structural Engineer: DeSimone 800 Brickell Avenue, 6th Floor Miami, FL 33131 MEP Engineer: Stantec 3915 Biscayne Blvd, Suite 401 Miami, FL 33137-3737

VSN Engineering, Inc. 8660 W. Flagler Street, Suite 113 Miami, FL 33144

Geo-tech Engineer: Langan 15150 NW 79th Court, Suite 200 Miami Lakes, FL 33016-5848

Life Safety Consultant: SLS Consulting, Inc. 260 Palermo Avenue Coral Gables, FL 33134

Parking Consultant: Timothy Haahs & Associates, Ir 40 NW 3rd Street, Suite 1102 Miami, FL 33128

Elevator Consultant: Van Deusen & Associates, Inc. 8201 Peters Road, Suite 1000 Plantation, FL 33324

Acoustic Consultant: Electro-Media Design, Ltd. 973-C Russell Avenue Gaithersburg, MD 20879

Gaithersburg, MD 20879 Landscape Architect: Naturalficial, Inc. 6915 Red Road, Suite 224 Coral Gables, FL 33143 Contact: Andres Arcila O: 786.717.6564 / M: 305.321.2341 Firm Reg. No. LC26000548

## NO. DESCRIPTION

DATE OF ISSUE DRAWN BY PS & AR



CHECKED BY AA & PA

PROJECT NO. & TITLE Project Title TORINO GARAGE

PROJECT STATUS INAL PLANNING BOARD SUBMI

## KEY PLAN




SCALE & ORIENTATION




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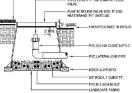
Peter Anselmo R.L.A. FL# 6667221 DRAWING TITLE


L-4.01 GROUND LVL LANDSCAPE LIGHTING PLAN

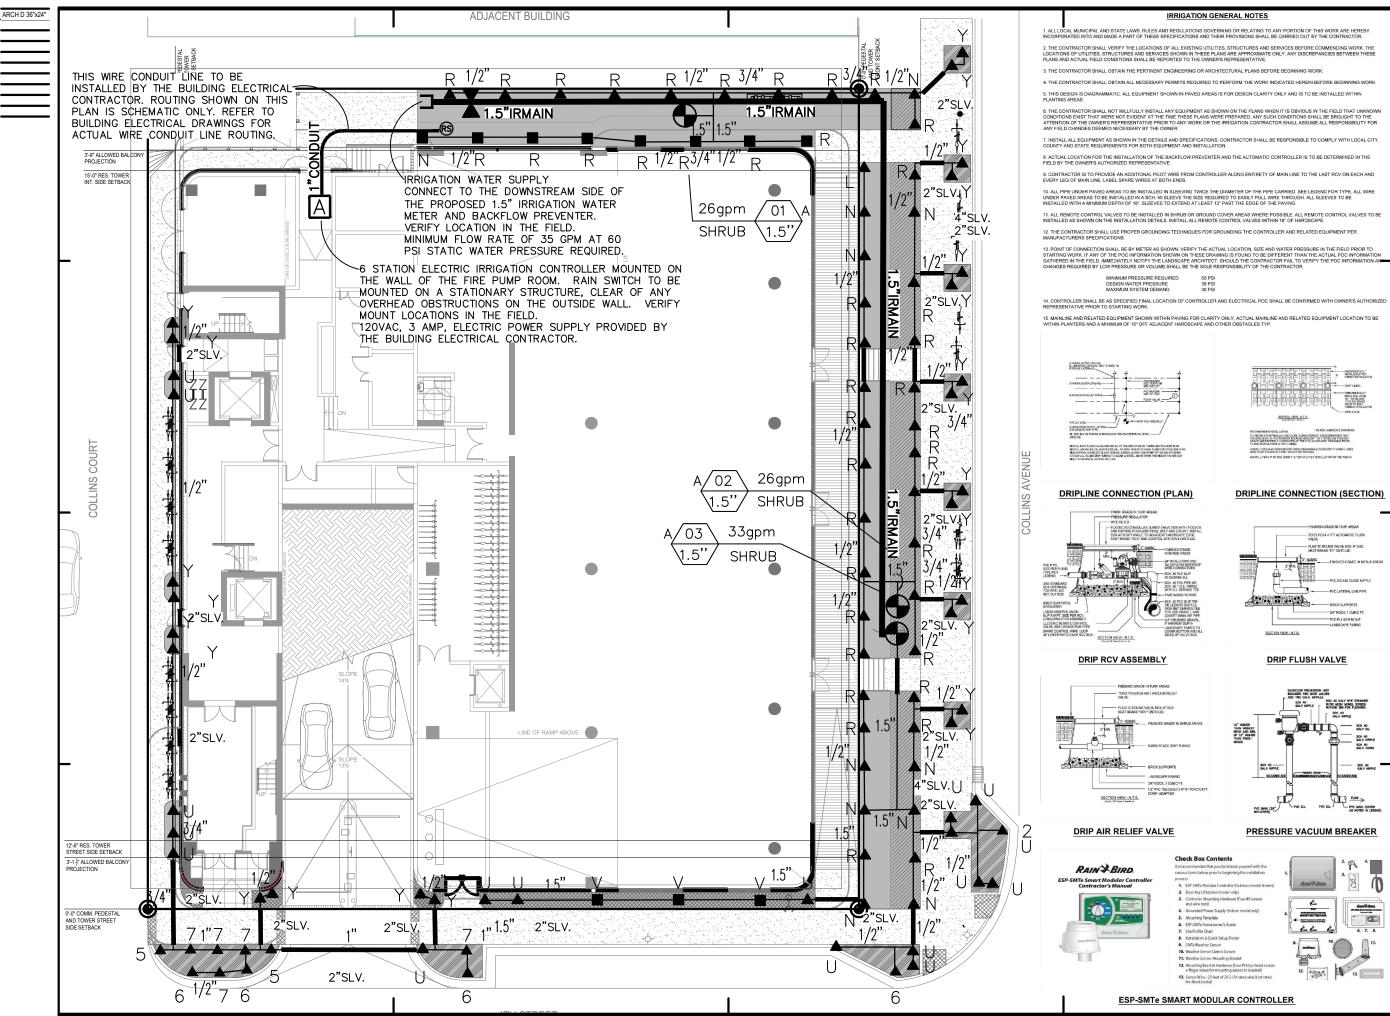

50 PSI
39 PSI
30 PSI



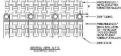

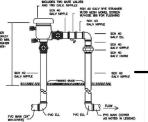

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Project Title TORINO GARAGE PROJECT STATUS

### KEY PLAN

SCALE



SCALE & ORIENTATION



SEAL & SIGNATURE

Peter Anselmo R.L.A. FL# 6667221 DRAWING TITLE

IR-1.01 GROUND LVL IRRIGATION PI AN