
1212 LINCOLN

1212 LINCOLN ROAD MIAMI BEACH, FLORIDA DESIGN REVIEW BOARD SIGNAGE AND GRAPHICS FINAL SUBMITTAL - APRIL 8, 2019

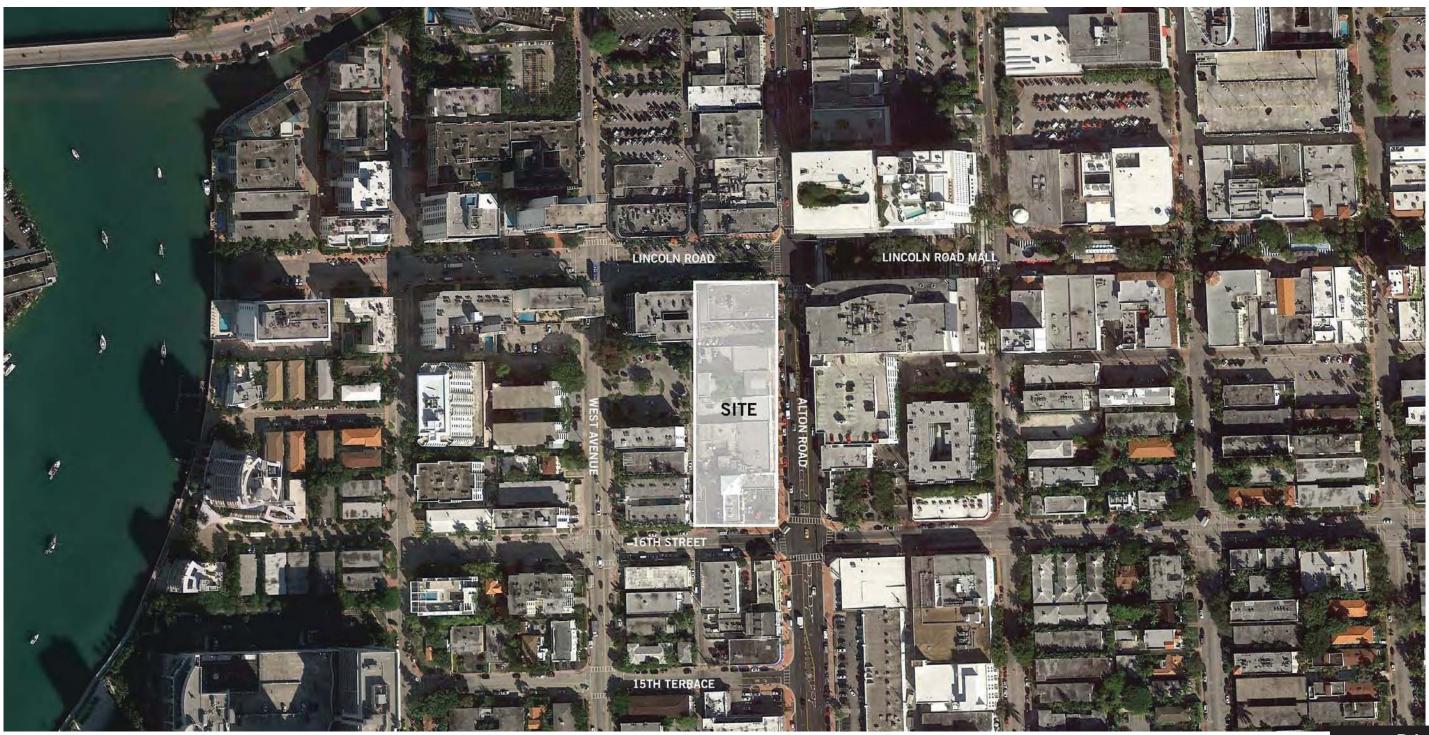

CURRENT ZONING VARIANCE REQUESTS - SIGNAGE

138-13 GENERAL SIGN REQUIREM	ENTS AND DESIGN STANDARDS	
REGULATION	REQUIREMENT	PROPOSED
(.6) QTY OF SIGNS PER FRONTAGE	1 WALL, PROJECTING, OR DETACHED SIGN PER ALLOWED FRONTAGE	VARIANCE REQUESTED TO ALLOW 2 PROJECTING SIGNS PER TENANT ON FLOORS 1 AND 2
138-16 WALL SIGN		
REGULATION	REQUIREMENT	PROPOSED
MAX AREA PERCENTAGE	SEE SUPPLEMENTAL STANDARD (1% OF 24,467 SF WALL AREA= 245 SF)	245 SF
MAX AREA	MIN = 15 SF; MAX = 100 SF	
HEIGHT RESTRICTIONS	SHALL NOT BE LOCATED ABOVE GROUND FLOOR	SEE SUPPLEMENTAL STANDARD
SUPPLEMENTAL STANDARD	ONE BUILDING ID SIGN ABOVE THE ROOFLINE NOT TO EXCEED 1% OF WALL AREA	VARIANCE REQUESTED TO BE PLACE ON ROOF OF RETAIL FLOORS (AT LOWEST LEVEL OF GARAGE)
138-16 PROJECTING SIGN		
REGULATION	REQUIREMENT	PROPOSED
MAX AREA	15 SF	191 SF PARKING SIGN; VARIANCES REQUESTED (#60-63); SEE APPENDIX B; REVOCABLE PERMIT TO BE SOUGHT
		141 SF PARKING SIGN; VARIANCES REQUESTED (#64-66); SEE APPENDIX B
		VARIANCE REQUESTED TO ALLOW TENANTS' PROJECTING SIGNS TO BE 25 SF EACH ON GROUND FLOOR
		VARIANCE REQUESTED TO ALLOW TENANTS' PROJECTING SIGNS TO BE 20 SF EACH ON SECOND FLOOR
		VARIANCE REQUESTED TO ALLOW AGGREGATE TO EXCEED ALLOWABLE FOR FIRST FLOOR TENANTS
		VARIANCE REQUESTED TO ALLOW PROJECTING SIGNS ABOVE THE FIRST FLOOR WITHOUT DIRECT ACCESS FROM THE STREET.

<u>NOTE</u>

REVOCABLE PERMIT WILL BE SOUGHT FOR EACH OF THREE SIGNS:

- 1. PARKING SIGN AT SE CORNER ON ALTON ROAD
- 2. PARKING SIGN AT SW CORNER ON 16TH STREET
- 3. WELLS FARGO TENANT SIGN

SHEET NUMBER	SHEET NAME	
PAGE 2	SURVEY	
PAGE 3	LOCATION PLAN	
PAGE 4	ZONING DATA AND DRAWING LIST	
PAGE 5	BUILDING PLANS - FIRST LEVEL	
PAGE 6	BUILDING PLANS - SECOND LEVEL	
PAGE 6a	LANDSCAPE PLANS	
PAGE 7	ZONING AND VARIANCES SUMMARY	
PAGE 8	SIGNAGE LOCATIONS AND VARIANCES - PLANS	
PAGE 9	SIGNAGE LOCATIONS AND VARIANCES - ELEVS	
PAGE 9a	ELEVATIONS: LANDSCAPE AND SIGNAGE	
PAGE 10	EXISTING BUILDING KEY PLAN	
PAGE 11	EXISTING BUILDING SITE PHOTOS	
PAGE 12	EXISTING BUILDING SITE PHOTOS	
PAGE 13	EXISTING BUILDING SITE PHOTOS	
PAGE 14	EXISTING BUILDING SITE PHOTOS	
PAGE 15	APPENDIX B - PKG SIGNS AND SCREEN BY LEONG	
	LEONG	
PAGE 32	APPENDIX C - TENANT AND DIRECTIONAL SIGNAGE	
PAGE 37	APPENDIX D - DIGITAL SCREEN	
PAGE 39	APPENDIX E - BUILDING ID SIGN	
	PAGE 2 PAGE 3 PAGE 4 PAGE 5 PAGE 6 PAGE 6a PAGE 7 PAGE 8 PAGE 9 PAGE 9 PAGE 10 PAGE 11 PAGE 12 PAGE 13 PAGE 13 PAGE 14 PAGE 15 PAGE 32 PAGE 37	

(NOTE: APPENDIX A IS NOT USED)

PERKINS + WILL

806 DOUGLAS ROAD SUITE 300 CORAL GABLES, FLORIDA 33134

1212 LINCOLN ROAD



2200 BISCAYNE BLVD. MIAMI , FLORIDA 33137

LANDSCAPE ARCHITECT

URBAN ROBOT

LLC 420 LINCOLN ROAD SUITE 600 MIAMI BEACH, FLORIDA URBANROBOT.NET

MEP

LA 6666853

BR+A

2600 S. DOUGLAS ROAD SUITE 1100 CORAL GABLES, FLORIDA

STRUCTURAL

YHCE ENGINEERING

12151 SW 128TH CT SUITE 104 MIAMI, FLORIDA

DESIGN REVIEW BOARD GRAPHICS AND SIGNAGE 02-18-2019

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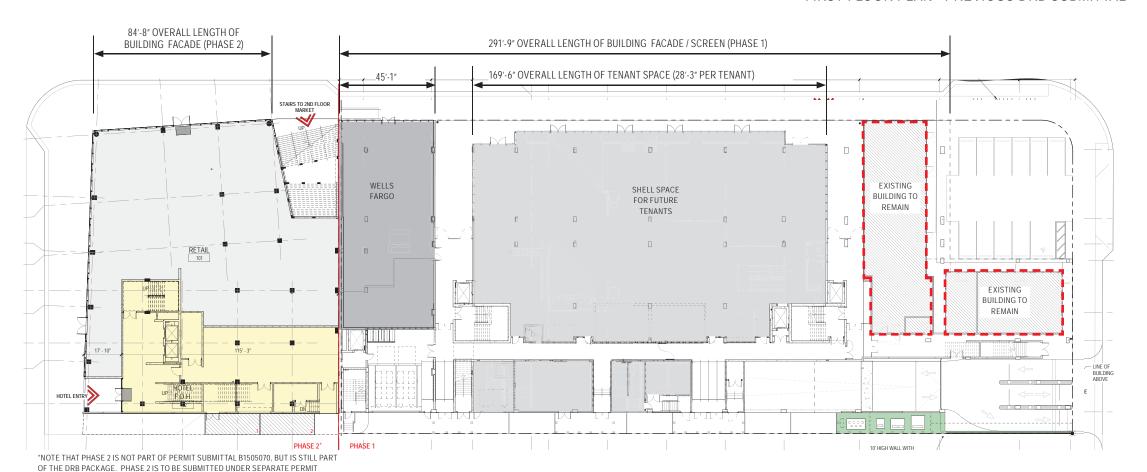
ZONING DATA AND DRAWING LIST

SHEET NUMBER



ALTON ROAD MINISTRUMENTS MINISTRUM

FIRST FLOOR PLAN - PREVIOUS DRB SUBMITTAL



FIRST FLOOR PLAN- PER PERMIT SUBMITTAL B1505070

PERKINS + WILL

806 DOUGLAS ROAD SUITE 300 CORAL GABLES, FLORIDA 33134

1212 LINCOLN ROAD



2200 BISCAYNE BLVD. MIAMI , FLORIDA 33137

LANDSCAPE ARCHITECT

URBAN ROBOT LLC

420 LINCOLN ROAD SUITE 600 MIAMI BEACH, FLORIDA URBANROBOT.NET LA 6666853

MEP

BR+A

2600 S. DOUGLAS ROAD SUITE 1100 CORAL GABLES, FLORIDA

STRUCTURAL

YHCE ENGINEERING

12151 SW 128TH CT SUITE 104 MIAMI, FLORIDA

DESIGN REVIEW BOARD GRAPHICS AND SIGNAGE 03-11-2019

MARK ISSUE	DATE
Job Number	810414.000
Drawn	Author
Checked	Checker
Approved	Approve
	TITLE

BUILDING PLANS

SHEET NUMBER




ALTON ROAD ALTON

PHASE 2 PHASE 1

SECOND FLOOR PLAN - PREVIOUS DRB SUBMITTAL

SECOND FLOOR PLAN- PER PERMIT SUBMITTAL B1505070

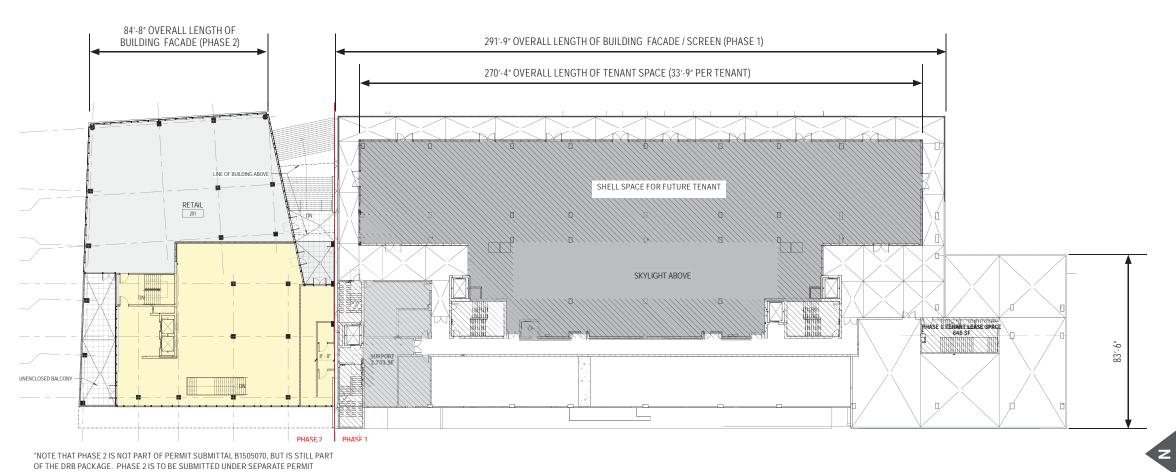

PERKINS + WILL

806 DOUGLAS ROAD SUITE 300 CORAL GABLES, FLORIDA 33134

1212 LINCOLN ROAD



2200 BISCAYNE BLVD. MIAMI , FLORIDA 33137

LANDSCAPE ARCHITECT

URBAN ROBOT LLC

420 LINCOLN ROAD SUITE 600 MIAMI BEACH, FLORIDA URBANROBOT.NET LA 6666853

MEP

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2600 S. DOUGLAS ROAD SUITE 1100 CORAL GABLES, FLORIDA

STRUCTURAL

YHCE ENGINEERING

12151 SW 128TH CT SUITE 104 MIAMI, FLORIDA


DESIGN REVIEW BOARD GRAPHICS AND SIGNAGE 03-11-2019

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BUILDING PLANS


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LANDSCAPE PLAN - PREVIOUS DRB SUBMITTAL

ALTON ROAD

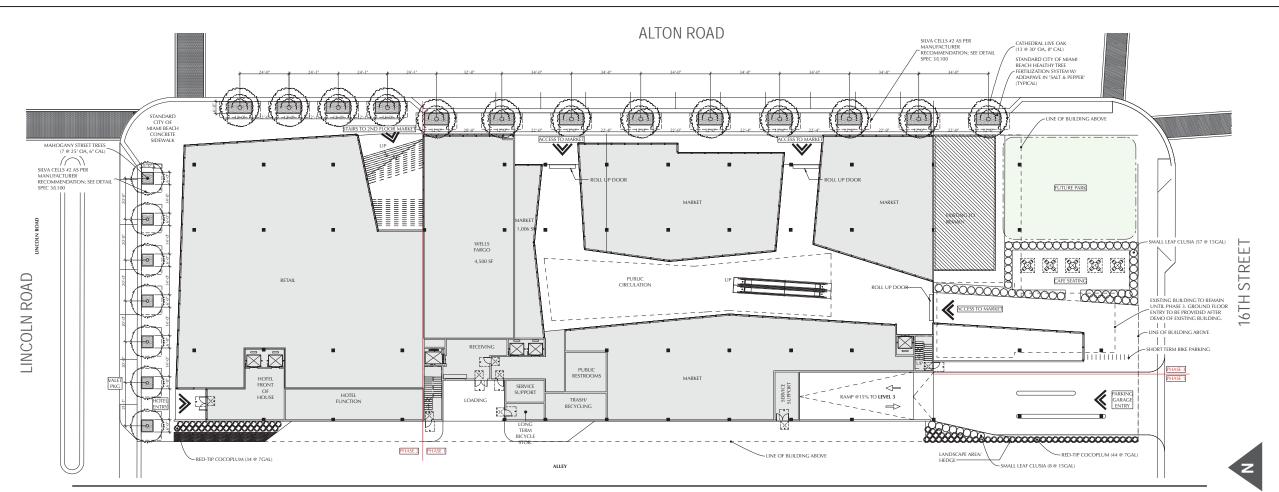

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FUTURE PHASE 2		ALLEY		The state of the s

SITE PLANTING PLAN- PER PERMIT SUBMITTAL B1505070

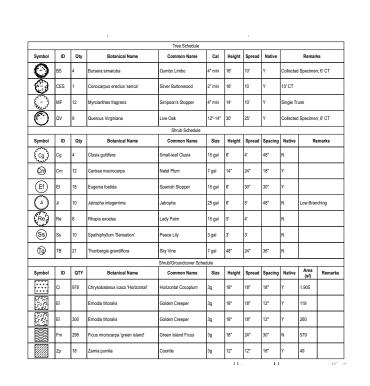PERKINS +WILL

806 DOUGLAS ROAD SUITE 300 CORAL GABLES, FLORIDA 33134

1212 LINCOLN ROAD



2200 BISCAYNE BLVD. MIAMI , FLORIDA 33137

LANDSCAPE ARCHITECT

URBAN ROBOT LLC

420 LINCOLN ROAD SUITE 600 MIAMI BEACH, FLORIDA URBANROBOT.NET LA 6666853

BR+A

MEP

2600 S. DOUGLAS ROAD SUITE 1100 CORAL GABLES, FLORIDA

STRUCTURAL

YHCE ENGINEERING

12151 SW 128TH CT SUITE 104 MIAMI, FLORIDA

DESIGN REVIEW BOARD GRAPHICS AND SIGNAGE 03-11-2019


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Job Number	810414.000
MARK	ISSUE DATE

16TH STREET

LANDSCAPE PLANS

SHEET NUMBER



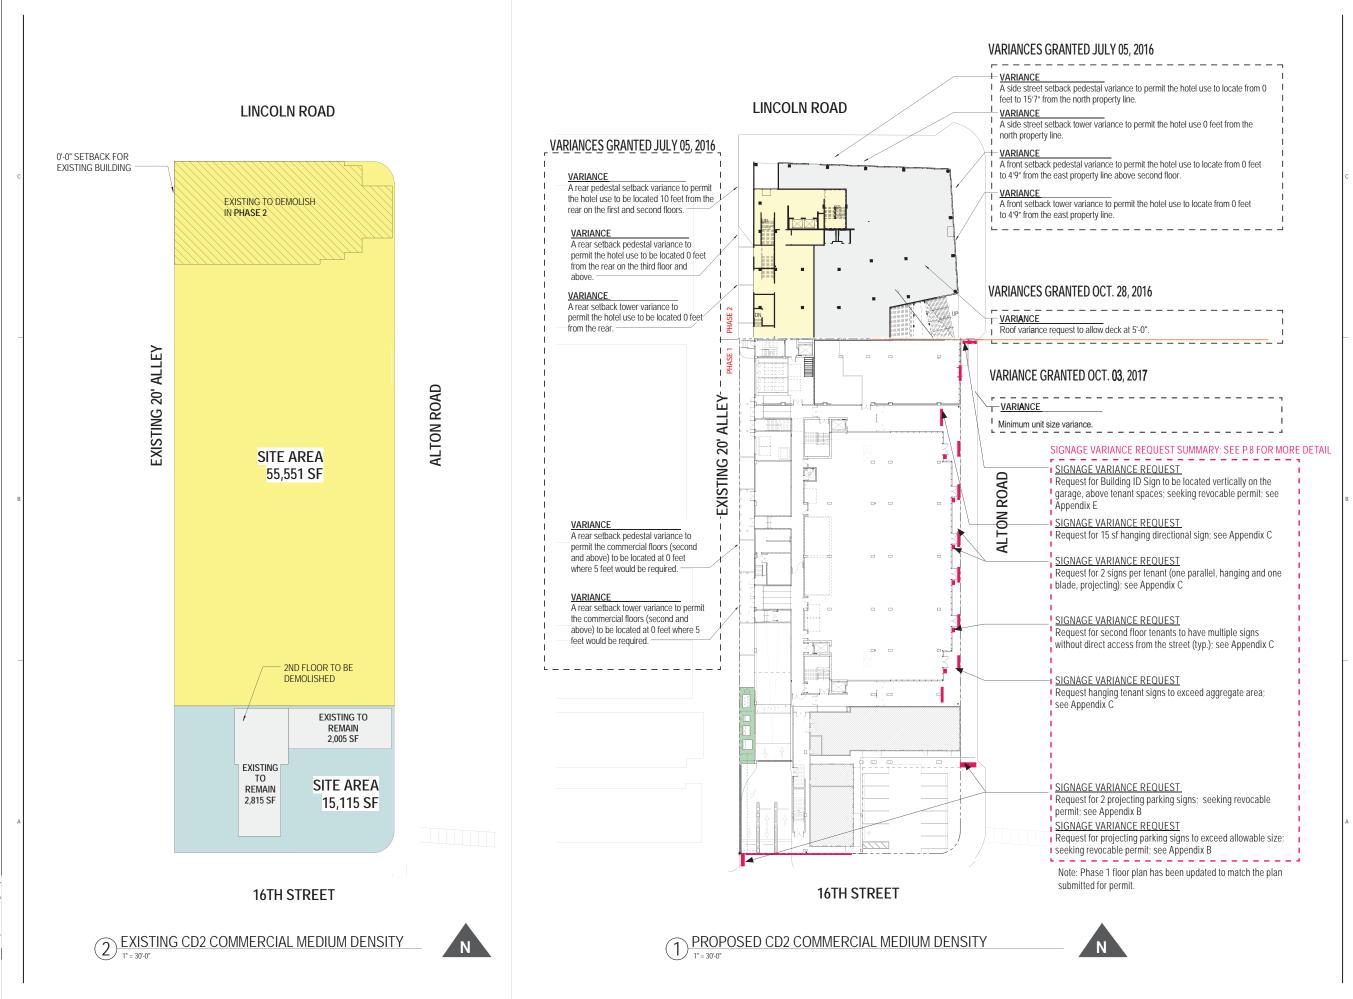

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806 DOUGLAS ROAD SUITE 300 CORAL GABLES, FLORIDA 33134

> 1212 LINCOLN ROAD



2200 BISCAYNE BLVD. MIAMI, FLORIDA 33137

LANDSCAPE ARCHITECT

URBAN ROBOT LLC

420 LINCOLN ROAD SUITE 600 MIAMI BEACH, FLORIDA URBANROBOT.NET LA 6666853

MEP

BR+A 2600 S. DOUGLAS ROAD SUITE 1100 CORAL GABLES, FLORIDA

STRUCTURAL

YHCE ENGINEERING

12151 SW 128TH CT SUITE 104 MIAMI, FLORIDA


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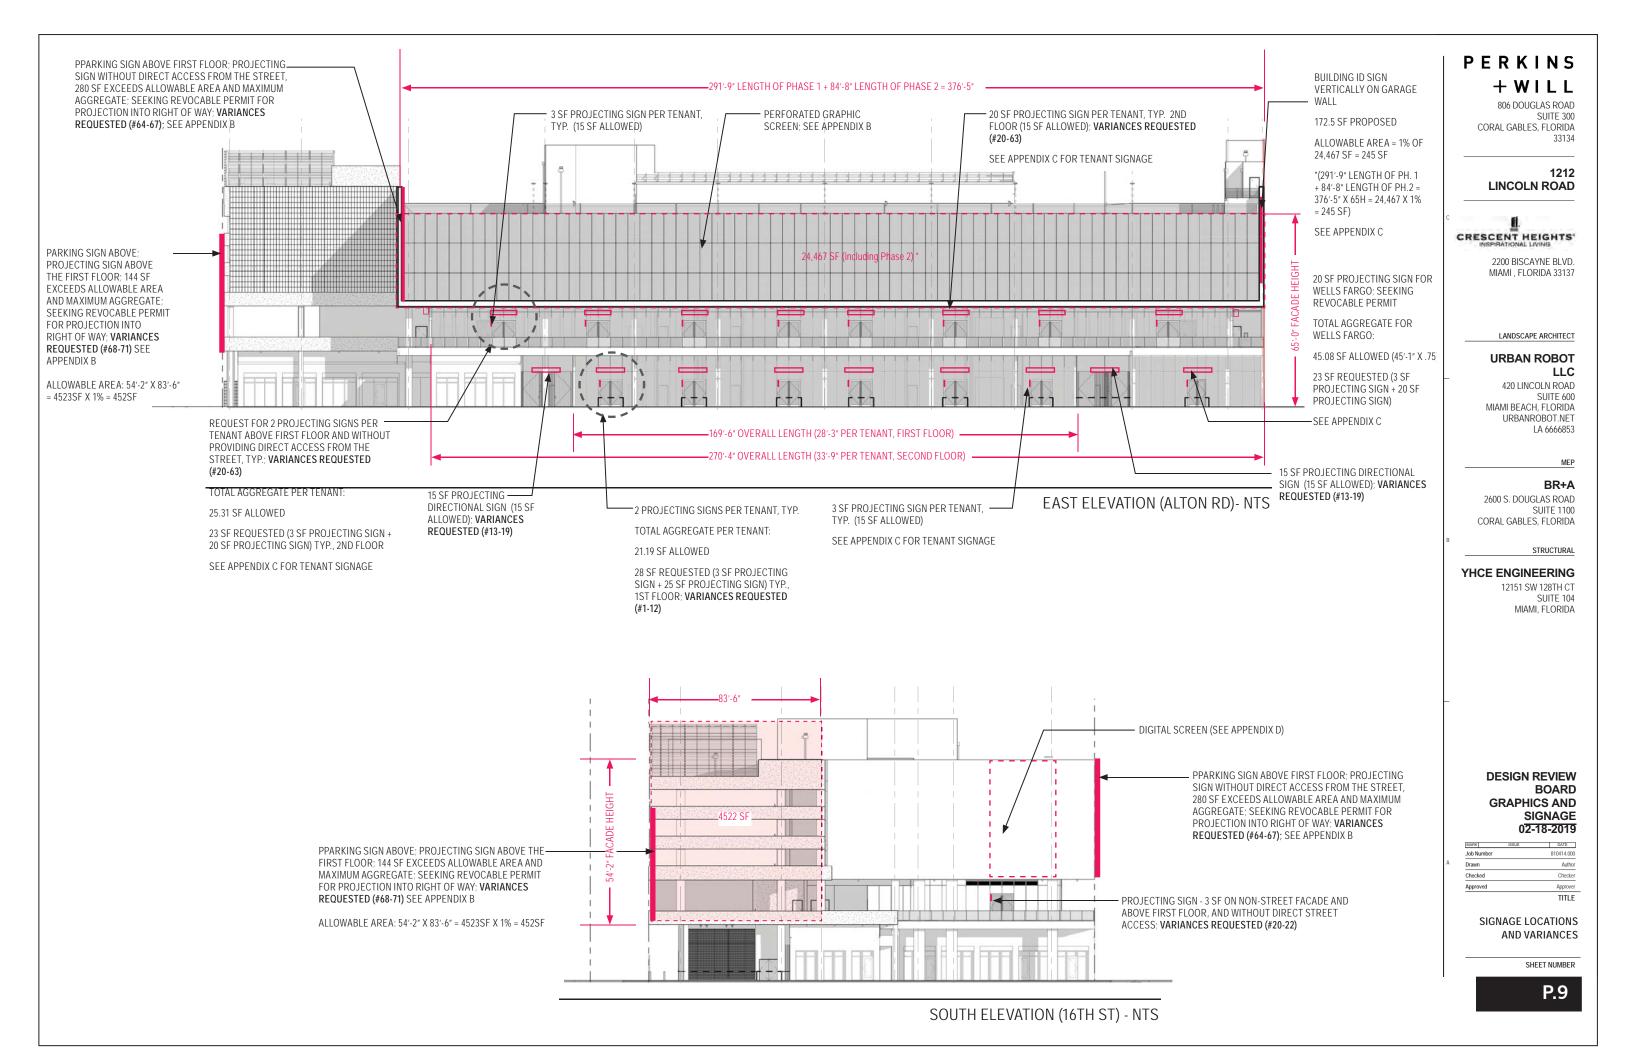
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Job Number	810414.000
MARK ISSUE	DATE


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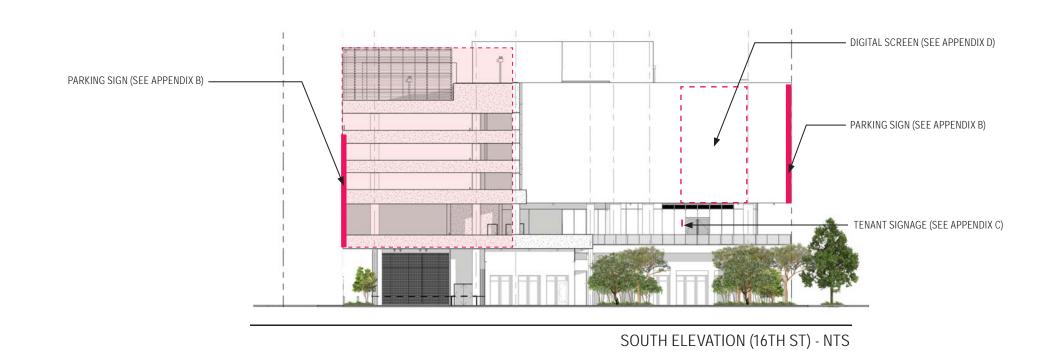






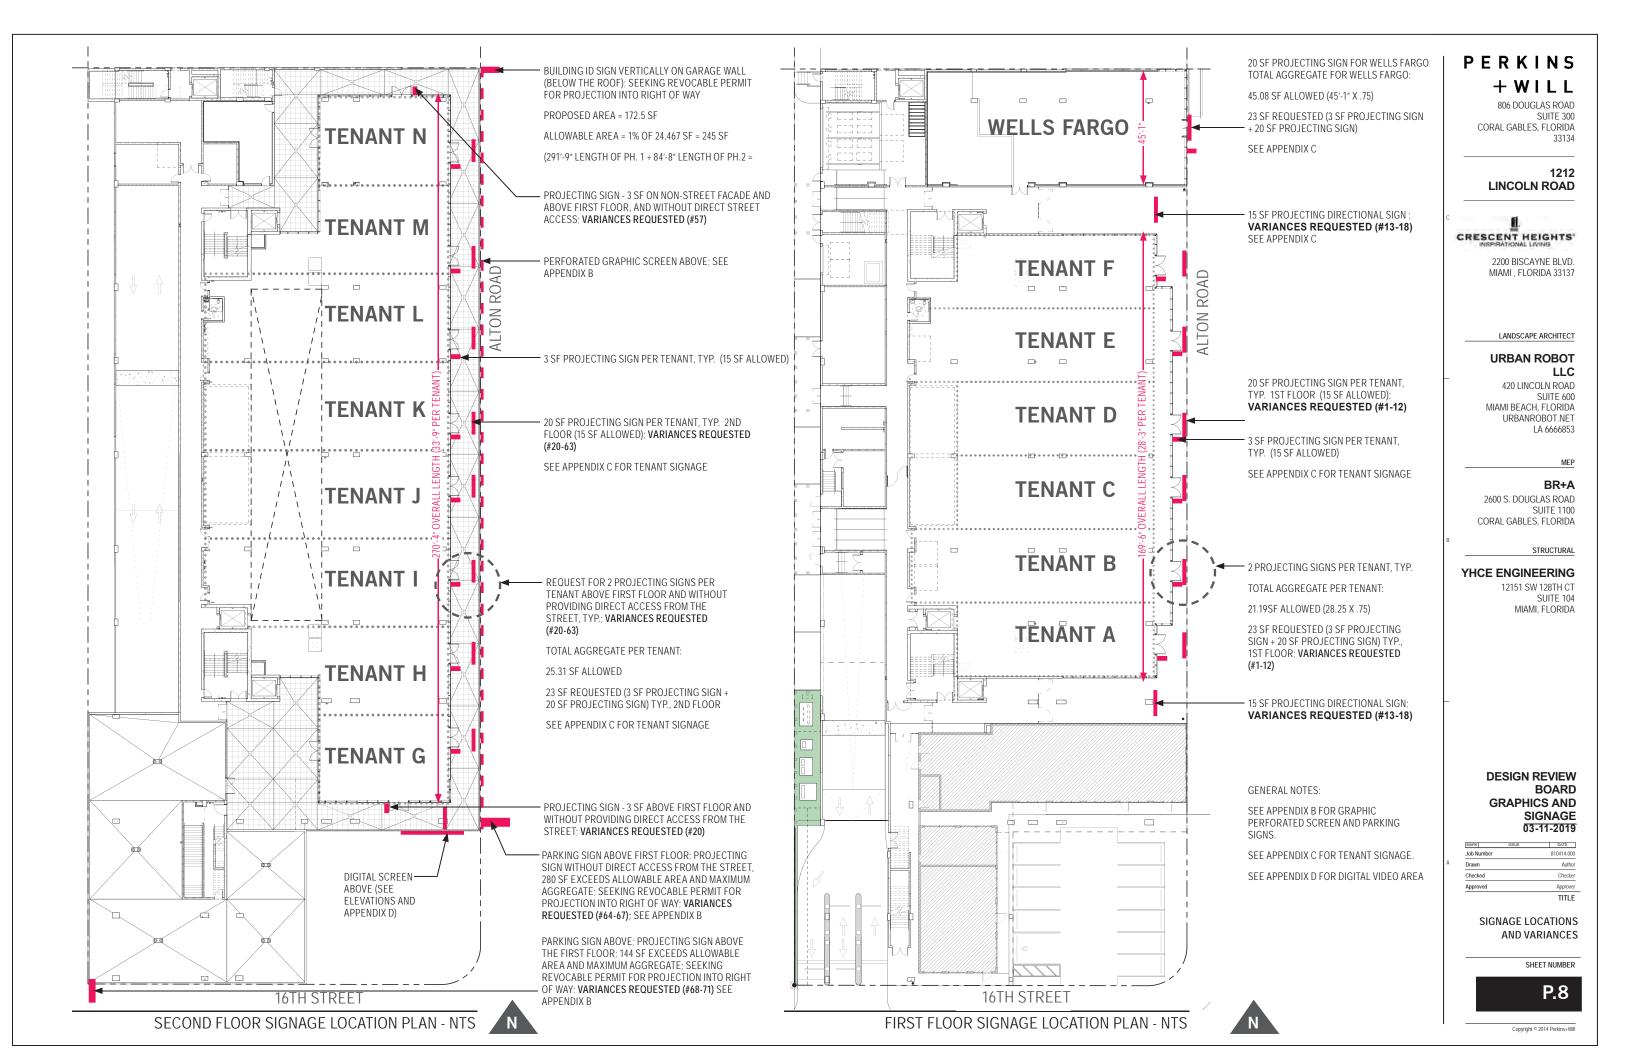

EAST ELEVATION (ALTON RD)- NTS

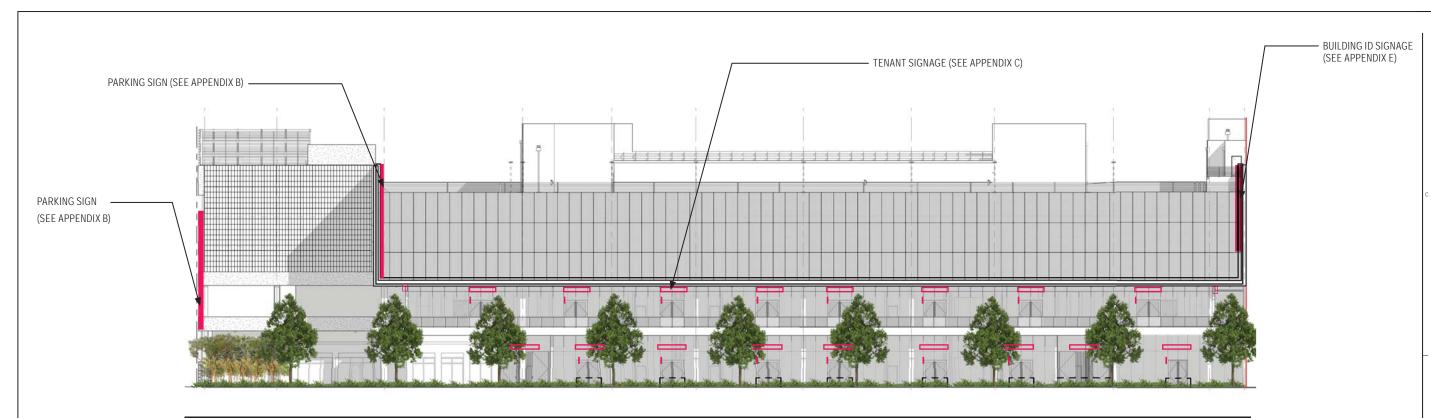

PERKINS + WILL

806 DOUGLAS ROAD SUITE 300 CORAL GABLES, FLORIDA 33134

1212 LINCOLN ROAD



2200 BISCAYNE BLVD. MIAMI , FLORIDA 33137

LANDSCAPE ARCHITECT

URBAN ROBOT

420 LINCOLN ROAD SUITE 600 MIAMI BEACH, FLORIDA URBANROBOT.NET LA 6666853

MEP

BR+ADOUGLAS ROAD

2600 S. DOUGLAS ROAD SUITE 1100 CORAL GABLES, FLORIDA

STRUCTURAL

YHCE ENGINEERING

12151 SW 128TH CT SUITE 104 MIAMI, FLORIDA

DESIGN REVIEW BOARD GRAPHICS AND SIGNAGE 02-18-2019

MARK	ISSUE	DATE
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Checked		Checke
Approved		Approve

ELEVATIONS WITH LANDSCAPE


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P.9a



APPENDIX B: PARKING SIGNAGE AND PARKING SCREEN



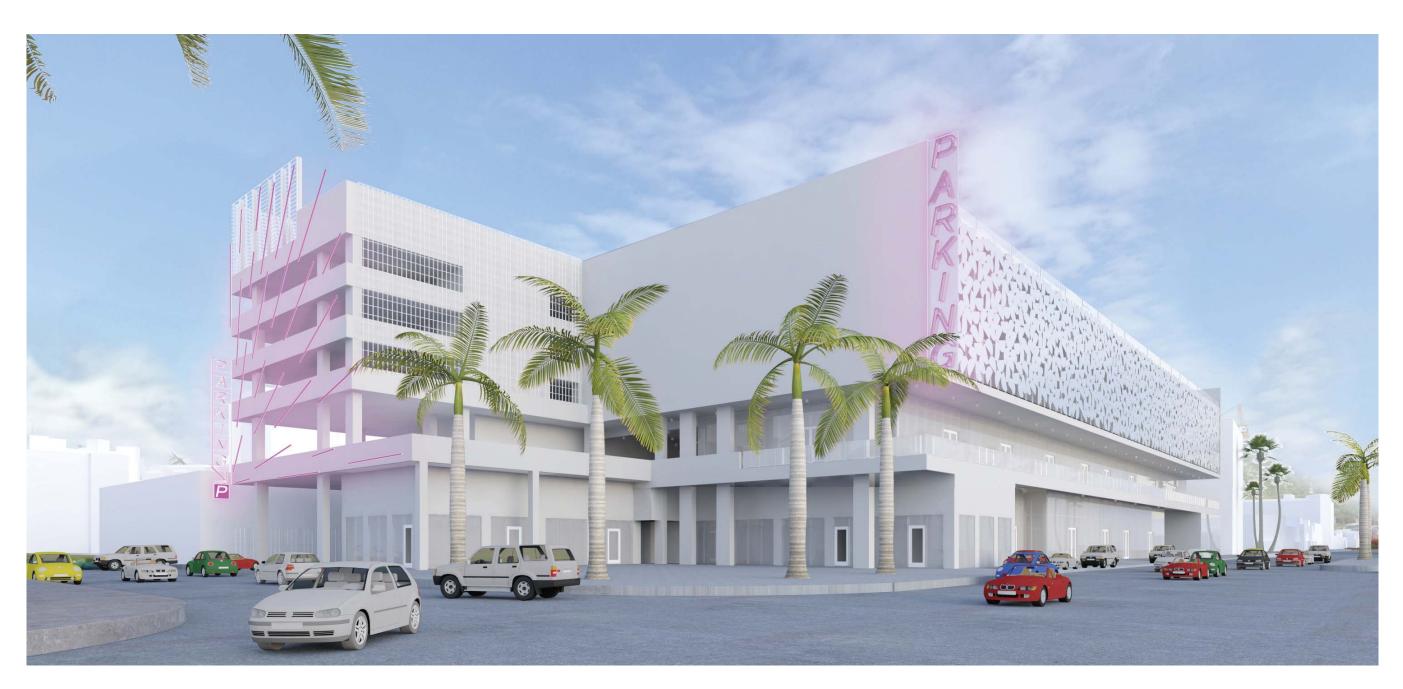

1212 LINCOLN ROAD, 190403 DESIGN DEVELOPMENT PART II SUBMISSION REVISION I

SHEET NUMBER	SHEET NAME	75% DD PART I DD PART I DD PART II DD PART II DD PART II Issue5 Title Issue7 Title Issue7 Title Issue7 Title Issue7 Title Issue7 Title Issue7 Title
A-100	LEVEL 3	0000
A-101	LEVEL 4	ŎŎŎŎ
A-102	LEVEL 5	0000
A-104	ROOF LEVEL	0000
A-200	EXTERIOR ELEVATIONS	0000
A-301	ENLARG PLAN & ELEV (01/03)	0000
A-302	ENLARG PLAN & ELEV (02/03)	0000
A-303	ENLARG PLAN & ELEV (03/03)	0000
A-304	FACADE DETAILS	0000
A-305	FACADE DETAILS	00
A-307	ENLARGE ELEVATIONS - SIGNAGE	00
A-308	ENLARGE ELEVATION - SOUTH FACADE LIGHTING	00
A-309	ENLARGE ELEVATION - ALTON RD. SIGN	00
A-310	ENLARGE ELEVATION - 16TH ST. SIGN	00
A-311	DETAIL - SCREEN ALPHA	00

LEONG LEONG

NEW YORK, NY 10002 CHRIS LEONG TEL (212) 920-7221 OWNER / CLIENT

MIAMI, FL 33137

PERKINS + WILL 806 DOUGLAS ROAD, SUITE 300 CORAL GABLES, FL 33134

YHCE ENGINEERING 12151 SW 128TH CT, SUITE 104

1212 LINCOLN ROAD
1600 - 1634 ALTON RD. MAMI BEACH, FL 33138

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PROJECTS, FOR ADDITIONS TO THIS
PROJECT OR COMPLETION OF THIS
PROJECT BY OTHERS

| Date | Issue / Revision | O117/179 | T9% D0 SET | O122719 | DD PART I | O308/19 | DD PART I | REV I | O433719 | DD PART I | REV I |

DOB NO.

PROJECT NO. 18

DATE 02/


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DESIGN ARCHITECT LEONG LEONG LEONG LEONG
167 BOWERY 3F
NEW YORK, NY 10002
CHRIS LEONG
TEL (212) 920-7221
OWNER / CLIENT
CRESCENT HEIGHTS
2200 RISCAYNE BLVD.
MIAMI, FL 33137 STRUCTURAL ENGINEER

YHCE ENGINEERING
12151 SW 128TH CT, SUITE 104
MIAMI, FL 33186 CRESCENT HEIGHTS
1212 LINCOLN ROAD
1800 - 1634 ALTON RD, MAIMIN BEACH, FL 233339 SEAL & SIGNATURE


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LEVEL 3

DRAWING NUMBER A-100

1/32" =

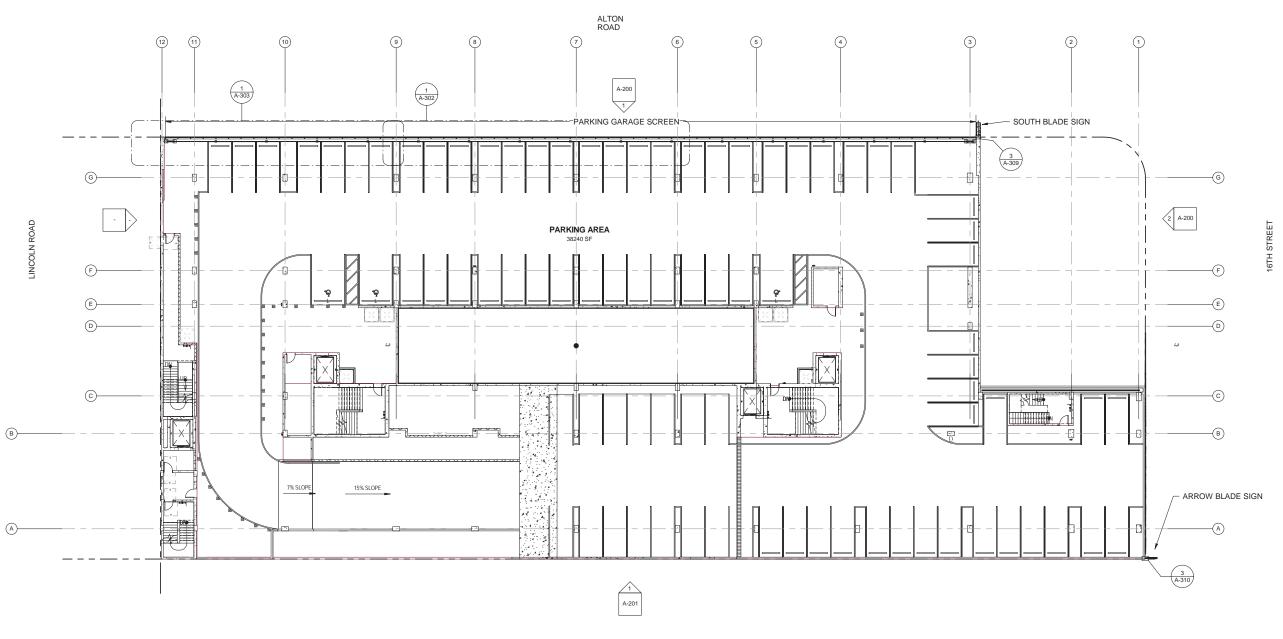LEVEL 3

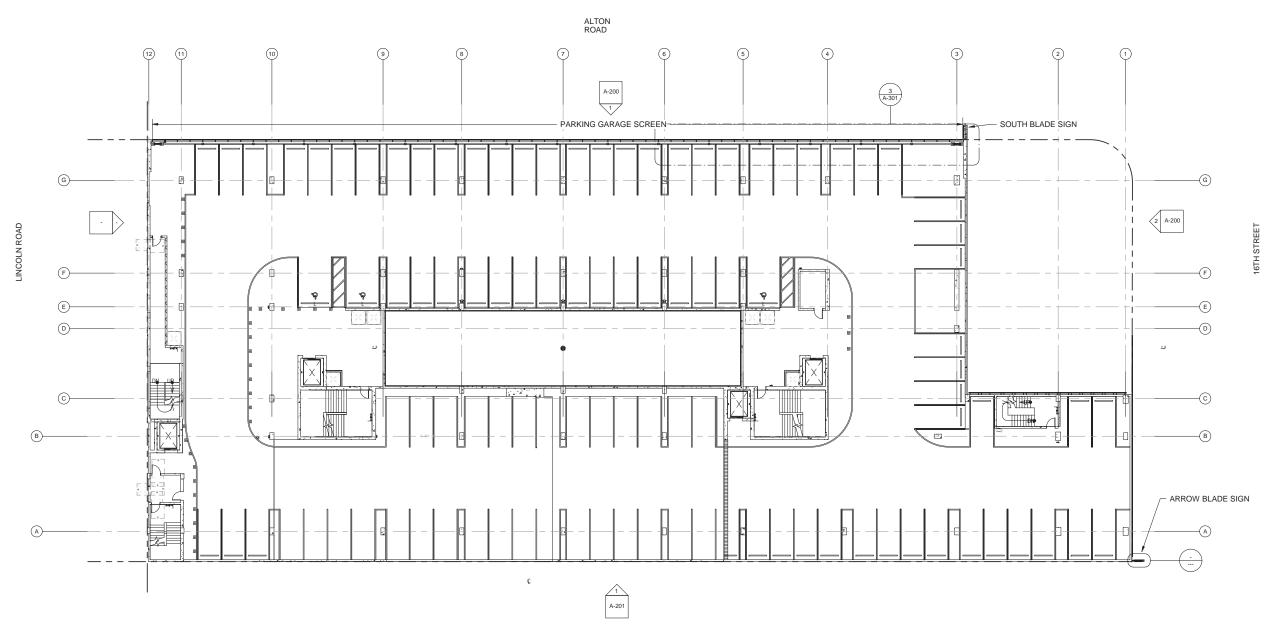


DESIGN ARCHITECT LEONG LEONG LEONG LEONG
167 BOWERY 3F
NEW YORK, NY 10002
CHRIS LEONG
TEL (212) 920-7221
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CRESCENT HEIGHTS
2200 BISCAYNE BLVD.
MIAMI, FL 33137 ARCHITECT

PERKINS + WILL
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CORAL GABLES, FL 33134 STRUCTURAL ENGINEER

YHCE ENGINEERING
12151 SW 128TH CT, SUITE 104
MIAMI, FL 33186 CRESCENT HEIGHTS
1212 LINCOLN ROAD
1600 - 1659 ALTON RD. MAMMI BEACH, FL. 33139 SEAL & SIGNATURE

A-101

1/32" = " LEVEL 4

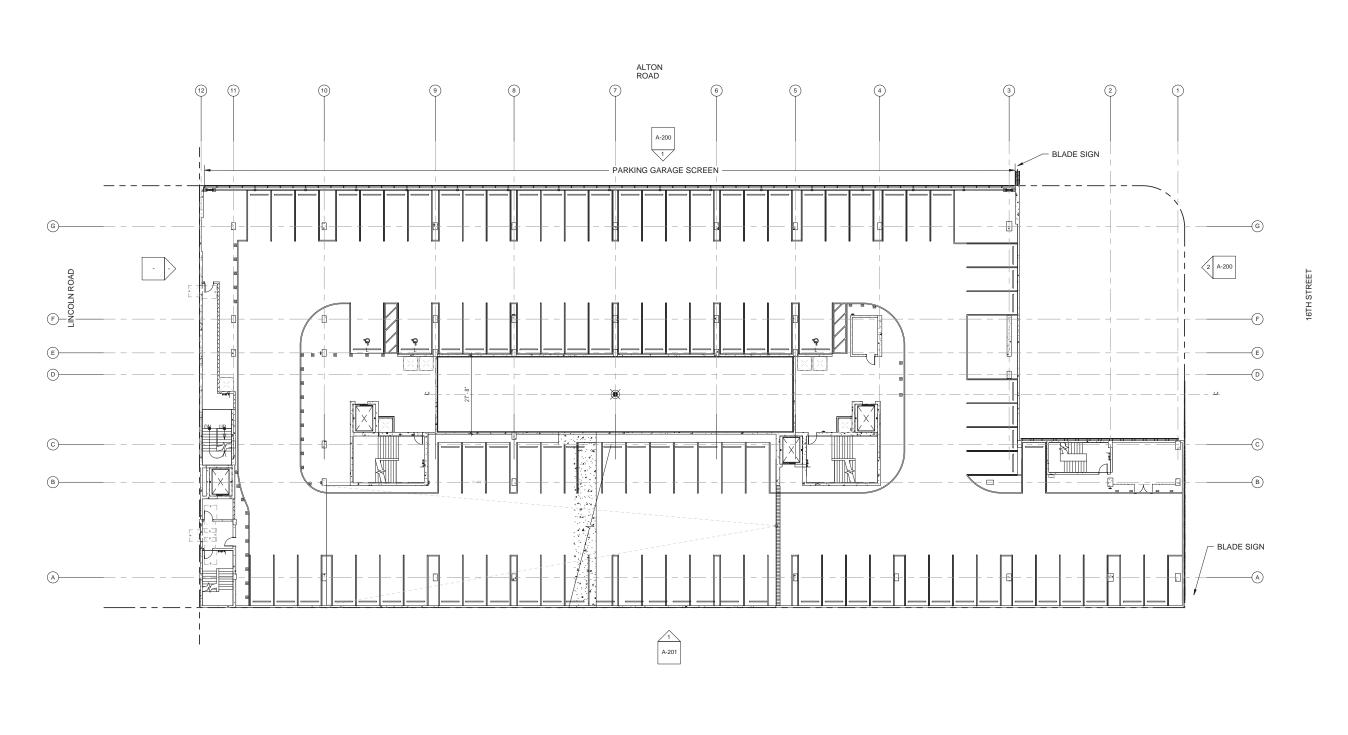

DESIGN ARCHITECT LEONG LEONG CRESCENT HEIGHTS 2200 BISCAYNE BLVD. MIAMI, FL 33137 ARCHITECT

PERKINS + WILL
806 DOUGLAS ROAD, SUITE 300
CORAL GABLES, FL 33134 STRUCTURAL ENGINEER

YHCE ENGINEERING
12151 SW 128TH CT, SUITE 104
MIAMI, FL 33186 CRESCENT HEIGHTS
1212 LINCOLN ROAD
1800 - 1834 ALTONED, MAMI BEACH, FL 33338


P.19

LEVEL 5

A-102

LEVEL 5

1/32" =

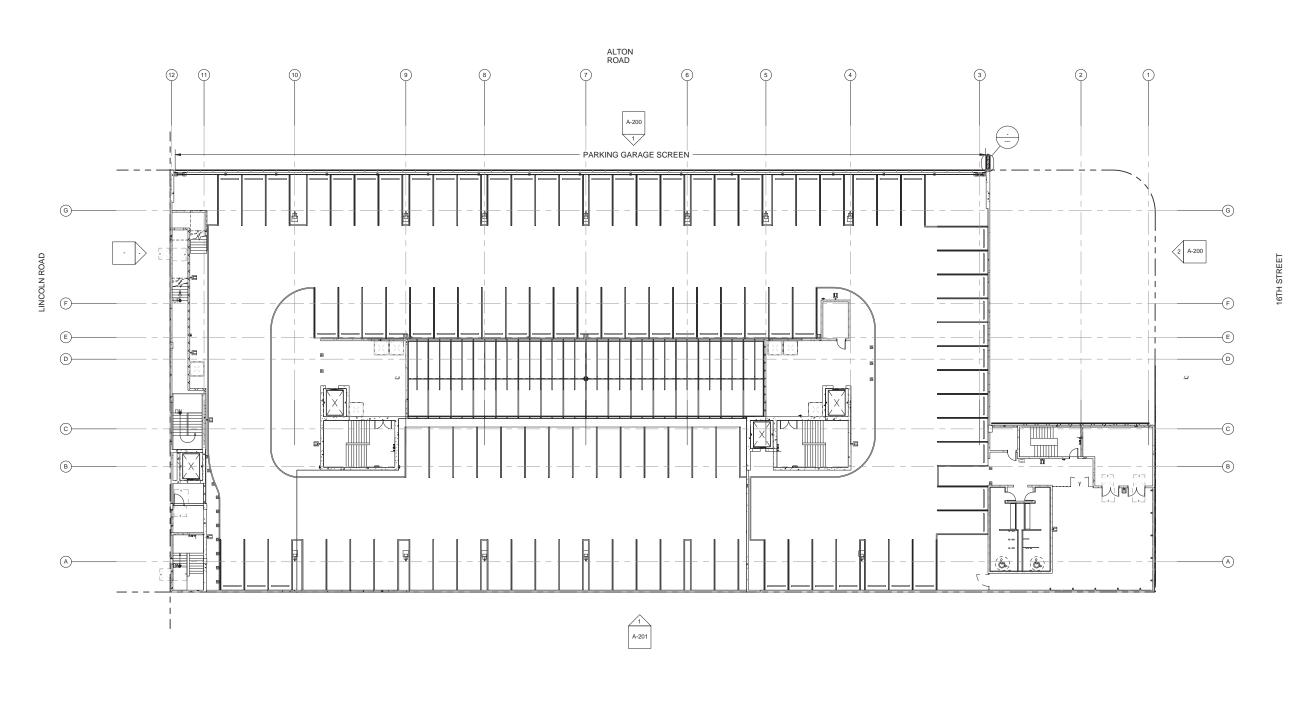

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167 BOWERY 3F
NEW YORK, NY 10002
CHRIS LEONG
TEL (212) 920-7221
OWNER / CLIENT
CRESCENT HEIGHTS
2200 BISCAYNE BLVD.
MIAMI, FL 33137 ARCHITECT


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806 DOUGLAS ROAD, SUITE 300
CORAL GABLES, FL 33134 STRUCTURAL ENGINEER


YHCE ENGINEERING
12151 SW 128TH CT, SUITE 104
MIAMI, FL 33186 CRESCENT HEIGHTS
1212 LINCOLN ROAD
1600 - 1634 ALTON RD. MAIMIN BEACH, FL 23339 ROOF LEVEL

A-104

LEVEL ROOF

1/32"

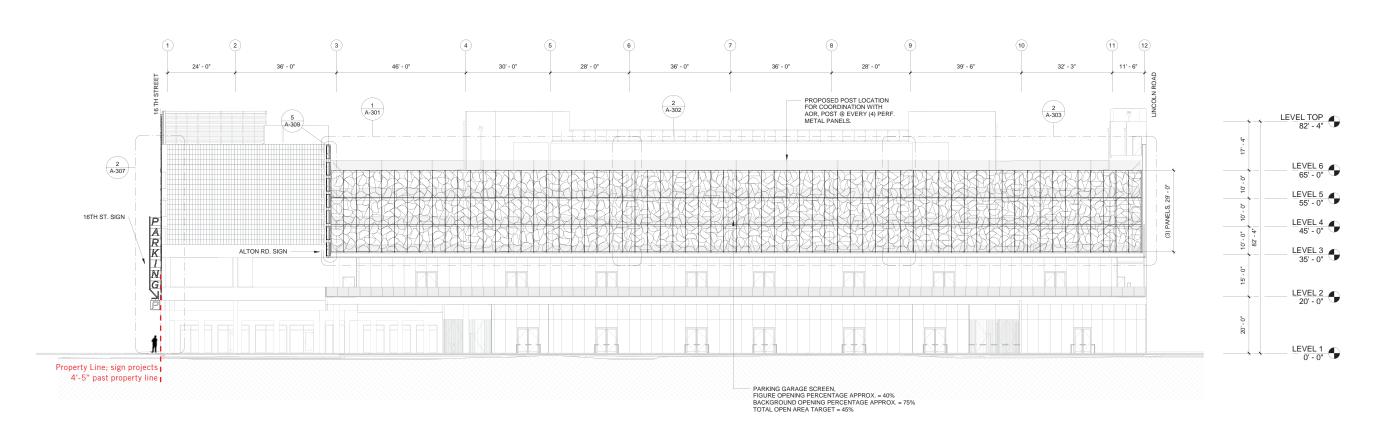


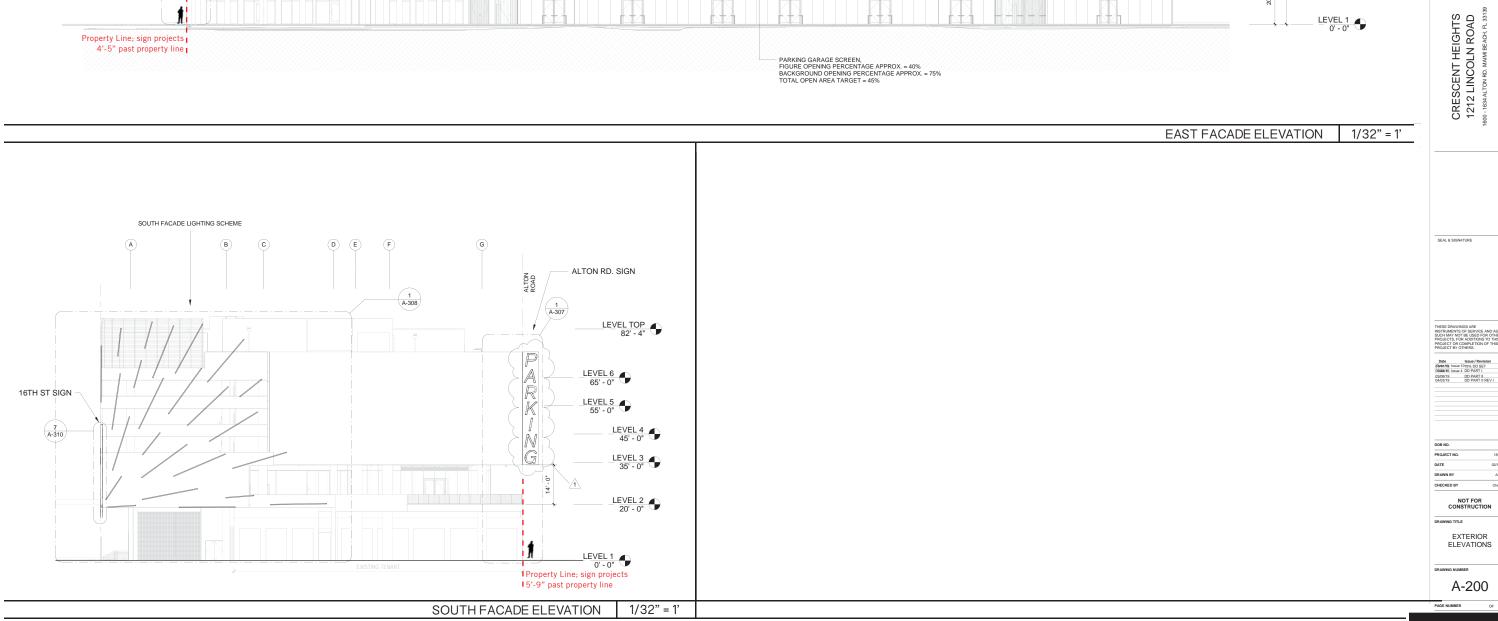



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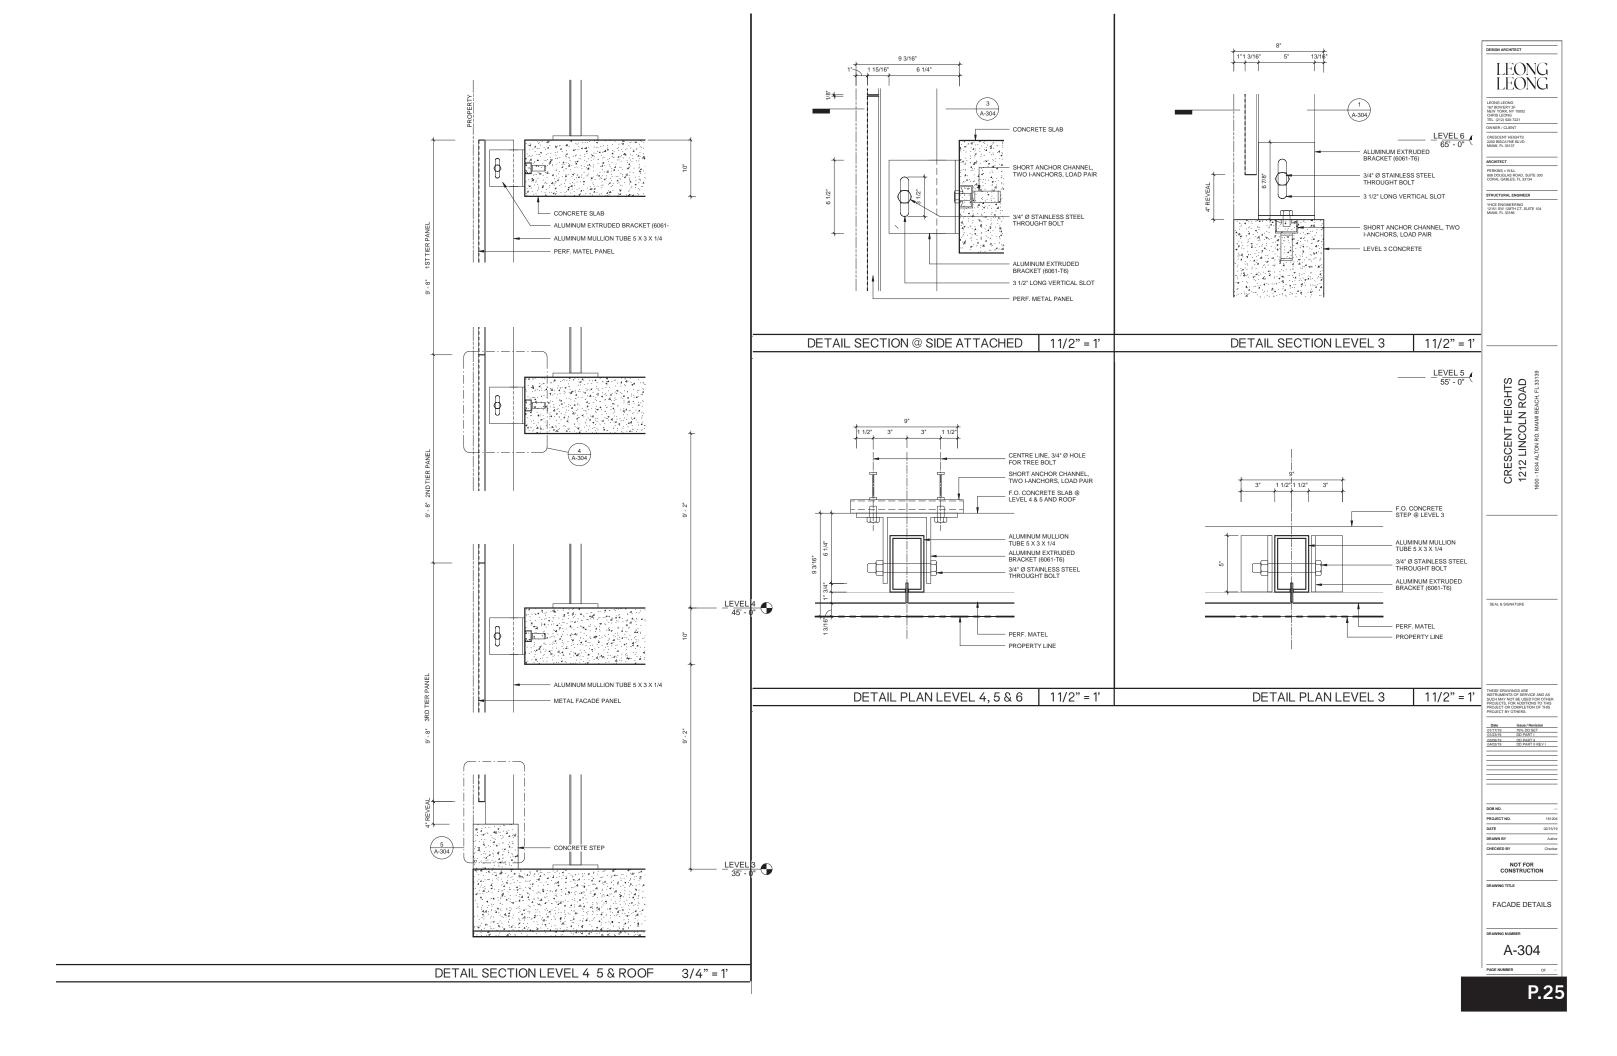
PERKINS + WILL 806 DOUGLAS ROAD, SUITE 300 CORAL GABLES, FL 33134


YHCE ENGINEERING 12151 SW 128TH CT, SUITE 104 MIAMI, FL 33186



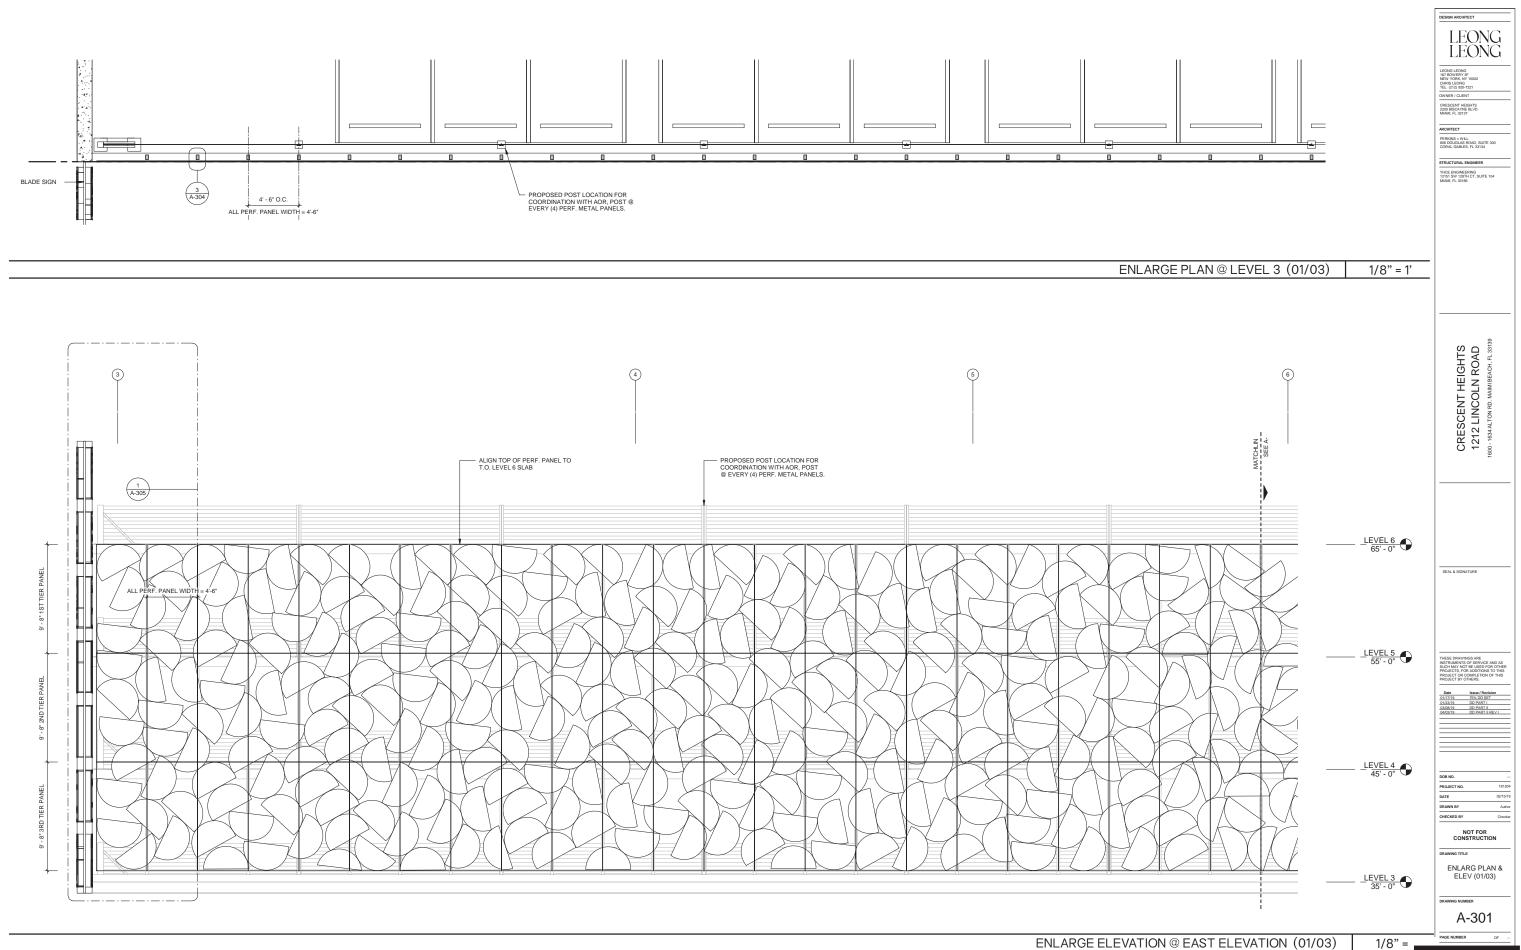

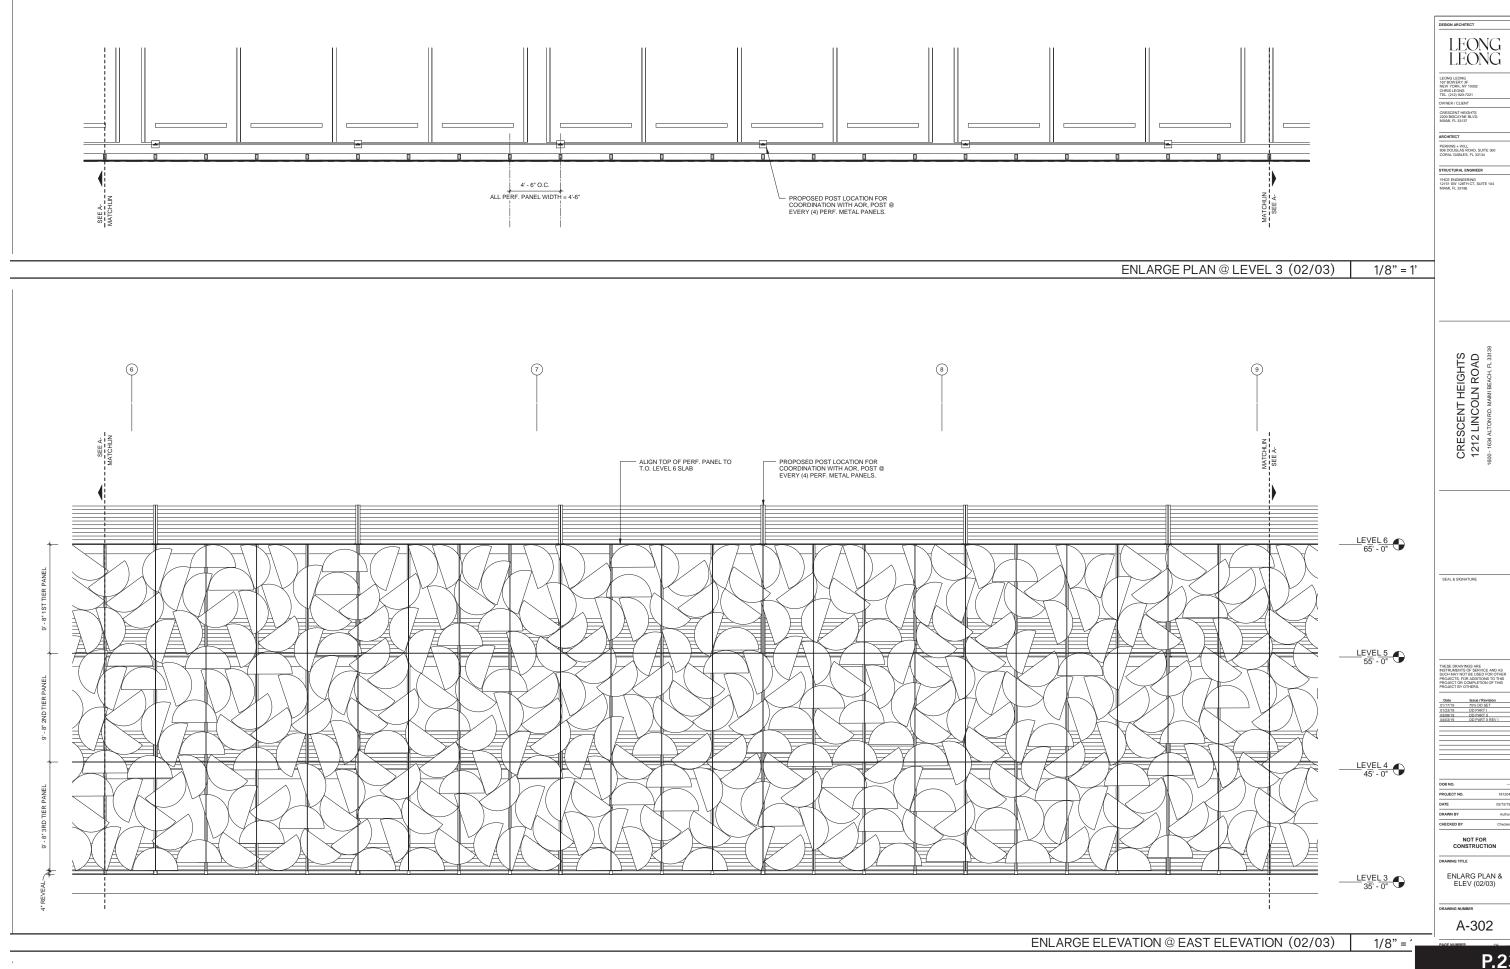

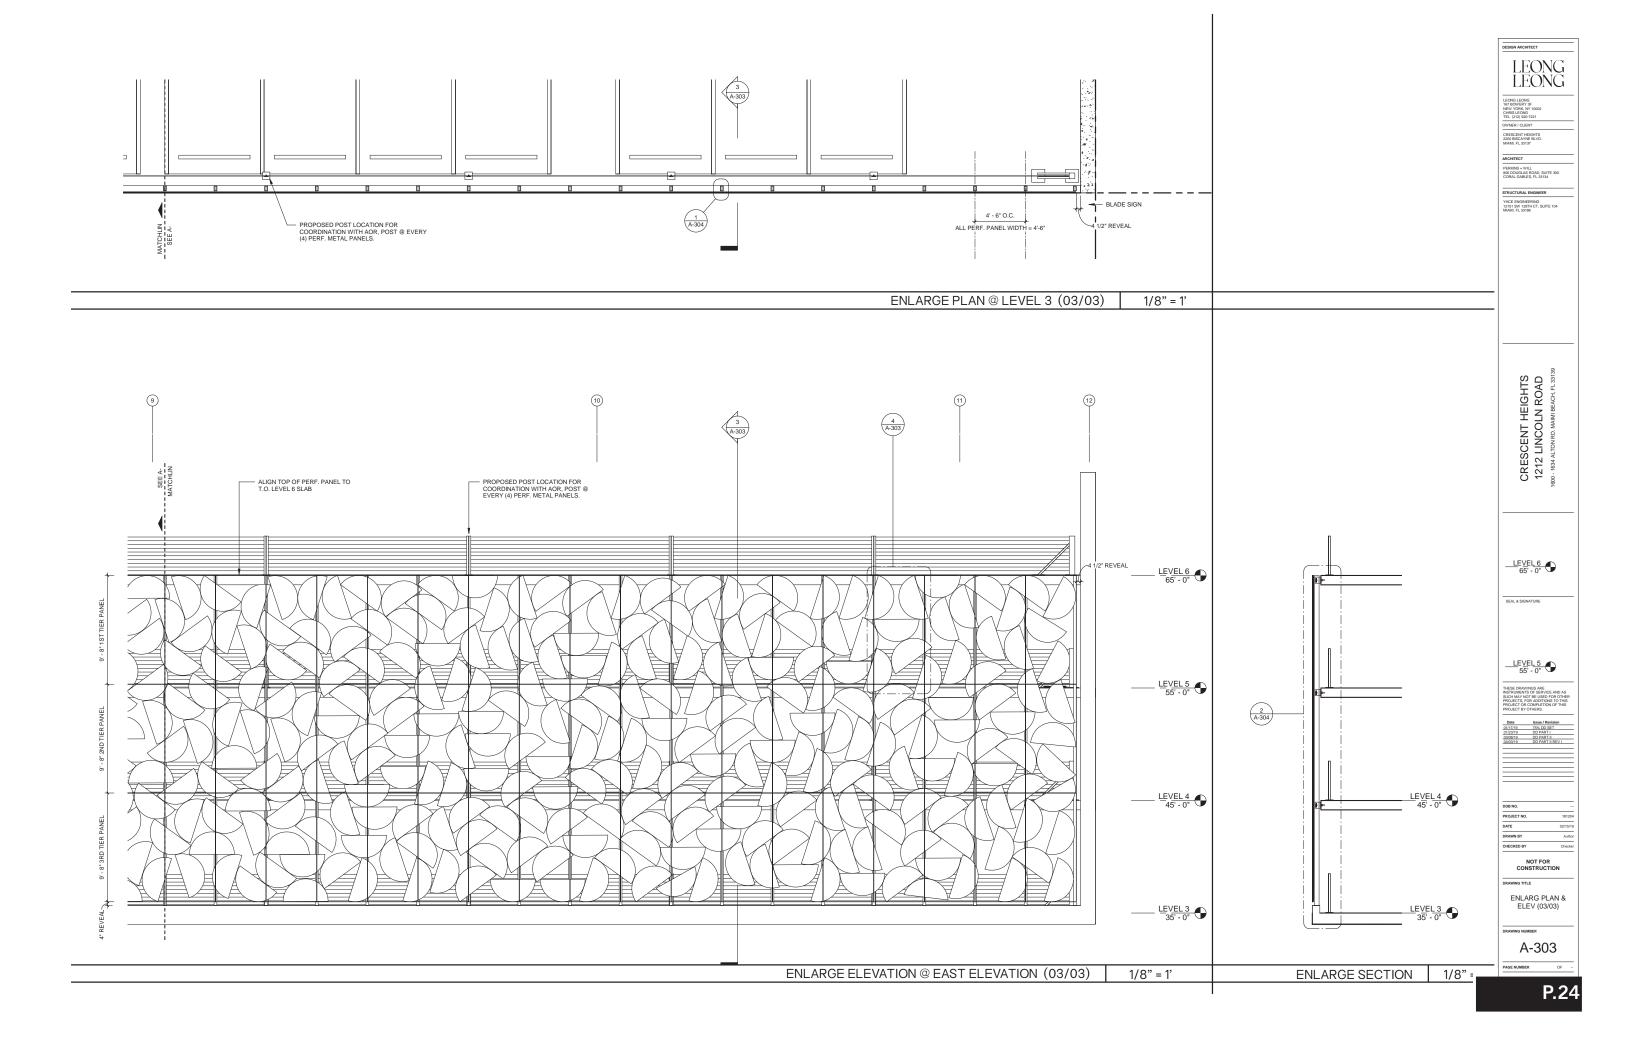


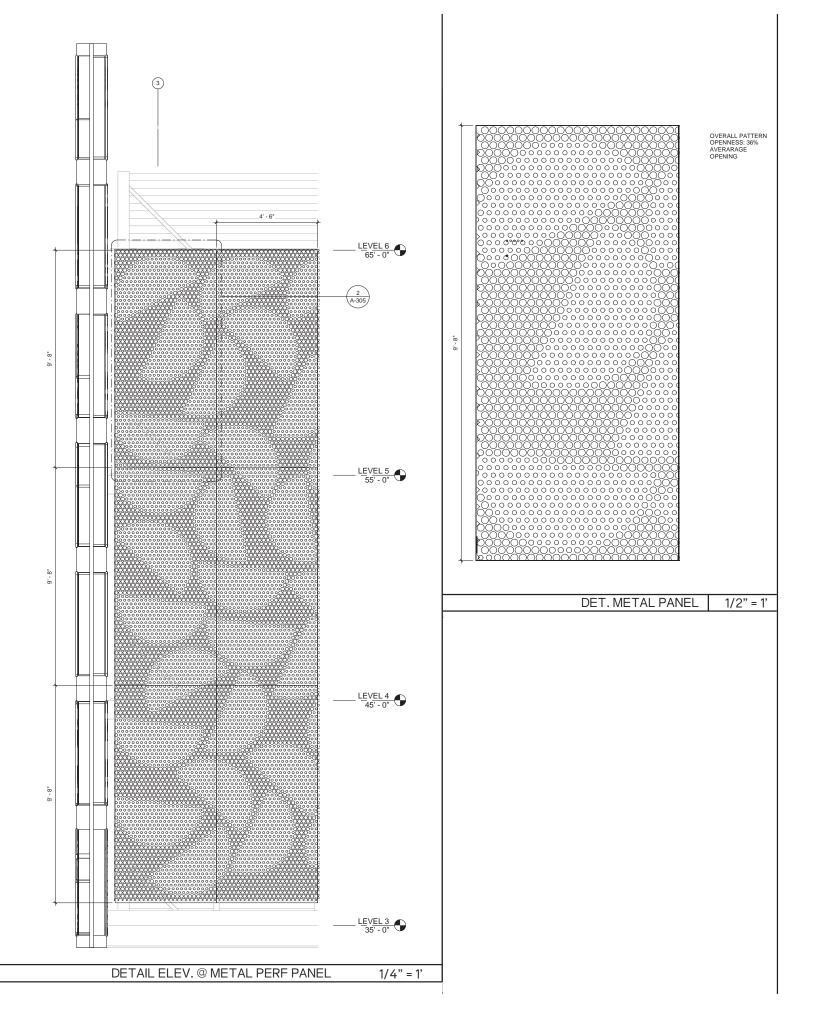


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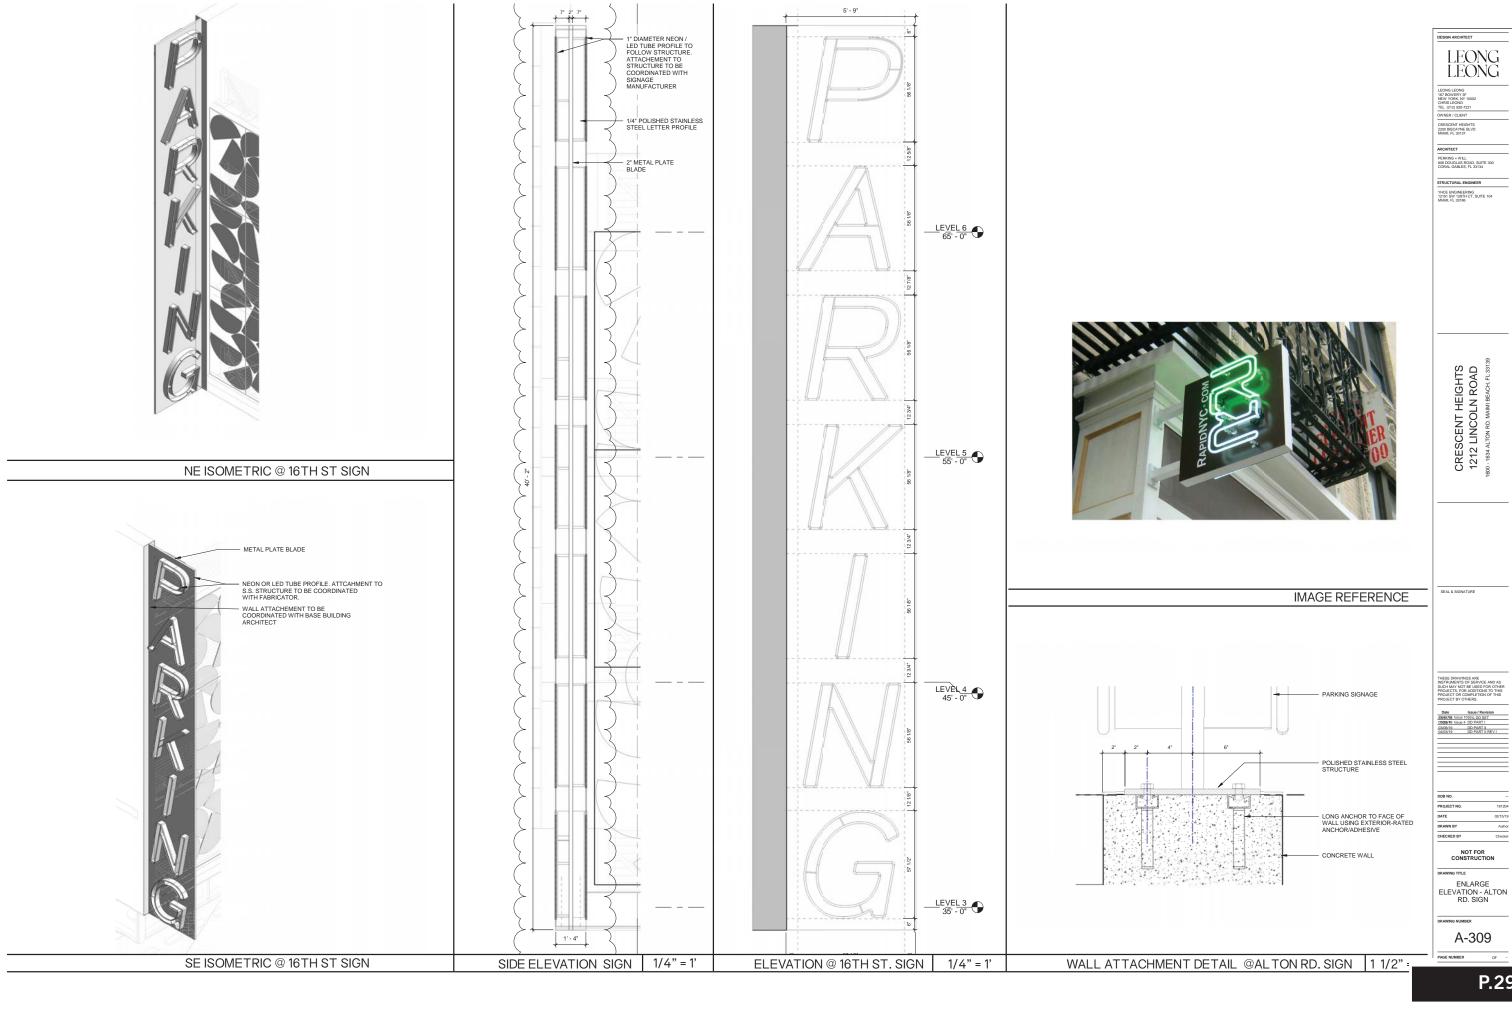
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12151 SW 128TH CT, SUITE 104
MIAMI, FL 33186


CRESCENT HEIGHTS 1212 LINCOLN ROAD 1600 - 1634 ALTON RO. MAMI BEACH, FL 33139 FACADE DETAILS A-305



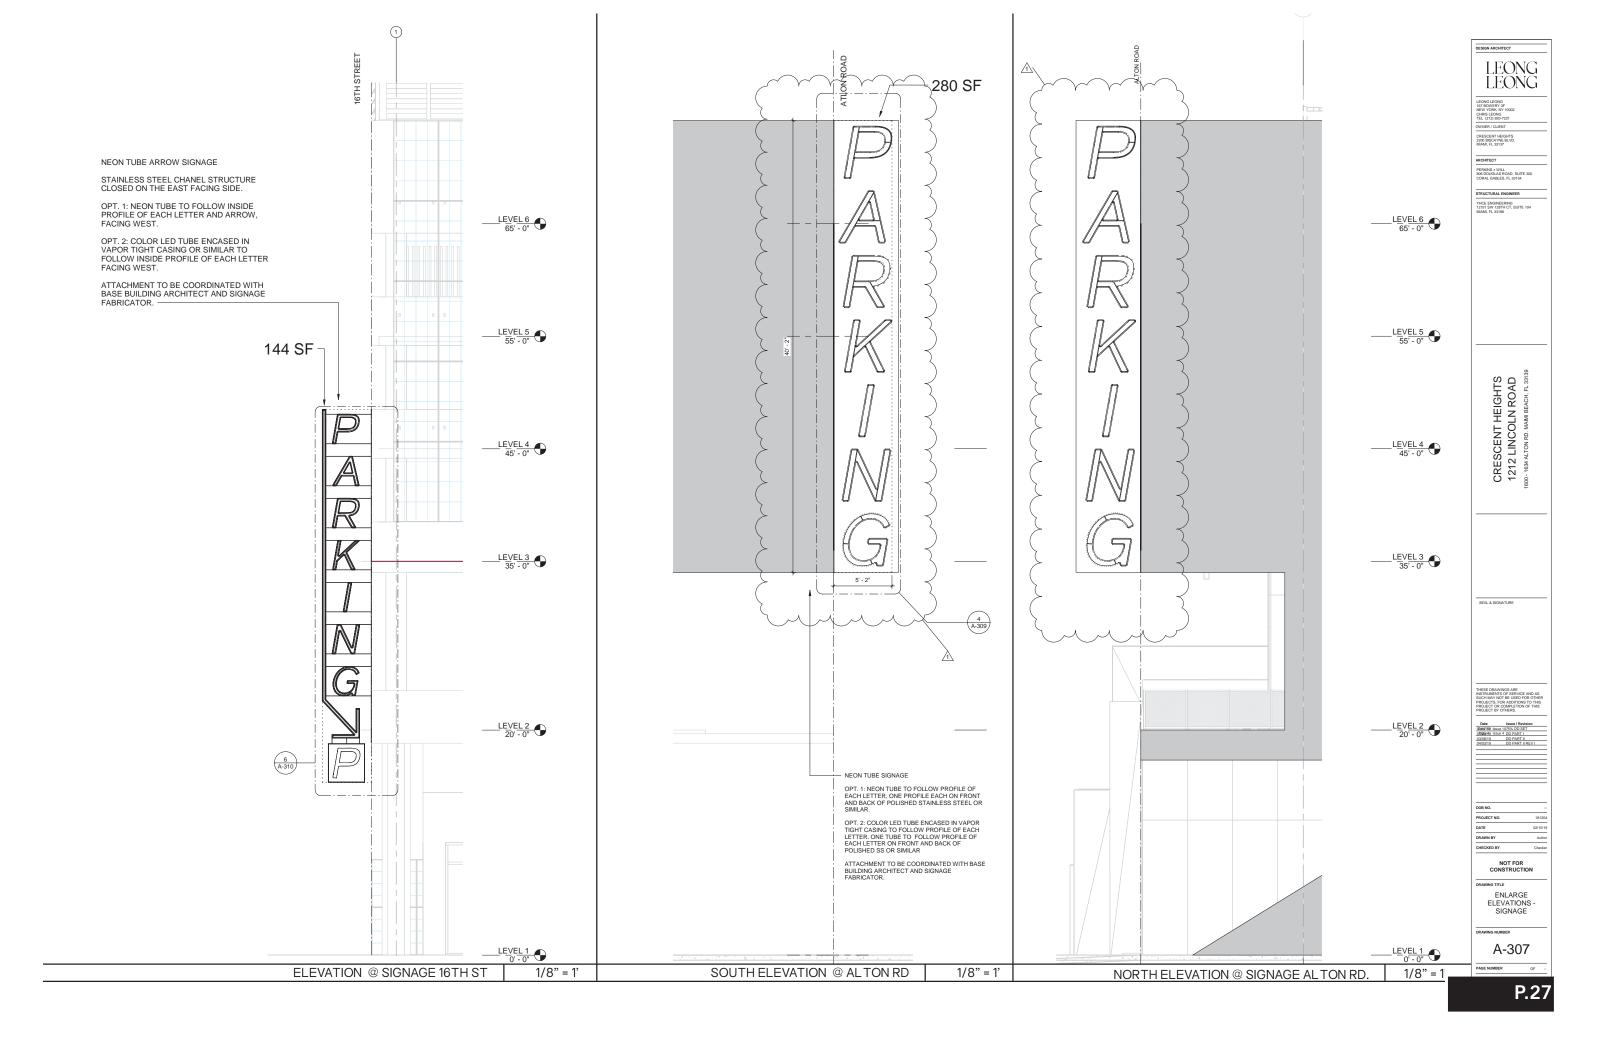

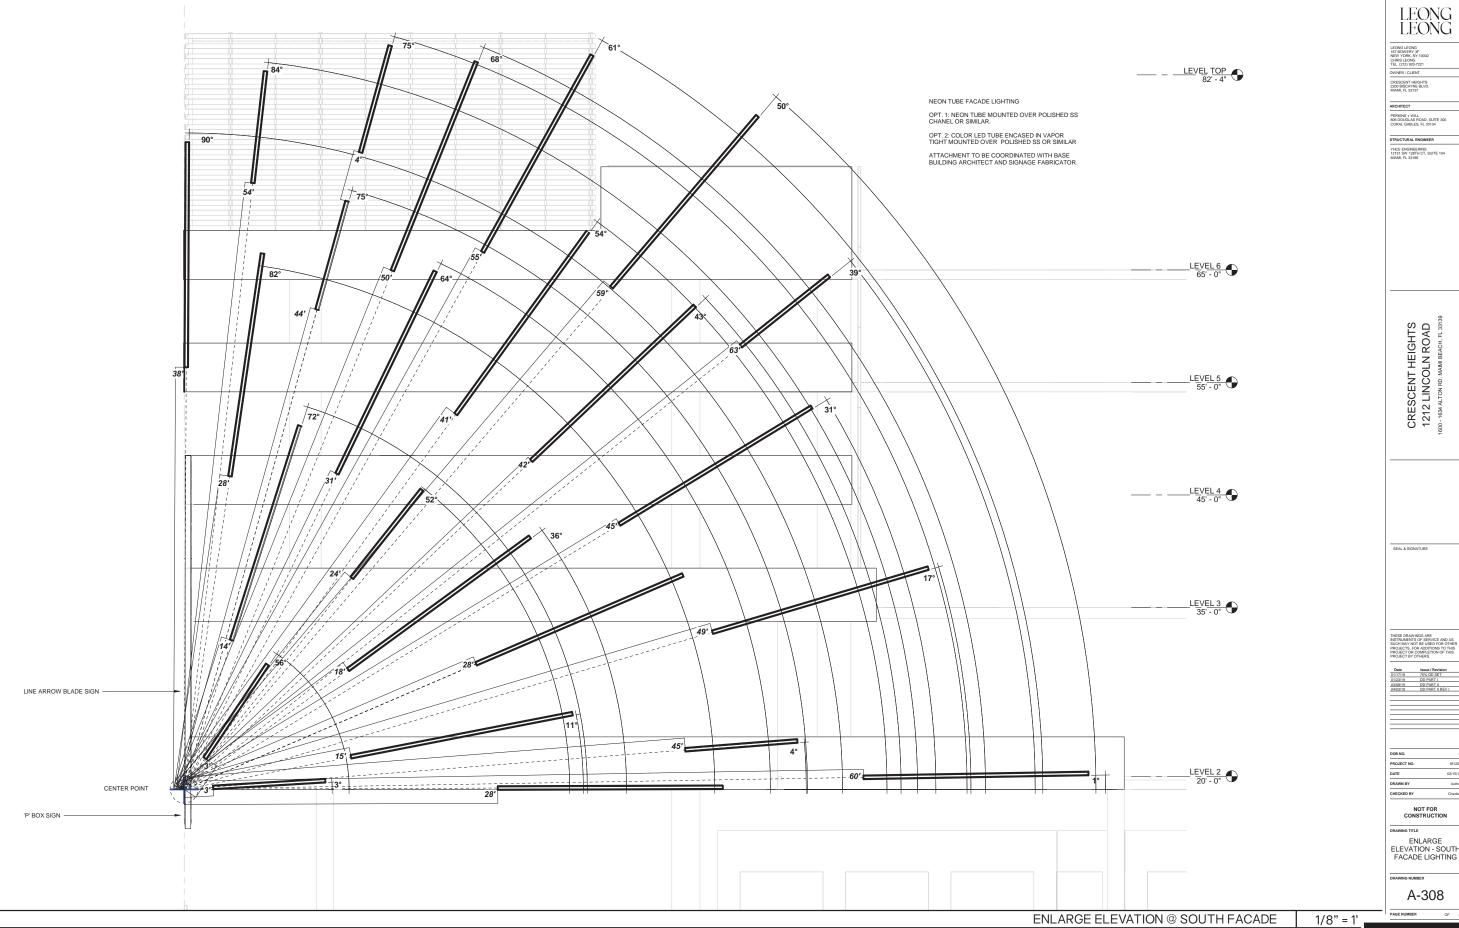DESIGN ARCHITECT ENLARGE ELEVATION - SOUTH FACADE LIGHTING



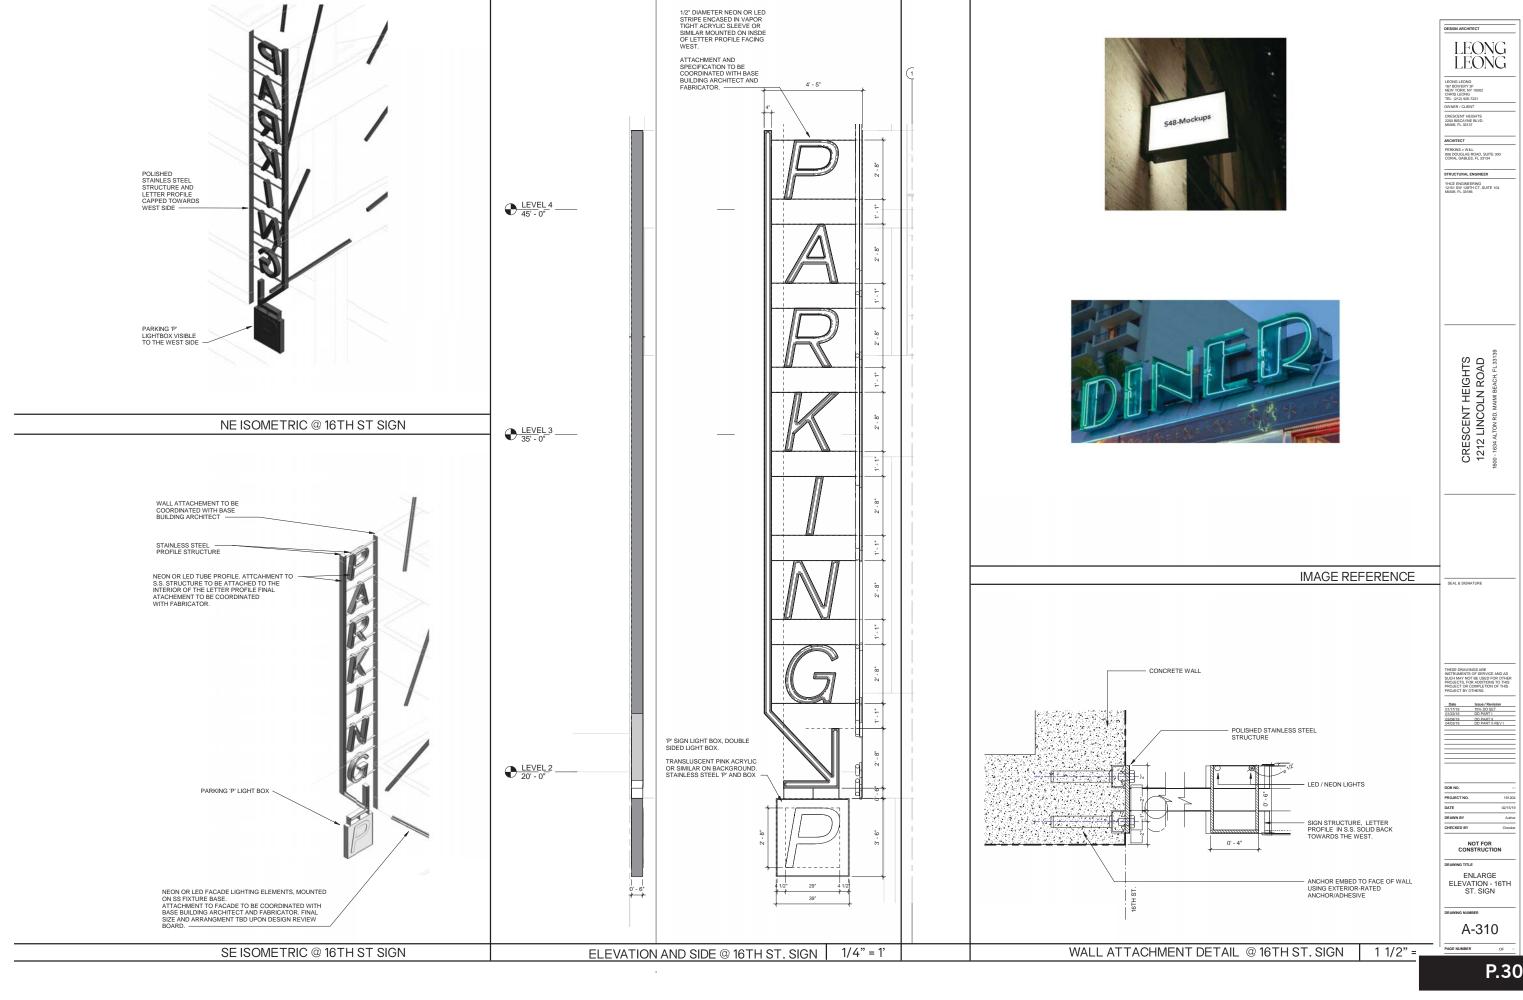

LEONG
LEONG LEONG
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LEONG LEONG LEONG LEONG LEONG LEONG
NEW YORK NY 10002
CHES LEONG
COWNERY CLEENT
CRESCENT HEIGHTS
CRESCENT HEIGHTS
ARCHITECT
ARCHITECT
SOO DOUGLAS ROAD, SUITE 300
COOKLA GREEK, FL 20134

DESIGN ARCHITECT

STRUCTURAL ENGINEER

YHCE ENGINEERING
12161 SW 128TH CT, SUITE 104
MIAMI, FL 33186

CRESCENT HEIGHTS
1212 LINCOLN ROAD
1600 - 1634 ALTON RD. MAMII BEACH, R. 23139

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THESE DRAWINGS ARE INSTRUMENTS OF SERVICE AND AS SUCH MAY NOT BE USED FOR OTHER PROJECT OR COMPLETION OF THIS PROJECT OR COMPLETION OF THIS PROJECT BY OTHERS.

| Date | Issue / Revision | O1/17/19 | 75% DD SET | O1/23/19 | DD PART II | O4/03/19 | DD PART II | O4/03/19 | DD PART II REV I

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DATE
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DETAIL - SCREEN ALPHA

A-311


SCREEN ALPHA MAP

1" = 20' - 0




APPENDIX C: TENANT AND DIRECTIONAL SIGNAGE




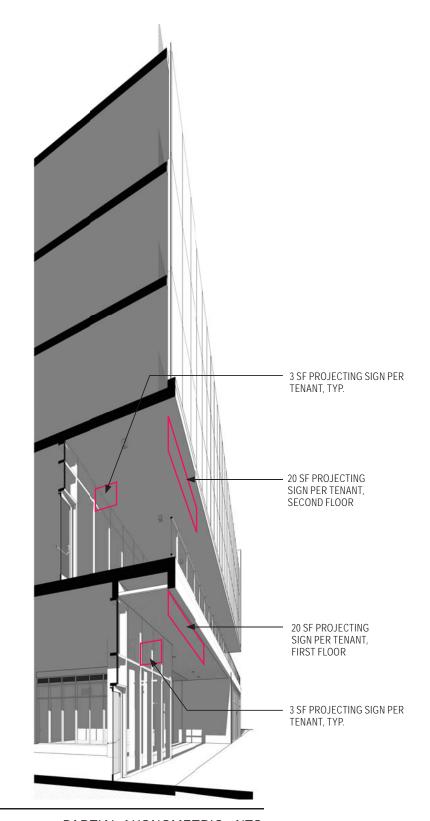

PARTIAL AXONOMETRIC - NTS

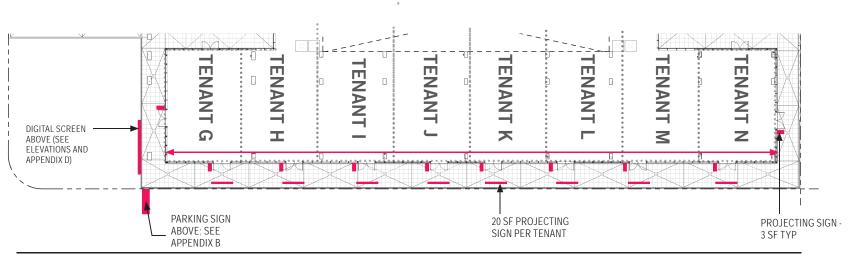


SECOND FLOOR RETAIL SIGNAGE PLAN

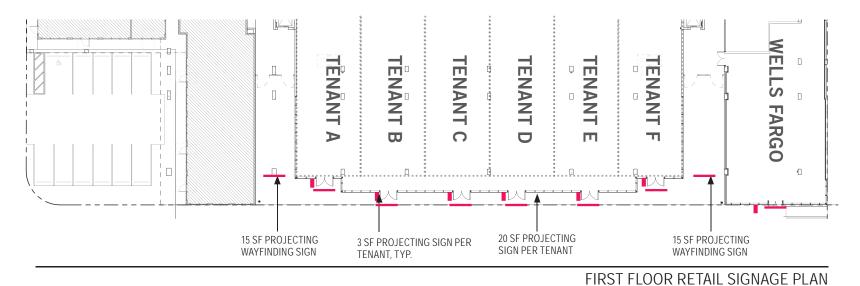



EAST ELEVATION - NTS



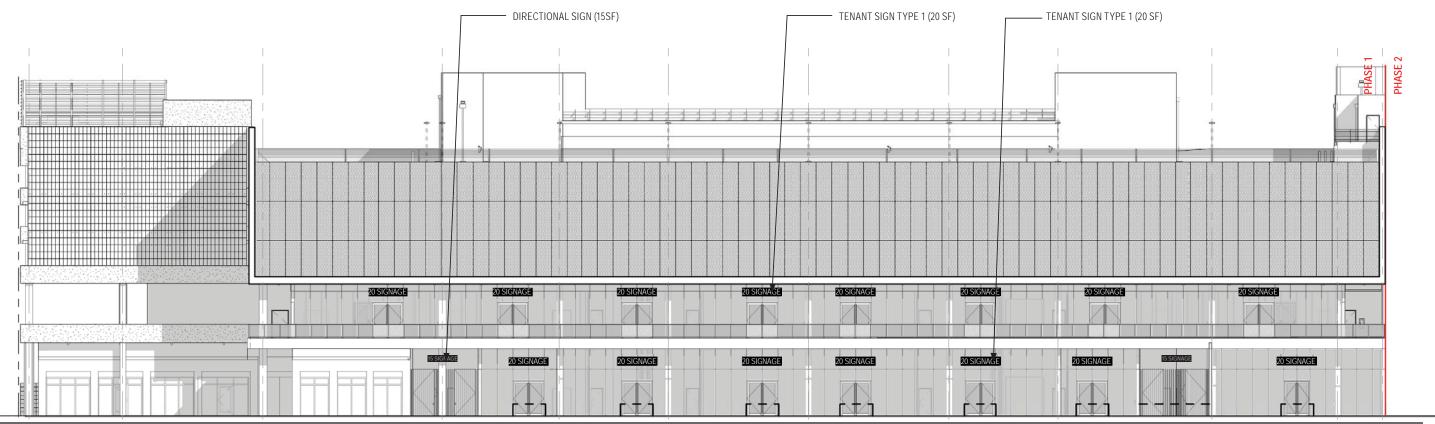

TENANT SIGN TYPE 1 - 20 SF ON 2ND FLOOR; 25 SF ON 1ST FLOOR

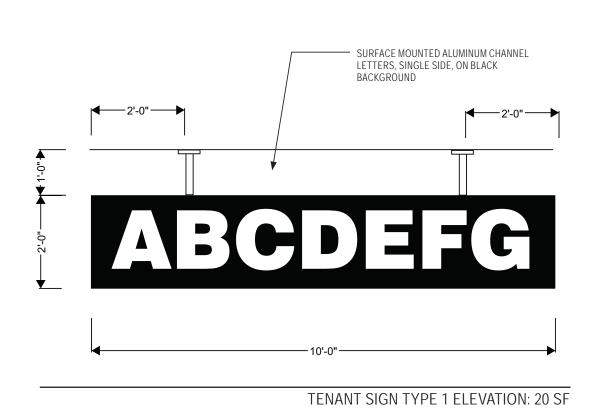


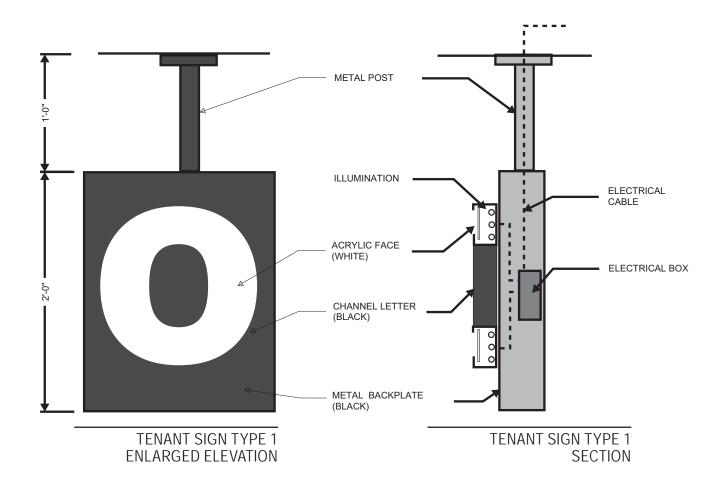





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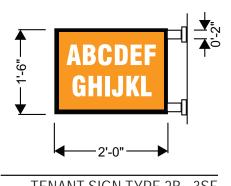
- 1. THREE VARIATIONS SHOWN FOR EACH RETAILER TO HAVE UNIQUE IDENTITY
- 2. MAXIMUM AREA = 3 SF
- 3. NON-LIT BOX SIGNS
- 4. WELLS FARGO SIGN EXAMPLES SHOWN FROM GUIDELINES

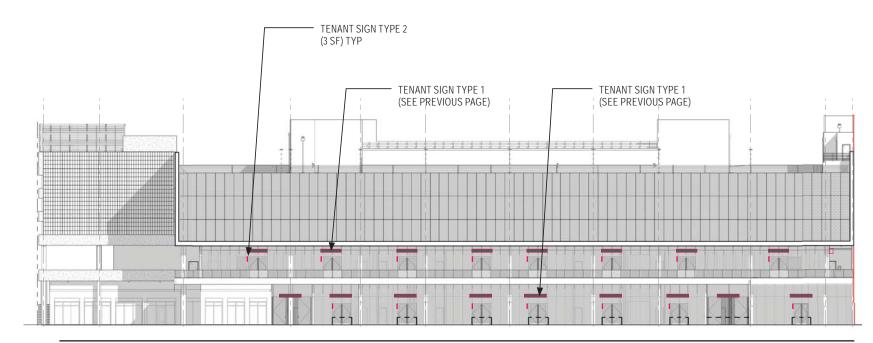


EAST ELEVATION - NTS



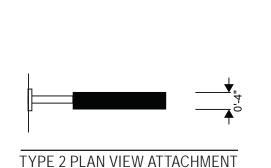

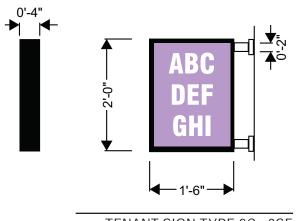

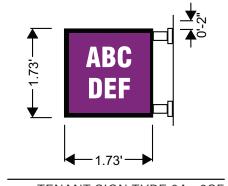


TENANT SIGN TYPE 2C - 3SF


TENANT SIGN TYPE 2B - 3SF

TENANT SIGN TYPE 2A - 3SF




2b Channel Letters on Staging Panel (halo and facelit) Low Profile Letters on Staging Panel (halo and facelit) −1'-6" ---> TYPE 2C SAMPLE

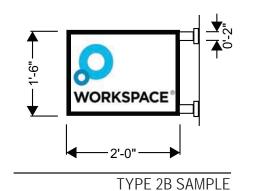


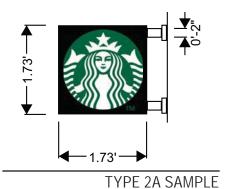





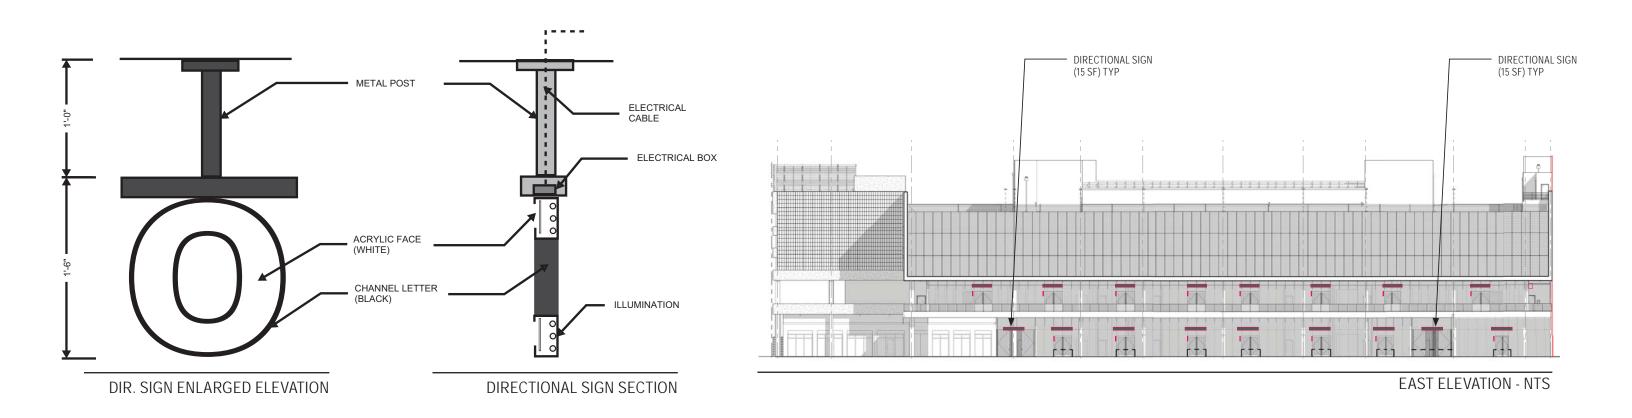

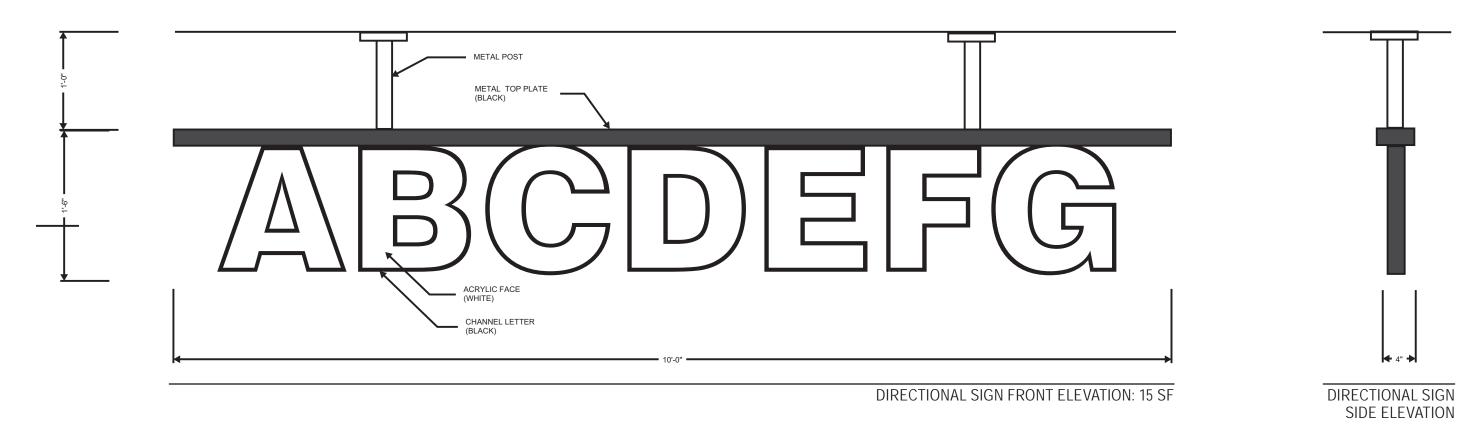




APPENDIX D: DIGITAL SCREEN





DIGITAL SCREEN

- Screen size: 800 sfFlexible location on south wall See options

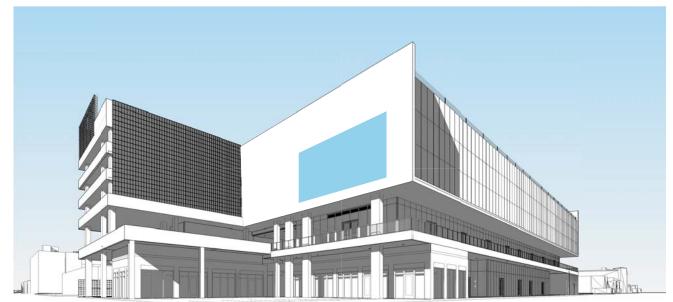

OPTION A

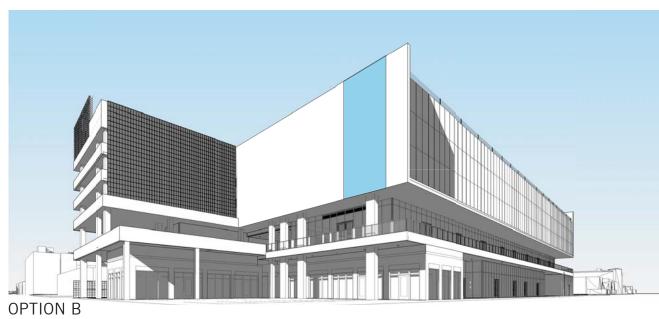


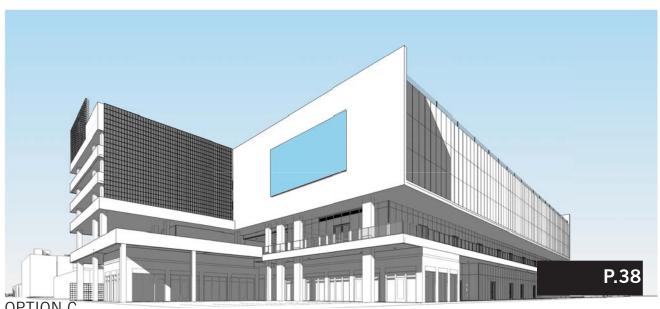



APPENDIX E: BUILDING ID SIGN



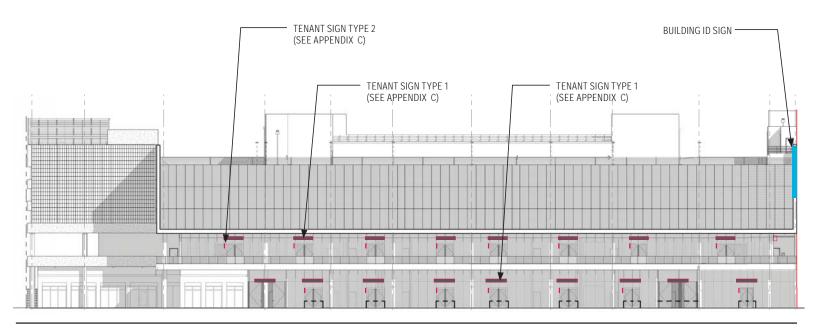

EAST ELEVATION - NTS



1212 LINCOLN ROAD BUILDING IDENTIFICATION

ALLOWABLE AREA = 1% OF 24,467 SF = 244.6 SF


(291'-9" LENGTH OF PH. 1 + 84'-8" LENGTH OF PH.2 = 376'-5" X 65H = 24,467 X 1% = 245 SF)

PROPOSED AREA: 172.5 SF

GENERAL NOTES:

SIGN IS NOT ILLUMINATED

CONSISTS OF WHITE PIN LETTERS ON METAL PLATE (DOUBLE SIDED)

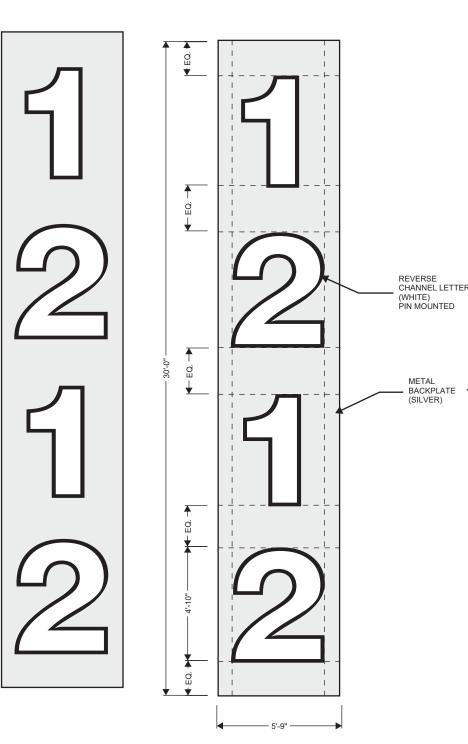

ELEVATION - NTS SECTION - NTS

